

For Office Use Only (to be inserted by the Secretary-Treasurer after application is deemed complete)

FILE NUMBER: A-2003

The Personal Information collected on this form is collected pursuant to section 45 of the Planning Act and will be used in the processing of this application. Applicants are advised that the Committee of Adjustment files is considered public information and is available to anyone upon request and will be published on the City's website. Questions about the collection of personal information should be directed to the Secretary-Treasurer, Committee of Adjustment, City of Brampton.

APPLICATION Minor Variance or Special Permission

(Please read Instructions)

NOTE: It is required that this application be filed with the Secretary-Treasurer of the Committee of Adjustment and be accompanied by the applicable fee.

The undersigned hereby applies to the Committee of Adjustment for the City of Brampton under section 45 of the <u>Planning Act</u>, 1990, for relief as described in this application from By-Law **270-2004**.

1.	Name of (Owner(s) Asemarech Yohann	es		
		2 Bunchgrass Pl. Brampton.	ON L6R 2J9		
	Phone #	647-787-6340		Fax #	
	Email	mannghotra.93@gmail.com			
2.	Name of	Agent Manjinder Kaur			
	Address	15845 River Dr. Georgetown	ON L7G 4S7		
	Phone #	289-962-4003		Fax #	-
	Email	ar.manjinderkaur@gmail.com		=	
3.	Nature ar	nd extent of relief applied for	(variances requeste	d):	
		ermit a proposed exterior			located
		the main wall of the dwe			
		stairway constructed bel		nde to be located betwee	n the main wall
	of a dwe	elling and the flankage lot	line.		1
					1
4.	Why is it	not possible to comply with	the provisions of the	by-law?	
••	Discourse State of the Control of th	ner of the property wants			nis mortgage
		er to provide a second dwe			
	not poss	sible on rear yard and the	other side of the p	property due to insufficier	nt space and
	privacy	reason. So the only space	e where owner car	construct the entrance i	s the side of
	the prop	perty. The entrance is des	signed in such a wa	ay that it is inside the lega	al property
5.	Legal De	scription of the subject land	:		
	Lot Num	ber 156			
		nber/Concession Number	SALL OD O IO		
	Municipa	2 Bunchgrass Pl, Bra	mpton, ON L6R 2J9		
6.		on of subject land (<u>in metric</u>	<u>units</u>)		
	Frontage				
	Depth Area	23.56 339.00 SQM			
7		o the subject land is by: al Highway		Seasonal Road	
		al Road Maintained All Year	$\overline{\Box}$	Other Public Road	Ħ
		Right-of-Way		Water	

Particulars of all buildings and structures on or proposed for the subject land: (specify in metric units ground floor area, gross floor area, number of

8.

Swales

storeys, width, length, height, etc., where possible) EXISTING BUILDINGS/STRUCTURES on the subject land: List all structures (dwelling, shed, gazebo, etc.) Ground Floor Area: 131.65 sqm Gross Floor Area: 309.50 sqm, No. of Levels: 2 Width: 9.5 m Length: 15.95 m PROPOSED BUILDINGS/STRUCTURES on the subject land: N/A 9. Location of all buildings and structures on or proposed for the subject lands: (specify distance from side, rear and front lot lines in metric units) **EXISTING** Front yard setback 4.3 M Rear yard setback 5.79 M Side yard setback 1.21 M Side yard setback 4.24 M **PROPOSED** Front yard setback 4.3 M Rear yard setback 5.79 M Side yard setback 1.21 M Side yard setback 2.79 M December 2018 10. Date of Acquisition of subject land: 11. Existing uses of subject property: Residential - Single Dwelling Unit 12. Proposed uses of subject property: Residential - Two Dwelling Unit 13. Existing uses of abutting properties: Residential Date of construction of all buildings & structures on subject land: February 2007 14. 15. Length of time the existing uses of the subject property have been continued: 5 Years 16. (a) What water supply is existing/proposed? Municipal Other (specify) Well (b) What sewage disposal is/will be provided? Other (specify) Municipal Septic (c) What storm drainage system is existing/proposed? Sewers Other (specify) **Ditches**

17.	subdivision or		or an application und	er the Planning Act, for ap	proval of a plan of
	Yes 🔲	No 🔽			
	If answer is yes	s, provide details:	File #	Status	
18.	Has a pre-cons	sultation application b	een filed?		
	Yes	No 🗸			
19.	Has the subjec	t property ever been	the subject of an app	lication for minor variance	?
	Yes	No 🔽	Unknown [
	If answer is ye	s, provide details:			
	File #	Decision		Relief	
	File #	Decision Decision		Relief Relief	
					
				Manjinder ature of Applicant(s) or Author	
			Signa	ature of Applicant(s) or Author	rized Agent
DAT	ED AT THE City		OF Georgetown		
THE	S 19 DA	Y OF Dec	, 20 _23,		
IN TH ALL OF T BELIEVIN DATH.	THE ABOVE STANG IT TO BE TRUE ED BEFORE ME OF BEFORE THIS 21	or Halton TEMENTS ARE TRUITE AND KNOWING TH	Gagandeep Jasva Commissioner Province of Onta for the Corporat City of Brampto Expires Septem	DECLARE THAT: SOLEMN DECLARATION OF ME FORCE AND EFFECT A val , etc., ario, ion of the	Conscientiously as if made under
	A Commission	per etc.			
		F	OR OFFICE USE ONL	Y	
	Present Officia	al Plan Designation:		-	
	Present Zonin	g By-law Classification	on:	R1C-855	
	This application		with respect to the vari re outlined on the attac	ances required and the resul ched checklist.	ts of the
	Conno	r Cowan		2023-12-20	
		Zoning Officer		Date	
		DATE RECEIVED	Dec , 21	2023	
		pplication Deemed	, , ,		Revised 2020/01/07
	Complete b	y the Municipality 🖳			

APPOINTMENT AND AUTHORIZATION OF AGENT

To: The Secretary-Treasurer
Committee of Adjustment
City of Brampton
2 Wellington Street West
Brampton, Ontario
L6Y 4R2

LOCATIO	ION OF THE SUBJECT LAND: 2 Bunchgrass Pl					
I/We,	Asemarech Yochannes					
the under	dersigned, being the registered owner(s) of the subject lands, hereby authorize					
	Manjinder Kaur					
	please print/type the full name of the agent(s)					
	to make application to the City of Brampton Committee of Adjustment in the matter of an application for minor variance with respect to the subject land.					
Dated thi	this 19 day of December , 2023 .					
	Asemarech Gochannes					
(signa	gnature of the owner[s], or where the owner is a firm or corporation, the signature of an officer of	he owner.)				
	(where the owner is a firm or corporation, please print or type the full name of the person sign	ing.)				

NOTE: If the owner is a firm or corporation, the corporate seal shall be affixed hereto.

NOTE: Unit owners within a Peel Standard Condominium Corporation are to secure authorization from the Directors of the Condominium Corporation in a form satisfactory to the City of Brampton, prior to submission of an application. Signatures from all Members of the Board of Directors are required.

PERMISSION TO ENTER

To: The Secretary-Treasurer
Committee of Adjustment
City of Brampton
2 Wellington Street West
Brampton, Ontario
L6Y 4R2

LOCATIO	N OF TH	E SUBJEC	T LAND: 2 Bur	nchgrass PI	
I/We,			Asemar	rech Yochannes	
-			please print/ty	pe the full name of	of the owner(s)
the City of the above	f Brampt noted pi	on Comm roperty for	ittee of Adjustment	and City of Br	land, hereby authorize the Members of rampton staff members, to enter upon inspection with respect to the attached
Dated this	19	day of	December		_ , 2023
		-	Asemarech (
(signa	ture of the	owner[s], or	where the owner is a fi	rm or corporation,	, the signature of an officer of the owner.)
	() ob a = 41 -		G	and print or hear th	ha full name of the namen signing \
	(where the	owner is a	iiiii oi corporation, piea	ase brillir or type it	he full name of the person signing.)

NOTE: If the owner is a firm or corporation, the corporate seal shall be affixed hereto.

NO DISCUSSION SHALL TAKE PLACE BETWEEN THE COMMITTEE MEMBERS AND THE APPLICANT DURING THE SITE INSPECTION

SURVEYOR'S REAL PROPERTY REPORT

PLAN OF LOTS 154, 155 AND 156 PLAN 43M-1300

CITY OF BRAMPTON

REGIONAL MUNICIPALITY OF PEEL

10m

PART 2 (SURVEY REPORT)


REGISTERED EASEMENTS AND/OR RIGHT-OF-WAYS: NONE

THIS PLAN DOES NOT CERTIFY COMPLIANCE WITH ZONING BY-LAWS

RADY-PENTEK & EDWARD SURVEYING LTD., O.L.S., 1999 **METRIC**

DISTANCES SHOWN ON THIS PLAN ARE IN METRES AND CAN BE CONVERTED TO FEET BY DIVIDING BY 0.3048.



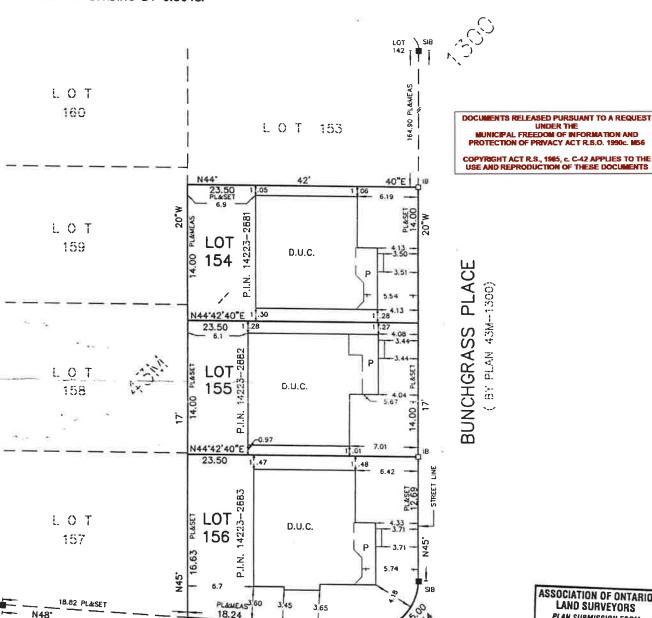

WILD INDIGO CRESCENT

30°F

00

(BY PLAN 43M-1300)

NOTES

DENOTES MONUMENT FOUND
DENOTES MONUMENT SET
DENOTES STANDARD IRON BAR
DENOTES IRON BAR
DENOTES IRON BAR
DENOTES DWELLING UNDER CONSTRUCTION
DENOTES PROPERTY IDENTIFIER NUMBER
DENOTES PORCH SIB IB PL D.U.C.

ALL FOUND MONUMENTS BY MARSHALL MACKLIN MONAGHAN ONTARIO LIMITED, O.L.S.
ALL TIES TO CONCRETE FOUNDATIONS.

BEARINGS ARE ASTRONOMIC AND ARE REFERRED TO THE SOUTHWEST LIMIT OF BUNCHGRASS PLACE AS SHOWN ON PLAN 43M-1300 HAVING A BEARING OF N45"17'20"W.

THIS REPORT WAS PREPARED FOR ASPEN RIDGE HOMES ASPEN RIDGE HOMES
AND THE UNDERSIGNED ACCEPTS NO
RESPONSIBILITY FOR USE BY OTHER PARTIES. CRADY-PENTEX & EDWARD SURVEYING LTD., O.L.S. 1999

SURVEYOR'S CERTIFICATE

I CERTIFY THAT:

- 1. THIS SURVEY AND PLAN ARE CORRECT AND IN ACCORDANCE WITH THE SURVEYS ACT, THE SURVEYORS ACT AND THE LAND TITLES ACT AND THE REGULATIONS MADE UNDER THEM.
- 2. THE SURVEY WAS COMPLETED ON THE 2 DAY OF Fed .. 1999

DATE FEB. 17/2 1999

SINO ONTARIO LAND SURVEYOR

ASSOCIATION OF ONTARIO

LAND SURVEYORS

PLAN SUBMISSION FORM


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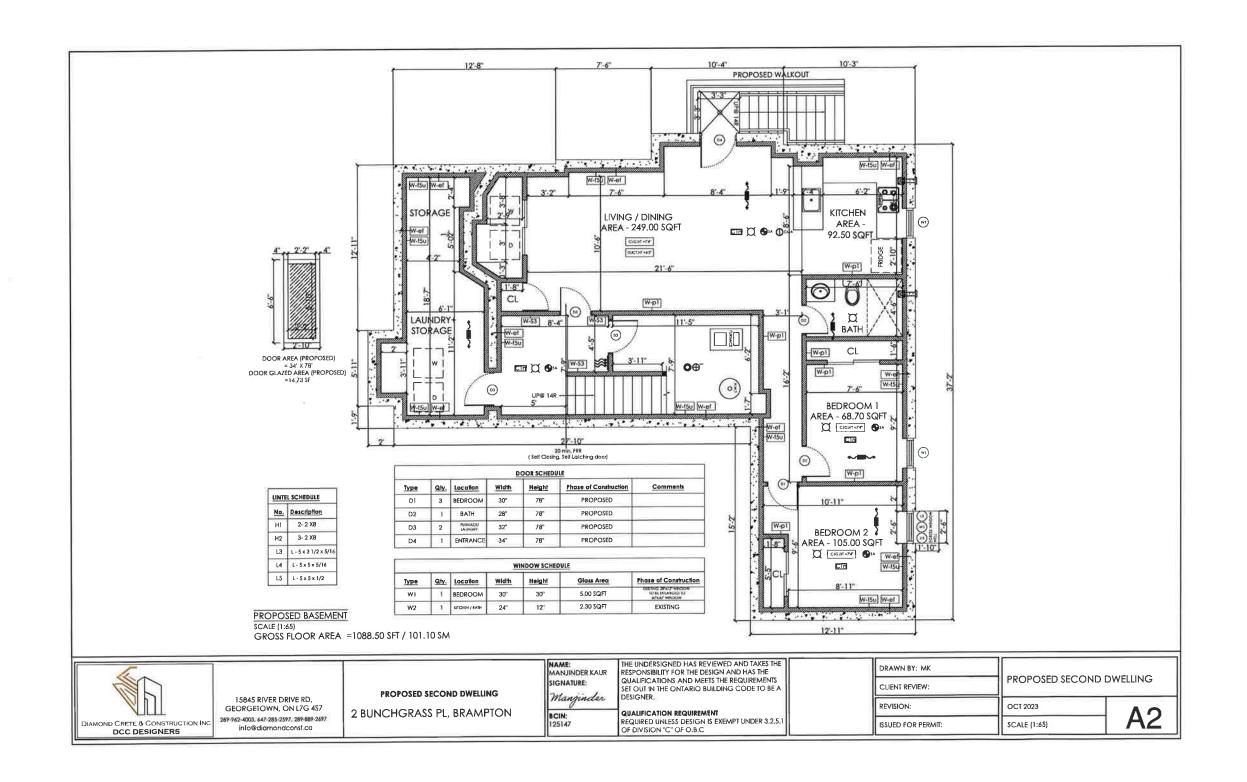
THIS PLAN IS NOT VALID UNLESS IT IS AN EMBOSSED ORIGINAL COPY ISSUED BY THE SURVEYOR





RADY-PENTEK & EDWARD SURVEYING LTD
ONTARIO LAND SURVEYORS
465 WILSON AVENUE, DOWNSVIEW, ONTARIO
635-5000
DRAWN: V.N.K. CHECKED: M.P.
JOB No. 98-182 ACAD No. 1300-154

CHECKED: M.P. ACAD No. 1300-154



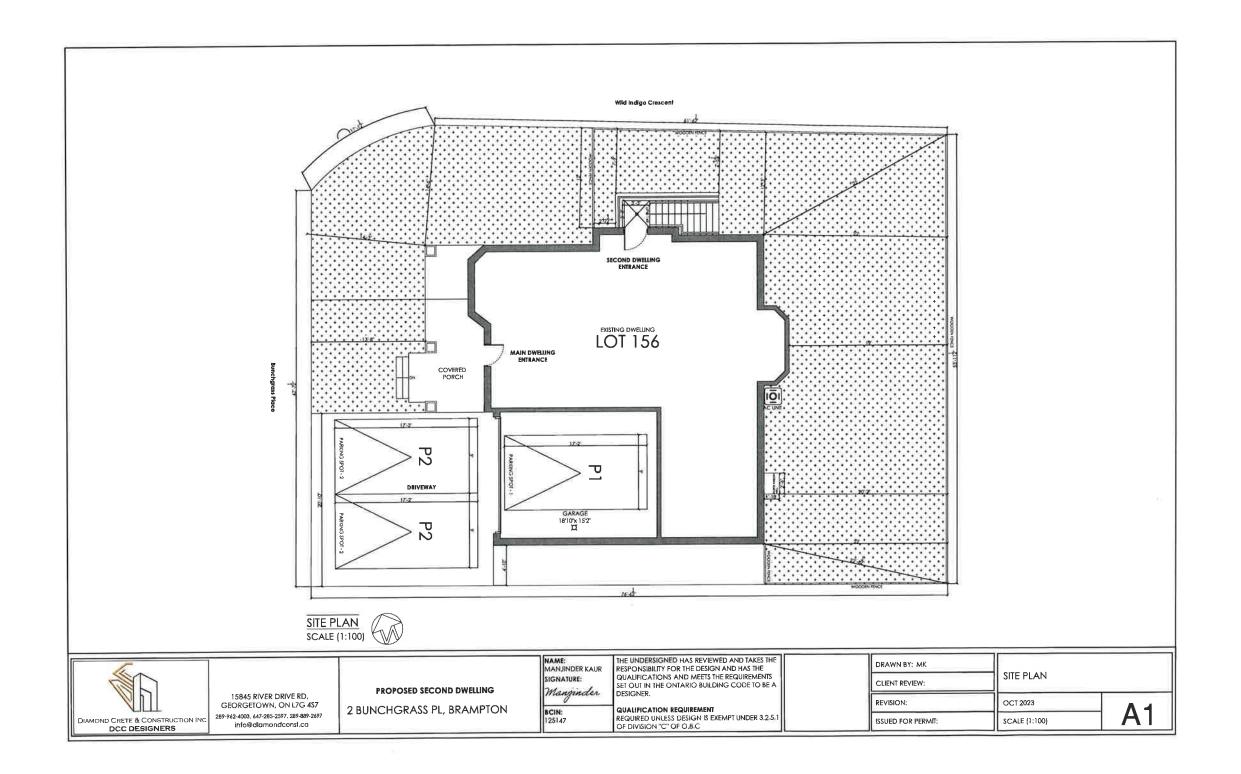

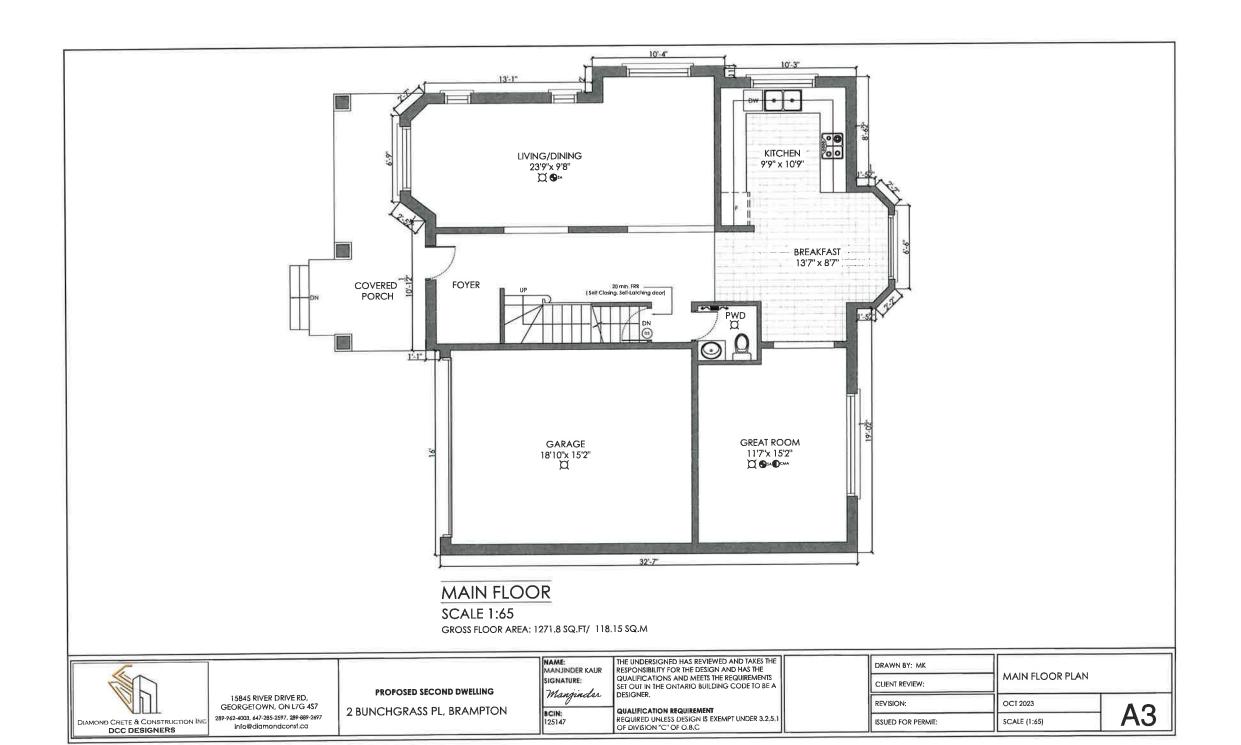

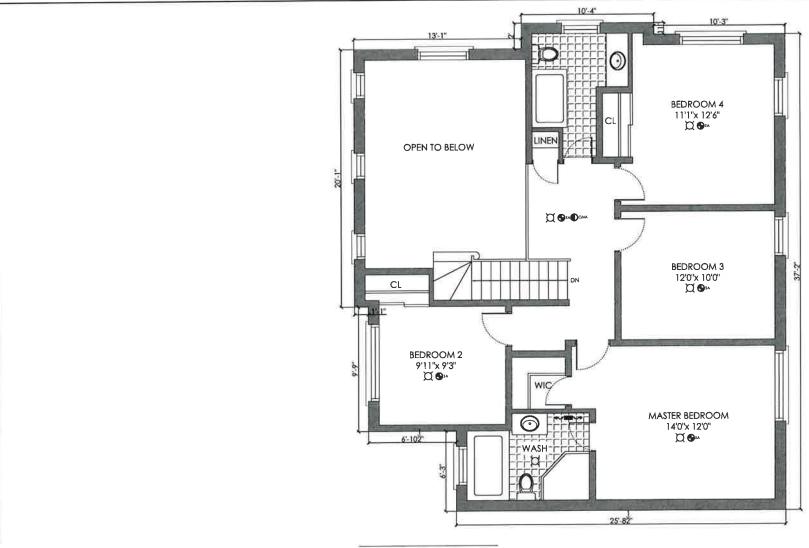

SECOND FLOOR

SCALE 1:65

GROSS FLOOR AREA: 971.5 SQ.FT/ 90.25 SQ.M



15845 RIVER DRIVE RD, GEORGETOWN, ON L7G 4S7 289-962-4003, 647-285-2597, 289-889-2697 Info@dlamondconst.ca

PROPOSED SECOND DWELLING

2 BUNCHGRASS PL, BRAMPTON


NAME: MANJINDER KAUR SIGNATURE:


Manginder BCIN: 125147

THE UNDERSIGNED HAS REVIEWED AND TAKES THE RESPONSIBILITY FOR THE DESIGN AND HAS THE QUALIFICATIONS AND MEETS THE REQUIREMENTS SET OUT IN THE ONTARIO BUILDING CODE TO BE A

QUALIFICATION REQUIREMENT REQUIRED UNLESS DESIGN IS EXEMPT UNDER 3,2,5,1 OF DIVISION "C" OF O.B.C

DRAWN BY: MK			
CLIENT REVIEW:	SECOND FLOOR PLAN		
REVISION:	OCT 2023	Λ Λ	
ISSUED FOR PERMIT:	SCALE (1:65)	A4	

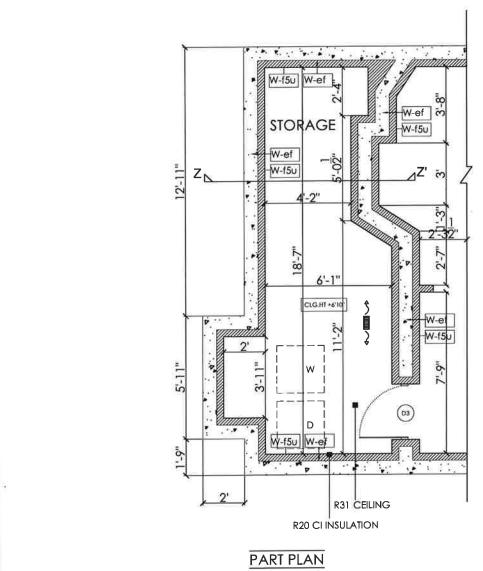

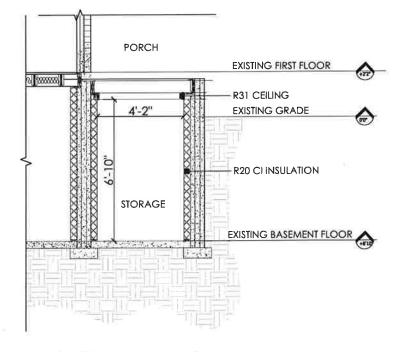

CROSS SECTION Z-Z' SCALE (1:40)

SCALE (1:40)



15845 RIVER DRIVE RD. GEORGETOWN, ON L7G 4\$7 289-962-4003, 647-285-2597, 289-889-2697 Info@diamondconst.ca

PROPOSED SECOND DWELLING

2 BUNCHGRASS PL, BRAMPTON


NAME: MANJINDER KAUR SIGNATURE: Manginder

THE UNDERSIGNED HAS REVIEWED AND TAKES THE RESPONSIBILITY FOR THE DESIGN AND HAS THE QUALIFICATIONS AND MEETS THE REQUIREMENTS SET OUT IN THE ONTARIO BUILDING CODE TO BE A DESIGNER.

BCIN: 125147

QUALIFICATION REQUIREMENT REQUIRED UNLESS DESIGN IS EXEMPT UNDER 3.2.5.1 OF DIVISION "C" OF O.B.C

	DRAWN BY: MK CLIENT REVIEW:	SECTION	
	REVISION:	OCT 2023	ΛE
1	ISSUED EOD DEDAAIT:	SCALE (1:40)	I AD I

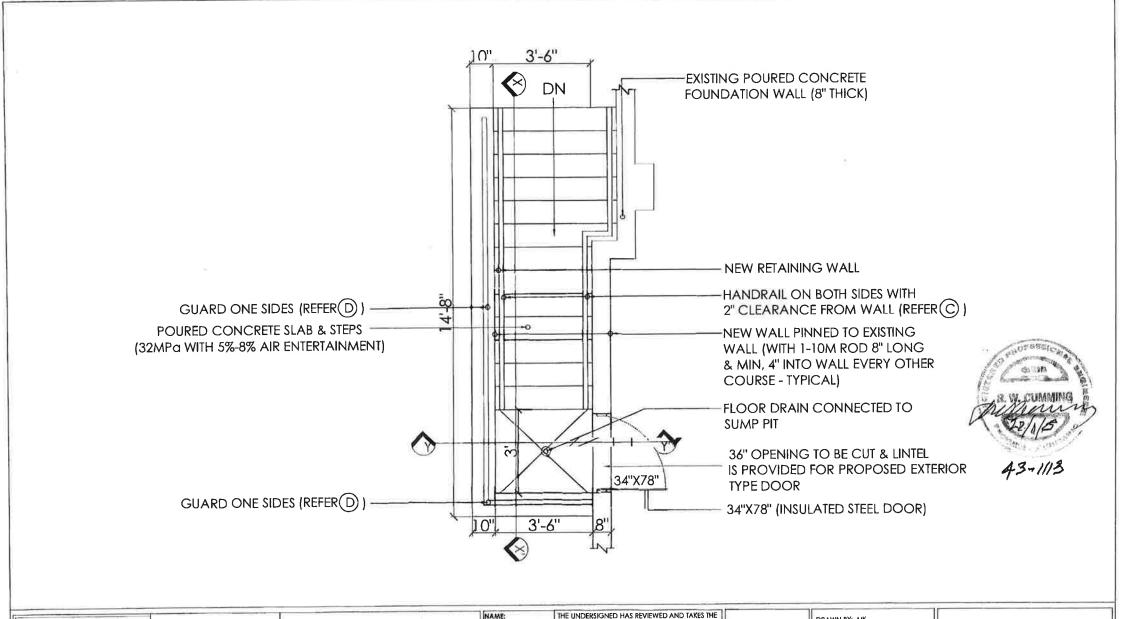



15845 RIVER DRIVE RD, GEORGETOWN, ON L7G 4S7 289-942-4003, 647-285-2597, 289-809-2697 Info@diamondconsi.ca PROPOSED SECOND DWELLING
2 BUNCHGRASS PL, BRAMPTON

NAME: MANJINDER KAUR SIGNATURE: THE UNDERSIGNED HAS REVIEWED AND TAKES THE RESPONSIBILITY FOR THE DESIGN AND HAS THE QUALIFICATIONS AND MEETS THE REQUIREMENTS SET OUT IN THE ONTARIO BUILDING CODE TO BE A DESIGNER.

QUAUFICATION REQUIREMENT
7 REQUIRED UNLESS DESIGN IS EXEMPT UNDER 3.2.5.1
OF DIVISION "C" OF O.B.C

DRAWN BY: MK

CLIENT REVIEW:

REVISION:


PROPO


OCT 2023

PROPOSED WALKOUT PLAN

ISSUED FOR PERMIT: SCALE (1:30)

A6

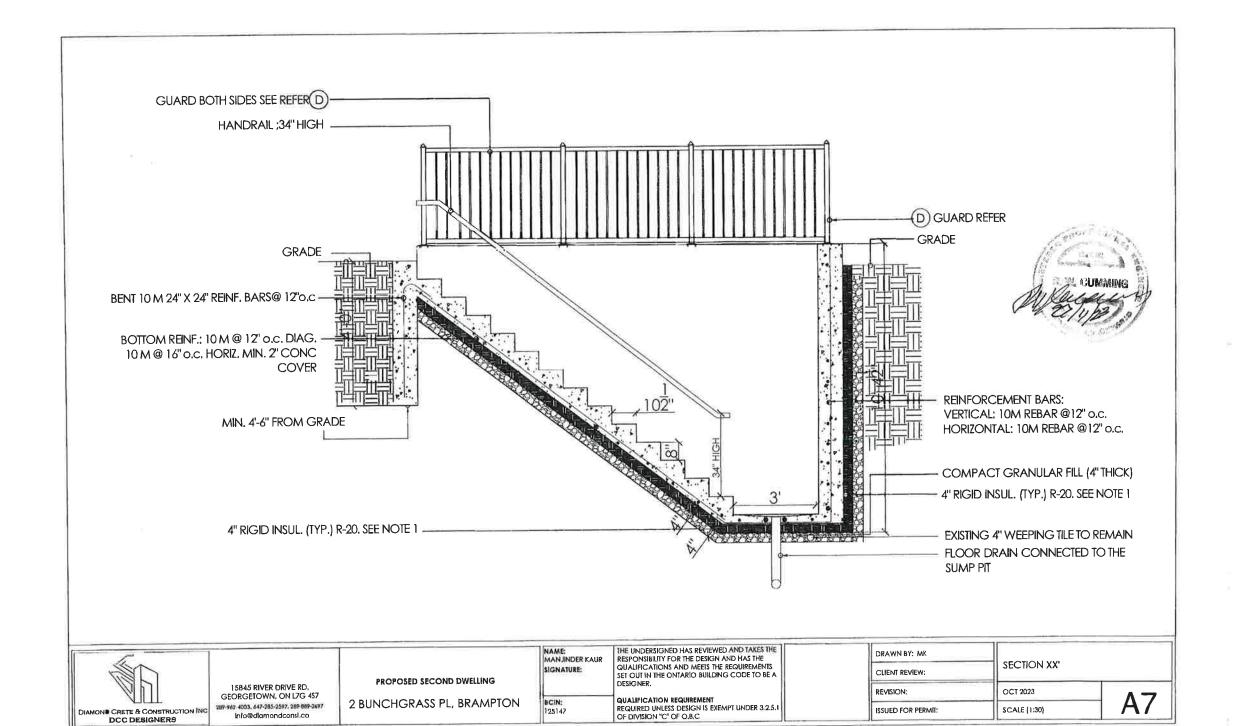

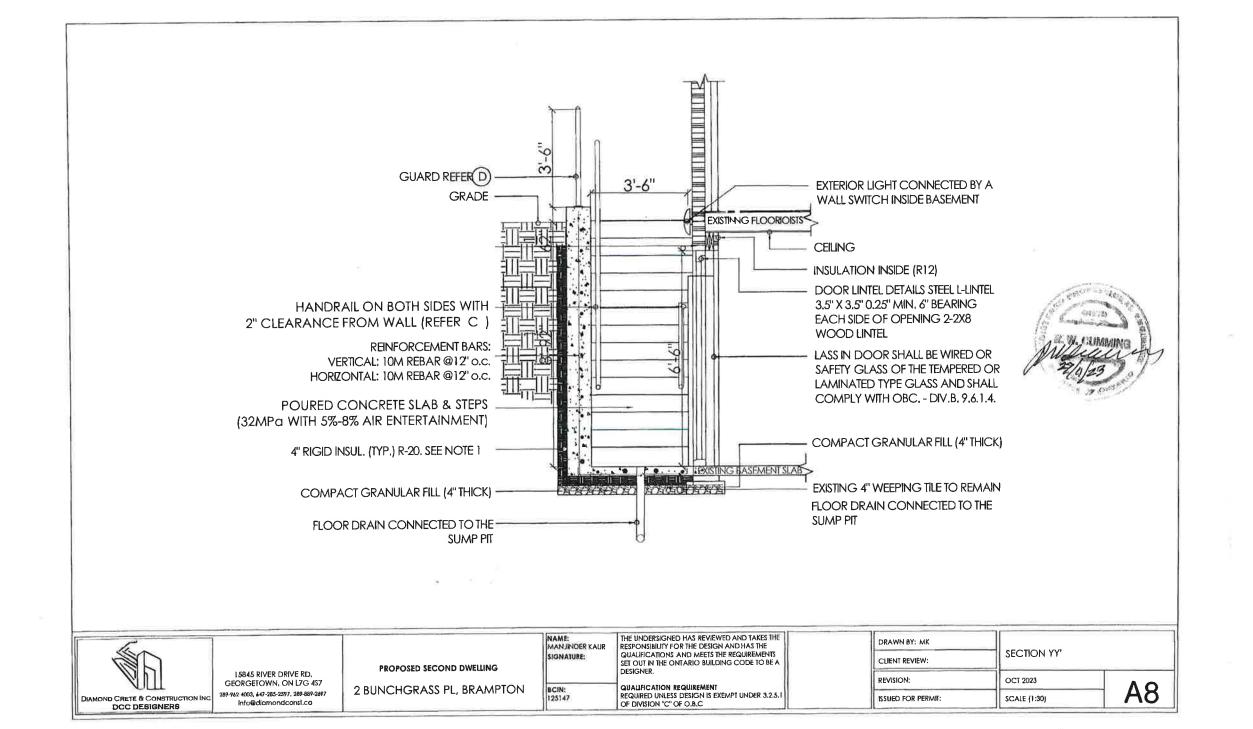

GENERAL NOTES

A FOOTINGS:

FOOTINGS SHALL REST ON NATURAL UNDISTURBED SOIL OR COMPACTED GRANULAR FILL WITH A MINIMUM SOIL BEARING CAPACITY OF 75 kPa

EXTERIOR STAIRS:

8" RISE MAXIMUM

5" MINIMUM 14" MAXIMUM

9 1/4" TREAD MINIMUM

14" MAXIMUM

HANDRAILS:

HANDRAILS SHOULD BE BETWEEN 34 TO 38 IN ABOVE THE TREAD AT THE LEADING EDGE LINE.
2 IN CLEARANCE FROM THE WALL IS REQUIRED. START AND END POINT OF HANDRAILS MUST
NOT OBSTRUCT PEDESTRIAN TRAFFIC OR CREATE A HAZARD BOTH SIDE HANDRAILS REQUIRED
IF STAIRS ARE 43 IN OR WIDER.

GUARDS (PRE-ENGINEERED):

42 INCH HIGH WHERE DISTANCE FROM GRADE TO BOTTOM OF WALKOUT EXCEEDS 5'-11" 36" FOR LESSER HEIGHTS, MAXIMUM 4" BETWEEN VERTICAL PICKETS.

E LIGHT

D

ELECTRIC FEED FOR THE LIGHT TO BE SEPARATE FROM ANY OTHER SWITCHED CIRCUIT.

EXTERNAL DOOR:

EXTERIOR DOOR GENERAL PERFORMANCE CRITERIA AND THERMAL RESISTANCE TO COMPLY WITH OBC 9, 7,3 INSTALLATION OF MANUFACTURED AND PRE-ASSEMBLED DOORS SHALL CONFORM TO THE MANUFACTURER'S INSTRUCTIONS.

ALL UNFINISHED PORTIONS OF THE GRAME AND OTHER COMPONENTS OF DOORS IN CONTACT WITH THE EDGES OF MASONRY OR CONCRETE SHALL BE PROTECTED WITH CAULKING.

INSULATION DETAILS:

RIGID INSULATION TO HAVE FOLLOWING SPECIFICATIONS:

1 STYROFOAM™ Brand SM Extruded Polystyrene Foam Insulation

ii RSI value of 0.87/25 mm [R-5 PER 1 INCH]

iii Board Size: [as indicated on Drawings],


iv Compressive Strength: 210 kPa


y Draining Capacity: > 0.72 m3/hr/m

INSULATION FINISHING:

INSTALL RIGID INSULATION ON EXISTING FOUNDATION WALL MIN 4' ABOVE EXISTING FOOTING INSULATIONS TO BE INSTALLED ON EXPOSED FOUNDATION WALL ONLY STARTING FROM GRANULAR FILL UNDER STEPS COVER INSULATION WITH 1/2" CEMENT BOARD INSTALL 21 1/2" GALVANIZED 'J' TRACK TO SECURE AND PROTECT ALL EXPOSED EDGES ALL JOINTS TO THE EXISTING WALL AND NEW STEPS MUST BE CAULKED APPLY SEAL GUARD TO ALL JOINTS ON CEMENT BOARD PARGE CEMENT BOARD OR APPLY ACRYLIC FINISH

RETAINING WALL:
10" POURED CONCRETE WALL DOES NOT REQUIRE REBAR IF BACKFILL HEIGHT DOES NOT EXCEED
4'-7", PROVIDE 10M REBAR @ 12" o.c. EACH WAY FOR BACKFILL HEIGHTS EXCEEDING 4'-7".

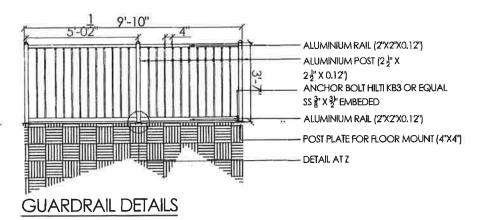

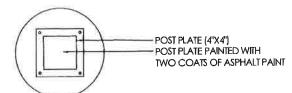

DETAIL AT Z






15845 RIVER DRIVE RD, GEORGETOWN, ON L7G 4S7 289-962-4003, 647-265-2597, 289-889-2697 Injo@diamondconst.ca PROPOSED SECOND DWELLING
2 BUNCHGRASS PL, BRAMPTON

NAME:
MANJINDER KAUR
SIGNATURE:
THE UNDERSIGNED HAS REVIEWED AND TAKES THE
RESPONSIBILITY FOR THE DESIGN AND HAS THE
QUALIFICATIONS AND MEETS THE REQUIREMENTS
SET OUT IN THE ONTARIO BUILDING CODE TO BE A
DESIGNER.

BCIN: QUALIFICATION REQUIREMENT
REQUIRED UNLESS DESIGN IS EXEMPT UNDER 3.2.5.1
OF DIVISION "C" OF O.B.C

DRAWN BY: MK CLIENT REVIEW:	GUARD RAIL DETAI	ILS
REVISION:	OCT 2023	100
ISSUED FOR PERMIT:	SCALE (1:30)	A9

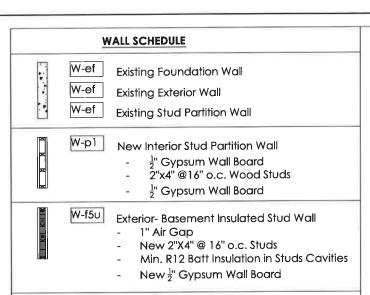

- 1 Layer ½" Regular GWB 2"X4" Wood Stud @ 16" o.c. Fire Insulation in Cavities 1 Layer 1" regular GWB

New Interior- 30 min Fire Separation (W1c)

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		$\overline{\Box}$	-	MIN 550 MM
Ē	3'-8"	32	\vdash	CHADE
LESS THEN:	ENABLE PORTION OF V OF UNOBSTRUCTED OF 1.9 SQLFT O CONFORM TO OBC GRESS WINDOW FOR F	PEMING NOT		
8.9910 I (E	MAXEMENT	SEURCOMA	WADO 10 EXT	OW WILL TO DRAIN WEEPING THE

LEGEND				
Ф"	SMOKE ALARM			
Ф°	CM ALARM			
⊕ _{n∞}	DUCT SMOKE DETECTOR			
	EXHAUST FAN DUCTED DIRECLY OUTSIDE			
¥°	FLOOR DRAIN			
◆○■○	HEAT REGISTER			
₩	AIR RETURN			
- 	LIGHT FIXTURES			
0	SPRINKLER			
4	EMERGENCY LIGHT			
P	ELECTRICAL OUTLET			
(L-1)	LINTEL NOTE			
0	DOOR TAG			
W-	WALL TAG			
(W)	WIDOW TAG			
©_>	CEILING TAG			

CEILING SCHEDULE

C1n Full Height Ceiling- 15min. fire separation (C.A. #152)

- -EX. Floor finish
- -EX. Floor Joist
- -Optional Insulation Cavities
- -1 Layer ½" Gypsum Board
- *NOTE: NO OPENINGS ARE PERMITTED
- *PART 11 COMPLIANCE ALTERNATIVE APPLIED





15845 RIVER DRIVE RD, GEORGETOWN, ON L7G 4S7 289-962-4003, 647-285-2597, 289-889-2697 info@diamondconst.ca

PROPOSED SECOND DWELLING

2 BUNCHGRASS PL, BRAMPTON

NAME: MANJINDER KAUR SIGNATURE:

BCIN: 125147

THE UNDERSIGNED HAS REVIEWED AND TAKES THE RESPONSIBILITY FOR THE DESIGN AND HAS THE QUALIFICATIONS AND MEETS THE REQUIREMENTS SET OUT IN THE ONTARIO BUILDING CODE TO BE A Manginder

> QUALIFICATION REQUIREMENT REQUIRED UNLESS DESIGN IS EXEMPT UNDER 3.2.5.1 OF DIVISION "C" OF O.B.C

DRAWN BY: MK CLIENT REVIEW:	GENERAL NOTES	
REVISION:	OCT 2023	A 1 O
ISSUED FOR PERMIT:		AIU

GENERAL NOTES:

- ALL CONSTRUCTION SHALL MEET WITH THE LATEST REQUIREMENTS OF:
- AUTHORITIES HAVING JURISDICTION.
- ZONING RESTRICTIONS AND COMMITTEE OF ADJUSTMENT DECISIONS.
- ONTARIO BUILDING CODE
- •ONTARIO REGULATIONS UNDER THE HEALTH AND PROMOTION ACT.
- •ONTARIO FIRE CODE
- •ALL SUPPLIERS SPECIFICATIONS RE: THE TECHNICAL METHODS TO USE MATERIALS AND THE SAFEST SYSTEM TO INSTALL BREAKABLE OR HANGING MATERIALS SUCH AS GLASS OR LIGHT FIXTURES ETC.

II. CONTRACTOR SHALL:

- $\bullet ce$ Confirm all dimensions on site and report any discrepancies or errors to the architect and the parties involved.
- •œ Work only from the approved permit drawings and specifications that are stamped and signed by the architect.
 •œ retain a certified surveyor to chalk out all property lines,
- BUILDING BOUNDARIES AND LIMITATIONS AND CONFIRM GRADES OF THE LOT.
- •PRIOR TO EXCAVATION, TAKE PRECAUTION IN SUCH A MANNER TO PREVENT DAMAGE TO ADJACENT PROPERTIES, EXISTING STRUCTURE, UTILITIES, ROADS AND SIDEWALKS.
- •PRIOR TO CONSTRUCTION CHECK WITH ALL INSPECTORS OF ALL AUTHORITIES HAVING JURISDICTION ON THE PROJECT REGARDING SCHEDULES OF INSPECTIONS AND ARRANGE FOR THEIR SITE VISITS AND CALL ALL UTILITY COMPANIES (GAS, HYDRO, CABLE, WORKS DEPT....etc.) TO CHECK ALL EXISTING LINES, PIPES, TREES,
- •PROVIDE ALL REQUIRED LATERAL FRAMING SUPPORTS (TO ENSURE RIGIDITY AND STURDINESS) THAT DO NOT SHOW ON DRAWINGS
- •NOT PLACE MATERIALS NOR PLACE OR OPERATE EQUIPMENT IN OR ADJACENT TO AN EXCAVATION IN A MANNER THAT MAY ENDANGER THE INTEGRITY OF THE EXCAVATION OR ITS SUPPORTS.
- NOT SCALE DRAWINGS UNLESS OTHERWISE MENTIONED
- •COMPLY BY SOIL REPORT WHENEVER APPLICABLE.
- •USE ONLY APPROVED SUPPLIERS & INSTALLERS

III. SHOP DRAWINGS:

- CE THE REVIEW OF SHOP DRAWINGS IS FOR THE SOLE PURPOSE OF ASCERTAINING CONFORMANCE WITH THE GENERAL DESIGN CONCEPT. IT SHALL NOT MEAN APPROVAL OF THE DETAIL DESIGN INHERENT IN THE SHOP DRAWING, RESPONSIBILITY FOR WHICH SHALL REMAIN WITH THE CONTRACTOR SUBMITTING SAME, AND SUCH REVIEW SHALL NOT RELIEVE THE CONTRACTOR OF HIS RESPONSIBILITY FOR MEETING ALL REQUIREMENTS OF THE CONTRACT DOCUMENTS. THE CONTRACTOR IS RESPONSIBLE FOR DIMENSIONS TO BE CONFIRMED AND CORRECTED AT THE JOB SITE, FOR INFORMATION THAT PERTAINS SOLELY TO FABRICATION, PROCESSES OR TO TECHNIQUES OF CONSTRUCTION AND INSTALLATION AND OR COORDINATION OF THE WORK OF ALL SUB-TRADES.
- •ALL SHOP DRAWINGS SHALL BE STAMPED BY THE MANUFACTURER'S STRUCTURAL ENGINEER PRIOR TO SUBMITTING FOR REVIEW BY
- •SEQUENCE OF SHOP DRAWINGS REVIEW: CONTRACTOR STRUCTURAL ENGINEER ALL OTHER INVOLVED CONSULTANTS -
- •SHOP DRAWINGS SHALL BE PROVIDED FOR: STEEL PREFAB. CONC. CANOPIES WINDOWS DOORS

IV.RENOVATION AND ADDITION CONSTRUCTION:

- •REPAIR ALL DEFECTIVE OR DAMAGED CONDITIONS IN BUILDING AND SITE THEN FINISH THEM TO MATCH
- •ALL EXISTING CONSTRUCTION SHALL BE ALL FINISHED UNLESS OTHERWISE MENTIONED, CHECK WITH ARCHITECT.

V. BONDING EXISTING TO NEW CONSTRUCTION:

- •PROVIDE 1/2" DIA. X 6" LONG ANCHOR BOLTS SPACED 3"-0" O/C VERTICALLY OR HORIZONTALLY BETWEEN EXISTING AND NEW STUDS AND ROOF FRAMINGS.
 •PROVIDE OVERLAPPED VERTICAL JOINTS BETWEEN EXISTING AND NEW MASONRY VENEERS. WALLS AND FOUNDATION.
- •SAND BLASTED AREA SHALL BE FINISHED WITH A CLEAR SEALANT.

CONSTRUCTION SPECIFICATIONS

1 WOOD

- •ALL WOOD CONSTRUCTION SHALL BE IN ACCORDANCE WITH CSA 086
 •BEAMS AND LINTELS & JOISTS SHALL BE KILN DRIED, STAMPED SPRUCE #2,
 UNLESS
- OTHERWISE MENTIONED.
- •ALL WOOD MEMBERS WHICH ARE PLACED IN SOIL SHOULD BE PRESSURE TREATED WITH A WOOD PRESERVATIVE.
- •ALL EXTERIOR WOOD SHALL BE STAINED OR PAINTED.

2 CONCRETE

- •SHALL COMPLY WITH CSA A23 SERIES INCL. COLD WEATHER CONCRETING.
- •MINIMUM COMPRESSIVE STRENGTH OF UNREINFORCED CONCRETE: 25 MPA AND 35 MPA FOR LOADING DOCK AND FOR ALL EXPOSED CONCRETE AFTER 28 DAYS WITH AIR ENTRAINMENT 6 %
- •MAXIMUM SLUMP 3"
- •PROVIDE SEALANT-TOPPED EXPANSION JOINT BETWEEN EXISTING AND NEW CONCRETE FLOORS.
- REINFORCEMENT SHALL CONFORM CSA 30.12 GRADE 58

3. STEEL

- •SHALL CONFORM TO CSA STANDARDS & CAN 3-G40.21 (STRUCTURAL STEEL QUALITY)
- •SHALL BE TREATED ON THE OUTSIDE SURFACE WITH AT LEAST ONE COAT OF RUST INHIBIT PAINT.
- •ALL EXPOSED STEEL SHALL BE GALVANIZED.
- •STEEL GRADE
- I) HOLLOW SECTION: G 40.21-M 350W
- BEAMS & COLUMNS: G 40.21-M 350W
- O.W.S.J.: LIVE LOAD DEFLECTION SHALL NOT EXCEED 1/360 OF SPAN,
 TOTAL LOAD DEFLECTION SHALL NOT EXCEED 1/300 OF SPAN.

 ON STAN SHALL NOT EXCEED 1/300 OF SPAN.
- •WELDING SHALL COMPLY WITH CSA W59 AND EXECUTED BY CERTIFIED WELDER.
- ALL BOLTS A 325 BOLTS.
- •FOR ALL STEEL FABRICATION, PROVIDE SHOP DRAWINGS AND CALCULATIONS STAMPED BY P. ENG.

. MINIMUM STRUCTURAL BEARING

(PROVIDE 2 SOLID MASONRY BLOCKS BELOW BEARING)

- WOOD JOIST: 2"
- WOOD BEAMS: 4"
- •STEEL BEAM: 8"
- •STEEL LINTEL: 8"
- \bullet O, W.S.J. : 6" ON MASONRY & 2 1/2" ON STEEL & SHALL HAVE 4" DEEP SHOES

MASONRY

- •SHALL HAVE 1000 PSI MIN. CRUSHING STRENGTH.
- •PROVIDE GALVANIZED STANDARD BLOCK-LOK EACH 2ND COURSE.
- •VERTICAL JOINTS SHALL BE STAGGERED & CORNERS INTERLOCKED.
- •PROVIDE SHOP DRAWINGS STAMPED BY P. ENG. FOR STONE VENEER & PREFAB PANELS.
- •VERTICAL CRACK CONTROL JOINTS (DESIGNED TO RESIST MOISTURE PENETRATION AND KEYED TO PREVENT RELATIVE DISPLACEMENT OF THE WALL PORTIONS ADJACENT TO THE JOINT) SHALL BE PROVIDED IN FOUNDATION WALLS MORE THAN 82"-0" LONG AT INTERVALS OF 50"-0" MAX. AND FLUSH WITH OPENING JAMBS.

3. FOUNDATION

- •FOOTING AND SONO TUBE FOUNDATION SHALL BEAR ON UNDISTURBED SOIL OR COMPACTED ENGINEERED FILL (TO 98 % STANDARD PROCTOR DENSITY) CAPABLE OF A BEARING OF 3000 PSF, SOIL SHALL BE CHECKED BY SOIL ENGINEER
- •DEPTH OF FOOTING ARE PROVISIONAL & SUBJECT TO VERIFICATION ON SITE BY A SOIL ENGINEER.
- •ALL EXTERIOR (OR EXPOSED TO EXTERIOR) WALLS, PARTITION, COLUMNS SHALL BE PROVIDED WITH 4'-0" DEEP FOUNDATION.
- •PROVIDE 5/8" DIA. X 16" LONG ANCHOR TIES (8" IN NEW CONSTRUCTION).
- •TOP TWO COURSES OF CONCRETE BLOCKS SHALL BE FILLED WITH CONCRETE.
- •PROVIDE MIN 8"X2'-0" WIDE STRIP FOOTING BELOW ANY INTERIOR LOAD BEARING WALL

4. COLUMNS

•SHALL BE SECURELY FASTENED TO CENTER OF FOUNDATIONS AND TO THE SUPPORTED MEMBERS TO PREVENT LATERAL MOVEMENT.

5. DESIGN LOADS

UN FACTORED DESIGN LOADS

- 1. SNOW LOAD = kPa (PART 4 DESIGN, Ss= 2.0 kPa, Sr = 0.4kPa)
- ROOF DEAD LOAD = 0.75kPa
- SECOND FLOOR DEAD LOAD=0.75kPa
- MAIN FLOOR DEAD LOAD=1.0kPa
- OCCUPANCY LIVE LOAD=1.9kPa
- WIND PRESSURE q(1/50) = 0.44 Kpa
- ASSUMED SOIL BEARING CAPACITY =75 kPa
- 8. GUARDS TO BE BUILT ACCORDING TO OBC 2012 SB-7



15845 RIVER DRIVE RD, GEORGETOWN, ON L7G 4S7 289-962-4003, 647-285-2597, 289-889-2697 Info@diamondconst.ca PROPOSED SECOND DWELLING

2 BUNCHGRASS PL, BRAMPTON

NAME: MANJINDER KAUR SIGNATURE:

125147

Manginder

THE UNDERSIGNED HAS REVIEWED AND TAKES THE RESPONSIBILITY FOR THE DESIGN AND HAS THE QUALIFICATIONS AND MEETS THE REQUIREMENTS SET OUT IN THE ONTARIO BUILDING CODE TO BE A DESIGNER.

QUALIFICATION REQUIREMENT

REQUIRED UNLESS DESIGN IS EXEMPT UNDER 3.2.5.1 OF DIVISION "C" OF O.B.C

DRAWN BY: MK		
CLIENT REVIEW:	GENERAL NOTES	
REVISION;	OCT 2023	A 4 4
ISSUED FOR PERMIT:		AH

ALL CONSTRUCTION TO ADERE TO THESE PLANS AND SPECS AND TO CONFORM TO ONTARIO BUILDING CODE AND ALL OTHER APPLICABLE CODE AND AUTHORITIES HAVING JURISDICTION THES REQUIREMENTS ARE TO BE TAKEN AS MINIMUM SPECIFICATIONS ONT REG 350/06

ROOF CONSTRUCTION

NO210 ROOF ASPHALT SHINGLES ON 1/8" PLYWOOD SHEATHING WITH H-CLIPS APPROVED WOOD TRUSSES @24" O.C. MAX APPROUVED EAVES PROTECTION TO EXTEND 3' FROM EDGE OF ROOF AND MIN. 12' INNER FACE OF EXTERIOR WALL.

2"X4" TRUSS BRACING @6" O.C. BOTTOM CORD PREFIN, ALUM, EAVSTROUGH, FASCIA, RWL & VENTED SOFFIT ATTIC VENTILATION 1:300 OF INSULATED FILING AREA WITH 50% AT FAVS.

STONE VENEER WALL CONSTRUCTION
4" FACE STONE, 1" AIR SPACE 0,03 THICK X 7/8 WIDE GALVANIZED METAL TIES INSRALLED W/ GALVANIZED SPIRAL NAILS 32" O., C. HORIZ.16" O.C VERT.

SHEATHING PAPER, LAYERS TO OVERLAP EACH OTHER ON 1/2" EXTERIOR TYPE SHEATHING , 2"X6" WOOD STUDS @16" O.C. R24 BATT INSULATION IN CONTINUOUS CONTACT W/SHEATHING AND VAPOUR BARIER /AIR BARIOUR BOUBLE PLAT AT THE TOP, SINGLE PLATE AT THE BOTTOM

STONE VANEER @ FDN. WALL

20 MM POLY FLASHING MINIMUM 6" UP BEHIND SHEATHING PAPER, WEEPING HOLES @ MIN 2'X7" APART

STUCCO WALL CONSTRUCTION

3 COATS OF STUCCO FINISH ON STUCCO LATH ON 1 1/2" T&G EPS INULATION BOARD FASTENED WITH NAILS OF MIN 3.2 MM DIA. W/ MIN 11.1 MM HEAD SAPCED @ MAX, 6" O.C VERTICALLY AND 16" O.C. HORIZONTALLY OR 4" O.C. VERTICALLY AND 24" HORIZONTALLY ON SHEATHING PAPER . @ NOT LESS THAN 8" ABOVE FINISHED GROUND

WOOD SIDING WALL CONSTRUCTION

FRAME WALL CONSTRUCTION FINISH WITH VYNEL SIDING SIDING PAPER LAYERS TO OVERLAP EACH OTHER EXTERIOR TYPE SIDING ON 2X6 WOOD STUDS @ 16" O.C DOUBLE PLATE AT THE TOP SINGLE PLATE @ BOTTOM R24 BATT INSULATION IN CAVITIES.

FOUNDATION WALLS

BITUMINOUS DAMPROOFING ON 1/4" PARGING ON 10" CONCRETE BLOCKS FDN. WALL TOP COURSE FILLED W/ CONCRETE PROVIDE PARGING COVED OVER 24"X12" POURED CONCRETE FOOTING TO BEAR ON UNDISTURBED SOIL PROVIDE DRAINAGE LAYER:

- MIN 3/4" MINERAL FIBRE INSULATION W/ A DENSITY OF NOT LESS THAN 3.6 LB/FT OR
- MIN. 4" OF FREE DRAINAGE GRANULAR MATERIAL OR
- A B.M.E.C. APPROVED DRAINAGE LAYER MATERIAL

REDUCTION IN FOUNDATION WALL THICKNESS

WHERE THE TOP OF FOUNDATION WALL IS REDUCED IN THICKNESS TO PERMIT THE INSTALLATION OF FLOOR JOIST, THE REDUCED SECTION SHALL BE NOT MORE 13 3/4" HIGHT AND NOT LESS THAN 3 1/2" THICK. WHERE THE TOP OF FOUNDATION WALL IS REDUCED IN THICKNESS TO PERMIT THE INSTALLATION OF A MASONRY EXTERIOR FACING .. THE REDUCED SECTION SHALL BE NOT LESS 3 1/2" THICK AND TIED TO THE FACING MATERIAL W/ METAL TIES.

INTERIOR STUD PARTITIONS (NO BEARING)

NO BEARING PATITIONS 1/Z DRYWALL FINISH ON BOTH SIDES OF 2"X4" WOOD STUDS @16" O.C. 2 TOP PLATES & 1 BOTTOM PLATE PROVIDE SOUND ATTENUATION INSULATION IN BATHROOM WALLS & WHERE INDICATED ON PLANS.

INTERIOR STUD PARTITIONS (BEARING)
BEARING PAITHONS 1/2" DRYWALL FINISH ON BOTH SIDES OF 2"X6" WOOD STUDS @16" O.C., 2 TOP PLATES & 1 BOTTOM PLATE PROVIDE SOUND ATTENUATION INSULATION IN BATHROOM WALLS & WHERE INDICATED ON

WALL INSULATION

MIN. R24 INSULATION BATTS TO COVER THE INTERIOR FACE OF THE EXTERIOR WALLS WITH CONTINUOUS AIR / VAPOUR BARIER

FOUNDATION INSULATION

R20 INSULATION BLANKET WITH AIR/VAPOUR BARRIER FROM SUB-FLOOR TO BASEMENT SLAB, DAMPPROOF W/ BLDG, PAPER BETWEEN THE FOUNDATION WALL AND INSULATION UP TO GRADE LEVEL.

STUD WALL REINFORCEMENT
PROVIDE WOOD BLOCKING REINFORCEMENT TO STUD WALLS FOR FUTURE

INSTALATION IN MAIN BATHROOM 33"X36" A.F.F. BEHIND TOILET 33" A.F.F. ON THE WALL OPPOSITE THE ENTERANCE TO THE TUB AND SHOWER

 $\frac{\text{SILL PLATE}}{2\text{"X6" SILL PLATE FASTENED TO FOUNDATION WALL WITH MIN.}~1/2\text{" DIA}.$ ANCHOR BOLTS EMBEDDED MIN, 4" IN CONCRETE @ 7'X10" O,C MAX, PROVIDE CAULKING FOR GASKET BETWEEN PLATE

FLOOR FRAMING
5/8" T&G PLYWOOD NAILED AND GLUED ON 2" X 8" I-JOIST WITH MIN, 1 1/2" END BEARING ON EACH SIDE WITH CROSS BRIDGING OR SOLID BLOCKING @ MAX. 6'X11" O.C.

ENGINEERED FLOOR FRAMING
5/8" T&G PLYWOOD NAILED AND GLUED ON 2" X 10" JOIST WITH MIN, 1 1/2" END BEARING ON EACH SIDE WITH CROSS BRIDGING OR SOLID BLOCKING @ MAX. 6"X11" O.C

MIN. 3" 25 MPA CONC. SLAB ON 4" COARSE GRANULAR FILL WITH DAMP PROOFING BELOW SLAB

STEEL BASEMENT COLUMN

MIN 3" DIA, AND WALL THIKNESS OF MIN, 3/16" WITH 4"X4"X1/4" THICK STEEL PLATE WELDED TOP AND BOTTOM AND SUPPORTED ON A 36"X36"X18" THK CONCRETE FOOTING ...

W 150X22 SITING ON STEEL COLUMN ON ONE END AND 3 1/2" END BEARING ON FOUNDATION WALL ON THE OTHER END WITH 1"X3" CONTINUS WOOD STRAPPING ON EACH SIDE OF THE BEAM

GRADE
SLOPE GRADE AWAY FROM BUILDING FACE & PROVIDE SEMI SOLID BLOCK COURSE AT OR BELOW GRADE LEVEL.

4" DIA, WEEPING TILE W/ 6" CRUSHED STONE OVER AND AROUND

CRAWL SPACE CLEARANCE MIN. 24" CLEAR TO U/S OF STRUCTURE PROVIDE 1/64" POLY GROUND COVER MIN. 11 13/16" OVERLAP, SEALED AT JOISTS & FUNDATIONS WALL & WEIGHTED DOWN W/MIN ACCESS OPENING OF 2' 7" X 1' 10"

ATTIC ACCESS HATCH 22"X28" WITH WEATHERSTRIPPING (MIN.3.4FT2) RSI 8 B (R50) RIGID INSULATION BACKING.

MIN 5/8" DRYWALL FINISH ON ALL CEILINGS .WITH CONTINUOS AIR VAPOUR BARIER WITH MIN. R40 INSULATION FOR ATTIC

DRYER VENT

CAPPED DRYER EXHAST VENTED TO EXTERIOR DUCT SHALL CONFORM TO OBC 2012 DIV. B PART 6

WASHROOM EXHAUST
MECHANICAL EXHAST FAN, VENTED TO EXTERIOR ,TO PROVIDE AT LEAST ONE AIR CHANGE PER HOUR .PROVIDE DUCT SCREEN AS PER OBC 2012

CABINETRY ABOVE RANGE

FRAMING FINISHES AND CABINETRY ABOVE A RANGE MUST HAVE MIN 2'06" CLEARANCE, UNLESS FRAMING, FINISHES AND CABINETRY ARE NON-COMBUSTABLE OR ARE PROTECTED AS PER 9, 10, 22, (2) (10) (1) AND

SMOKE ALARM O.B.C. 9.10.19

ROVIDE ONE PER FLOOR NEAR THE STAIRS CONNECTING THE FLOOR LEVEL ALARM TO BE CONNECTED TO AN ELECTRICAL CIRCUT AND INTERCONECTED TO ACTIVATE ALL ALARMS IF 1 SOUNDS IT SHOULD BE INSTALED IN CONFORMANCE WITH CAN/ULC-\$553

CARBON MOMOXIDE ALARM O.B.C. 9.33.4,
PROVIDE CARBON MONOXIDE DETECTOR ADJACENT TO EACH SLEEPING

 EXCAVATION AND BACKFILL
 EXCAVATION SHOULD BE UNDER TAKEN IN SUCH A MANNER SO AS TO PREVENT DAMAGE TO EXISTINF STRUCTURES ADN ADJACENT PROPERTY THE TOPSOIL AND VEGETABLE MATTER IN UNEXCAVATED AREAS UNDER A BUILDING SHALL BE REMOVED, THE BOTTOM OF EXCAVATIONS FOR FOUNDATIONS SHALL BE FREE OF ALL ORGANIC MATERIALS.

IF TERMITES ARE KNOWN TO EXIST, ALL STUMPS, ROOTS AND WOOD DEBRIS SHALL BE REMOVED TO A MIN DEPTH OF 11 3/4" IN EXCAVATED AREAS UNDER A BUILDING AND THE CLEARANCE BETWEEN UNTREATED STRUCTURAL WOOD ELEMENTS AND THE GROUND SHALL BE NOT LESS THAN 17 3/4"

BACK FILL WITHIN 23 5/8" OF THE FOUNDATION WALLS SHALL BE FREE OF DELETERIOUS DEBRIES AND BOULDERS OVER 7/8" IN DIAMETER,

30 NOTCHING AND DRILLING OF TRUSSESS, JOISTS AND RAFTERS

HOLES IN FLOORS, ROOFS AND CEILING MEMBES TO BE MAX, 1/4 X ACTUAL DEPTH OF MEMBER AND NOT LESS THAN 2" FROM EDGES.

NOTCHES IN FLOORS, ROOF, CEILING MEMBERS TO BE LOCATED ON TOP OF THE MEMBER WITHIN 1/2 THE ACTUAL DEPTH FROM THE EDGE OF BEARING AND NOT GREATER THAN 1/3 JOIST DEPTH,

WALL STUDS MAY BE NOTCHED OR DRILLED PROVIDE THAT NOT LESS THAN 2/3 THE DEPTH OF THE STUD REMAINS, JF LOAD BEARING AND I 1/2 IF NON LOAD BEARING WALL.

ROOF TRUSS MEMBERS WHALL NOR BE NOTCHED, DRILLED, OR WEAKENED UNLESS ACCOMMODATED IN THE DESIGN.

WHEN CERAMIC TILES APPLIED TO A MORTAR BED WITH ADHISEVE, THE BED SHALL BE A MIN, OF 1/2" THICK & REINFORCED WITH GALVANIZED DIAMOND MESH LATH, APPLIED OVER POLYYETHYLENE ON SUBFLOORING ON JOISTS AT NO MORE THAN 16" O.C. WITH AT LEAST 2 ROWS CROSS

2 STORY VOLUME SPACE 2 STORY HIGH (18'X0") EXTERIOR WALL STUDS TO BE 2-2"X6" CONTINUOS STUDS @12" O.C. TRIPLE UP AT EVERY THIRD DOUBLE STUDS C/W 3/8" EXTERIOR PLYWOOD SHEATHING, PROVIDE SOLID WOOD BLOCKING BETWEEN WOOD STUDS @(4'X0") O.C. VERTICALY .FOR HORIZONTAL DISTANCE NOT EXCEEDING (9'-6") PROVIDE (2-2"X6") TOP PLATE AND A SINGLE BOTTOM PLATE .MIN. OF 3-2"X8" CONTINUS HEADER AT GROUND CEILING LEVEL TOE NAILED AND GLUED AT TOP, BOTTOM PLATES AND HEADERS FOR 9' HIGH GROUND/FIRST FLOOR CEILING ADD TRIPPLE HEADERS NAILED ONTOP OF FOUNDATION WALL SILL PLATE AND ADD 1-2"X6" CONTINUS BOTTOM PLATE NAILED ON TOP OF HEADERS.



15845 RIVER DRIVE RD. GEORGETOWN, ON L7G 4S7

289-962-4003, 647-285-2597, 289-889-2697 info@diamondconst.ca

PROPOSED SECOND DWELLING 2 BUNCHGRASS PL, BRAMPTON NAME: MANJINDER KAUR SIGNATURE

125147

Manginder

THE UNDERSIGNED HAS REVIEWED AND TAKES THE RESPONSIBILITY FOR THE DESIGN AND HAS THE QUALIFICATIONS AND MEETS THE REQUIREMENTS SET OUT IN THE ONTARIO BUILDING CODE TO BE A

QUALIFICATION REQUIREMENT

REQUIRED UNLESS DESIGN IS EXEMPT UNDER 3.2.5.1 OF DIVISION "C" OF O.B.C

DRAWN BY: MK CONSTRUCTION NOTES CLIENT REVIEW: REVISION: OCT 2023 ISSUED FOR PERMIT:



WINDOWS

- WINDOWS TO BE SEALED TO THE AIR AND VAPOR BARRIER
- WINDOWS THAT SEPERATE HEATED SPACE FROM UNHEATED SPACE
- SHALL HAVE AN OVERALL COEFFICIENT OF HEAT TRANSFER OF 1,6 OR
- AN ENERGY RATING OF NOT LESS THAN 21 FOR OPERABLE WINDOWS AND 31 FOR FIXED WINDOWS
- SKYLIGHTS SHALL HAVE AN OVERALL COEFFICIENT OF HEAT TRANSFER OF 2 8W/(M2 K)



DOORS AND WINDOWS

- EVERY FLOOR LEVEL CONTAINING A BEDROOM AND NOT SERVED BY AN EXTERIOR DOOR SHALL
 CONTAIN AT LEAST ONE WINDOW HAVING AN UNOBSTRUCTED OPEN AREA OF 0.35 m², AND NO
 DIMENSION LESS THAN 380MM, WHICH IS OPENABLE FROM THE INSIDE WITHOUT TOOLS.
- EXTERIOR HOUSE DOORS AND WINDOWS WITHIN 2000MM FROM GRADE SHALL BE CONSTRUCTED
 TO RESIST FORCED ENTRY AND SHALL HAVE A DEADBOLT LOCK.
- THE PRINCIPAL EXTRY DOOR SHALL HAVE EITHER A DOOR VIEWER, TRANSPARENT GLAZING OR A



HVAC NOTES

- CONTRACTOR TO COORDINATE DUCTS INSTALLATION WITH PIPES, ELECTRICAL LIGHTING &
 BUILDING STRUCTURE
- ALL MECHANICAL DUCTWORK SHALL BE CONCEALED IN ATTIC SPACE OR BULKHEADS UNLESS

 OTHERWISE NOTED.
- PROVIDE FLUE VENT, COMBUSTION AIR AND TERMINATION KIT FOR FURNACE AND INSTALL AS PER MANUFACTURER WRITTEN INSTRUCTION.
- PROVIDE BALANCING DAMPERS AT ALL AIR SUPPLY TAKE-OFFS:
- 1. AT BRANCH DUCT OFF MAIN TRUNK DUCT.
- 2. IN DRY WALL AREA, PROVIDE DAMPER AT GRILLE WITH APPROVED LOCKING DEVICE TO
- CUTTING FOR DUCTS SHALL BE DONE BY THIS CONTRACTOR OBTAIN APPROVAL BEFORE CUTTING
 IN ANY WALL, STRUCTURAL BEAM, FLOOR AND ROOF
- COORDINATE LOCATION OF EACH S.A., GRILLE AND RETURN AIR GRILLE ON SITE BEFORE CUTTING
 AND ROUGH-IN
- INSULATE ALL EXHAUST AIR DUCTS MIN, 150MM FROM WALLS OR ROOF.
- CONNECT GAS PIPE TO EACH UNIT COMPLETE WITH SHUT OFF VALVE, ALL GAS PIPING SHALL BE CSA AND CGA APPROVED, INSTALL PIPES IN ACCORDANCE TO B149.1 CODE.
- INSULATE ALL DUCTS IN CELLING SPACE, ATTIC SPACE AND GARAGE
- TEST AND BALANCE SYSTEM, SUBMIT BALANCING REPORT.
- COORDINATE ROUTING DUCTS AND LOCATION OF EACH GRILLE, FAN AND FURNACE WITH STRUCTURAL MEMBERS, PIPING, CONDUITS AND LIGHTING, OFFSET AS REQUIRED AND MAINTAIN REQUIRED SERVICE ACCESS.
- PROVIDE R.A., GRILLES AT HIGH AND LOW LEVELS, EACH GRILLE SHALL BE COMPLETED WITH
- USE SPACE BETWEEN JOISTS AND WALL STUDS FOR RETURN WHERE APPLICABLE, PROVIDE SHEET
 METAL JOISTS LINER (JL) AS REQUIRED.



MECHANICAL VENTILATION:

- A MECHANICAL VENTILATION SYSTEM IS REQUIRED WITH A TOTAL
- CAPACITY AT LEAST EQUAL TO THE SUM OF:
- 10.0 L/S EACH FOR BASEMENT AND MASTER BEDROOM
- 5.0 L/S FOR EACH OTHER ROOM.

 A PRINCIPAL DWELLING EXHAUST FAN SHALL BE INSTALLED AND CONTROLLED BY A CENTRALLY LOCATED SWITCH IDENTIFIED AS SLICH.
- SUPPLEMENTAL EXHAUST SHALL BE INSTALLED SO THAT THE TOTAL CAPACITY OF ALL KITCHEN, BATHROOM AND OTHER EXHAUSTS, LESS
- THE PRINCIPAL EXHAUST, IS NOT LESS THAN THE TOTAL REQUIRED.
- CAPACITY.
- A HEAT RECOVERY VENTILATOR MAY BE EMPLOYED IN LIEU OF EXHAUST TO PROVIDE
- VENTILATION, AN HRY IS REQUIRED IF ANY SOUD FUEL BURNING APPLIANCES ARE INSTALLED.

 SUPPLY AIR INTAKES SHALL BE LOCATED SO AS TO AVOID CONTAMINATION FROM EXHAUST
 OUT ITS.



NATURAL VENTILATION

- EVERY ROOF SPACE ABOVE AN INSULATED CHUNG SHALL BE VENTILATED WITH UNOBSTRUCTED OPENINGS EQUAL TO NOT LESS THAN 1/300 OF THEINSULATED CHUNG AREA.
- INSULATED ROOF SPACES NOT INCORPORATING AN ATTIC SHALL BE VENTILATED WITH
- UNOBSTRUCTED OPENINGS EQUAL TO NOT LESS THAN 1/150 OF THE INSULATED CEILING AREA.
- ROOF VENTS SHALL BE UNIFORMLY DISTRIBUTED WITH MIN. 25% AT TOP OF THE SPACE AND 25% AT BOTTOM OF THE SPACE DESIGNED TO PREVENT THE ENTRY OF RAIN, SNOW, OR INSECTS.
- UNHEATED CRAWL SPACES SHALL BE PROVIDED WITH 0.1m



FOOTING

33 24"X12" DEEP POURED CONCRETE 2200 PSI . ON UNDISTERBED SOIL MIN. 48" BELOW FINISHED GRADE



BUILT UP POST

3-2"X4" BUILT UP POST WITH DAMPPROOFING MATERIAL WRAPPED AT

END OF POST ANCHORED TO 24"X24"X12" CONC. FOOTING:



RANGE HOOD EXHUST

MECHANICAL EXHAST HOOD WITH MIN 100 CFM AND 6" DIM. RIGID STEEL DUCT OR EQUIVALENT TO OUTDOOR.



SHOWER AND TUB VALVES

- ALL SHOWER VALVES SHALL CONFORM TO OBC DIV. B
 7.6.5.2.
- WATERPROOF FINISH REQUIRED AT SHOWER AND TUB AREAS TO CONFIRM TO OBC DIV B 9.29.2



WALL REINFORCEMENT FOR FUTURE GRAB BARS INSTALLATION IN WASHROOM

SEE WASHROOM DETAIL SHEET



GARAGE WALL-GAS PROOFING

ATTACHED GARAGES MUST BE COMPLETELY SEALED TO PREVENT THE INFILTRATION OF CARBON MONOXIDE & GASOLINE FUMES INTO THE DWELLING.

- PROVIDE 1/2" DRYWALL W/ MIN. 2 COATS OF JOINT COMPOUND AT ALL WALLS ADJACENT TO DWELLING.
- CAULK BETWEEN GYPSUM BOARD AND OTHER SURFACES W/ ACOUSTIC SEALANT.
- CAULK ALL PENETRATIONS SUCH AS HOSE BIBS W/ FLEXIBLE CAULKING.
- DOORS BETWEEN GARAGE & DWELLING SHALL BE TIGHT HITTING & WEATHER STRIPPED & PROVIDED
 W/ A SELF CLOSING DEVICE. DOOR MUST NOT OPEN INTO A ROOM INTENDED FOR SLEEPING.
- GARAGE SLAB SHALL BE SLOPED TO DRAIN OUTDOORS,
- UNIT MASONRY WALLS FORMING THE SEPARATION BETWEEN THE DWELLING, ATTACHED GARAGE SHALL BE PROVIDED W/ 2 COATS OF SEALER OR COVERED W/PLASTER OR GYPSUM BOARD ON THE GARAGE SIDE.



PRECAST STAIRS

PRECAST CONCRETE STEPS OR WOOD STEPS
(PERMITTED TO A MAX, OF 3 RISERS) WHER NOT EXPOSED TO
WHEITHER MAX RISE /-//B" MIN. 1HREAD 9-1/2".
GREATER THAN 3 RISERS WILL REQUIRE LANDING/GUARD /
HANDRAIL AND FOUNDATION UNDER CONC. STEPS.



WOOD FRAME STAIRS

1				
	STAIRS DETAILS		.CURVED STAIRS	
	MAX RISE	= 7-7/8"	MIN AVG. RUN	= 7-7/8"
	MIN RUN	= 8-1/4"	MIN RUN	= 5-7/8"
	MIN TREAD	= 9-1/4"	THE TRUE	.,,
	MAX NOSING	= 1"-0	RAILING	
	MIN HEADROOM	= 6'-5"	FINISHED RAILING C	N PICKETS
	RAIL@LANDING	= 2'-11"	SPACED MAX. 4".	-
	RAIL@STAIRS	= 2'-8"	INFERIOR GUARDS	2'-11" MIN

40 ½

INSULATION VALUES ABOVE GRADE WALLS BASEMENT WALLS INSULATION +

CONTINUOUS R-10 RIGID

R-12 MIN BATT INSULATION

CEILING WITH ATTIC SPACE
CEILING WITHOUT ATTIC SPACE

R-60 E R-31

R-24

DIAMOND CRETE & CONSTRUCTION INC.
DCC DESIGNERS

15845 RIVER DRIVE RD, GEORGETOWN, ON L7G 487 289-962-4003, 647-285-2597, 289-889-2697 info@diamondconst.ca PROPOSED SECOND DWELLING

2 BUNCHGRASS PL, BRAMPTON

NAME: MANJINDER KAUR SIGNATURE: Manginder

MIN STAIRS WIDTH = 2'-10"

THE UNDERSIGNED HAS REVIEWED AND TAKES THE RESPONSIBILITY FOR THE DESIGN AND HAS THE QUALIFICATIONS AND MEETS THE REQUIREMENTS SET OUT IN THE ONTARIO BUILDING CODE TO BE A DESIGNER.

EXTERIOR GUARDS 3'-6" MIN.

BCIN: 125147 QUALIFICATION REQUIREMENT
REQUIRED UNLESS DESIGN IS EXEMPT UNDER 3,2,5,1
OF DIVISION "C" OF O.B.C

DRAWN BY: MK

CLIENT REVIEW:

CONSTRUCTION NOTES

REVISION:

GSUED FOR PERMIT:

A 13

Zoning Non-compliance Checklist

File	No.	

Applicant: Manjinder Kaur Address: 2 Bunchgrass Pl

Zoning: R1C-885

By-law 270-2004, as amended

Category	Proposal	By-law Requirement	Section #
USE			
LOT DIMENSIONS AREA / DEPTH / WIDTH			
BUILDING SETBACKS FRONT / SIDE / REAR			
BUILDING SIZE			
BUILDING HEIGHT			
COVERAGE			
BELOW GRADE ENTRANCE	To permit a proposed exterior stairway leading to a below grade entrance located between the main wall of the dwelling and the flankage lot line	whereas the by-law does not permit a stairway constructed below established grade to be located between the main wall of a dwelling and the flankage lot line.	10.23.1
ACCESSORY STRUCTURE SETBACKS			
ACCESSORY STRUCTURE SIZE / HEIGHT			
MULTIPLE ACCESSORY STRUCTURES			
DRIVEWAY WIDTH			
LANDSCAPED OPEN SPACE			
ENCROACHMENTS			
TWO-UNIT DWELLING			
SCHEDULE "C"		Δ.	
OTHER - DECK			

Connor Cowan	
Reviewed by Zoning	
2023-12-20	
Date	