Flower City



For Office Use Only (to be inserted by the Secretary-Treasurer after application is deemed complete)

FILE NUMBER: /

The Personal Information collected on this form is collected pursuant to section 45 of the Planning Act and will be used in the processing of this application. Applicants are advised that the Committee of Adjustment is a public process and the information contained in the Committee of Adjustment files is considered public information and is available to anyone upon request and will be published on the City's website. Questions about the collection of personal information should be directed to the Secretary-Treasurer, Committee of Adjustment, City of Brampton.

APPLICATION Minor Variance or Special Permission

(Please read Instructions)

It is required that this application be filed with the Secretary-Treasurer of the Committee of Adjustment and be NOTE: accompanied by the applicable fee.

The undersigned hereby applies to the Committee of Adjustment for the City of Brampton under section 45 of the Planning Act, 1990, for relief as described in this application from By-Law 270-2004.

1.	Name of Owner(s) Agyei Peprah-Asiase Address 13 HARPER RD, BRAMPTON
	Addison to the district to the
	Phone # 416-939-1550 Fax # agyeipeprah@hotmail.com
2.	Name of Agent ARYAN SHARMA Address 96 KENNEDY RD SOUTH, UNIT 206
	Phone # 905-452-8200 Fax # Email info@thedesignfine.com
3.	Nature and extent of relief applied for (variances requested): 1) MINOR VARIANCE FOR REDUCED REAR YARD SETBACK FROM 7.5 M TO 3.84M 2) MINOR VARIANCE REDUCE SETBACK ON SECOND FLOOR FROM (1.2+0.6M) TO 1.2M (ALLOWABLE FOR MAIN FLOOR) 3) MINOR VARIANCE FOR INCREASE IN COVERAGE TO 36.40% (MAX ALLOWED (30%)
4.	Why is it not possible to comply with the provisions of the by-law? 1) Current minimum allowable setback is 7.5 m we propose 3.84 m. 2) Second floor side setback is (1.2+0.6 m) we would like to propose 1.2 m for both main floor and second floor. 3) Coverage exceeding by 6.4%.
5.	Legal Description of the subject land: Lot Number 236 Plan Number/Concession Number Municipal Address 13 HARPER RD, BRAMPTON
6.	Dimension of subject land (in metric units) Frontage 15.24 M Depth 35.05 M Area 534.19 M
7.	Access to the subject land is by: Provincial Highway Municipal Road Maintained All Year Private Right-of-Way Seasonal Road Other Public Road Water

Particulars of all buildings and structures on or proposed for the subject

8.

land: (specify in metric units ground floor area, gross floor area, number of storeys, width, length, height, etc., where possible) EXISTING BUILDINGS/STRUCTURES on the subject land: List all structures (dwelling, shed, gazebo, etc.) Bungalow with Garage. (garage to be demolished) PROPOSED BUILDINGS/STRUCTURES on the subject land: Two story addition attach to existing house. Location of all buildings and structures on or proposed for the subject lands: (specify distance from side, rear and front lot lines in metric units) **EXISTING** Front yard setback 7.96 M 13.16 M 2.4 M Rear yard setback Side yard setback Side yard setback 5.7 M **PROPOSED** Front yard setback 7.96 3.84 M 2.4 M Rear yard setback Side yard setback Side yard setback 1.2 M 10. Date of Acquisition of subject land: unknown 11. Existing uses of subject property: RESIDENTIAL (TWO UNIT DWELLING) 12. Proposed uses of subject property: RESIDENTIAL (THREE UNIT DWELLING) 13. Existing uses of abutting properties: RESIDENTIAL Date of construction of all buildings & structures on subject land: 1960 14. 15. Length of time the existing uses of the subject property have been continued: 6 YEARS 16. (a) What water supply is existing/proposed? Municipal \square Other (specify) Well (b) What sewage disposal is/will be provided? Municipal Other (specify) Septic (c) What storm drainage system is existing/proposed? \mathbf{Z} Sewers Other (specify) **Ditches Swales**

17.	Is the subject p	property the subject of a consent?	n application ur	nder the Planning Act, fo	or approval of a plan of
	Yes	No 🗹			
	If answer is yes	s, provide details: Fil	e#	Statu	us
18.	Has a pre-cons	ultation application been	filed?		
	Yes	No 🔽			
19.	Has the subject	property ever been the	subject of an ap	oplication for minor varia	ince?
	Yes	No 🔽	Unknown		
	If answer is yes	s, provide details:			
	File#	Decision		Relief Relief	
	File #	Decision Decision		Relief	
)	
			Sig	nature of Applicant(s) or A	Authorized Agent
DAT	ED AT THE DEC	EMBER 27TH OF			·
					_
		Y OF DECEMBER			THAN THE OWNER OF
THE SUB	JECT LANDS, W	SIGNED BY AN AGENT, RITTEN AUTHORIZATIO	N OF THE OWN	IER MUST ACCOMPANY	THE APPLICATION. IF
		CORPORATION, THE AICORPORATION'S SEAL			AN OFFICER OF THE
	A North	1 (2 2 2 2 2 2 2 2 2 2 2 2 2 2 2 2 2 2 2		- (1t)	Branchin
	1, JANA	SHARMA- DE PERSON	, OF TH	IE OF	Diary
	\ 1				
BELIEVIN		TEMENTS ARE TRUE A IE AND KNOWING THAT			
OATH.					
DECLAR	ED BEFORE ME	Lion of			
Ush	OF _	Drampin -		A	
IN THE	J Keen	OF OF			
eel	THIS	DAY OF			
Jan	<u>uay</u> , 20	Olara Vani	3	ignature of Applicant or A	uthorized Agent
		a Commissioner,	etc.,		
	A Commission	Province of Onta	no, on of the		
		City of Brampton Expires September			
		FOR	OFFICE USE ON	NLY	1
	Present Officia	l Plan Designation:			
	Present Zoning	g By-law Classification:		R1B	
	This application	on has been reviewed with said review are o			results of the
		Salu leview are 0	uumeu on me au	acieu dieunist.	
	Connor Cowa			2024-01-08	
		Zoning Officer		Date	
		DATE RECEIVED	anuar	4 9, 2029	<u>/</u>

Date Application Deemed Complete by the Municipality

Revised 2022/02/17

APPOINTMENT AND AUTHORIZATION OF AGENT

To:

The Secretary-Treasurer Committee of Adjustment

City of Brampton

2 Wellington Street West

Brampton, Ontario

L6Y 4R2

coa@brampton.ca

LOCATION OF THE SUBJECT LAND	13 HARRETERORIBE	ABARAMPTON
------------------------------	------------------	------------

I/We, AgyaeiPepphatriAssiase

please print/type the full name of the owner(s)

the undersigned, being the registered owner(s) of the subject lands, hereby authorize

ARYANSISHIMRIMA

please print/type the full name of the agent(s)

to make application to the City of Brampton Committee of Adjustment in the matter of an application for minor variance with respect to the subject land.

Dated this 27

day of DECHAMBER

2023

(signature of the owner[s], or where the owner is a firm or corporation, the signature of an officer of the owner.)

(where the owner is a firm or corporation, please print or type the full name of the person signing.)

NOTE: If the owner is a firm or corporation, the corporate seal shall be affixed hereto.

NOTE: Unit owners within a Peel Standard Condominium Corporation are to secure authorization from the Directors of the Condominium Corporation in a form satisfactory to the City of Brampton, prior to submission of an application. Signatures from all Members of the Board of Directors are required.

PERMISSION TO ENTER

To: The Secretary-Treasurer
Committee of Adjustment
City of Brampton
2 Wellington Street West
Brampton, Ontario
L6Y 4R2

coa@brampton.ca

LOCATION OF THE SUBJECT LAND: 13 HARRPEERDRER/BARAIMPTON

I/We, AgyaeiPeppahahaiAssiase

please print/type the full name of the owner(s)

the undersigned, being the registered owner(s) of the subject land, hereby authorize the Members of the City of Brampton Committee of Adjustment and City of Brampton staff members, to enter upon the above noted property for the purpose of conducting a site inspection with respect to the attached application for Minor Variance and/or consent.


Dated this 27 day of DECEMBER , 2023.

(signature of the owner[s], or where the owner is a firm or corporation, the signature of an officer of the owner.)


(where the owner is a firm or corporation, please print or type the full name of the person signing.)

NOTE: If the owner is a firm or corporation, the corporate seal shall be affixed hereto.

NO DISCUSSION SHALL TAKE PLACE BETWEEN THE COMMITTEE MEMBERS AND THE APPLICANT DURING THE SITE INSPECTION

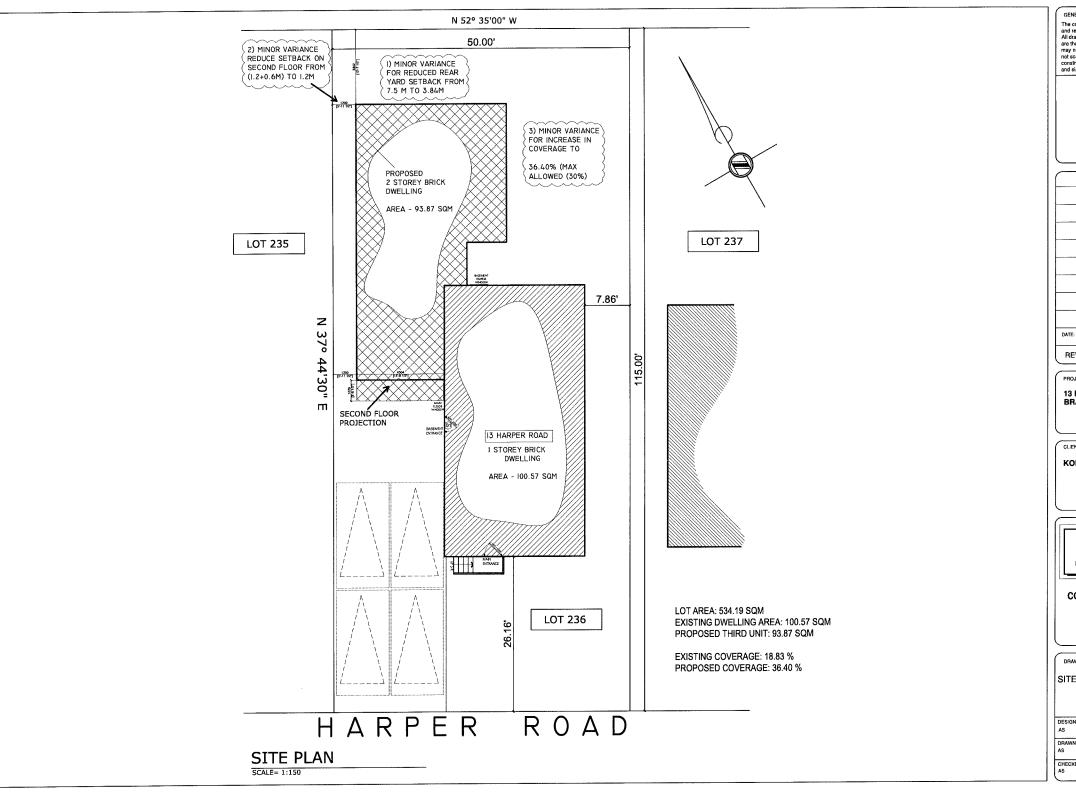

The contractor shall check and verify all dimensions and report all errors and omissions to the consultant. All drawings, specifications and related documents are the copyright property of DESIGN FINE LTD. and may not be reproduced without their permission. Do not scale drawings. This drawing shall not be used for construction purposes unless issued for construction and signed by DESIGN FINE LTD.

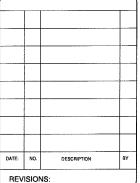

13 HARPER ROAD, BRAMPTON,ON

CLIENT:

KOFI




CONSULTING ENGINEERS

96 KENNEDY ROAD SOUTH BRAMPTON, ON L6W 3E7 Ph: 905-452-8200 Fax: 905-452-8285 www.thedeslgnfine.com

DRAWING TITLE:

SITE PLAN

DESIGN: AS	SCALE: AS NOTED	DRAWING NO:
DRAWN: AS	DATE: JULY, 2023	Q1
CHECKED: AS	PROJECT NO DFL-2023-035	

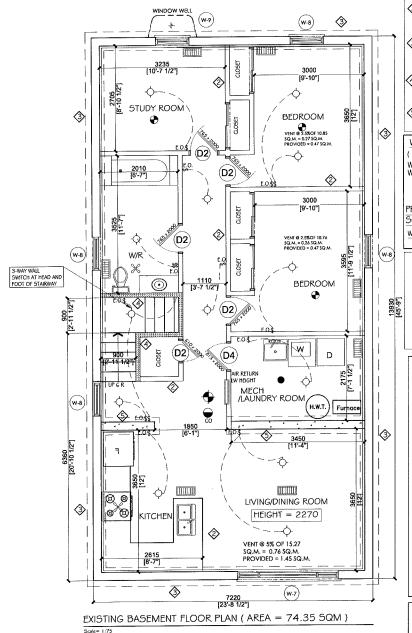

WALL SCHEDULE

PROPOSED INTERIOR 38 X 140 @406 O/C 12.7 MM GYPSUM WALL BOARDS ON BOTH THE SIDES TO REMAIN AS IS

PROPOSED 38 X 140 WOOD FRAMING @ 406 O.C. RSI 2.11 INSULATION W/VAPOR --- BARRIER UP TO THE FULL BASEMENT

(38 X 140)MM FRAMING @ 406 MM OR 16" (30

- EXISTING CONCRETE BLOCK WALL TO BE REMAIN AS IS

WINDOW SCHEDULE (EXISTING TO REMAIN) W8 850 x 560 WINDOW

DOOR SCHEDULE (EXISTING TO REMAIN) W7 2600 X 560 WINDOW D-1 800 X 2000 DOOR D-2 765 X 2000 DOOR D-3 610 X 2000 DOOR

D-4 813 X 2000 DOOR

PROPOSED WINDOW SCHEDULE

W-9 865 X 1420 WINDOW

LEGEND:

- WIRED INTERCONNECTED SMOKE ALARM WITH VISUAL SIGNALING COMPONENT (STROBE)

PROVIDE DUCT TYPE SMOKE DETECTOR WHICH UPON ACTIVATION WILL TURN OFF FUEL SUPPLY AND ELECTRICAL TO THE HEATING SYSTEM

ELECT, LIGHT SWITCH CONTD. TO O/S DAMPERED VENT

- HEATING OUTLET

- ELECTRIC OUTLET

- CARBON MONO-OXIDE DETECTOR

- SPRINKLER

GENERAL NOTES:

ALL WORK SHALL CONFORM TO THE ONTARIO BUILDING CODE O. REG. 332 /12 AS AMENDED DIV. B. PART 7.

ELECTRICAL NOTES:

- 1. ALL THE ELECTRICAL INSTALLATIONS MUST BE INSPECTED BY THE ELECTRICAL SAFETY AUTHORITY.
- 2. ALL SMOKE ALARMS ARE LOCATED WITH CONFORMATION OF OBC. DIV.B 9.10.19.3.

PLUMBING NOTES:

- ALL THE PLUMBING SHALL CONFORM TO THE ONTARIO BUILDING CODE O. REG. 332 /12 AS AMENDED DIV. B. PART 7.
- 2. PRESSURE BALANCE OR THERMOSTATIC MIXING VALVE REQUIRED ON SHOWER AS PER OBC DIV.B 7.6.5.2.(1)
- THE MAXIMUM HOT WATER TEMPERATURE SUPPLIED TO THE FIXTURES IN RESIDENTIAL OCCUPANCIES SHALL NOT EXCEED 49° C (120° F) AS PER OBC ARTICLE 7.6.5.1 DISHWASHER AND CLOTHES WASHERS ARE EXEMPT FROM THIS REQUIREMENT.
- 4. ALL THERMOSTATIC VALVES SHALL CONFORM TO CAN/CSA-B125 "PLUMBING FIXTURES" AND BE LABELED ACCORDINGLY.
- 5. THE FIRE SPRINKLER SYSTEM SHALL BE A FLOW THROUGH SYSTEM WITH A MINIMUM 3" COPPER PIPE CONNECTED TO AT LEAST A 3" COPPER WATER PIPE OR DIRECTLY AFTER THE WATER METER.


NOTE: THE INSTULLATION OF CARBON MONOXIDE DETECTOR S SHALL COMPLY WITH OBC DIV B.9.33.4 REQUIREMENTS.

- : INSTALLATION OF HVAC EQUIPMENTS SHALL CONFORM TO MANUFACTURE'S SPECIFICATIONS AND MANUALS
- : MECHANICAL VENTILATION SHALL BE PROVIDED IN CONFORMANCE WITH OBC DIV B.9.32.3 REQUIREMENTS.

- MIN CEILING HEIGHT REQUIRED FOR BASEMENT IS 1950 MM
- PROVIDED EXHAUST FAN/ RANG HOOD
- MIN 30 MIN F.R.R FOR STRUCTURAL ITEMS
- LOCATION OF SMOKE ALARMS PER OBC DIV.B.9.10.19.3
- THE FIRE SPRINKLER SYSTEM SHALL BE A FLOW THROUGH SYSTEM WITH A MIN 3 COPPER PIPE CONNECTED TO AT LEAST A $\frac{3}{4}$ 1 COPPER WATER PIPE OR DIRECTLY AFTER THE WATER METER OR PEV LINE $(\frac{3}{4})$ 1
- BASEMENT CEILING AND MAIN FLOOR ASSEMBLY TO PROVIDE FIRE SEPARATION OF 15MIN. MINIMUM WITH & GYPSUM WALL BOARD

GENERAL NOTE:

The contractor shall check and verify all dimensions and report all errors and omissions to the consultant.
All drawings, specifications and related documents
are the copyright property of DESIGN FINE LTD, and roduced without their permission. Do not scale drawings. This drawing shall not be used for construction purposes unless issued for construction and signed by DESIGN FINE LTD.

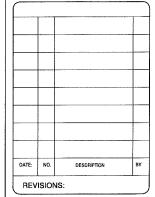

PROJECT

13 HARPER ROAD. BRAMPTON.ON

CLIENT:

KOFI




CONSULTING ENGINEERS

96 KENNEDY ROAD SOUTH BRAMPTON, ON L6W 3E7 Ph: 905-452-8200 Fax: 905-452-8285 www.thedesignfine.com

ORAWING TITLE:

EXISTING BASEMENT PLAN

DESIGN: AS	SCALE: AS NOTED	DRAWING NO:
DRAWN: AS	DATE: JULY, 2023	Λ1
CHECKED:	PROJECT NO	^ '

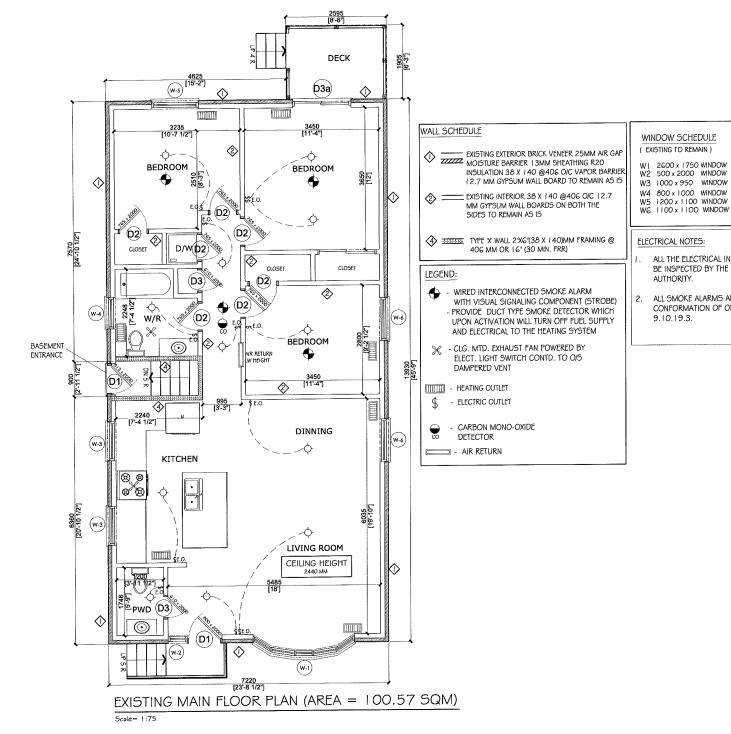

WINDOW SCHEDULE

DOOR SCHEDULE (EXISTING TO REMAIN)


W1 2600 x 1750 WNDOW W2 500 x 2000 WINDOW W3 1000 x 950 WINDOW W4 800 x 1000 WINDOW W5 1200 x 1100 WINDOW

D-1 813 X 2000 DOOR D-2 765 X 2000 DOOR D-3 610 X 2000 DOOR D-3a 1500 X 2000 SLIDING DOOR

ELECTRICAL NOTES:

- ALL THE ELECTRICAL INSTALLATIONS MUST BE INSPECTED BY THE ELECTRICAL SAFETY AUTHORITY.
- ALL SMOKE ALARMS ARE LOCATED WITH CONFORMATION OF OBC. DIV.B 9.10.19.3.

The contractor shall check and verify all dimensions and report all errors and omissions to the consultant.
All drawings, specifications and related documents are the copyright property of DESIGN FINE LTD. and may not be reproduced without their permission. Do not scale drawings. This drawing shall not be used for construction purposes unless issued for construction and signed by DESIGN FINE LTD.

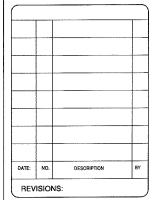

PROJECT:

13 HARPER ROAD. BRAMPTON,ON

CLIENT:

KOFI




CONSULTING ENGINEERS

96 KENNEDY ROAD SOUTH BRAMPTON, ON L6W 3E7 Ph: 905-452-8200 Fax: 905-452-8285 www.thedesignfine.com

DRAWING TITLE:

EXISTING MAIN FLOOR PLAN

DESIGN: AS	SCALE: AS NOTED	DRAWING NO:
DRAWN: AS	DATE: JULY, 2023	۸۵
CHECKED:	PROJECT NO	42

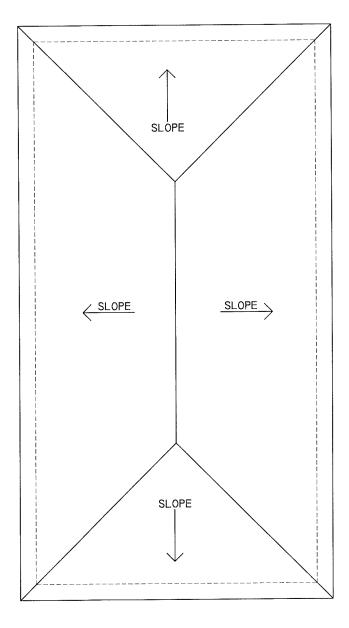


EXISTING ROOF PLAN

Scale= 1:75

GENERAL NOTE:

GENERAL NOTE:

The contrator shall check and verify all dimensions and report all errors and omissions to the consultant. All drawings, specifications and related documents are the copyright property of DESIGN FINE LTD. and may not be reproduced without their permission. Do not soale drawings. This drawing shall not be used for construction purposes unless issued for construction and signed by DESIGN FINE LTD.

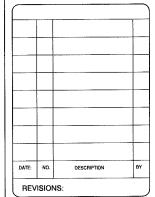

PROJECT:

13 HARPER ROAD, BRAMPTON,ON

CLIENT:

KOF




CONSULTING ENGINEERS

96 KENNEDY ROAD SOUTH BRAMPTON, ON L6W 9E7 Ph: 905-452-8200 Fax: 905-452-8285 www.thedesignfine.com


DRAWING TITLE:

EXISTING ROOF PLAN

DESIGN: AS	SCALE: AS NOTED	DRAWING NO:
DRAWN: AS	DATE: JULY, 2023	٧a
CHECKED:	PROJECT NO	73

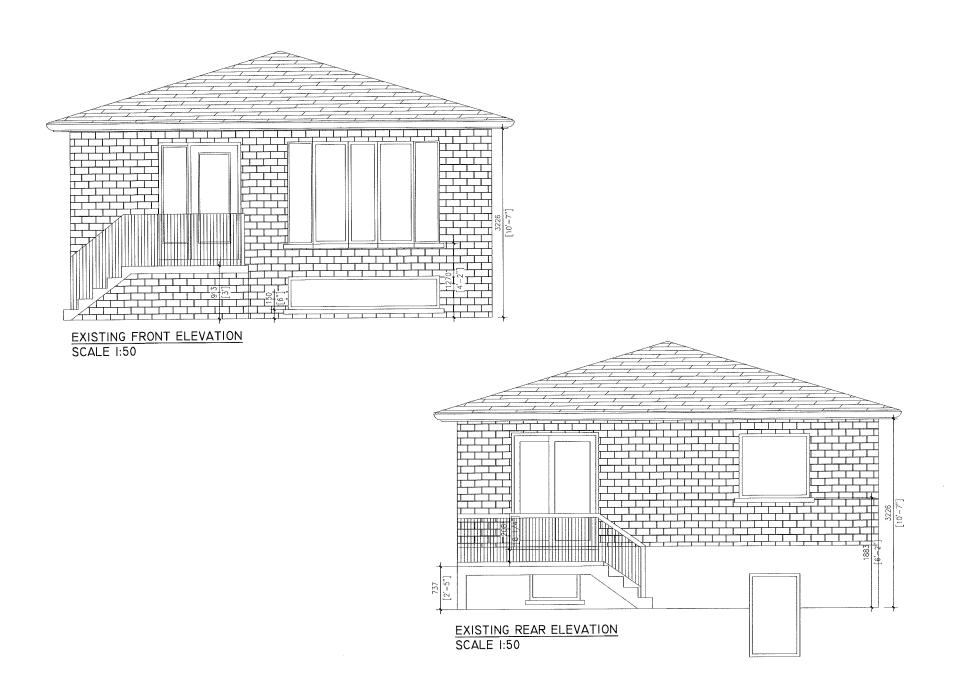

The contractor shall check and verify all dimensions and report all errors and omissions to the consultant. All drawings, specifications and related documents are the copyright property of DESIGN FINE LTD. and may not be reproduced without their permission. Do not scale drawings. This drawing shall not be used for construction purposes unless issued for construction and signed by DESIGN FINE LTD.

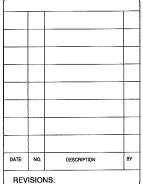

112110101

PROJECT:

13 HARPER ROAD, BRAMPTON,ON

CLIENT:

KOFI




CONSULTING ENGINEERS

96 KENNEDY ROAD SOUTH BRAMPTON, ON LBW 3E7 Ph: 905-452-8200 Fax: 905-452-8285 www.thedesignfine.com

DRAWING TITLE:


EXISTING FRONT, REAR ELEVATIONS

DESIGN: AS	SCALE: AS NOTED	DRAWING NO:
DRAWN: AS	DATE: JULY, 2023	1 1 1
CHECKED: AS	PROJECT NO DFL-2023-035	//4

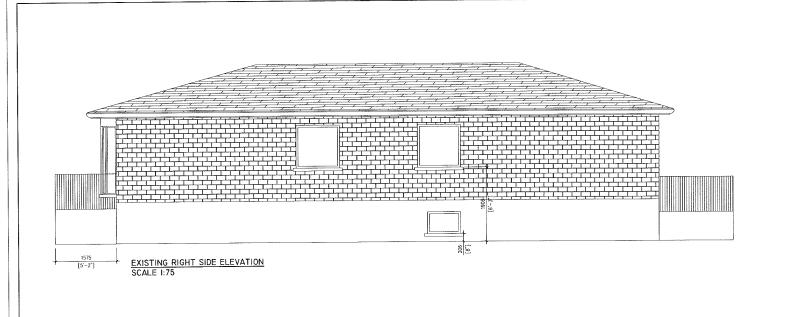



The contractor shall check and verify all dimensions and report all errors and omissions to the consultant. All drawings, specifications and related documents are the copyright property of DESIGN FINE LTD. and may not be reproduced without their permission. Do not scale drawings. This drawing shall not be used for construction purposes unless issued for construction and signed by DESIGN FINE LTD.

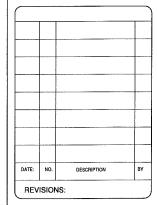

PROJECT:

13 HARPER ROAD, BRAMPTON,ON

CLIENT:

KOFI




CONSULTING ENGINEERS

96 KENNEDY ROAD SOUTH BRAMPTON, ON L6W 3E7 Ph: 905-452-8200 Fax: 905-452-8285 www.thedesignfine.com

DRAWING TITLE:

EXISTING SIDE ELEVATIONS

DESIGN: AS	SCALE: AS NOTED	DRAWING NO:
DRAWN: AS	DATE: JULY, 2023	Δ5
CHECKED:	PROJECT NO	AJ

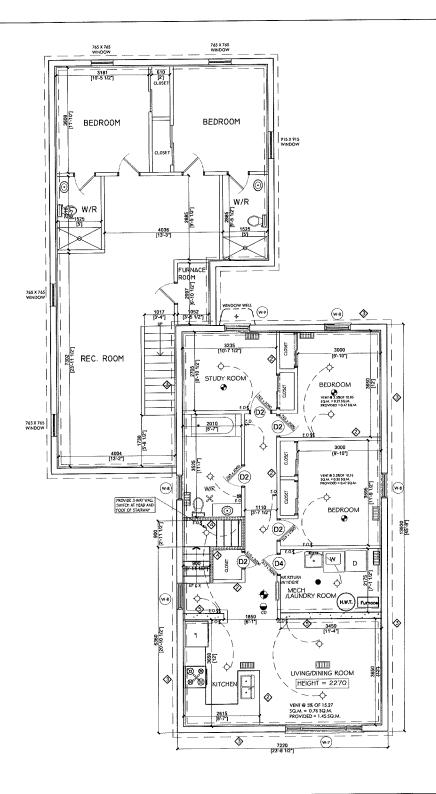

WALL SCHEDULE

PROPOSED INTERIOR 38 X 140 @406 O/C 12.7 MM GYP5UM WALL BOARDS ON BOTH THE SIDES TO REMAIN AS IS

PROPOSED 38 X 140 WOOD FRAMING @ 406 O.C. RSI 2.11 INSULATION WAPOR BARRIER UP TO THE FULL BASEMENT

FRAMING @ 406 MM OR 16" (30

MIN. FRR) S - EXISTING CONCRETE BLOCK WALL
TO BE REMAIN AS IS

→ EXECUTE TYPE % WALL 2 %G* (38 X 140)MM

WINDOW SCHEDULE DOOR SCHEDULE (EXISTING TO REMAIN) W7 2600 X 560 WINDOW D-1 800 X 2000 DOOR W8 850 X 560 WINDOW D-2 765 X 2000 DOOR

D-3 610 X 2000 DOOR D-4 813 X 2000 DOOR

(EXISTING TO REMAIN)

PROPOSED WINDOW SCHEDULE W-9 865 X 1420 WNDOW

WRED INTERCONNECTED SMOKE ALARM WITH VISUAL SIGNALING COMPONENT

PROVIDE DUCT TYPE SMOKE DETECTOR WHICH UPON ACTIVATION WILL TURN OFF FUEL SUPPLY AND ELECTRICAL TO THE HEATING SYSTEM

CLG. MTD. EXHAUST FAN POWERED BY ELECT. LIGHT SWITCH CONTD. TO 0/5

- HEATING OUTLET

- CARBON MONO-OXIDE DETECTOR

SPRINKLER

GENERAL NOTES:

ALL WORK SHALL CONFORM TO THE ONTARIO BUILDING CODE O. REG. 332 /12 AS AMENDED DIV. B. PART 7.

- ALL THE ELECTRICAL INSTALLATIONS MUST BE INSPECTED BY THE ELECTRICAL SAFETY
- 2. ALL SMOKE ALARMS ARE LOCATED WITH CONFORMATION OF OBC. DIV.B 9.10.19.3.

PLUMBING NOTES:

- ALL THE PLUMBING SHALL CONFORM TO THE ONTARIO BUILDING CODE O. REG. 332 13.2 AS AMENDED DIV. B. PART 7.
- 2. PRESSURE BALANCE OR THERMOSTATIC MIXING VALVE REQUIRED ON SHOWER AS PER OBC DIV.B 7.6.5.2.(1)
- THE MAXIMUM HOT WATER TEMPERATURE SUPPLIED TO THE FIXTURES IN RESIDENTIAL OCCUPANCIES SHALL NOT EXCEED 49° C (120° F) AS PER OBC ARTICLE 7.6.5.1 DISHWASHER AND CLOTHES WASHERS ARE
- ALL THERMOSTATIC VALVES SHALL CONFORM TO CAN/CSA-B125 'PIUMBING FIXTURES" AND BE LABELED ACCORDINGLY.
- THE FIRE SPRINKLER SYSTEM SHALL BE A FLOW THROUGH SYSTEM WITH A MINIMUM Proper PIPE CONNECTED TO AT LEAST A 3 COPPER WATER PIPE OR DIRECTLY AFTER THE WATER METER.

NOTE: THE INSTULLATION OF CARBON MONOXIDE DETECTOR 5 SHALL COMPLY WITH OBC DIV B.9.33.4 REQUIREMENTS.

- : INSTALLATION OF HVAC EQUIPMENTS SHALL CONFORM TO MANUFACTURE'S SPECIFICATIONS AND MANUALS
- MECHANICAL VENTILATION SHALL BE PROVIDED IN CONFORMANCE WITH OBC DIV 8.9.32.3 REQUIREMENTS.


- MIN CEILING HEIGHT REQUIRED FOR BASEMENT IS 1950 MM PROVIDED EXHAUST FAW RANG HOOD MIN 30 MIN F.R.R FOR STRUCTURAL ITEMS
- LOCATION OF SMOKE ALARMS PER OBC DIV.B.9.10.19.3
- THE FIRE SPRINKLER SYSTEM SHALL BE A FLOW THROUGH SYSTEM WITH A MIN 🕻 COPPER PIPE CONNECTED TO AT LEAST A \$\frac{1}{2}\text{ COPPER WATER PIPE OR DIRECTLY AFTER THE WATER METER OR PEV LINE (\frac{1}{2}\text{)} BASEMENT CEILING AND MAIN FLOOR ASSEMBLY TO PROVIDE FIRE SEPARATION OF 15MIN. MINIMUM
- WITH & GYPSUM WALL BOARD

PROPOSED BASEMENT FLOOR PLAN

Scale = 1:100

GENERAL NOTE:

The contractor shall check and verify all dimensions and report all errors and omissions to the consultant and report all errors and omissions to the consultant. All drawings, specifications and related documents are the copyright property of DESIGN FINE LTD. and may not be reproduced without their permission. Do not scale drawings. This drawing shall not be used for construction purposes unless issued for construction and signed by DESIGN FINE LTD.

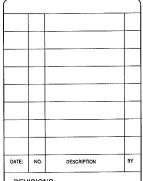

REVISIONS:

PROJECT:

13 HARPER ROAD, BRAMPTON,ON

CLIENT:

KOFI




CONSULTING ENGINEERS

www.thedesignfine.com


DRAWING TITLE:

PROPOSED BASEMENT PLAN

DESIGN: AS	SCALE: AS NOTED	DRAWING NO:
DRAWN: AS	DATE: JULY, 2023	۸۵
CHECKED: AS	PROJECT NO DFL-2023-035	70

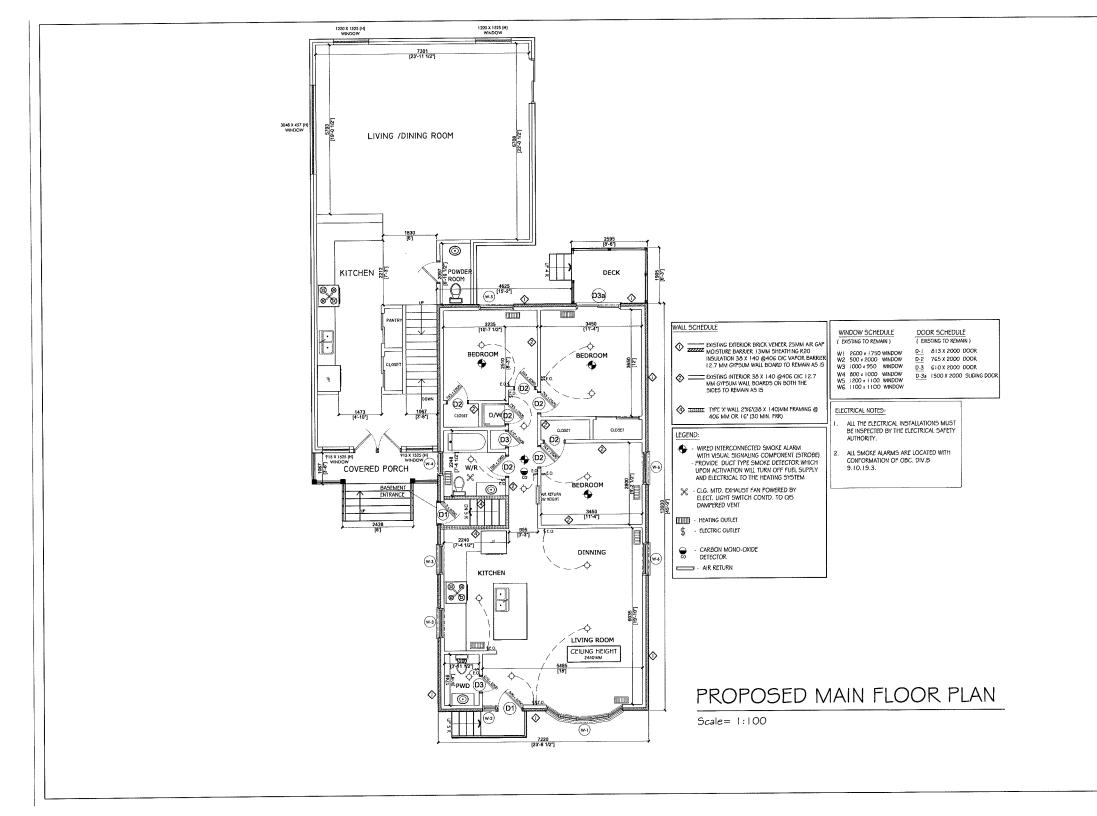

The contractor shall check and verify all dimensions and report all errors and missions to the consultant. All drawings, specifications and related documents are the copyright proparty of DESIGN FINE LTD. and may not be reproduced without their permission. Do not scale drawings. This drawing shall not be used for construction purposes unless issued for construction and signed by DESIGN FINE LTD.

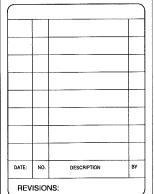

PROJECT:

13 HARPER ROAD, BRAMPTON,ON

CLIENT:

KOFI




CONSULTING ENGINEERS

96 KENNEDY ROAD SOUTH BRAMPTON, ON L6W 3E7 Ph: 905-452-8200 Fax: 905-452-8285 www.thedesignfine.com

DRAWING TITLE:

PROPOSED MAIN FLOOR

DESIGN: AS	SCALE: AS NOTED	DRAWING NO:
DRAWN: AS	DATE: JULY, 2023	۸7
CHECKED: AS	PROJECT NO DFL-2023-035	Α/

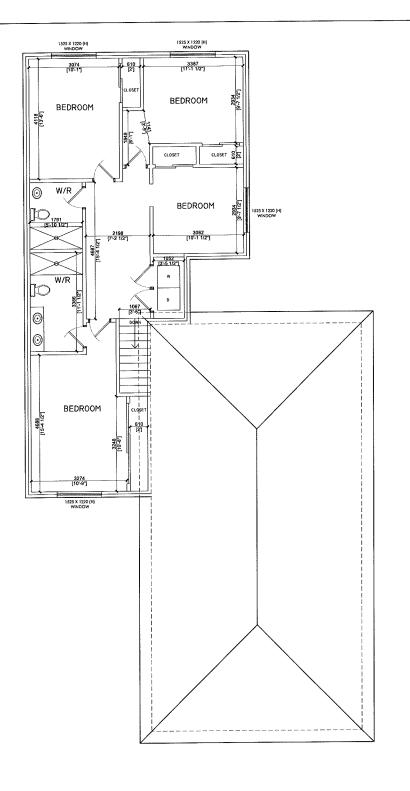


PROPOSED SECOND FLOOR PLAN

Scale= 1:100

GENERAL NOTE:

The contractor shall check and verify all dimensions and report all errors and omissions to the consultant. All drawings, specifications and related documents are the copyright property of DESIGN FINE LTD. and may not be reproduced without their permission. Do not scale drawings. This drawing shall not be used for construction purposes unless issued for construction and signed by DESIGN FINE LTD.

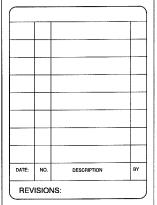

PROJECT:

13 HARPER ROAD, BRAMPTON,ON

KOFI



CONSULTING ENGINEERS

96 KENNEDY ROAD SOUTH BRAMPTON, ON L6W 3E7 Ph: 905-452-8200 Fax: 905-452-8285 www.thedesignfine.com

DRAWING TITLE:

PROPOSED SECOND FLOOR PLAN

DESIGN: AS	SCALE: AS NOTED	DRAWING NO:
DRAWN: AS	DATE: JULY, 2023	ΛΩ
CHECKED:	PROJECT NO	HO



EXISTING FRONT ELEVATION SCALE 1:75




EXISTING REAR ELEVATION SCALE 1:75

GENERAL NOTE:

GENERAL NOTE:

The contractor shall check and verify all dimensions and report all errors and omissions to the consultant. All drawings, specifications and related documents are the copyright property of DESIGN FINE LTD. and may not be reproduced without their permission. Do not scale drawings. This drawing shall not be used for construction purposes unless issued for construction and signed by DESIGN FINE LTD.

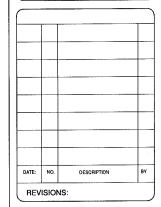

PROJECT:

13 HARPER ROAD, BRAMPTON,ON

CLIENT:

KOFI




CONSULTING ENGINEERS

96 KENNEDY ROAD SOUTH BRAMPTON, ON L6W 3E7 Ph: 905-452-8200 Fax: 905-452-8285 www.thedesignfine.com


DRAWING TITLE:

PROPOSED FRONT AND REAR ELEVATIONS

-	DESIGN: AS	SCALE: AS NOTED	DRAWING N
- 1	DRAWN: AS	DATE: JULY, 2023	٨٥
	CHECKED:	PROJECT NO	AS

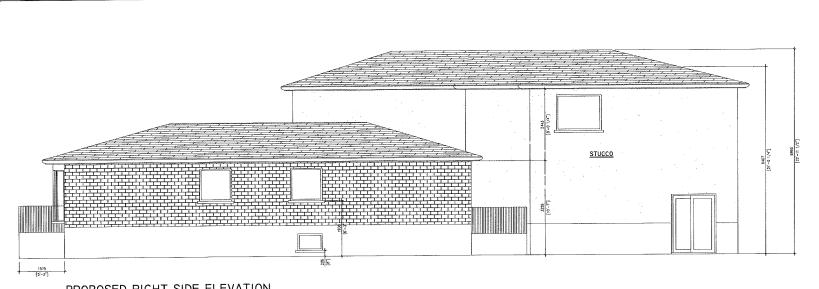

PROPOSED RIGHT SIDE ELEVATION SCALE 1:100

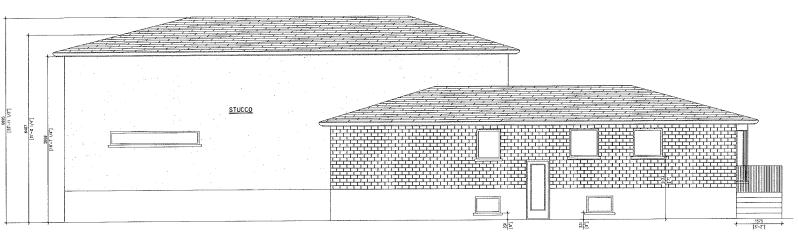


PROPOSED LEFT SIDE ELEVATION SCALE 1:100

GENERAL NOTE:

CREMENT. NOTE:

The contractor shall check and verify all dimensions and report all errors and omissions to the consultant. All drawings, specifications and related documents are the copyright property of DESIGN FINE LTD. and may not be reproduced without their permission. Do not scale drawings. This drawing shall not be used for construction purposes unless issued for construction and signed by DESIGN FINE LTD.

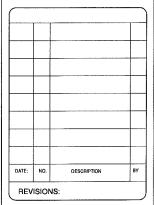

PROJECT:

13 HARPER ROAD, BRAMPTON,ON

CLIENT:

KOFI




CONSULTING ENGINEERS

96 KENNEDY ROAD SOUTH BRAMPTON, ON LSW 3E7 Ph: 905-452-8200 Fax: 905-452-8285 www.thedesignfine.com

DRAWING TITLE:

PROPOSED SIDE ELEVATIONS

DESIGN: AS	SCALE: AS NOTED	DRAWING NO:
DRAWN: AS	DATE: JULY, 2023	Λ1.
CHECKED: AS	PROJECT NO DFL-2023-035	A1

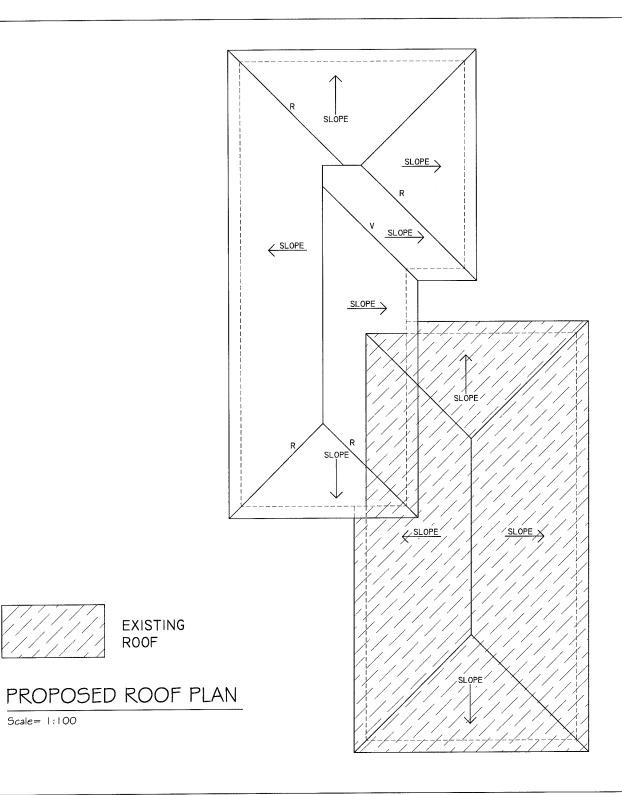

EXISTING


ROOF

Scale= 1:100

GENERAL NOTE:

GENERAL NOTE:

The contractor shall check and verify all dimensions and report all errors and omissions to the consultant. All drawings, specifications and related documents are the copyright property of DESIGN FINE LTD. and may not be reproduced without their permission. Do not scale drawings. This drawing shall not be used for construction purposes unless issued for construction and signed by DESIGN FINE LTD.

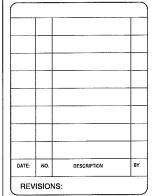

PROJECT:

13 HARPER ROAD, BRAMPTON,ON

CLIENT:

KOFI




CONSULTING ENGINEERS

96 KENNEDY ROAD SOUTH BRAMPTON, ON L6W 3E7 Ph: 905-452-8200 Fax: 905-452-8285 www.thedesignfine.com

DRAWING TITLE:

PROPOSED ROOF PLAN

DESIGN: A5	SCALE: AS NOTED	DRAWING NO:
DRAWN: AS	DATE: JULY, 2023	Λ1-
CHECKED: AS	PROJECT NO DFL-2023-035	A

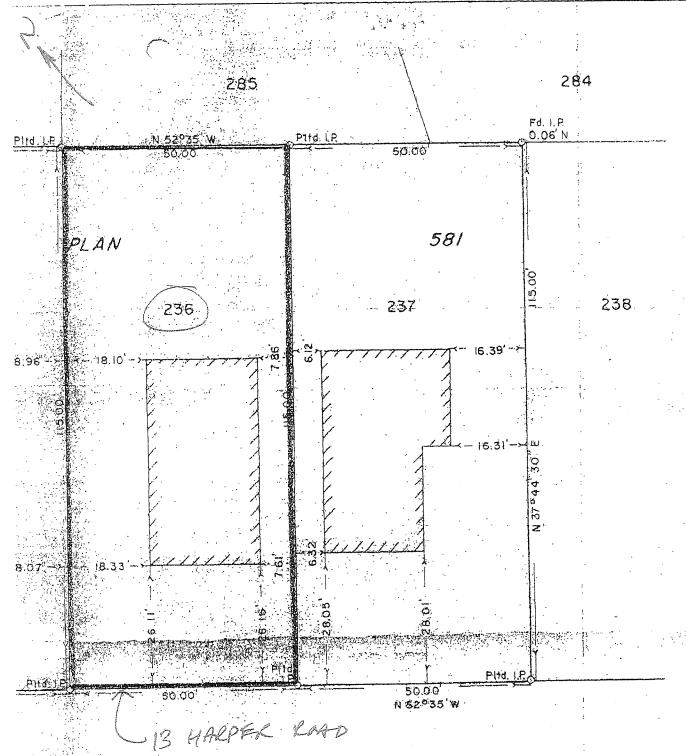

MAKROAD

5. E

N OF SURVEY

3 & 237 REGISTERED PLAN 581

JUNTY OF PEEL

it this plan is correct

GNIZ

OLD & BROUSE

HEERS, ONTARIO LAND SURVEYORS

A SCARLETT ROAD

WESTON, ONT

CH. 4-5464

DATE OCT 19, 1959 PROJECT . 59-381-1

Zoning Non-compliance Checklist

File No.	-60010-
13 00	0000

Applicant: Aryan Sharma Address: 13 Harper Rd

Zoning: R1B

By-law 270-2004, as amended

Category	Proposal	By-law Requirement	Section #
USE			
BUILDING SETBACKS - REAR	To permit a rear yard setback of 3.84m to a proposed addition	whereas the by-law requires a minimum rear yard setback of 8.76m.	10.27(a)
BUILDING SETBACKS - SIDE	To permit a building addition with an exterior side yard setback of 1.2m on the second storey	whereas the by-law requires a minimum exterior side yard setback of 1.8m on the second storey	10.27(b)(i)
BUILDING SIZE	To permit a lot coverage of 36.4%,	whereas the by-law permits a maximum lot coverage of 30%.	10.27(c)
BUILDING HEIGHT			
COVERAGE			
BELOW GRADE ENTRANCE			
ACCESSORY STRUCTURE SETBACKS			
ACCESSORY STRUCTURE SIZE / HEIGHT			
MULTIPLE ACCESSORY STRUCTURES			
DRIVEWAY WIDTH			
LANDSCAPED OPEN SPACE			
ENCROACHMENTS			
TWO-UNIT DWELLING			
SCHEDULE "C"			
OTHER - DECK			

Connor Cowan	
Reviewed by Zoning	
2024-01-08	
Date	