Flower City



For Office Use Only (to be inserted by the Secretary-Treasurer after application is deemed complete)

FILE NUMBER:

A-2024-0041

The Personal Information collected on this form is collected pursuant to section 45 of the Planning Act and will be used in the processing of this application. Applicants are advised that the Committee of Adjustment files is considered public information and is available to anyone upon request and will be published on the City's website. Questions about the collection of personal information should be directed to the Secretary-Treasurer, Committee of Adjustment, City of Brampton.

APPLICATION Minor Variance or Special Permission

(Please read Instructions)

NOTE: It is required that this application be filed with the Secretary-Treasurer of the Committee of Adjustment and be accompanied by the applicable fee.

The undersigned hereby applies to the Committee of Adjustment for the City of Brampton under section 45 of the Planning Act, 1990, for relief as described in this application from By-Law **270-2004**.

ule <u>rialli</u>			ilication from by-Law 270-2004.	
	Owner(s) Kevin Michael &			
Address	4 Alderway Avenue, Brampt	ton, ON, L6Y 2B	6	
Phone #	4166595329 kevin.michael.905@gmail.c	om	Fax #	
Name of Address	Agent Sarah Mahdi 135 Weir Chase, Misissauga	L5V 2W9, ON		
Phone # Email	647-281-9294 sarah@snsdesignandbu	ild.com	Fax #	
Nature a	nd extent of relief applied for	(variances req	uested):	
Why is i	t not possible to comply with	the provisions	of the by-law?	
	escription of the subject land			
	mber/Concession Number al Address <u>4 Alderway Av</u>	646 re. Brampton,	ON L6Y 2B6	
	ion of subject land (in metric e 18.29 30.48 557.418	units)		
	to the subject land is by:			

8.	Particulars of all buildings and structures on or proposed for the subject land: (specify <u>in metric units</u> ground floor area, gross floor area, number of storeys, width, length, height, etc., where possible)					
	EXISTING BUILDINGS/STRUCTURES on the subject land: List all structures (dwelling, shed, gazebo, etc.)					
		195.281-storey dwellingPorch: 10.81				
	PROPOSED BUILDINGS/STRUCTURES or 2-units in basement floor: total area 1					
9.	Location of all buildings and str	ructures on or proposed for the subject lands:				
	•	r and front lot lines in <u>metric units</u>)				
	EXISTING Front yard setback 5.78 Rear yard setback 3.97 Side yard setback 1.73 Side yard setback 5.49					
	PROPOSED Front yard setback 5.78 Rear yard setback 3.97 Side yard setback 1.73 Side yard setback 5.49					
10.	Date of Acquisition of subject land:	January 31, 2024				
11.	Existing uses of subject property:	Single family dwelling				
12.	Proposed uses of subject property:	3-unit dwelling				
13.	Existing uses of abutting properties:	Single family dwelling				
14.	Date of construction of all buildings & str	ructures on subject land: 1963				
15.	Length of time the existing uses of the su	bject property have been continued: 60 years				
16. (a)	What water supply is existing/proposed? Municipal Well	Other (specify)				
(b)	What sewage disposal is/will be provided Municipal Septic	Other (specify)				
(c)	What storm drainage system is existing/p Sewers Ditches Swales	Other (specify)				

17.	Is the subject prop subdivision or cor		of an application u	nder the Planning A	ct, for approval of a plan of
	Yes	No 🔽			
	If answer is yes, p	rovide details:	File #		Status
18.	Has a pre-consulta	ation application	been filed?		
	Yes	No 🔽			
19.	Has the subject pr	operty ever been	the subject of an a	oplication for minor	variance?
	Yes	No 🔽	Unknown		
	If answer is yes, p				
	File #	Decision Decision		Relief Relief	
	File #	Decision		Relief	
				. 6	
			Sig	gnature of Applicant(s) or Authorized Agent
DAT	ED AT THE	13th	of February	vary , 2024	
	3 <u>19</u> DAY 0				
IF THIS A	APPLICATION IS SIG	SNED BY AN AG	ENT, SOLICITOR O		HER THAN THE OWNER OF
					ANY THE APPLICATION. IF BY AN OFFICER OF THE
			SEAL SHALL BE AF		
1	1, Sarah	Mahdi	, OF Th	HE city	OF <u>mississuv</u> ga
IN THE	E <u>region</u> OF	peel	SOLEMNLY	DECLARE THAT:	U
ALL OF 1	THE ABOVE STATE	MENTS ARE TRU	JE AND I MAKE TH	IS SOLEMN DECLAR	RATION CONSCIENTIOUSLY EFFECT AS IF MADE UNDER
DECLARION THE Peel	OF BY THIS	OF DAY OF			Q do to
0	May, 20 3 A Commissioner e	Provin	Vani missioner, etc., ice of Ontario, corporation of the f Brampton	Signature of Applicant	or Authorized Agent
		Expire	FOR OFFICE USE O	NLY	
	Present Official P	lan Designation:			
	Present Zoning B	y-law Classificat	ion:	R1B	
	This application h		I with respect to the vare outlined on the at		I the results of the
	Comer	Com		2024-02-07	
	Zo	ning Officer			Date
		TE RECEIVED	Tehnia	113.20	DU

Date Application Deemed Complete by the Municipality

Revised 2022/02/17

APPOINTMENT AND AUTHORIZATION OF AGENT

To: The Secretary-Treasurer
Committee of Adjustment
City of Brampton
2 Wellington Street West
Brampton, Ontario
L6Y 4R2
coa@brampton.ca

LOCATION	OF THE SUBJECT LAND: 4 Alderway Ave.
I/We,	Kevin Michael & Christine Michael
	please print/type the full name of the owner(s)
the unders	gned, being the registered owner(s) of the subject lands, hereby authorize
Sarah Mah	di
	please print/type the full name of the agent(s)
	pplication to the City of Brampton Committee of Adjustment in the matter of an for minor variance with respect to the subject land.
Dated this	day of February , 20 24 .
ga	had -
(signatu	re of the owner[s], or where the owner is a firm or corporation, the signature of an officer of the owner.)
(1	where the owner is a firm or corporation, please print or type the full name of the person signing.)

NOTE: Unit owners within a Peel Standard Condominium Corporation are to secure authorization from the Directors of the Condominium Corporation in a form satisfactory to the City of Brampton, prior to submission

NOTE: If the owner is a firm or corporation, the corporate seal shall be affixed hereto.

of an application. Signatures from all Members of the Board of Directors are required.

PERMISSION TO ENTER


To: The Secretary-Treasurer
Committee of Adjustment
City of Brampton
2 Wellington Street West
Brampton, Ontario
L6Y 4R2
coa@brampton.ca

LOCATION OF THE SUBJECT LAND: 4 Alderway Av

LOCATIO		IL SUBJE	T LAND. 4 AIU	erway Av.		
I/We,	Kevin Mi	chael & Chri	stine Michael	7		
			please pr	int/type the full name	e of the owner(s)	
the City the abov	of Bramp e noted p	oton Commoroperty for	ittee of Adjustm	nent and City of conducting a site	ct land, hereby authorize the Member Brampton staff members, to enter u te inspection with respect to the attac	pon
Dated th	i <mark>s</mark> 1	_ day of	February		, 20 _ <u>24</u>	
(sign	ature of the	e owner[s], o	where the owner i	s a firm or corporation	on, the signature of an officer of the owner.)	
	(where th	e owner is a	firm or corporation,	, please print or type	e the full name of the person signing.)	

NOTE: If the owner is a firm or corporation, the corporate seal shall be affixed hereto.

NO DISCUSSION SHALL TAKE PLACE BETWEEN THE COMMITTEE MEMBERS AND THE APPLICANT DURING THE SITE INSPECTION

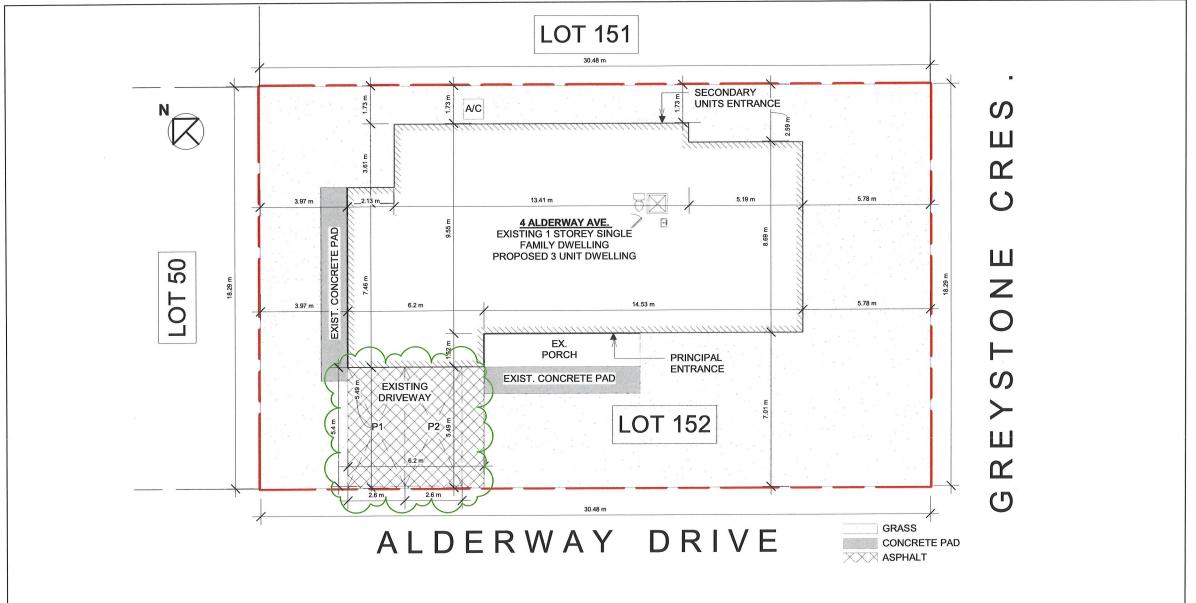





NOTES:

DRAWINGS MUST NOT BE SCALED DRAWINGS TO BE READ IN CONJUNCTION WITH THE GENERAL NOTES AND THE O.B.C.

All drawings & information shown on these drawings must be checked & verified on site prior to construction or fabrication of its

It shall be the responsibility of the contractor to provide all necessary bracing, shoring, sheet piling, or other temporary supports, to

All drawings are the property of the Architect / Designer & must be returned upon request.



ADDRESS: 4 Alderway Ave. Brampton, ON L6Y 2B6 PROJECT: THREE UNIT DWELLING
 Date:
 2024-01-30

 Drawn by:
 S.M

 Checked by:
 S.I

1:128

SITE PLAN

A102

GENERAL TAGS (UNLESS OTHERWISE NOTED)

ALL CONSTRUCTION TO ADHERE TO THESE PLANS AND SPEC'S AND TO CONFORM TO THE ONTARIO BUILDING CODE AND ALL OTHER APPLICABLE CODES AND AUTHORITIES HAVING JURISDICTION, THESE REQUIREMENTS ARE TO BE TAKEN AS MINIMUM SPECIFICATIONS.

ROOF CONSTRUCTION

ROOF FINISH, ON 2-PLY ROOF MEMBRANE 3/4" EXT. PLYWOOD SHEATHING WITH "H" CLIPS. APPROVED JOISTS AS PER PLANS. APPROVED FAVES PROTECTION TO EXTEND 900 mm (3'-0") FROM EDGE OF ROOF AND MIN. 300 mm (12") BEYOND INNER FACE OF EXTERIOR WALL. PREFIN. ALUM. EAVESTROUGH, FASCIA, RWL.

- RSI 10.57 (R60) ROOF INSULATION AND APPROVED VAPOUR BARRIER, 16mm (5/8") INT. DRYWALL FINISH OR APPROVED EQUAL. (R31) ROOF INSULATION IF NO ATTIC SPACE.
- FOUNDATION WALL/ FOOTINGS: -SEE OBC 9.15.4-(3)

POURED CONC. FDTN. WALL WITH BITUMINOUS DAMPROOFING WITH DRAINAGE LAYER, PROVIDE PARGING COVER ON (22"X8") CONTIN. KEYED CONC. FTG. REINFORCED WITH 2-15M CONT. PROVIDE DOWELS INTO FTG TO MATCH VERTICAL STEEL IN WALLS AND COLUMNS EXCEPT WHEN NOTED OTHERWISE. BRACE FOUNDATION WALL PRIOR TO BACKFILLING, ALL FOOTINGS SHALL REST ON NATURAL UNDISTURBED SOIL OR COMPACTED ENGINEERED FILL, WITH MINIMUM BEARING CAPACITY OF 150kPa SERVICIBILITY LIMIT STATES (SLS) OR GREATER AND 200kPa ULTIMATE LIMIT STATES (ULS).

- 100mm (4") DIA. WEEPING TILE 150mm (6") CRUSHED STONE OVER AND AROUND WEEPING
- BASEMENT SLAB (5)

80mm (3") MIN. 25MPa (3600psi) CONC. SLAB ON 100mm (4") COARSE GRANULAR FILL, OR 15MPa (2200psi) CONC. WITH DAMPROOFING BELOW SLAB.

- 38X140 (2"X6") SILL PLATE WITH 13mm (1/2") DIA. ANCHOR BOLTS 200mm (8") LONG, EMBEDDED MIN. 100mm (4") INTO CONC. @ 1200mm (4'-0") O.C., CAULKING OR 25mm (1" MIN. MINERAL WOOL BETWEEN PLATE AND TOP FDTN. WALL, USE NON-SHRINK GROUT TO LEVEL SILL PLATE WHEN REQUIRED.
- BEARING STUD PARTITION

38X150 (2"X6") STUDS @ 400mm (16") O.C. 38X150 (2"X6") SILL PLATE ON DAMPPROOFING MATERIAL, 13mm (1/2") DIA. ANCHOR BOLTS 200mm (8") LONG, EMBEDDED MIN. 100mm (4") INTO CONC. @ 1200mm (4'-0") O.C. 00mm (4") HIGH CONC. CURB ON 350X155 (14"X6") CONC. FOOTING. ADD HORIZ. BLOCKING AT MID-HEIGHT IF WALL IS UNFINISHED

INTERIOR STUD PARTITIONS (8)

> BEARING PARTITIONS 38X89 (2"X4") @ 400mm (16") O.C. FOR 2 STOREYS AND 300mm (12") O.C. FOR 3 STOREYS. NON-BEARING PARTITIONS 38X89 (2"X4") @ 600mm (24") O.C., PROVIDE 38X89 (2"X4") BOTTOM PLATE AND 2/ 38X89 (2-2"X4") TOP PLATE. 13mm (1/2") INTERIOR DRYWALL BOTH SIDES OF STUD, PROVIDE 38/140 (2"X4" OR 2"x6") STUDS/PLATES WHERE NOTED.

EXPOSED FLOOR TO EXTERIOR

PROVIDE (R31) INSULATION, APPROVED VAPOUR BARRIER AND CONTINUOUS AIR BARRIER, FINISHED SOFFIT.

STEEL COLUMN (SEE O.B.C 9.15.3.3)

HSS 4"X4"X1/4" ST. COL. C/W 6"X6"X1/2" PL. TOP WELD TO BEAM & 6"X8"X1/2" BASE PL. C/W 2 - 1/2" DIA. 12" LONG 2" HOOK ANCHORS SET INTO CONC. FIELD WELD COL.TO BASE PL

STEEL BASEMENT COLUMN (SEE O.B.C. 9.15.3.3)

90mm (3-1/2") DIA x 4.78mm (.188") FIXED OR ADJUSTABLE STL. COL. W/ MAX ALLOWABLE LOAD OF 108.6kN (24,000LBS) W/ 150X150X9.5 (6"X6"3/8") STL. TOP & BOTTOM PLATE ON 1070X1070X460 (42"X42"X18") CONC. FOOTING ON UNDISTURBED SOIL OR ENG. FILL CAPABLE OF SUSTAINING A PRESSURE OF 125 kPa. MIN. AND AS PER SOILS REPORT.

STEEL COLUMN

90mm (3-1/2") DIA x 4.78mm (.188) NON-ADJUSTABLE STL. COLUMN WITH 150X150X9.5 (6"X6"3/8") STEEL TOP PLATE. BASE PLATE 120X250X12.5 (4 1/2"X10"X1/2") WITH 2-12mm DIA x 300mm LONG x 50mm HOOK ANCHORS (2-1/2"X12"X2") FIELD WELD COLUMN TO BASE PLATE.

- BEAM POCKET OR 200X200 (8"X8") POURED (13) CONCRETE NIB WALLS. MINIMUM BEARING 90mm (3-1/2").
- STEEL BEARING PLATE FOR MASONRY WALLS

280X280X16 (11"X11"X 5/8") STL. PLATE FOR STL. BEAMS AND 280X280X12 (11"X11"X1/2") STL. PLATE FOR WOOD BEAMS BEARING ON CONC. BLK. PARTYWALL, ANCHORED W/ 2-19mm (3/4") X200mm (8") LONG GALV. ANCHORS WITHIN SOLID BLOCK COURSE. LEVEL WITH NON-SHRINK GROUT.

OR
SOLID WOOD BEARING FOR WOOD STUD WALLS

SOLID REARING TO BE AT LEAST AS WIDE AS THE SUPPORTED MEMBER. SOLID WOOD BEARING COMPRISED OF BUILT-UP WOOD STUDS TO BE CONSTRUCTED IN ACCORDANCE WITH OBC, 9.17.4.2 (2).

- 3-38X89 (3-2"X4") BUILT-UP-POST ON METAL BASE SHOE ANCHORED TO CONC. WITH 12.7 (1/2") DIA. BOLT, 610X610X300 (24"X24"X12") CONCRETE FOOTING.
- STEP FOOTINGS: MIN. HORIZ. STEP = 864mm (2'-10"), MAX, VERT, STEP = 600mm (23 5/8") FOR FIRM SOILS, 400mm (16") MAX, STEP FOR SAND AND GRAVEL
- COLD CELLAR PORCH SLAB

6" 32MPa CONC. SLAB WITH 5-8% AIR ENTRAINMENT. WITH REINF. BARS AS NOTED. SLOPE SLAB MIN. 1.0% FROM DOOR.

- THE FDTN. WALL SHALL NOT BE REDUCED TO LESS THAN 90mm (3-1/2") THICK TO A MAX. DEPTH OF 600mm (24") AND SHALL BE TIED TO THE FACING MATERIAL WITH METAL TIES SPACED 200mm (8") O.C. VERTICALLY AND 900mm (36") O.C. HORIZONTALLY. FILL SPACE BETWEEN WALL AND FACING SOLID WITH MORTAR.
- GARAGE SLAB: 100mm (4") 32 MPa (4640psi) CONC. SLAB WITH 5-8% AIR ENTRAINMENT ON MIN. 100 (4") COARSE GRANULAR FILL WITH COMPACTED SUB-BASE OR COMPACTED NATIVE FILL. SLOPE TO FRONT AT 1% MIN.
- 13mm (1/2") GYPSUM BD. ON WALL AND CEILING BETWEEN HOUSE AND GARAGE (R22) IN WALLS, (R31) IN CEILING. TAPE AND SEAL ALL JOINTS GAS TIGHT.
- DOOR AND FRAME GASPROOFED. DOOR EQUIPPED WITH SELF CLOSING DEVICE AND WEATHERSTRIPPING

FIREPLACE CHIMNEYS -OBC. 9.21.-TOP OF FIREPLACE CHIMNEY SHALL BE 915mm (3'-0") ABOVE THE HIGHEST POINT AT WHICH IT COMES IN CONTACT WITH THE ROOF AND 610mm (2'-0") ABOVE THE ROOF SURFACE WITHIN A HORIZ DISTANCE OF 3050mm (10'-0") FROM THE CHIMNEY.

- MECHANICAL EXHAUST FAN, VENTED TO EXTERIOR, TO PROVIDE AT LEAST ONE AIR CHANGE PER HOUR.
- U.L.C. RATED CLASS "B" VENT 610mm (2'-0") ABOVE THE POINT IN CONTACT WITH THE ROOF FOR SLOPES UP TO 9/12 REFER TO THE ONTARIO GAS UTILIZATION CODE.
- CAPPED DRYER EXHAUST VENTED TO EXTERIOR C/W INSECT SCREEN.
- ATTIC ACCESS HATCH MIN. 545X700 (22"X28") WITH WEATHERSTRIPPING. RSI 5.4 (R40) RIGID INSULATION BACKING
- DIRECT VENT FURNACE TERMINAL MIN. 900mm (36") FROM A GAS REGULATOR. MIN. 300mm 12") ABOVE FIN. GRADE, FROM ALL OPENINGS. EXHAUST & INTAKE VENTS. HRV INTAKE TO BE A MIN. OF 1830mm (6'-0") FROM ALL EXHAUST TERMINALS. REFER TO GAS UTILIZATION CODE.
- DIRECT VENT GAS FIREPLACE. VENT TO BE A MINIMUM 300mm (12") FROM ANY OPENING AND ABOVE FIN. GRADE, REFER TO GAS UTILIZATION CODE.
- ALL STAIRS/ EXTERIOR STAIRS -OBC. 9.8 .-(29)

MAX, RISE = 200 (7-7/8") = 125 (4-7/8") MIN. RUN = 255 (10") MAX NOSING = 25 (1") MIN. HEADROOM = 1950 (6'-5") = 900 (2'-11") RAIL @ LANDING RAIL @ STAIR = 865 (2'-10" MIN STAIR WIDTH = 860 (2'-10")

FOR CURVED STAIRS MIN. RUN NARROW END

MIN RUN

= 150 (6") = 200 (8")

- FINISHED RAILING ON PICKETS SPACED MAXIMUM 100mm (4") BETWEEN PICKETS. GUARDS -OBC. 9.8.8.2.-NTERIOR GUARD: 900mm (2'-11") MIN. EXTERIOR GUARDS: 1070mm (3'-6") MIN.
- RESIDENTIAL GUARD DESIGN LOADS SINGLE FAMILY DWELLING 9.8.7.7.(1)(a)

a) a concetrated load at any point of not less than b) for handrails other than those serving a single dwelling unit, a uniformly distributed load of 0.7KN/m (48lbs/ ft)

SUBFLOOR, JOIST STRAPPING AND BRIDGING

16mm (5/8") T & G SUBFLOOR ON WOOD FLOOR JOISTS. FOR CERAMIC TILE APPLICATION (*SEF OBC 9.30.6.*) 6mm (1/4") PANEL TYPE UNDERLAY UNDER RESILIENT & PARQUET FLOORING (-*SEE ORC 9 23 9 4*) ALL JOISTS TO BE BRIDGED WITH 38X38 (2"X2") CROSS BRACING OR SOLID BLOCKING @ 2100mm (6'-11") O.C. MAX. ALL JOISTS TO BE STRAPPED WITH 19X64 (1"X3") @ 2100mm (6'-11") O.C. UNLESS A PANEL TYPE CEILING FINISH IS APPLIED.

EXPOSED BUILDING FACE -OBC. 9.10.14.11 EXTERIOR WALLS TO HAVE A FIRE RESISTANCE RATING OF NOT LESS THAN 45 mins. WHERE LIMITING DISTANCE IS LESS THAN 1.2M (3'-11") WHERE THE LIMITING DISTANCE IS LESS THAN 600mm (1'-11") THE EXPOSING FACE SHALL BE CLAD IN NON-COMBUSTIBLE MATERIAL

CONVENTIONAL ROOF FRAMING

38X140 (2"X6") RAFTERS @ 400mm (16" O.C.), 38x184 (2"x8") RIDGE BOARD. 38X89 (2"X4") COLLAR TIES AT MIDSPANS, CEILING JOISTS TO BE 38X89 (2"X4") @ 400mm (16") O.C. FOR MAX. 2830mm (9'-3") SPAN & 38X140 (2"X6") @ 400 (16") O.C. FOR MAX. 4450mm (14'-7") SPAN. RAFTERS FOR BUILT-UP ROOF TO BE 38X89 (2"X4") @ 600mm (24") O.C. WITH A 38X89 (2"X4") CENTRE POST TO THE TRUSS BELOW, LATERALLY BRACED @ 1800mm (6'-0") O.C. VERTICALLY

TWO STOREY VOLUME SPACES

FOR A MAXIMUM 5490mm (18'-0") HEIGHT, PROVIDE 2-38X140 (2-2"X6") CONTINUOUS STUDS @ 300mm (12") O.C. FOR BRICK AND 400mm (16") O.C. FOR SIDING, PROVIDE SOLID WOOD BLOCKING BETWEEN STUDS @ 1220mm (4'-0") O.C. VERT. FOR HORIZ. DISTANCES NOT EXCEEDING 2900 mm (9'-6"), PROVIDE 38-140 (2"X6") STUDS @ 400 mm (16") O.C. WITH A CONTINUOUS HEADER AT THE GROUND FLOOR CEILING LEVEL. TOENAILED AND GLUED TO TOP PLATES.

GASPROOFING NOTES FOR CONSTRUCTION BETWEEN GARAGE & DWELLING

ATTACHED GARAGES MUST BE COMPLETELY SEALED TO PREVENT INFILTRATION OF GASES INTO DWELLING

a) PROVIDE 13mm (1/2") GYPSUM BOARD WITH MIN. 2 COATS OF JOINT COMPOUND AT ALL WALLS ADJACENT TO DWELLING. b) CAULK JOINTS BETWEEN GYPSUM BOARD & OTHER SURFACES WITH ACOUSTIC SEALANT c) CAULK PENETRATIONS SUCH AS HOSE BIRS WITH ACOUSTIC SEALANT. D) 9.10.13.15. Doors Between Garages & dwelling units

(1) A door between an attached or built-in garage and a dwelling unit shall be tight-fitting and weatherstripped to provide an effective barrier against the passage of gases & exhaust fumes and shall be fitted with a self-closing device.

O.B.C. 9.10.9.16

ALL CONSTRUCTION NOTES TO BE USED AS A
REFERENCE, NOTES AND ASSEMBLIES MAY DIFFER AS INDICATED ON PLANS.

NOTE:
ROOF TRUSS INFORMATION REFER TO ROOF TRUSS SHOP DRAWINGS FOR ALL ROOF FRAMING INFORMATION UNLESS OTHERWISE NOTED

ALL BEAMS SUPPORTING FLOOR LOADS ARE SPECIFIED AS PER P. FNG. THE FLOOR TRUSS MANUFACTURER TO VERIFY ALL LVL BEAM SIZES FOR SHOP DRAWINGS

FLOOR FRAMING INFO REFER TO TJI SHOP DRAWINGS FOR ALL TRUSS-JOIST INFORMATION AND DETAILS. UNLESS OTHERWISE NOTED.

NOTE:

TYPICAL FOR ALL FLOORS:

- FLOOR SHALL BE 3/4" PLYWOOD. GLUED AND NAILED
- ALL JOISTS SHALL HAVE A MIN. BEARING OF 1 3/4" AT
- WOOD/PSL/LVL BEAMS SHALL HAVE A MIN. BEARING OF 3-1/2" AT SUPPORT TYP, U/ND



NOTES

DRAWINGS MUST NOT BE SCALED DRAWINGS TO BE READ IN CONJUNCTION WITH THE SENERAL NOTES AND THE O.B.C.

All drawings & information shown on these drawings must be checked & verified on site prior to construction or fabrication of its components. Unless noted otherwise, no rovision has been made in the design for conditions

It shall be the responsibility of the contractor to provide all necessary bracing, shoring, sheet piling, or other temporary supports, to safeguard all existing or adjacent structures affected by construction. All dimensions are given in imperial units unless otherwise indicated.

All drawings are the property of the Architect / Designer &



ADDRESS:

4 Alderway Ave. Brampton, ON L6Y 2B6

PROJECT:

THREE UNIT DWELLING

GENERAL NOTES

Date:	2024-01-30
Drawn by:	S.M
Checked by:	S.I

A100

Scale

GENERAL NOTES

- ALL DIMENSIONS ARE IN IMPERIAL UNLESS
- CONTRACTOR SHALL CHECK AND VERIFY ALL DIMENSIONS ON SITE AND REPORT ANY DISCREPANCIES.
- DO NOT SCALE DRAWINGS
- ALL WORK SHALL COMPLY WITH THE ONTARIO
 BUILDING CODE 2012 AND THE REQUIREMENTS OF ALL AUTHORITIES HAVING JURISDICTION.
- THIS DRAWING SET IS THE EXCLUSIVE PROPERTY OF HIS ENGINEERING INC. COPYRIGHT RESERVED.
- CONTRACTOR SHALL NOT MAKE ANY CHANGES OR MODIFICATIONS WITHOUT CONSULTANT'S WRITTEN CONSENT. CONTRACTOR ASSUMES FULL LEGAL AND CONTRACTUAL LIABILITY FOR ANY UNAUTHORIZED CHANGES. CONTRACTOR
- SHALL CORRECT THEM AT HIS/HER OWN COST.
 CONTRACTOR TO SCHEDULE WORK SO IT DOES NOT INTERFERE WITH NORMAL TENANT
- COORDINATE ALL INTERIOR WORK WITH TENANTS.
 PROVIDE MIN. 72 HOURS NOTICE TO TENANTS.
- THE CONTRACTOR, HIS TRADES & SUPPLIERS SHALL PROVIDE SERVICES AND MATERIALS IN COMPLIANCE WITH THE EXISTING CODES,
- STANDARDS AND INDUSTRY GUIDELINES. 10 ALL WORK UPON COMPLETION SHALL BE SUFFICIENT TO OBTAIN THE OCCUPANCY PERMIT. ANY REVISIONS REQUIRED BY THE AUTHORITIES HAVING JURISDICTION SHALL BE AT THE EXPENSE OF THE CONTRACTOR, TRADE OR SUPPLIER.
- COORDINATE GARBAGE CONTAINER LOCATION WITH CONSULTANT AND/OR HOME OWNER. COORDINATE ANY POWER SHUT-OFFS WITH 12. HOME OWNER.
- ALL EXISTING WALL AND FLOOR THICKNESSES AND DETAILING TO BE VERIFIED ON SITE FOR COHESION WITH PLANNED WORK
- 14. EXISTING ROOF HEIGHTS AND SLOPES TO BE VERIFIED ON SITE.

GENERAL DEMOLITION NOTES

- FOR USE OF ON-SITE FACILITIES COORDINATE WITH HOME OWNER AND/OR CONSULTANT.
- FOR ANY FRIABLE ASBESTOS CONTAINING MATERIALS (ACM) ENCOUNTERED, SUSPECTED, OR ANY ACM DAMAGED DURING WORK OPERATIONS, NOTIFY CONSULTANT. DO NOT DISTURB SUCH MATERIAL PENDING INSTRUCTIONS FROM ENVIRONMENTAL CONSULTANT.
- CONTRACTOR TO STORE ALL REMOVED MATERIALS IN SECURE WASTE
- CONTAINER. ALL SECURITY SYSTEM REMOVALS TO BE COORDINATED WITH OWNER'S SECURITY CONTRACTOR PRIOR TO COMMENCEMENT
- CONTRACTOR SHALL VERIFY ALL SECURITY AND ACCESS SYSTEM INSTALLATIONS AND ENSURE THAT SUCH INSTALLATIONS HAVE NOT REDUCED THE PERFORMANCE OF COMPONENTS OR RENDERED THE PRODUCT'S WARRANTY VOID. PROVIDE COMMISIONING REPORTS FOR ALL
- SECURITY AND ACCESS SYSTEMS. CONTRACTOR TO PROTECT ALL ADJACENT SURFACES AND ASSEMBLIES FROM DAMAGE. ALL SURFACES AND ASSEMBLIES DAMAGED BY CONTRACTOR TO BE REPAIRED OR REPLACED AT
- CONTRACTOR'S EXPENSE. PROTECT EXISTING HVAC SYSTEM THROUGHOUT DURATION OF WORK. SHUT DOWN HVAC SYSTEM PRIOR TO SANDING AND/OR DEMOLISHING GYPSUM ASSEMBLIES, CLEAR ALL DUST AND POLLUTED AIR BEFORE TURNING SYSTEM ON. NOTIFY AND COORDINATE WITH CONSULTANT AND HOME OWNER PRIOR TO SHUTTING DOWN HVAC SYSTEM.
- SHUT DOWN AFFECTED FIRE ALARM ZONE DURING HOT WORK, REACTIVE FIRE ALARM ZONE.
- STEEL CUTTING WITH POWER EQUIPMENT
 SHALL BE DONE WITH BURR-FREE SAW BLADES. KEEP SAW BLADES WELL LUBRICATED (SPARKS & FUMES ARE PROHIBITED).
- CONTRACTOR TO REMOVE TO SOURCE ALL ABANDONED AND UNUSED INFRASTRUCTURE WIRES & CABLES IN CEILING CAVITIES, PLENUMS, & WALLS AFFECTED BY WORK UNDER THIS
- PROTECT EXISTING FLOOR FINISHES WITH THICK POLYETHYLENE BARRIERS OR PAINTER'S SHEETS THROUGHOUT DEMOLITION & CONSTRUCTION.
- PROTECT ADJACENT SURFACES AT ALL 12. TIMES WHEN PAINTING AND/OR REPAINTING. DAMAGED OR STAINED SURFACES RESULTING FROM NEGLIGENCE SHALL BE RECTIFIED AT THE CONTRACTOR'S EXPENSE
- CONTRACTOR SHALL PROVIDE ADEQUATE CONSTRUCTION FENCING, HOARDING, AND DUST/FUME BARRIERS AT ALL AREAS OF WORK & THROUGHOUT ENTIRE DURATION OF WORK IN ALL PHASES.
- EXISTING DRAWINGS REPRESENT RECORD DOCUMENTATION OF EXISTING BUILDING CONDITIONS. THE ARCHITECT DOES NOT WARRANT THE ACCURACY OF THE INFORMATION PROVIDED.

WALL SCHEDULE (EXTERIOR TO INTERIOR)



EXIST. FOUNDATION WALL (UNINSULATED)

BITUMINOUS DAMPROOFING WITH DRAINAGE LAYER TO

- POURED CONCRETE FOUNDATION WALL (REFER TO PLANS FOR THICKNESS)



EXISTING FOUNDATION WALL (INSULATED)

- REFER TO FN1. ADD

- -2" RIGID INSULATION BOARD (R10 CONT.), ON
- 2"x4" WOOD STUDS @ 16" O.C. W/BATTS INSULATION (R20), ON - VAPOUR BARRIER, ON
- 1/2" DRYWALL

EXTERIOR DOUBLE BRICK (EXISTING)



- 3-1/2" BRICK VENEER AS PER ELEVATION, ON
- BASE FLASHING UP MIN. 150mm (6") BEHIND
- BUILDING PAPER, ON - 3 1/2" BRICK VENEER, LATH & PLASTER



NEW INTERIOR 2"x4" WALL

-1/2" DRYWALL, ON -2"x4" WOOD STUD @16" O.C, ON



NEW INTERIOR FIRE RATED WALL

CONSTRUCTION COMPLIES WITH SUPPLEMENTARY STANDARDS TO THE O.B.C 2012 SB-3 TABLE 1 WALL NUMBER W4a -38X89 mm (2X4) W OOD STUDS AT 400 mm (16") O.C. -SINGLE 38X89mm (2X4) TOP AND BOTTOM PLATES. -89mm (3 1/2") THICK ABSORPTIVE MATERIAL PROCESSED FROM ROCK, SLAG, GLASS, OR CELLULOSE FIBRE ON ONE SIDE -RESILIANT CHANNEL @400mm O.C ON ONE SIDE OF WALL -1 LAYER 15.9mm (5/8") TYPE "X" GYPSUM BOARD ON RESILIENT -15.9 mm (5/8") TYPE "X" DRYWALL ON OTHER SIDE

ROOF SCHEDULE



EXISTING SLOPED ROOF

FLOOR SCHEDULE



EXISTING CONCRETE SLAB

4" POURED CONCRETE SLAB, ON - 4" COARSE GRANULAR FILL



EXISTING 2X10 WOOD JOISTS

FINISHED FLOORING, ON - 3/4" PLYWOOD SUBFLOOR, ON -2X10 AS PER PLANS, ON

STRUCTURAL NOTES

WINDOW LINTEL SCHEDULE

W1= 2-2X8 (3'-0" MAX. SPAN)

W2= 2-2X10 (4'-6" MAX. SPAN)

W3= 3-2X10 (6'-0" MAX. SPAN)

W4= 3-2X12 (8'-0" MAX. SPAN)

STEEL LINTELS

L1 = L3.5" X 3.5" X 1/4"(4'-0" MAX)

L2 = L5" X 3.5" X 3/8" (7'-0" MAX) $L3 = L6" \times 4" \times 3/8"(9'-0" MAX)$

 $L4 = L7" \times 4" \times 3/8"(11'-0" MAX)$

BOLT STEEL ANGLES TO WOOD LINTEL @24" O.C. ROVIDING MIN. OF 6" BEARING AT ENDS.

ALL PRE-ENGINEERED JOISTS AND LVL TO BE HANDLED & INSTALLED AS PER MANUFACTURE'S INSTRUCTIONS.



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It shall be the responsibility of the contractor to provide all necessary bracing, shoring, sheet piling, or other temporary supports, to safeguard all existing or adjacent structures affected by construction. All dimensions are given in imperial units unless otherwise indicated.

All drawings are the property of the Architect / Designer & must be returned upon request.



ADDRESS:


4 Alderway Ave. Brampton, ON L6Y 2B6 PROJECT:

THREE UNIT DWELLING


2024-01-30 Date: S.M Drawn by: S.I Checked by:

WALL TYPE & STRUCTURAL NOTES A101

Scale:

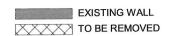

AREA: 1,629 SQFT CEILING: 7'-6"

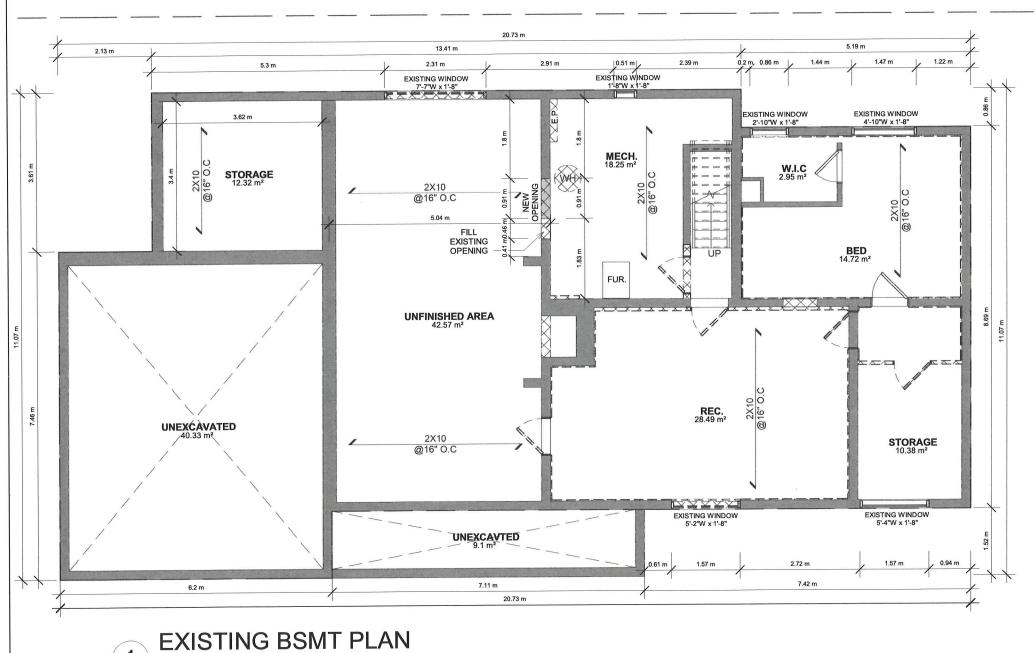



NOTE

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ADDRESS:

4 Alderway Ave. Brampton, ON L6Y 2B6

PROJECT:


THREE UNIT DWELLING

EXISTING BASEMENT PLAN


Date:	2024-01-30
Drawn by:	S.M
Checked by:	S.I

A103

Scale: 1 : 64

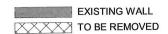

AREA: 2,119 SQFT CEILING: 8'-0"

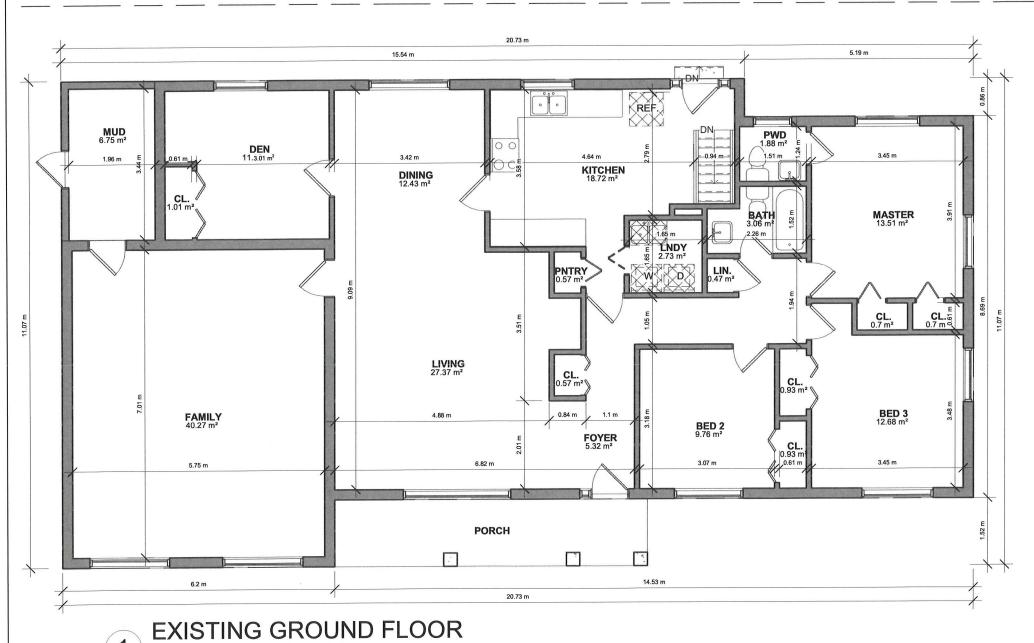



NOTE

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ADDRESS:

4 Alderway Ave. Brampton, ON L6Y 2B6

PROJECT:

THREE UNIT DWELLING

EXISTING GROUND FLOOR PLAN

2024-01-30
S.M
S.I

A104

Scale: 1:64

EXISTING WALL NEW WALL FRR WALL

AREA: 1,599 SQFT

UNIT #1: 739 SQFT UNIT #2: 727 SQFT

*NOTE: **EXISTING 1/2" DRYWALL CEILLING TO REMAIN**

CEILING: 7'-6"

PROPOSED BSMT PLAN

FURNACE MAY SERVE BOTH UNITS PROVIDED A SMOKE DETECTOR IS INSTALLED IN THE SUPPLY OR RETURN AIR DUCT SYSTEM WHICH WOULD TURN OFF THE FUEL SUPPLY AND ELECTRICAL POWER TO THE HEATING SYSTEM UPON ACTIVATION OF SUCH DETECTOR.

[AS PER OBC PART 11: C152 & C153] SPRINKLERED FURNACE RM. (NO FIRE RATED CEILING) DUCT-TYPE SMOKE DETECTOR SHALL BE INSTALLED IN DUCT SYSTEM IN FURNACE



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ADDRESS:

4 Alderway Ave. Brampton, ON L6Y 2B6

PROJECT:


THREE UNIT DWELLING

PROPOSED BASEMENT PLAN

2024-01-30	
S.M	
S.I	


A105

1:64 Scale:

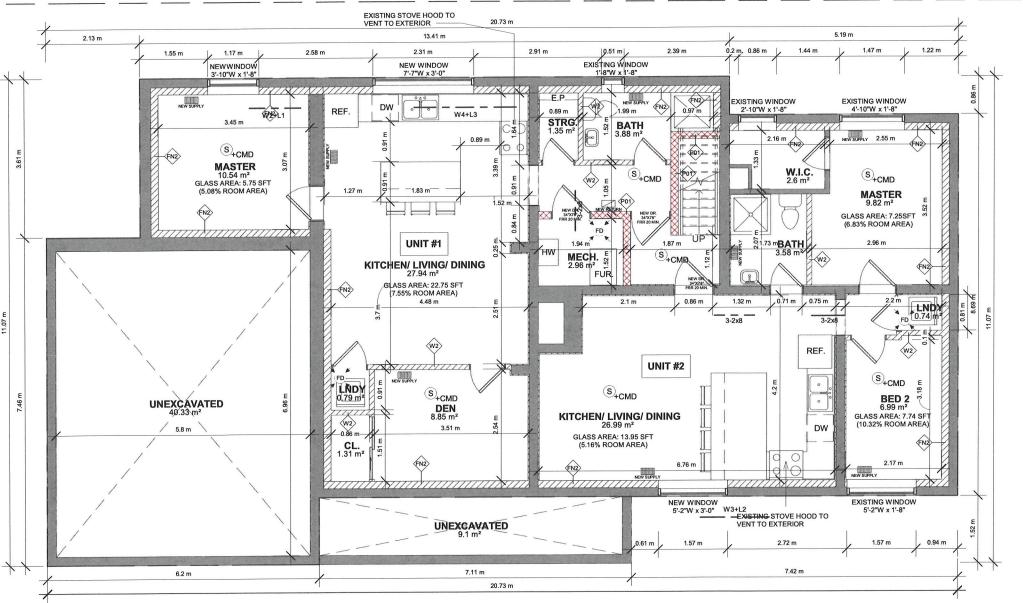



AREA: 2,119 SQFT CEILING: 8'-0"

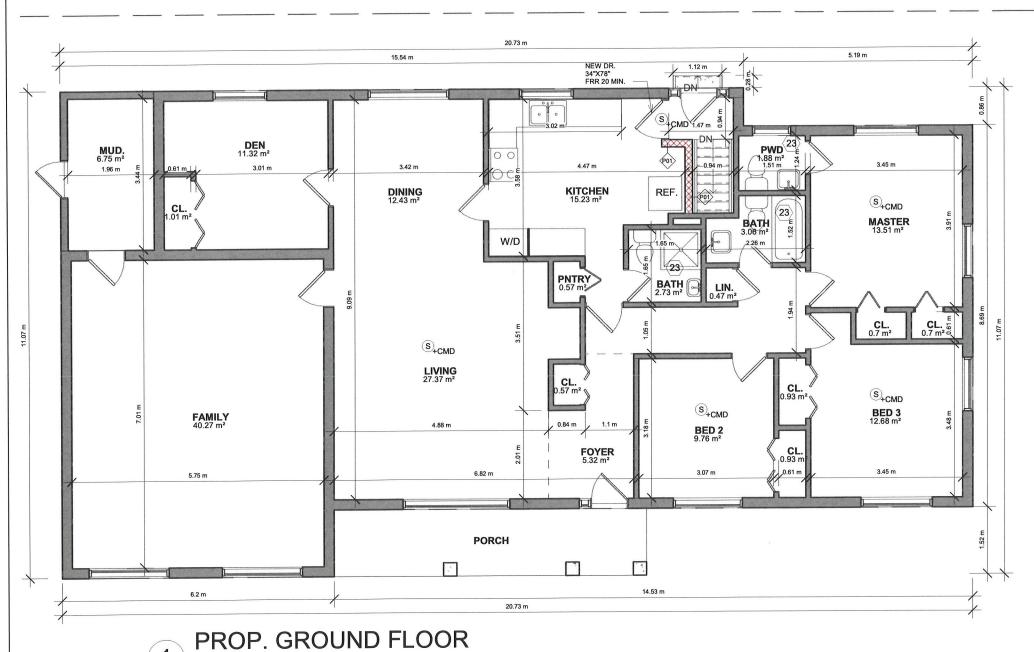



NOTE

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ADDRESS:

4 Alderway Ave. Brampton, ON L6Y 2B6

PROJECT:

THREE UNIT DWELLING

PROPOSED GROUND FLOOR PLAN

Date:	2024-01-30
Drawn by:	S.M
Checked by:	S.I


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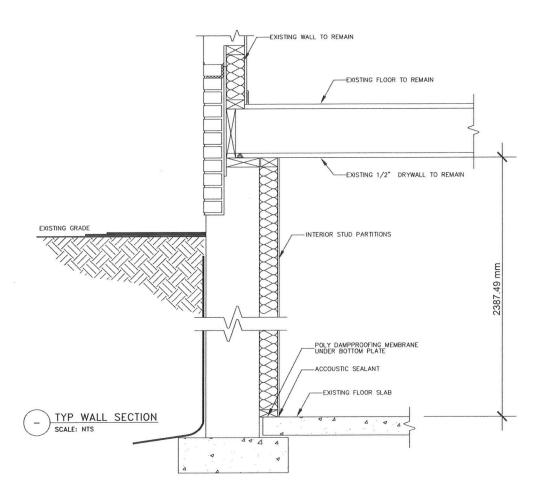
Scale: 1:64



Construction complies with supplementary standards to the O.B.C 2012 SB-3 table 1 wall number W4b

- 38 X 89 mm (2 X 4) wood studs at 400 mm (16") o.c. single 38 X 89 mm (2 X 4) top and bottom plates 89mm (3 1/27) thick absorptive material processed from rock, slag, glass, or cellulose fibre on one side Resiliant channel @ 400mm o.c. on one side of wall
- 2 layer 15.9mm (5/8") type "X" gypsum board on resilient metal channel side
 15.9 mm (5/8") type "X" drywall on other side



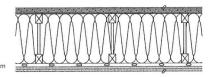



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4 Alderway Ave. Brampton, ON L6Y 2B6 PROJECT:


THREE UNIT DWELLING

2024-01-30 Date: Drawn by: S.M S.I Checked by:

TYP. WALL SECTION

A107

Scale:

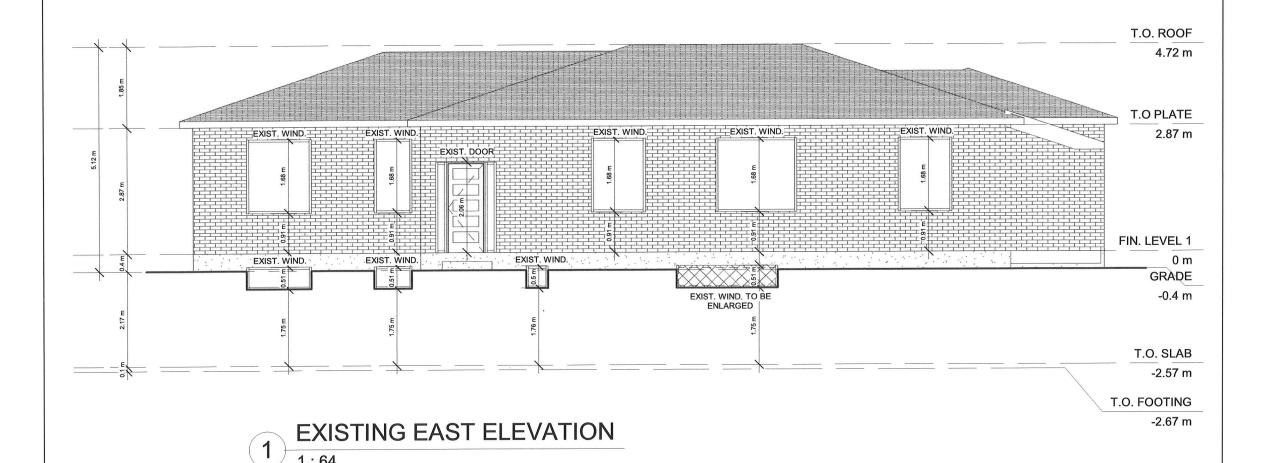

ADDRESS:

4 Alderway Ave. Brampton, ON L6Y 2B6 PROJECT:

THREE UNIT DWELLING

EXISTING EAST ELEVATION

2024-01-30

S.M

S.I

1:64

Date: Drawn by:

Scale:


Checked by:

A108

HNS
Engineering Inc.

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HNS Engineering Inc.

PROPOSED EAST ELEVATION

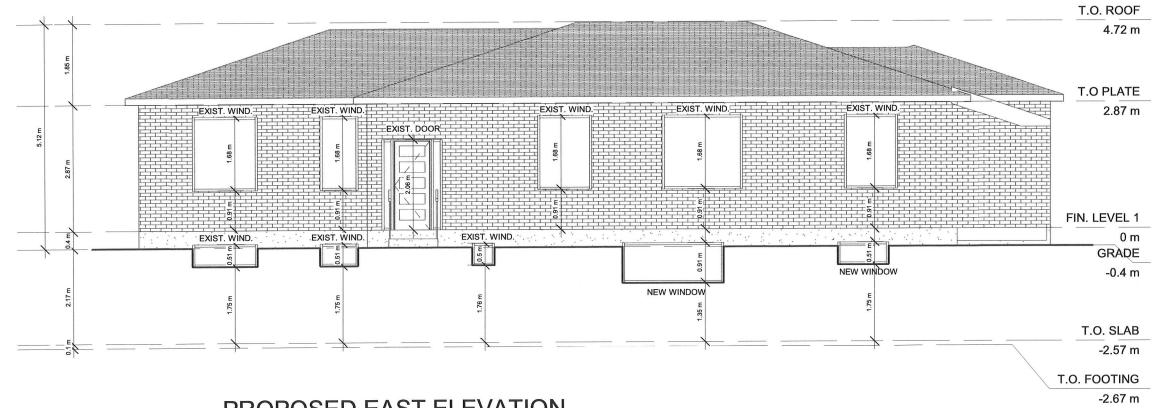All drawings are the property of the Architect / Designer & must be returned upon request.



K.M. NOMAN 100143559

4 Alderway Ave. Brampton, ON L6Y 2B6

ADDRESS:

PROJECT: THREE UNIT DWELLING

2024-01-30 Date: S.M Drawn by: S.I Checked by:

PROPOSED EAST **ELEVATION**

A109 Scale: 1:64

Zoning Non-compliance Checklist

File	No.
A	-2024-0041

Applicant: Sarah Mahdi Address: 4 Alderway Ave

Zoning: R1B

By-law 270-2004, as amended

Category	Proposal	By-law Requirement	Section #
PARKING	To permit a total of 2 parking spaces	whereas the by-law requires a minimum 3 parking spaces for a three-unit dwelling;	10.16(f)
LOT DIMENSIONS AREA / DEPTH / WIDTH			
BUILDING SETBACKS FRONT / SIDE / REAR			
BUILDING SIZE			
BUILDING HEIGHT			
COVERAGE			
BELOW GRADE ENTRANCE			
ACCESSORY STRUCTURE SETBACKS			
ACCESSORY STRUCTURE SIZE / HEIGHT			
MULTIPLE ACCESSORY STRUCTURES			
DRIVEWAY WIDTH	*		
LANDSCAPED OPEN SPACE			
ENCROACHMENTS			
TWO-UNIT DWELLING			
SCHEDULE "C"			
OTHER - DECK			

Connor Cowan	
Reviewed by Zoning	
2024-02-07	
Date	