

# **DRAWING LIST** SHEET NAME SHEET No.

A000	CONTEXT PAGE
A01	GENERAL NOTES & SCHEDULES
A001	3D VIEWS
A100	SITE PLAN
A101	FOOTING/FOUNDATION PLAN
A102	GROUND FLOOR PLAN
A103	SECOND FLOOR PLAN
A104	ROOF PLAN
A200	FRONT & REAR ELEVATIONS
A201	LEFT & RIGHT ELEVATIONS
A300	BUILDING SECTIONS
A400	TYPICAL DETAILS

Grand total: 12



TEM	ONTARIO	O BUILD	DING	CODE D	ATA N	1ATRIX					OBC REFERENCE			
1					OREY A	DDITION		$\square$ N	EW	☐ PART 3	PART 9	☐ PART 11		
	CREDITV							✓ A	DDITION		B1.1.2.4			
	7699 Cre	ditview	Rd.	Brampt	on, Ol	V ☐ CHANGE	OF USE	□ A	LTERATION	1.1.2.4	B9.10.1.3			
2	MAJOR OCCUPANCY(S) GROUP 'C' - RESIDENTIAL						3.1.2.1.(1)	B9.10.2						
3	BUILDING AREA (m2) EXISTING 159.96m² NEW 69.01m² TOTAL 228.97m							TAL <b>228.97m</b>	1.4.1.2	B1.4.1.2				
4	GROSS F	LOOR A	REA (	m2)		EXISTING 123.	36m² NEW 14	<b>43.94m</b> ² TO	TAL <b>269.31m</b> ²	1.4.1.2	B1.4.1.2			
5	NUMBER	R OF STC	OREYS	5		ABOVE GRADE	_2	BELOW GRA	DE <b>1</b>	1.1.2.4	B1.1.2.4			
6	HEIGHT (	OF BUIL	DING	(m)		9.75	m							
7	NUMBER	OF STR	REETS	/ACCES	S ROU	TES <b>1</b>				3.2.2.10	B9.10.20.3			
8	BUILDIN	G CLASS	SIFICA	TION 6	GROUP	P 'C' - RESIDENTI	AL			3.2.2.2083	B9.10.2 B9.10.8.1			
9	SPRINKL	ER SYSTI	EM				ENTIRE B	UILDING		3.2.2.2083	B9.10.8			
							☐ BASEMENT ONLY							
		]			IN LIEU IF ROOF RATING			3.2.2.17						
							NOT REQ	UIRED		INDEX				
10	STANDPI	PE REQ	UIREL	D			☐ YES	✓ NO	1	3.2.9	N/A			
11	FIRE ALA	RM REC	QUIRE	D			☐ YES	✓ <sub>NO</sub>		3.2.4	B9.10.18.2			
12	WATER S	ERVICE,	/SUP	PLY IS A	DEQU	ATE	YES	□ NO	)	3.2.5.7	N/A			
13	HIGH BU	ILDING					☐ YES	✓ NO	)	3.2.6	N/A			
14	PERMITTED CONSTRUCTION ☐ COMBUSTIBLE ☐ NON-COMBUSTIBLE ☐ BOTH  ACTUAL CONSTRUCTION ☐ COMBUSTIBLE ☐ NON-COMBUSTIBLE ☐ BOTH							3.2.2.2083	B9.10.8 B9.10.14.5					
15	MEZZAN				/ A					N/A	N/A			
16	TOTAL O		VCY L		<u>.</u> М2/РЕ	PERSONS ERSON	<b>√</b> 2 PERSON	NS/BED		3.1.17	B9.9.1.3			
17	BARRIER		ESIGI	N E	NTIRE	BUILDING	☐ YES	√NO	(EXPLAIN)	3.8	B9.5.2.1			
18	HAZARD	ous su	BSTA	NCES			YES	<b>▼</b> NO	)	3.3.1.2 3.3.1.19	B9.10.1.3.(4)			
19	REQUIRE	FRR (HOURS)				LISTED	LISTED DESIGN NO.		3.2.2.2083 B9.10.8 B9.10.9					
	FIRE RESISTAI					OR DESCRIPTION (SB-3)		3.2.1.4	в9.10.9 В9.10.9.16					
	RATING	VCE	FLO	ORS	N/	A HOURS		I/A						
	(FRR)		ROC	DF -	N/	'A HOURS		I/A						
			MEZ	ZZANINE	N/	'A HOURS	N.	I/A	-					
			FF	RR OF		_	LISTER	DESIGN NO	) <del>.</del>					
				JPPORT IEMBER:				SCRIPTION (						
			FLO	ORS .	N/	'A HOURS		I/A						
	ROOF N/A HOURS N/A													
			MEZ	ZZANINE	<u>N/</u>	'A HOURS		I/A						
20	SPATIAL	SEPARA	TION	ı - CONS	TRUCT	TION OF EXTERIO	OR WALLS		T	3.2.3	B9.10.15			
	WALL	Area Expos	- 1	Limiting		Proposed % of	Permitted max. % of	FRR	Listed Design	Combustable Construction.	Combustable Construction.	Non-Combi		
		Buildi	ing	Dist. (m)	OR H/I	Openings	Openings	(Hours)	or	CONSTRUCTION.	N-Combustable	Constructi		
		Face (			H/L	per Design	per OBC		Descirption		Cladding	~		
FRON	T	102.4		40.5m		11.5%	100%			<b>*</b>	X	×		
REAR	96.5n					39.6m		27.4%	100%			<b>4</b>	X	×
LEFT				21.4m		7.4%	100%			<b>*</b>	X	X		
RIGH1	Γ	96.5n	12	2.45m		3.8%	9%			<b>✓</b>	×	×		

### 1.) THESE DRAWINGS MUST BE CHECKED BY THE CUSTOMER OR CONTRACTOR. ANY ERRORS OR OMISSIONS MUST BE REPORTED IN WRITING TO NUTIMA DESIGN & PROJECT MANAGEMENT PRIOR TO COMMENCEMENT OF CONSTRUCTION.

2.) OWNER OR CONTRACTOR MUST CHECK AND VERIFY ALL SITE CONDITIONS BEFORE PROCEEDING WITH THE WORK.

3.) ALL DIMENSIONS SHOWN ON THESE DRAWINGS MUST BE CHECKED AGAINST ALL OTHER PROJECT DRAWINGS. ALL DISCREPANCIES MUST BE REPORTED TO THE CONSULTANT BEFORE PROCEEDING WITH THE WORK.

4.) FOR CONSTRUCTION PURPOSES, USE ONLY THE LATEST APPROVED DRAWINGS LABELLED SSUED FOR CONSTRUCTION'.

5.) DO NOT SCALE THE DRAWINGS.



	Revision Schedule					
No.	Description	Date				
7	Issued for Client Review	07/07/2021				
8	Submitted to CVC	06/08/2021				
9	Issued for HVAC	17/08/2021				
10	Issued for Trusses/Floors	17/08/2021				
11	Issued for Trusses/Floors	24/08/2021				
12	Approved by CVC	14/09/2021				
13	Issued for Structural Review	22/09/2021				
14	FND REV.	30/09/2021				
15	Issued for Permit	28/09/2021				
16	Minor Variance Approved	07/12/2021				
17	Issued for Heritage Review	08/07/2021				
18	Revis. Per Heritage Review	03/04/2022				
20	ISSUED PER	12/06/2023				



HERITAGE MEETING

**FOR HERITAGE REVIEW** 

Nutima Design & Project Management Inc.

289-327-1311

Creditview

Residence Address:

7699 Creditview Rd, Brampton, ON

Project No: 2021-35

Drawn By: W.K. Date: MAY 2021 Chkd By: W.K | Scale: 1/4" = 1'-0"

Drawing

Dwg Title: Revision:

PAGE

CONTEXT

20

1. THESE WORKING DRAWINGS ARE PROVIDED TO MAKE THE FULL DETAILS OF THE BUILDING OR STRUCTURE SHOWN. THEY MAY ALSO BE USED AS DOCUMENTS FOR CONSTRUCTION. ALL NOTES AND DIMENSIONS ARE SUBJECT TO CHANGE ACCORDING TO THE ARCHITECTURAL DRAWINGS, OWNER, LOCAL BUILDING OFFICIAL, APPLICABLE CODES, BUILDING REQUIREMENTS AND SITE CONDITIONS. THESE DRAWINGS ARE TO BE CHECKED BY THE CUSTOMER, OWNER AND / OR CONTRACTOR(S) INCLUDING COORDINATION OF THESE AGAINST ANY OTHER CONSTRUCTION DOCUMENTS. ANY ERRORS OR OMISSIONS MUST BE REPORTED IN WRITING TO THE DESIGNER PRIOR COMMENCEMENT OF CONSTRUCTION.

- 2. THESE DRAWINGS ARE NOT TO BE SCALED.
- 3. ALL WORK SHALL BE DONE IN ACCORDANCE WITH THE ONTARIO BUILDING CODE, ONTARIO ELECTRICAL CODE, AND ONTARIO FIRE CODE LATEST EDITIONS THEREOF.
- 4. THE WORK SHALL ALSO BE IN ACCORDANCE WITH ALL LOCAL CODES, AUTHORITIES HAVING JURISDICTION AND WITH ANY OWNER REQUIREMENTS NOT SPECIFICALLY COVERED.
- 5. THE CONTRACTOR SHALL COORDINATE WITH ALL TRADES INCLUDING SUBCONTRACTORS TO ENSURE NO CONFLICTS AND TO ENSURE EFFICIENT COMPLETION OF THE WORK.
- 6. EVERY ATTEMPT HAS BEEN MADE FOR COMPLETENESS HOWEVER IT IS THE CONTRACTORS' RESPONSIBILITY TO CONFIRM SITE CONDITIONS AND FIELD CONSTRUCTION.

1.) NO GEOTECHNICAL REPORT HAS BEEN PROVIDED FOR THIS DESIGN. THE DESIGN IS BASED ON TYPICAL SOILS CONDITIONS WITHIN THE GEOGRAPHIC AREA. ASSUMED ALLOWABLE BEARING CAPACITY OF 100 kPa AS SETOUT IN OBC-B9.4.4.1.

## **GENERAL REVIEW & INSPECTION:**

1.) A PERSON WHO INTENDS TO CONSTRUCT OR HAVE CONSTRUCTED A BUILDING, ALTERATION OR ADDITION THAT IS DESIGNED BY A "DESIGNER" SHALL ENSURE THAT THE "DESIGNER" IS RETAINED TO UNDERTAKE THE GENERAL REVIEW OF THE CONSTRUCTION OF THE BUILDING IN ACCORDANCE WITH THE PERFORMANCE STANDARDS OF THE ASSOCIATION, AS APPLICABLE AND AS SETOUT IN THE ONTARIO BUILDING CODE OBC- 2.17.4 TO DETERMINE WHETHER THE CONSTRUCTION IS IN GENERAL CONFORMITY WITH THE PLANS, SKETCHES, DRAWINGS, GRAPHIC REPRESENTATIONS, SPECIFICATIONS AND OTHER DOCUMENTS THAT ARE PREPARED BY THE "DESIGNER"; COPIES OF WRITTEN REPORTS ARISING OUT OF THE GENERAL REVIEW SHALL BE FORWARDED TO THE CHIEF BUILDING OFFICIAL BY THE DESIGNER WHO HAVE BEEN RETAINED TO UNDERTAKE THE GENERAL REVIEW OF THE CONSTRUCTION OF THE BUILDING.

- 2.) THE SIGNING CONSULTANT OR A DESIGNATED REPRESENTATIVE OF NUTIMA DESIGN & PROJECT MANAGEMENT, SHALL BE PROVIDED WITH A MINIMUM 48 HOURS NOTICE OF REQUIRED INSPECTIONS.
- 3.) INSPECTIONS BY NUTIMA DESIGN & PROJECT MANAGEMENT, ARE REQUIRED AS FOLLOWS:
- CONCRETE FOOTING & FOUNDATION WALL INSPECTION (PRE-POUR) - FRAMING COMPLETION INSPECTION (PRIOR TO INSULATION AND VAPOUR BARRIER)
- CONSTRUCTION COMPLETION




1.) THESE DRAWINGS MUST BE CHECKED BY THE CUSTOMER OR CONTRACTOR. ANY ERRORS OR OMISSIONS MUST BE REPORTED IN WRITING TO NUTIMA DESIGN & PROJECT MANAGEMENT PRIOR TO COMMENCEMENT OF CONSTRUCTION.

2.) OWNER OR CONTRACTOR MUST CHECK AND VERIFY ALL SITE CONDITIONS BEFORE PROCEEDING WITH THE WORK.

3.) ALL DIMENSIONS SHOWN ON THESE DRAWINGS MUST BE CHECKED AGAINST ALL OTHER PROJECT DRAWINGS. ALL DISCREPANCIES
MUST BE REPORTED TO THE CONSULTANT BEFORE PROCEEDING WITH THE WORK.

4.) FOR CONSTRUCTION PURPOSES, USE ONLY THE LATEST APPROVED DRAWINGS LABELLED 'ISSUED FOR CONSTRUCTION'.

5.) DO NOT SCALE THE DRAWINGS.

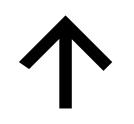

	Revision Schedule		
No.	Description	Date	
19	Issued for Client Review	26/08/2022	
20	ISSUED PER HERITAGE MEETING	12/06/2023	



Project Status: FOR HERITAGE **REVIEW** 

Nutima Design & Project Management Inc.

289-327-1311


Creditview Residence


Address:

7699 Creditview Rd, Brampton, ON Project No:

Drawn By: W.K. Date: MAY 2021

3D VIEWS 2021-35 Chkd By: W.K Scale: Dwg Title: Revision: A001 20

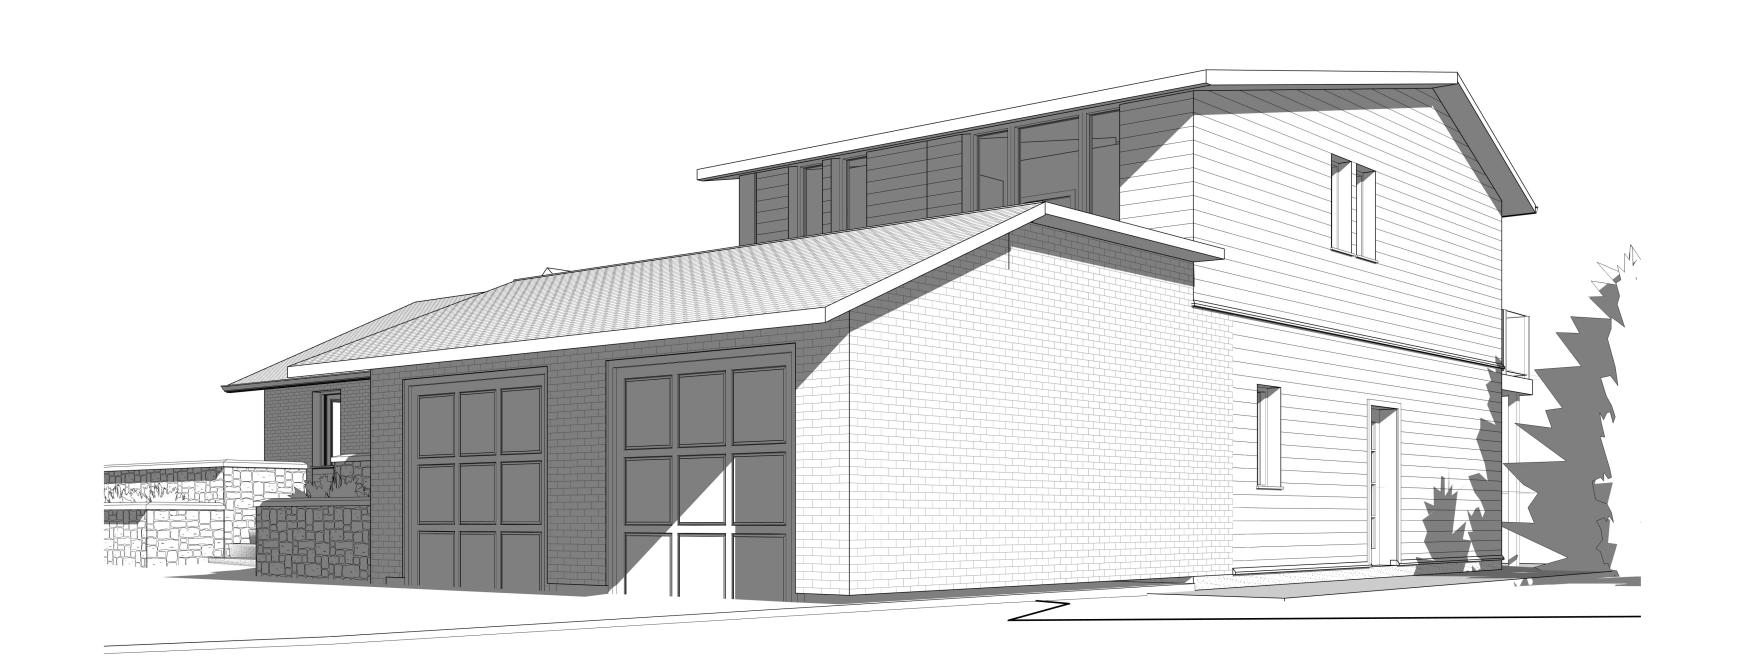

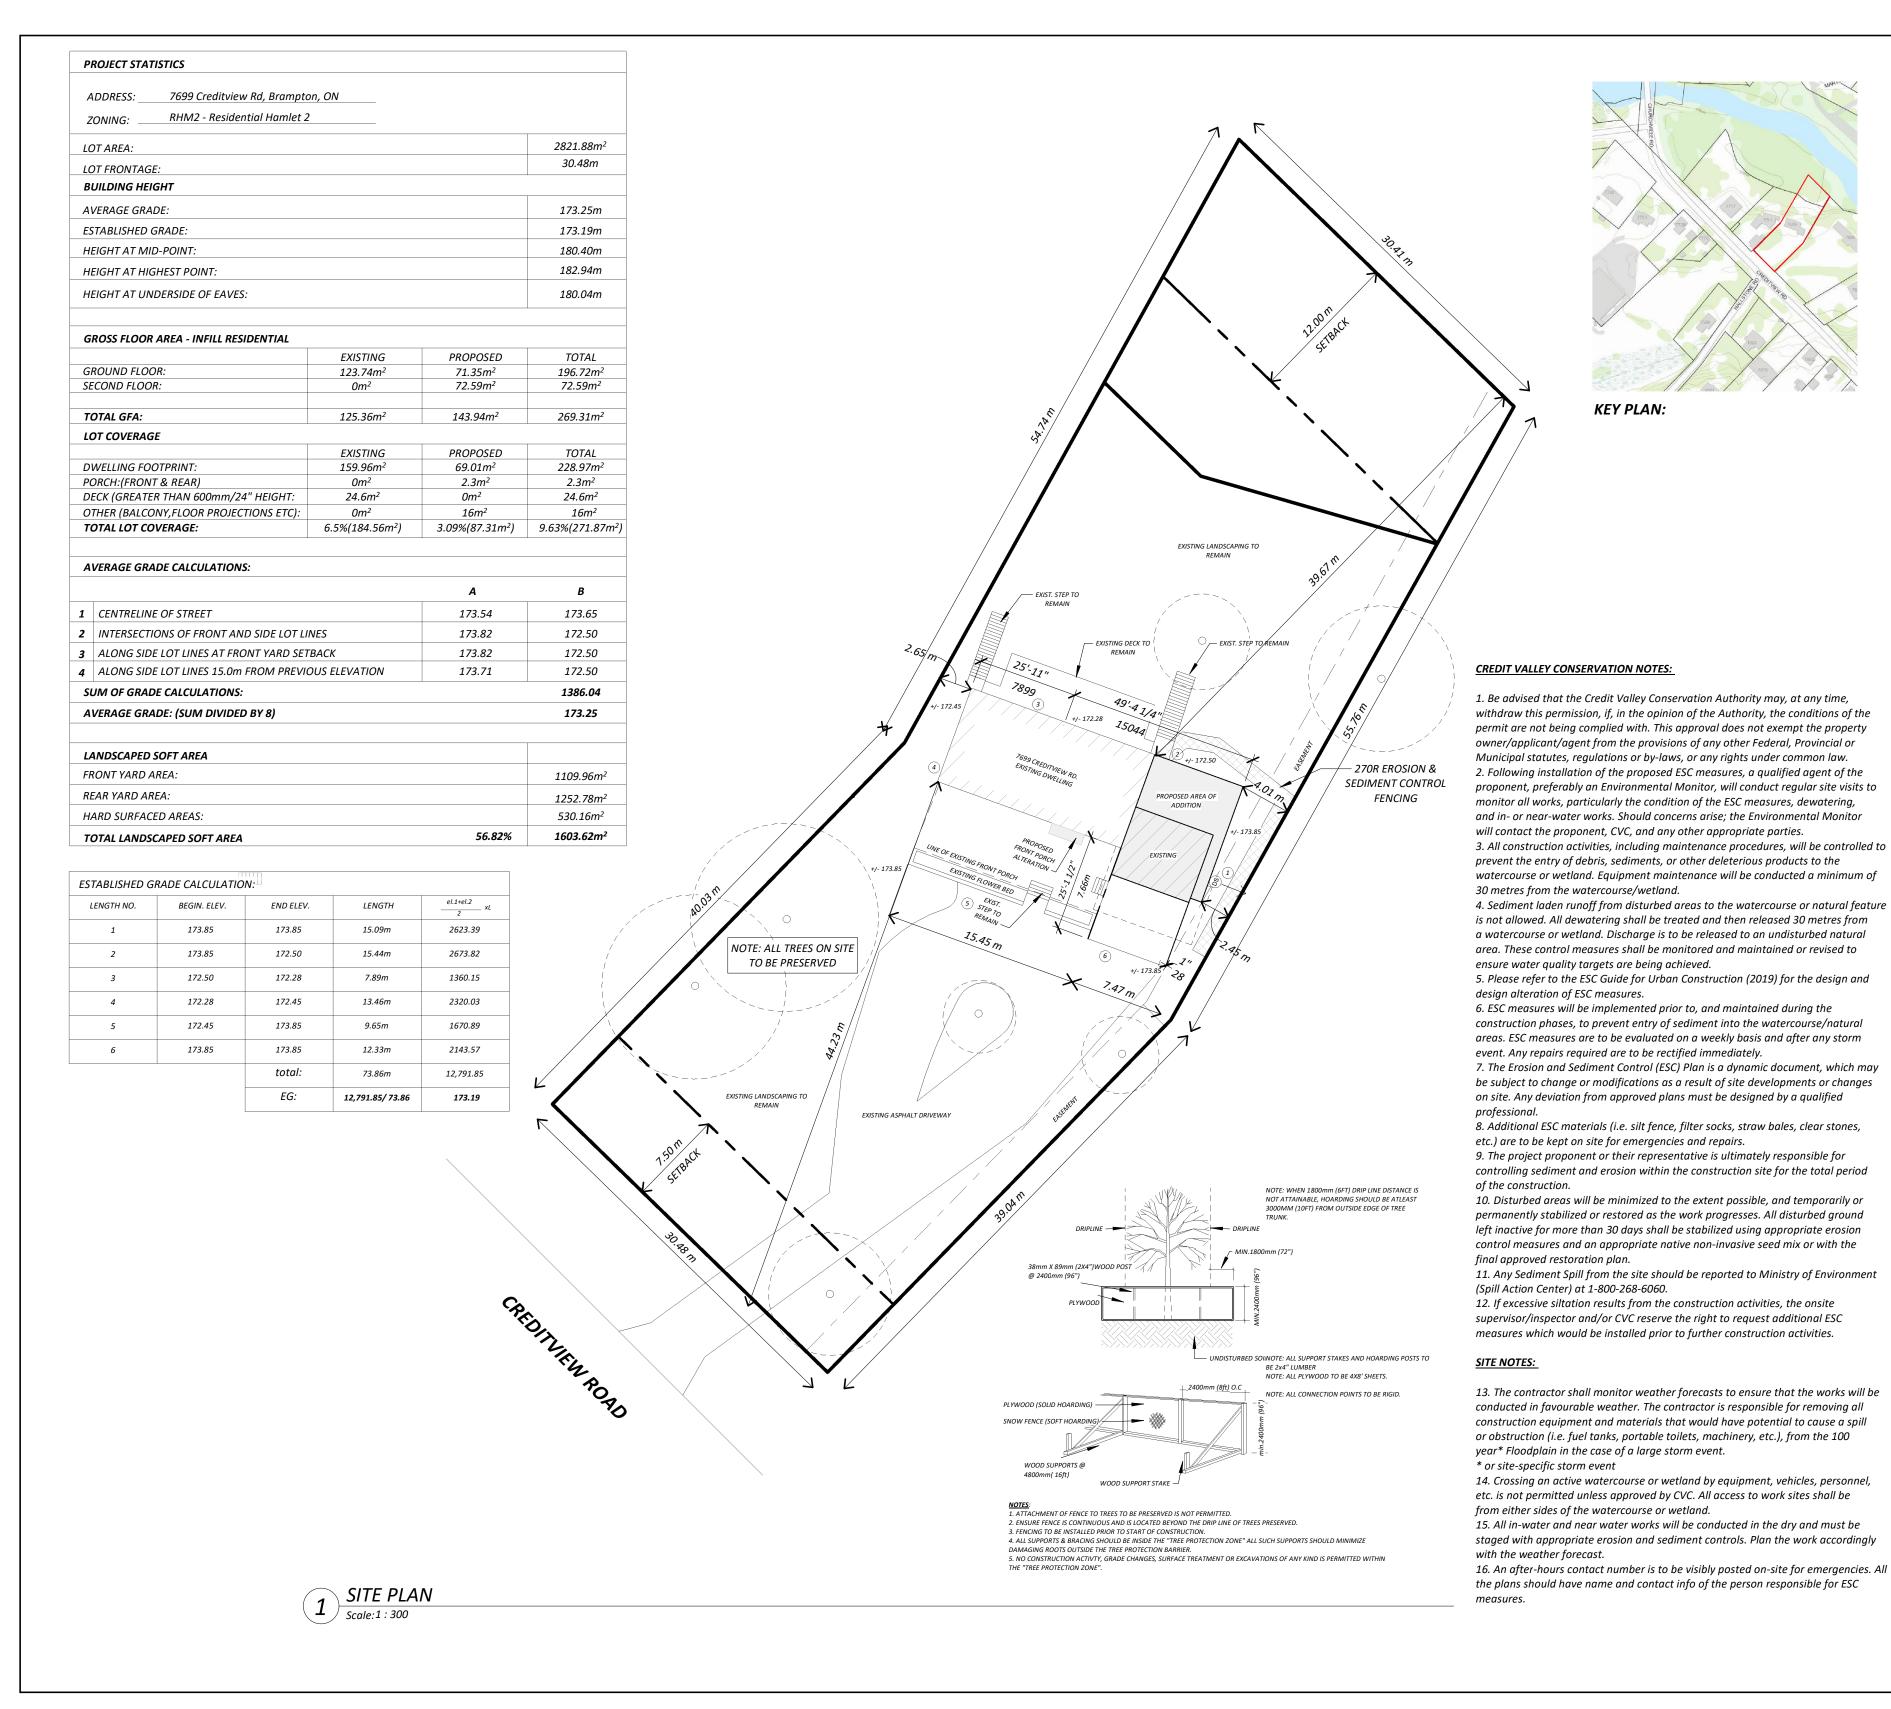

1.) THESE DRAWINGS MUST BE CHECKED BY THE CUSTOMER OR CONTRACTOR. ANY ERRORS OR OMISSIONS MUST BE REPORTED IN WRITING TO NUTIMA DESIGN & PROJECT MANAGEMENT PRIOR TO COMMENCEMENT OF CONSTRUCTION.

2.) OWNER OR CONTRACTOR MUST CHECK AND VERIFY ALL SITE CONDITIONS BEFORE PROCEEDING WITH THE WORK.

3.) ALL DIMENSIONS SHOWN ON THESE DRAWINGS MUST BE CHECKED AGAINST ALL OTHER PROJECT DRAWINGS. ALL DISCREPANCIES MUST BE REPORTED TO THE CONSULTANT BEFORE PROCEEDING WITH THE WORK.

4.) FOR CONSTRUCTION PURPOSES, USE ONLY THE LATEST APPROVED DRAWINGS LABELLED SSUED FOR CONSTRUCTION'.

5.) DO NOT SCALE THE DRAWINGS

**KEY PLAN:** 



# **Revision Schedule**

No.	Description	Date
7	Issued for Client Review	07/07/2021
8	Submitted to CVC	06/08/2021
9	Issued for HVAC	17/08/2021
10	Issued for Trusses/Floors	17/08/2021
11	Issued for Trusses/Floors	24/08/2021
12	Approved by CVC	14/09/2021
13	Issued for Structural Review	22/09/2021
14	FND REV.	30/09/2021
15	Issued for Permit	28/09/2021
16	Minor Variance Approved	07/12/2021
17	Issued for Heritage Review	08/07/2021
18	Revis. Per Heritage Review	03/04/2022
20	ISSUED PER HERITAGE MEETING	12/06/2023



# FOR HERITAGE

**REVIEW** 

Nutima Design & Project Management Inc.

289-327-1311

Project:

Creditview Residence

7699 Creditview Rd, Brampton, ON Project No:

2021-35

Drawn By: W.K. Date: MAY 2021 Chkd By: W.K | Scale: As indicated


Revision: 20


PLAN


SITE

Dwg Title:

A100

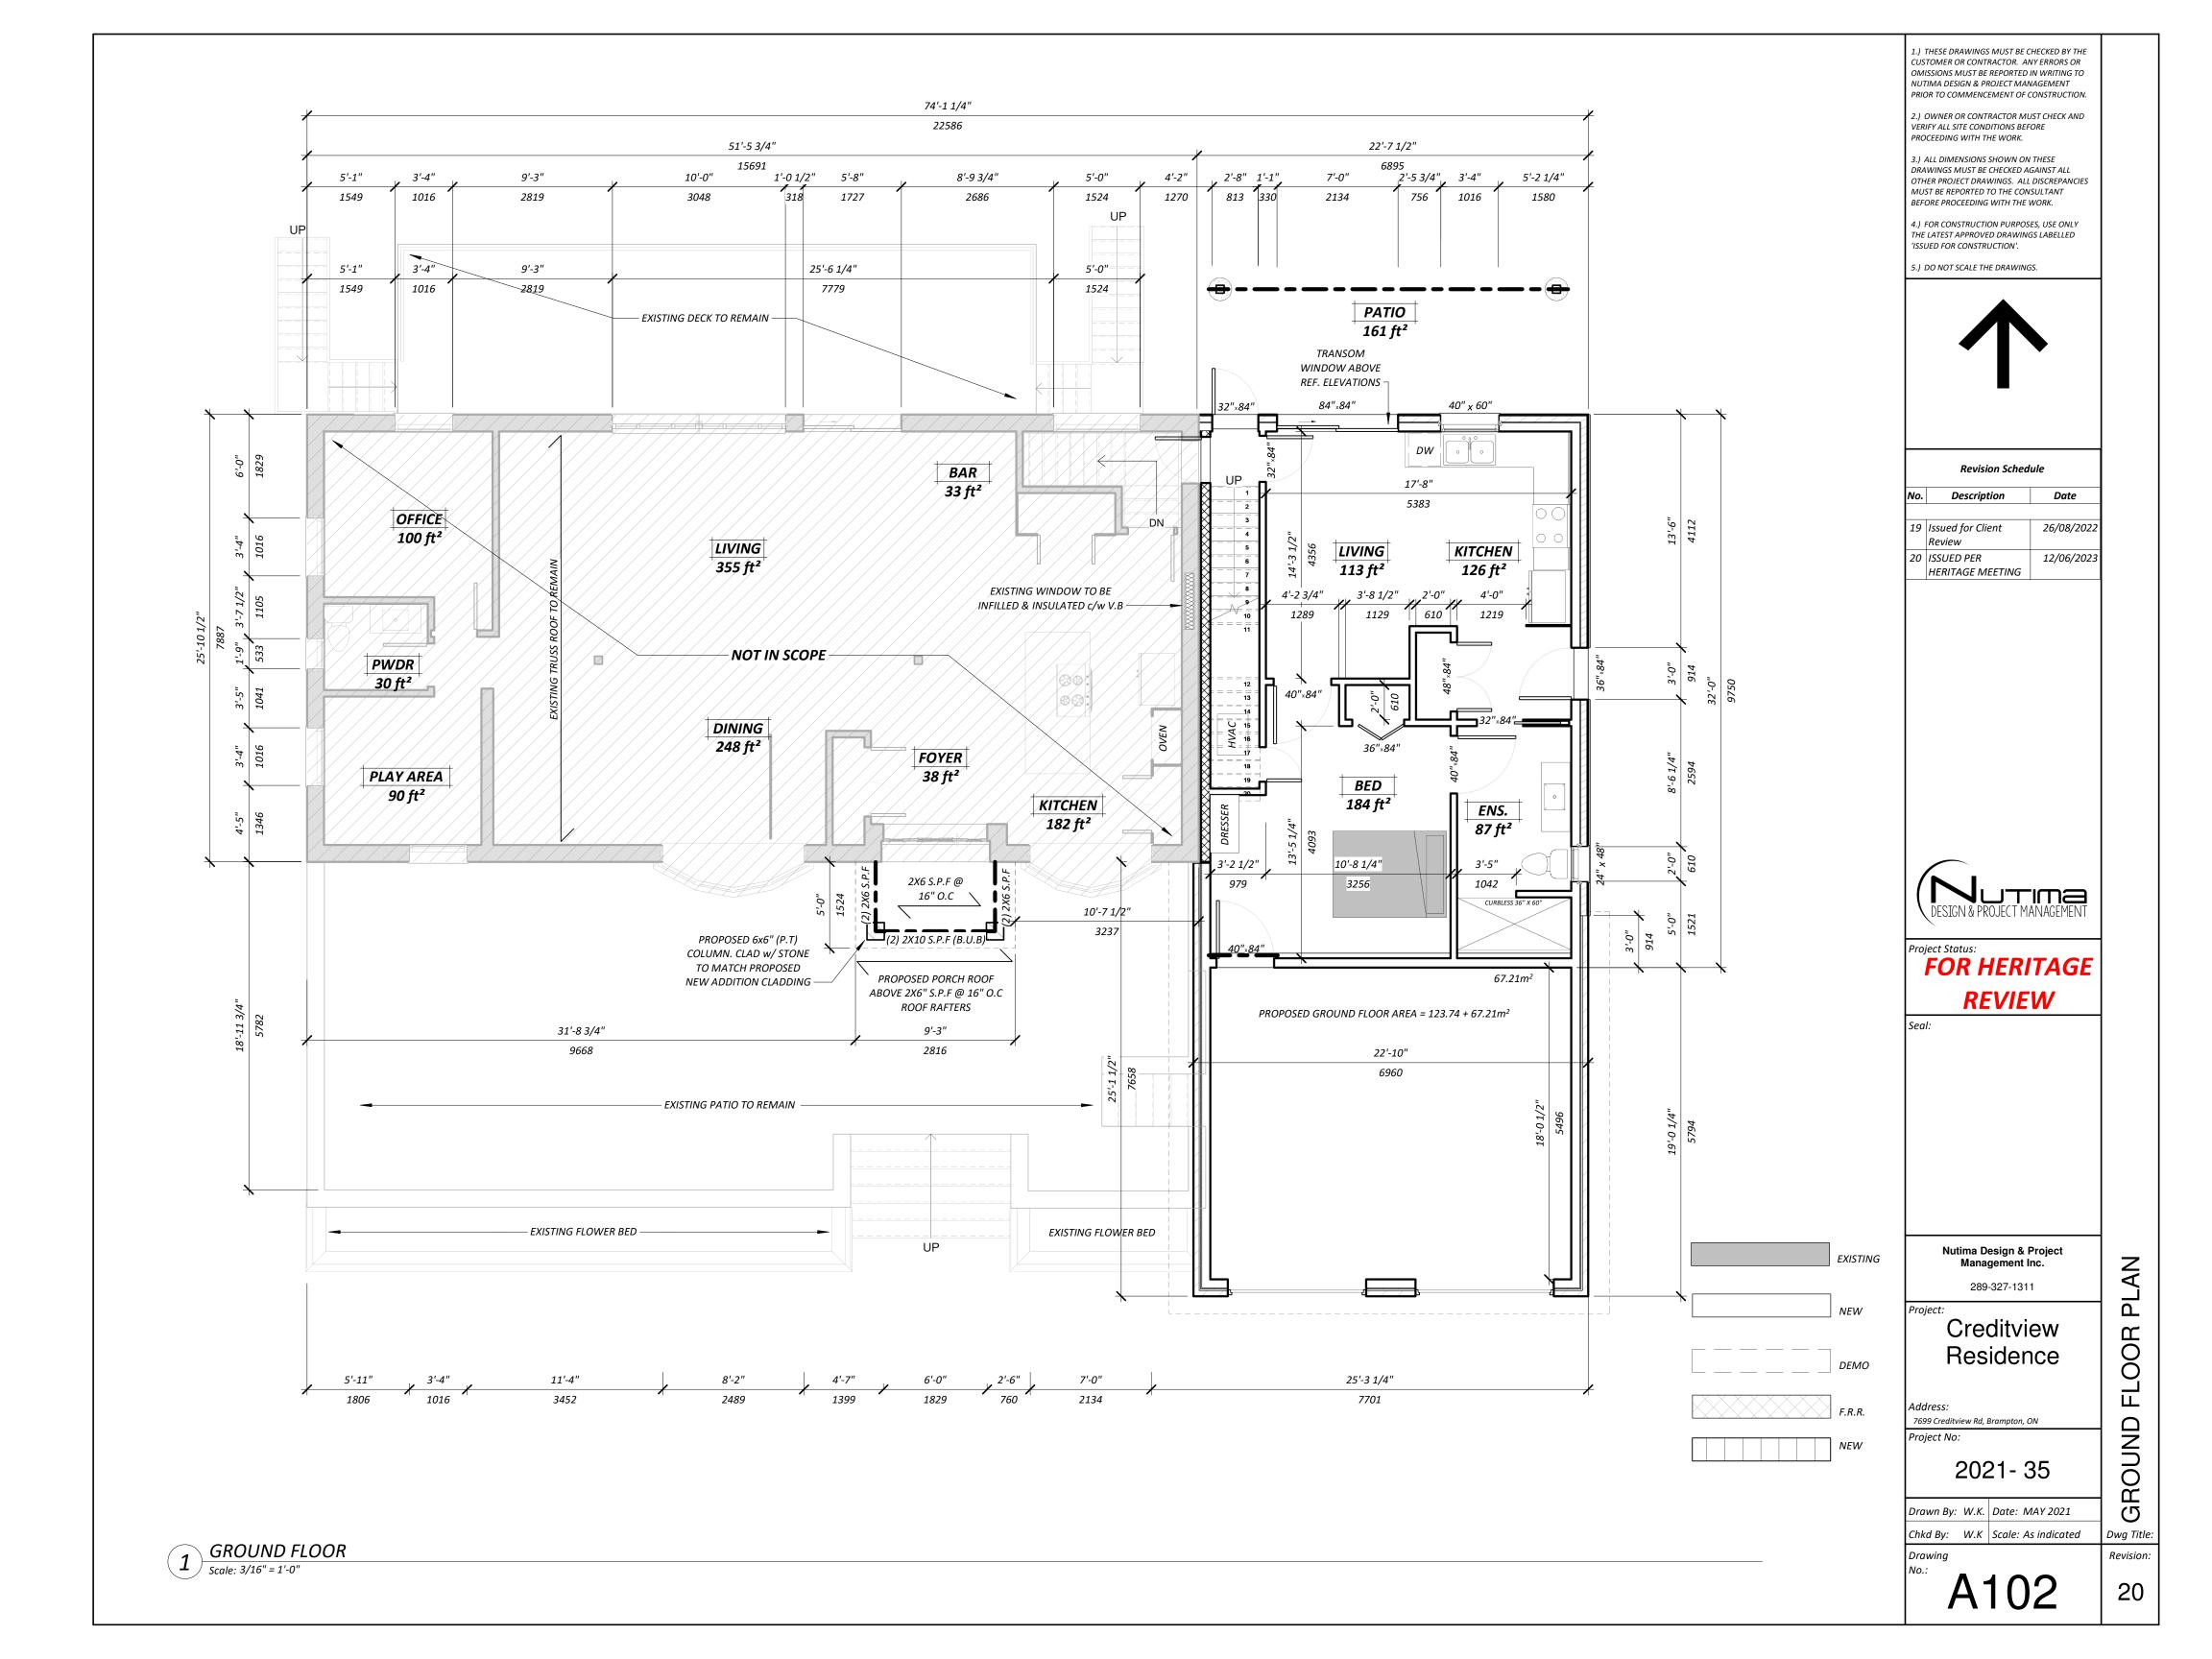

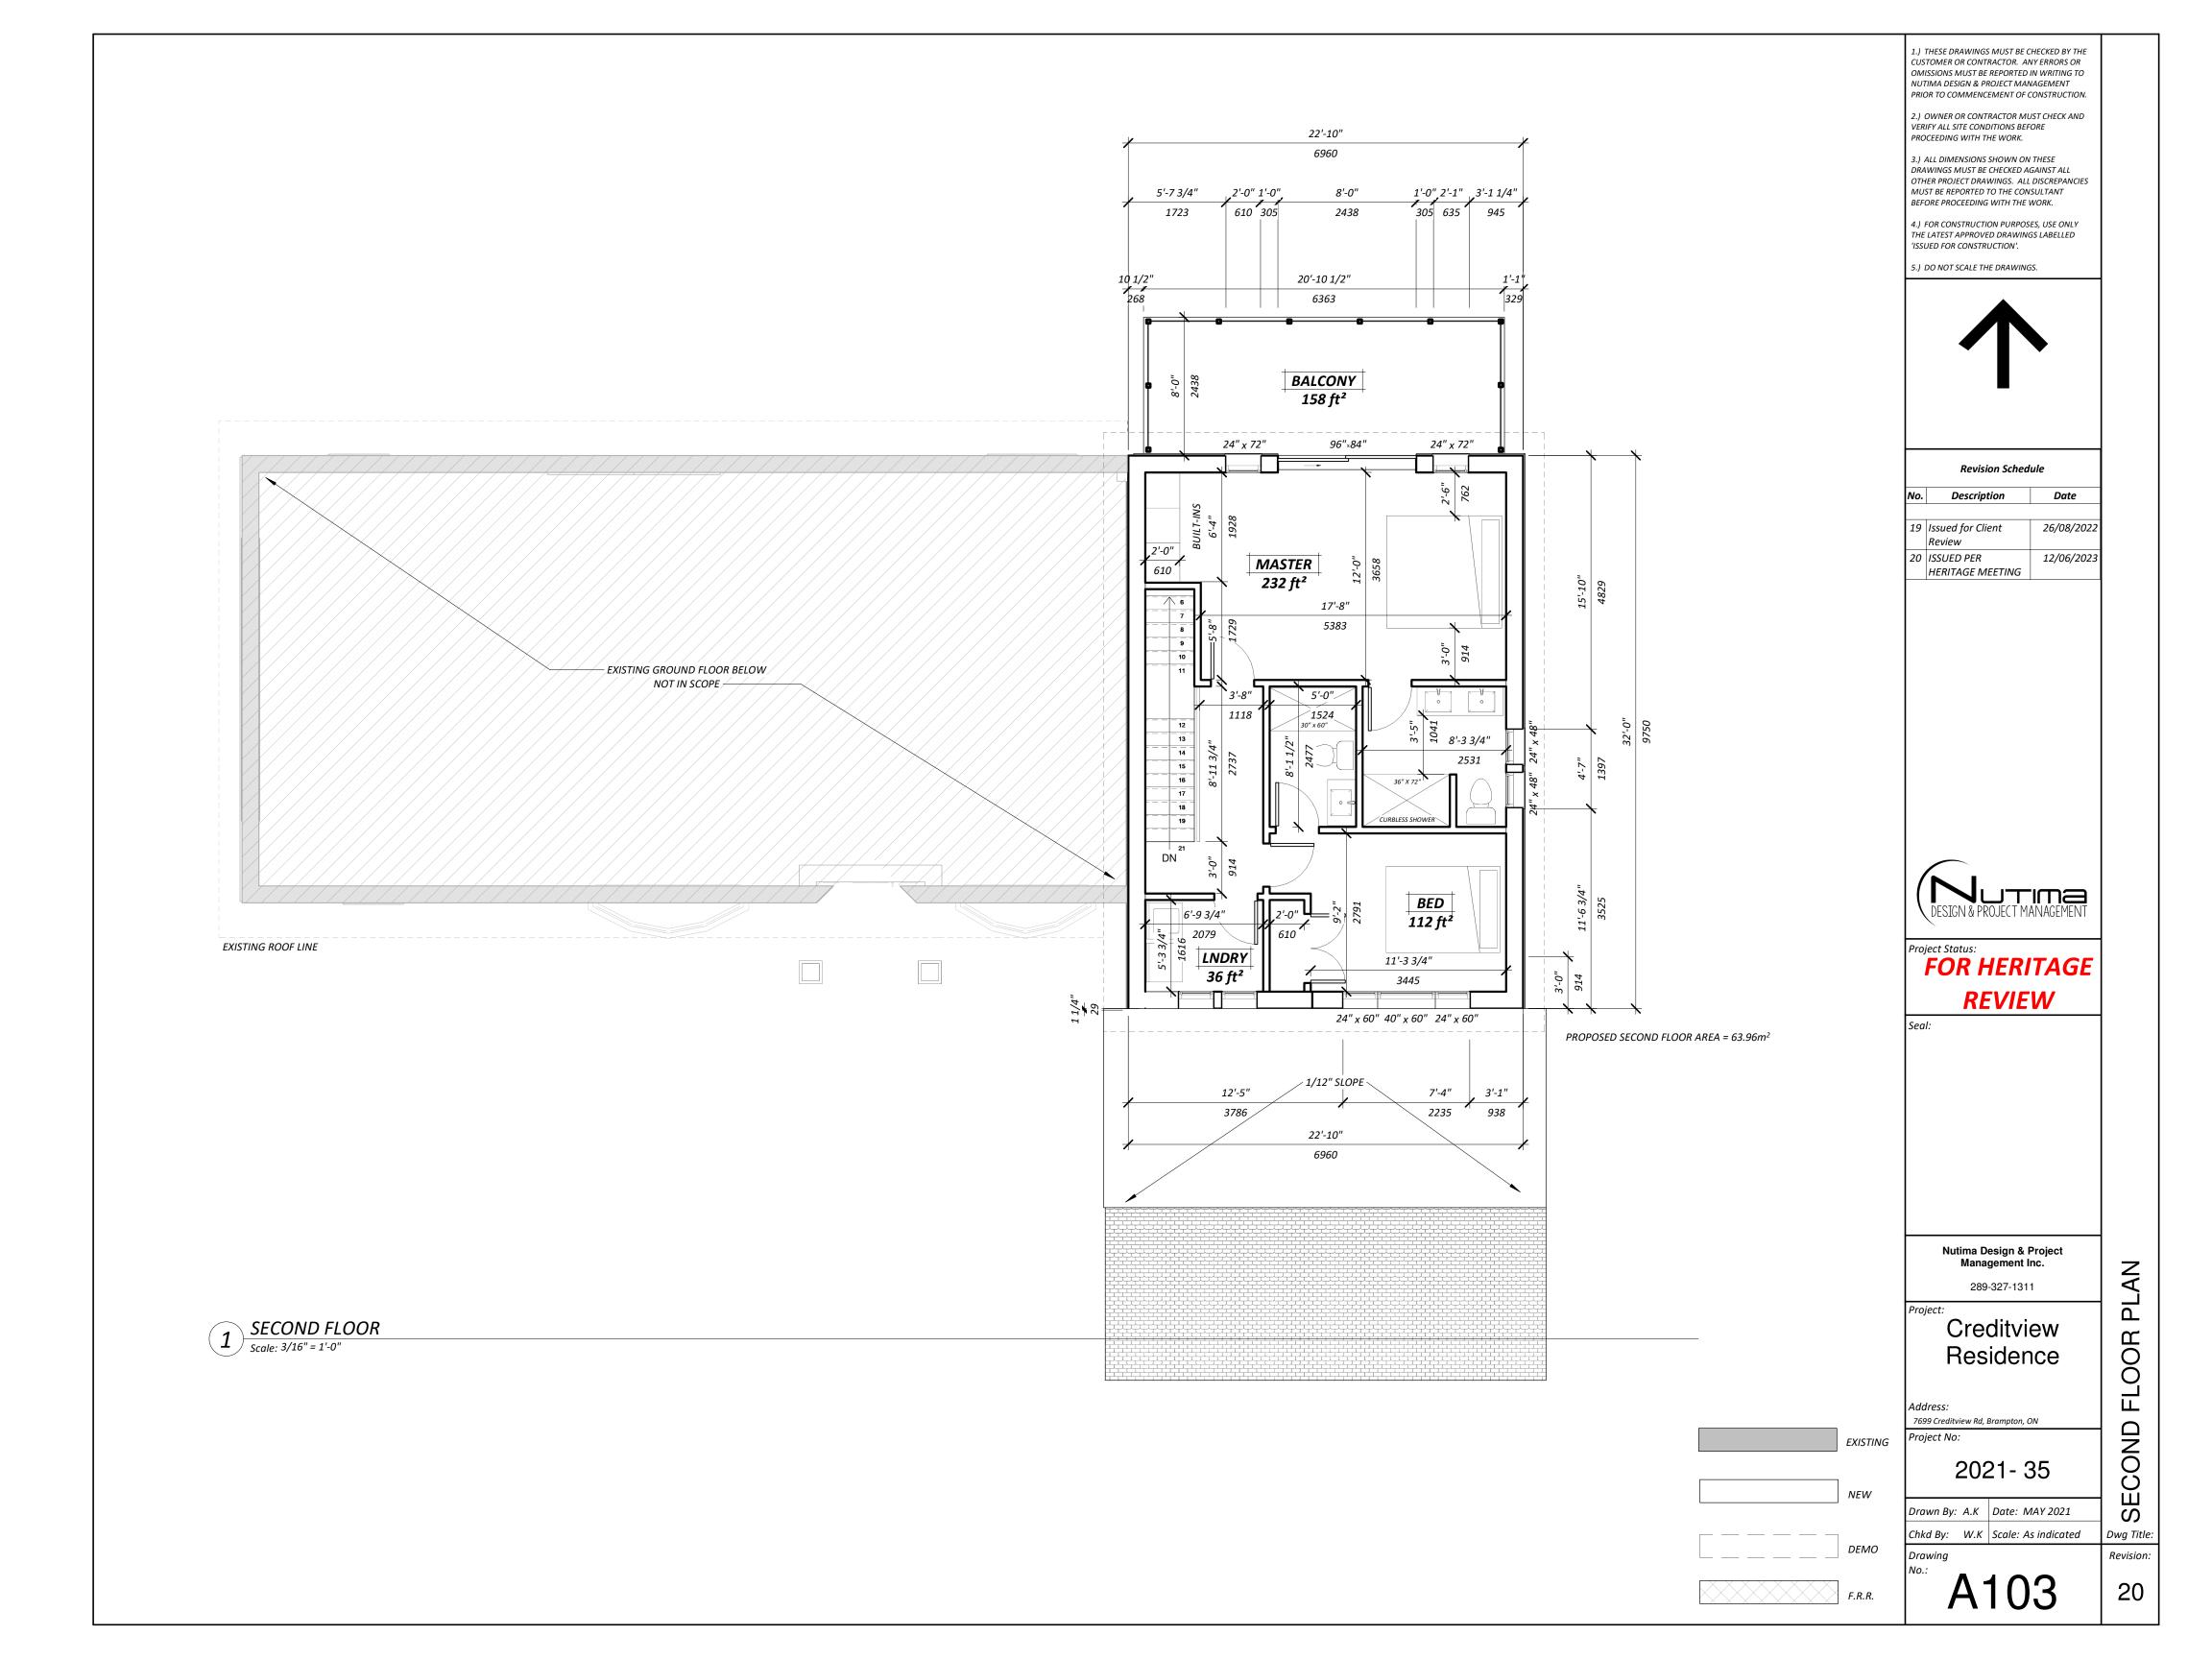

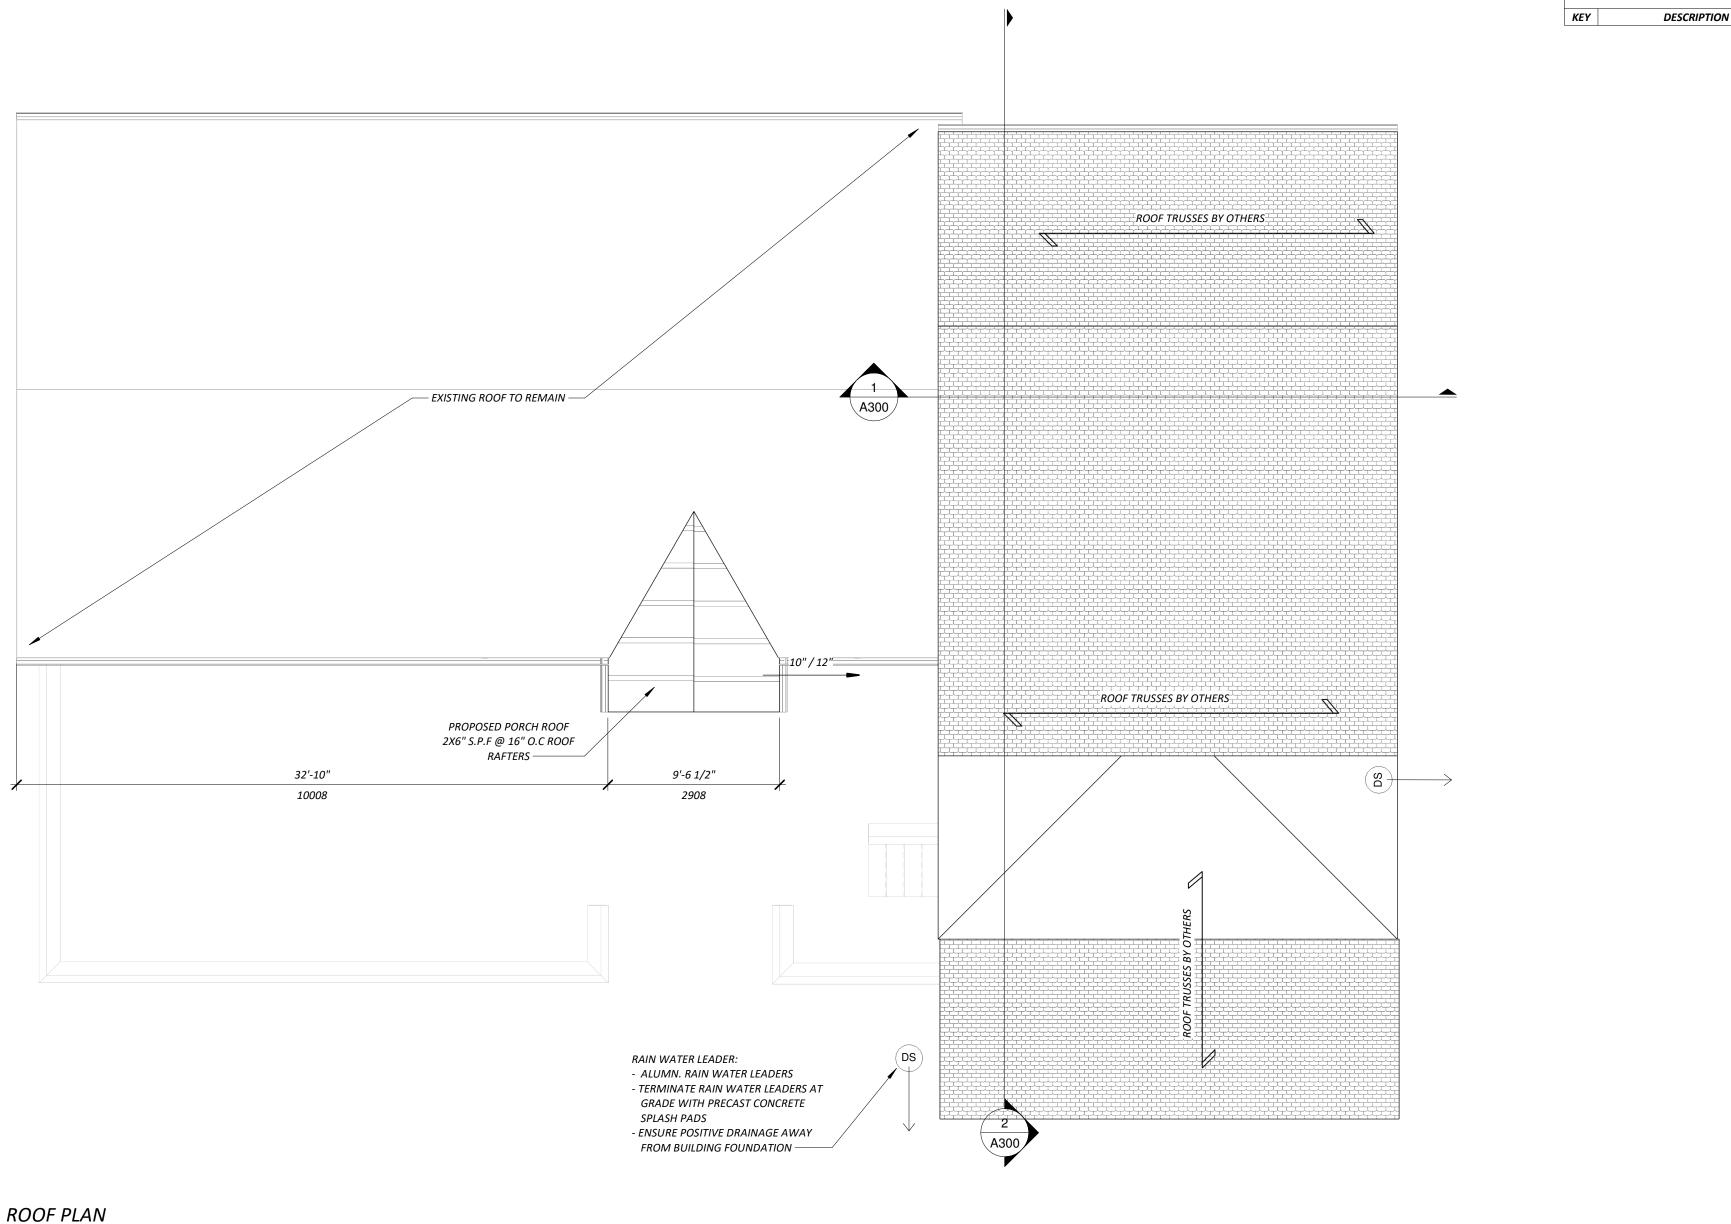

## **PRE - ENGINEERED ROOF TRUSS NOTES**

## 1.0 GENERAL

1.1 DESIGN TRUSSES IN ACCORDANCE WITH SECTION 4 OF THE CURRENT O.B.C. (INCLUDING UNBALANCED, SLIDING AND DRIFT SNOW LOADS,

AND LOADS IMPOSED BY DORMERS AND FRAME WORK SUPPORTED ON THE STRUCTURAL ROOF MEMBERS) AND CAN/CSA - 086.1. 1.2 TRUSS WEB SYSTEM TO SUIT MANUFACTURER WHO SHALL DETAIL AND PROVIDE ALL BRACING REQUIRED BY THE TRUSS DESIGN.

1.3 THE TRUSS SUPPLIER SHALL REFER TO MECHANICAL AND ELECTRICAL DRAWINGS FOR THE LOCATION AND WEIGHTS OF MECHANICAL UNITS IN THE CEILING SPACE OR ON THE ROOF.

1.4 TRUSSES SHALL BE DESIGNED BY A PROFESSIONAL ENGINEER OF THE PROVINCE OF ONTARIO WHO SHALL ASSUME FULL RESPONSIBILITY FOR THEIR STRENGTH AND SERVICEABILITY, INCLUDING ALL NECESSARY BRACING AND BRIDGING REQUIRED FOR THEIR STRUCTURAL INTEGRITY, SUBMIT SHOP DRAWINGS AND DESIGN CALCULATIONS BEARING HIS PROFESSIONAL STAMP.

## 2.0 EXECUTION

2.1 AS SHOWN ON PLANS THE GENERAL CONTRACTOR SHALL FURNISH AND INSTALL DIAGONAL, LONGITUDINAL AND/OR X BRACING TO THE ROOF SYSTEM AND WALLS TO PROVIDE LATERAL STABILITY TO THE STRUCTURE, UNLESS NOTED BRACING MEMBERS SHALL BE 38 X 89 CONNECTED TO WEBS, CHORDS AND WALL PLATES WITH A MINIMUM OF 2 - 90MM NAILS PER CONNECTION.

2.2 AT TRUSS BEARINGS PROVIDE GALVANIZED TRIP - L - GRIP CONNECTORS OR EQUAL EACH SIDE OF TRUSS NAILED TO TRUSS AND WALL PLATE.

2.3 INSTALL SHEATHING WITH LONG SIDE OF SHEETS PERPENDICULAR TO SPAN OF TRUSS AND NAIL AT 150 O.C. ALONG EDGES AND 200 O.C. AT INTERMEDIATE SUPPORTS.

2.4 THE GENERAL CONTRACTOR SHALL PROVIDE AND INSTALL ALL TEMPORARY BRACING REQUIRED TO MAINTAIN THE ROOF FRAMING AND WALLS STABLE UNTIL THE BUILDING IS COMPLETE.

2.5 THE GENERAL CONTRACTOR SHALL PROVIDE AND INSTALL ALL PERMANENT BRACING AND BRIDGING SPECIFIED AS PER MANUFACTURERS INSTRUCTIONS.

# **ROOF FRAMING PLAN NOTES:**

1. ALL ROOF TRUSSES @ 24" O/C. (UNLESS OTHERWISE NOTED) AND SLOPE AS PER PLANS.

2. PROVIDE SIMPSON STRONG TIE HANGERS OR APPROVED EQUAL.

3. PROVIDE MINIMUM 1 1/2" END BEARING OF ROOF JOISTS AND RAFTERS.

4. ALL ROOF FRAMING AND CEILING FRAMING TO BE IN ACCORDANCE WITH OBC 9.23.13 - ROOF AND CEILING FRAMING.

5. ROOF SHEATHING TO BE AS PER DETAILS NOTES. SHEATHING TO BE IN ACCORDANCE WITH OBC 9.23.15 ROOF SHEATHING

1.) THESE DRAWINGS MUST BE CHECKED BY THE **KEY NOTE LEGEND** CUSTOMER OR CONTRACTOR. ANY ERRORS OR OMISSIONS MUST BE REPORTED IN WRITING TO NUTIMA DESIGN & PROJECT MANAGEMENT


PRIOR TO COMMENCEMENT OF CONSTRUCTION. 2.) OWNER OR CONTRACTOR MUST CHECK AND

VERIFY ALL SITE CONDITIONS BEFORE PROCEEDING WITH THE WORK.

3.) ALL DIMENSIONS SHOWN ON THESE DRAWINGS MUST BE CHECKED AGAINST ALL OTHER PROJECT DRAWINGS. ALL DISCREPANCIES MUST BE REPORTED TO THE CONSULTANT BEFORE PROCEEDING WITH THE WORK.

4.) FOR CONSTRUCTION PURPOSES, USE ONLY THE LATEST APPROVED DRAWINGS LABELLED ISSUED FOR CONSTRUCTION'.

5.) DO NOT SCALE THE DRAWINGS.

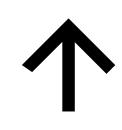

Revision Schedule				
No.	Description	Date		
7	Issued for Client Review	07/07/202		
8	Submitted to CVC	06/08/202		
9	Issued for HVAC	17/08/202		
10	Issued for Trusses/Floors	17/08/202		
11	Issued for Trusses/Floors	24/08/202		
12	Approved by CVC	14/09/202		
13	Issued for Structural Review	22/09/202		
14	FND REV.	30/09/202		
15	Issued for Permit	28/09/202		
16	Minor Variance Approved	07/12/202		
17	Issued for Heritage Review	08/07/202		
18	Revis. Per Heritage Review	03/04/202		



12/06/2023

20 ISSUED PER

HERITAGE MEETING

**FOR HERITAGE REVIEW** 

Nutima Design & Project Management Inc.

289-327-1311

Creditview

Residence

7699 Creditview Rd, Brampton, ON Project No:

Address:

Drawing

2021-35

Drawn By: W.K. Date: MAY 2021 Chkd By: W.K | Scale: As indicated


PLAN


ROOF

Dwg Title:

Revision:


20

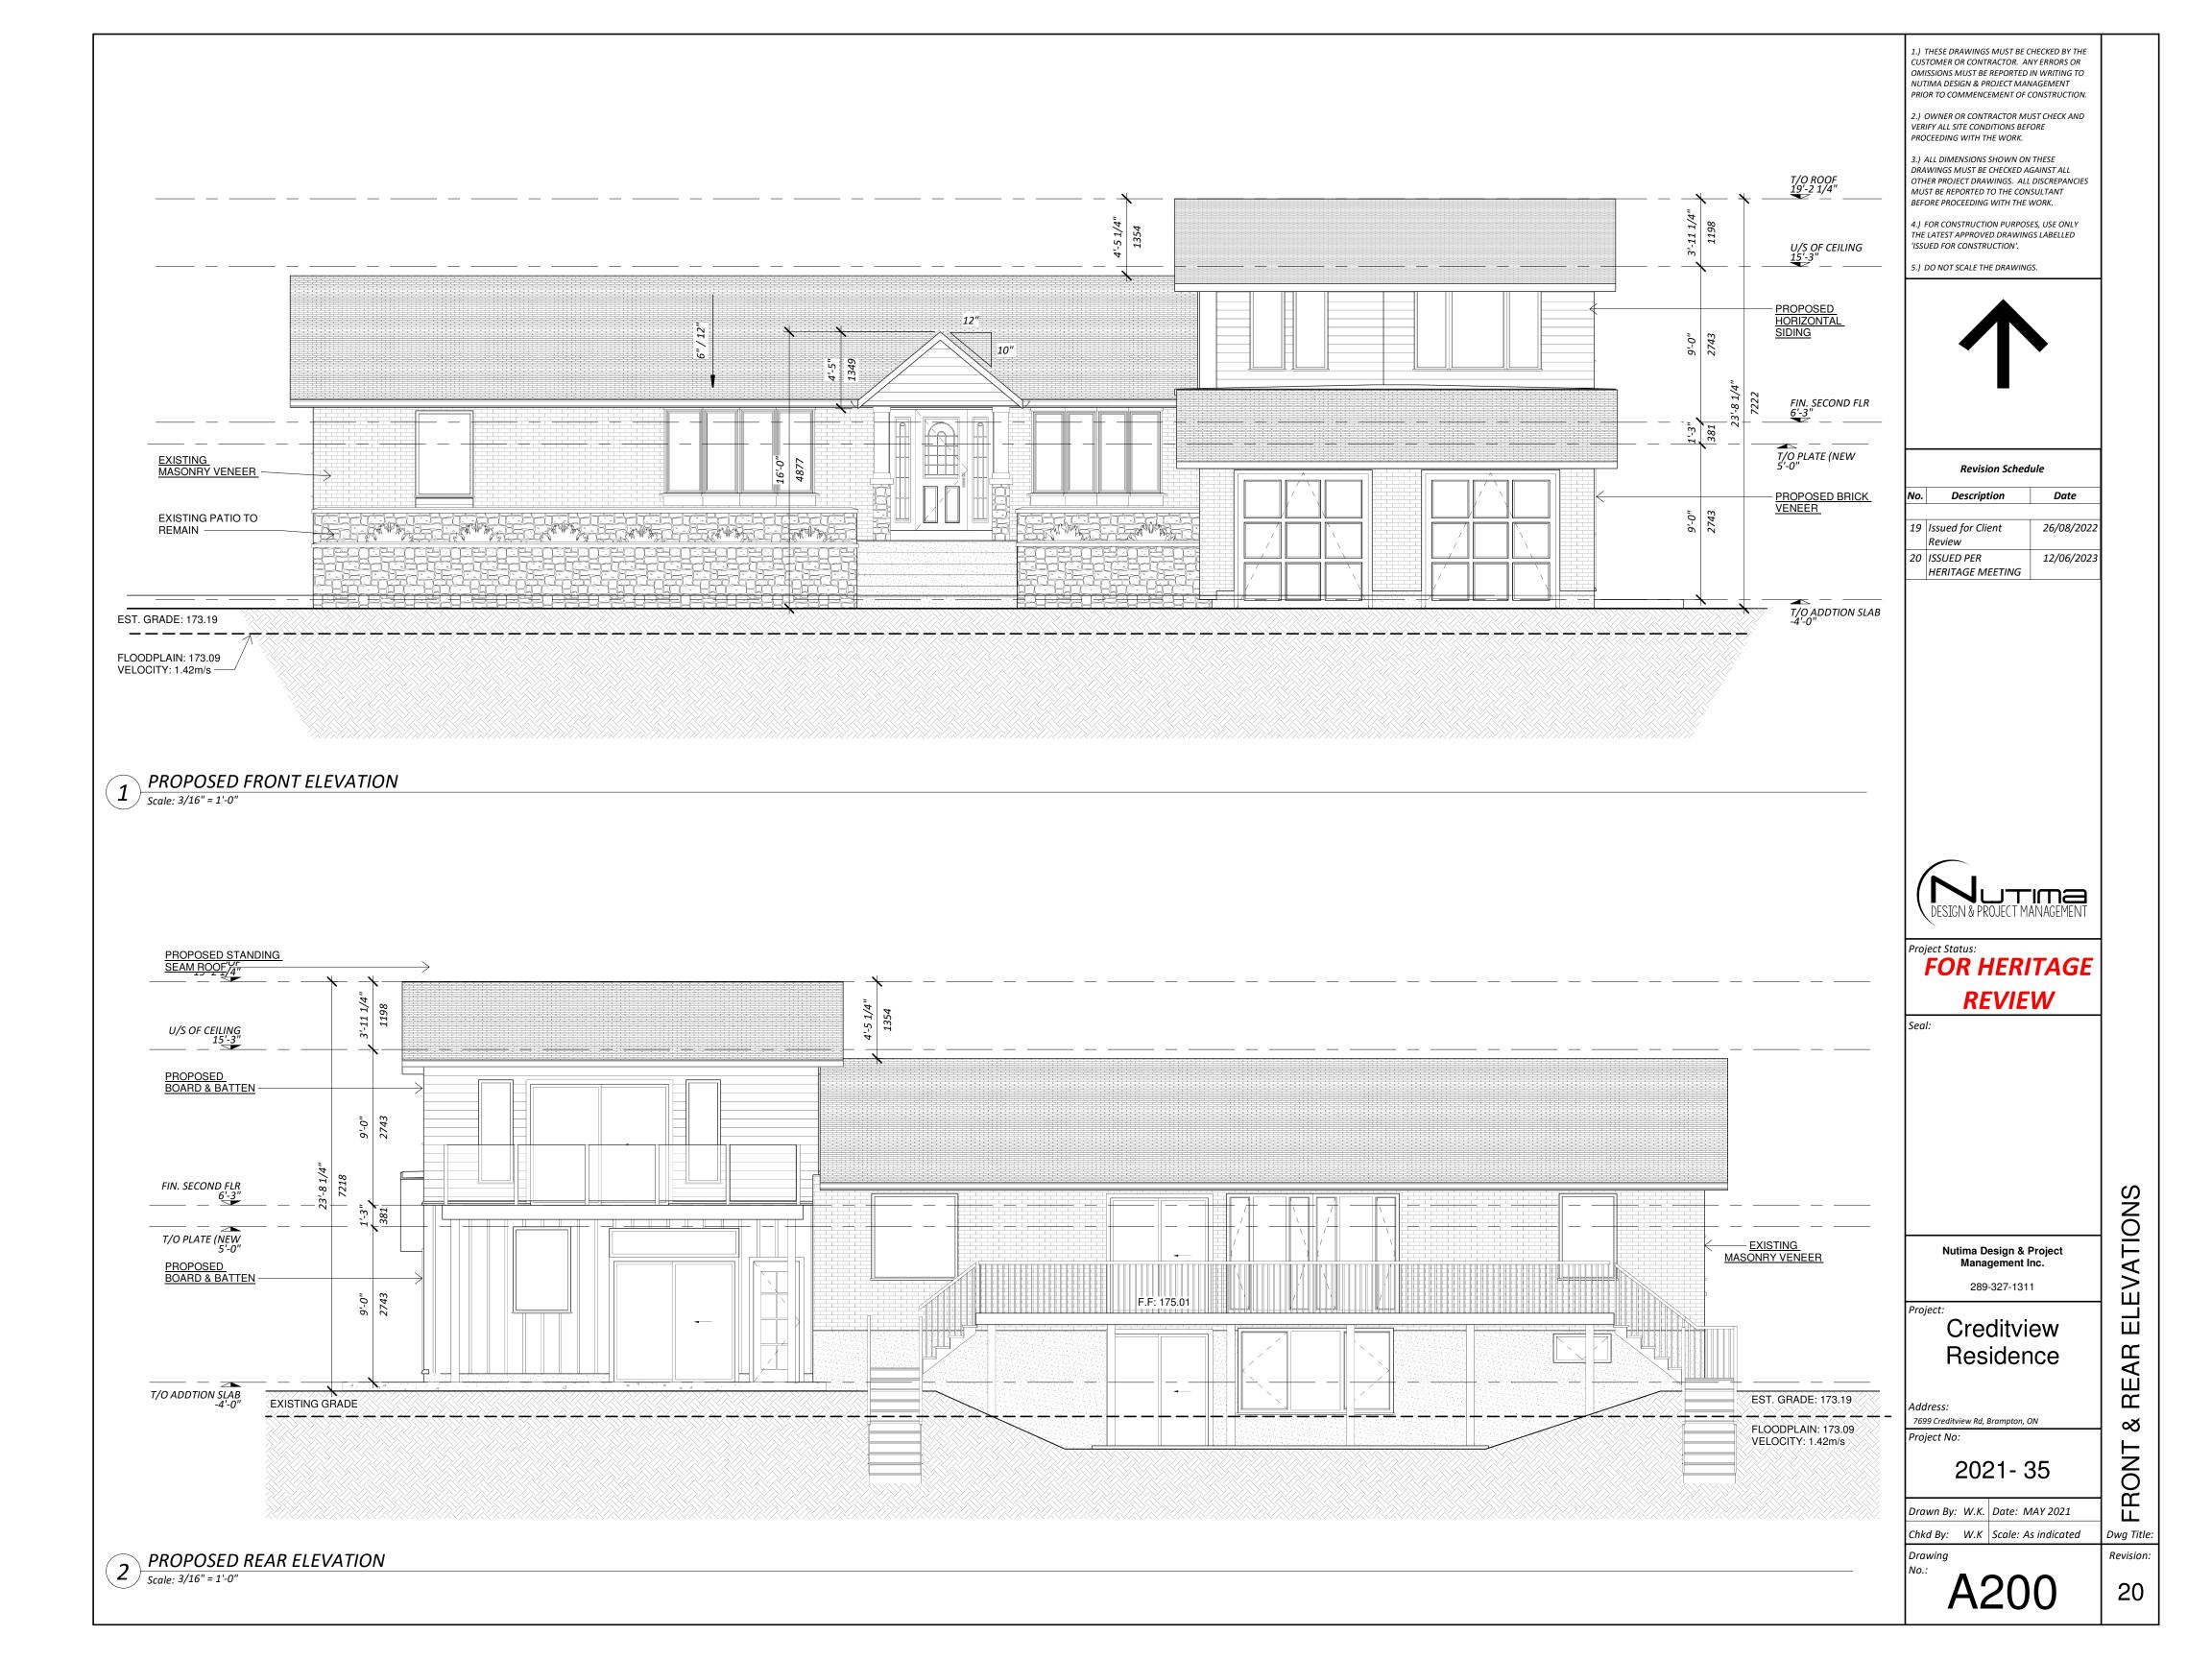

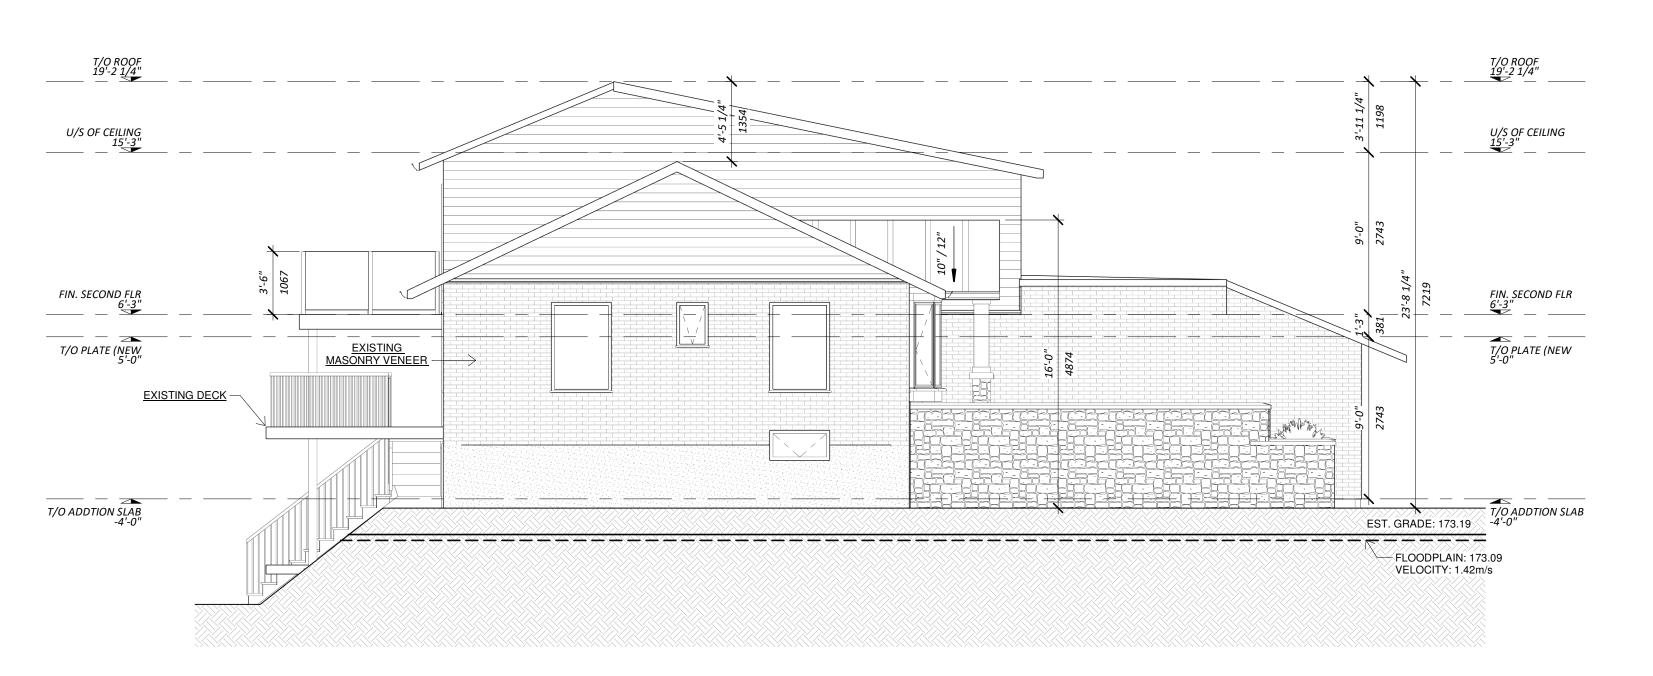

PROPOSED LEFT ELEVATION

Scale: 3/16" = 1'-0"

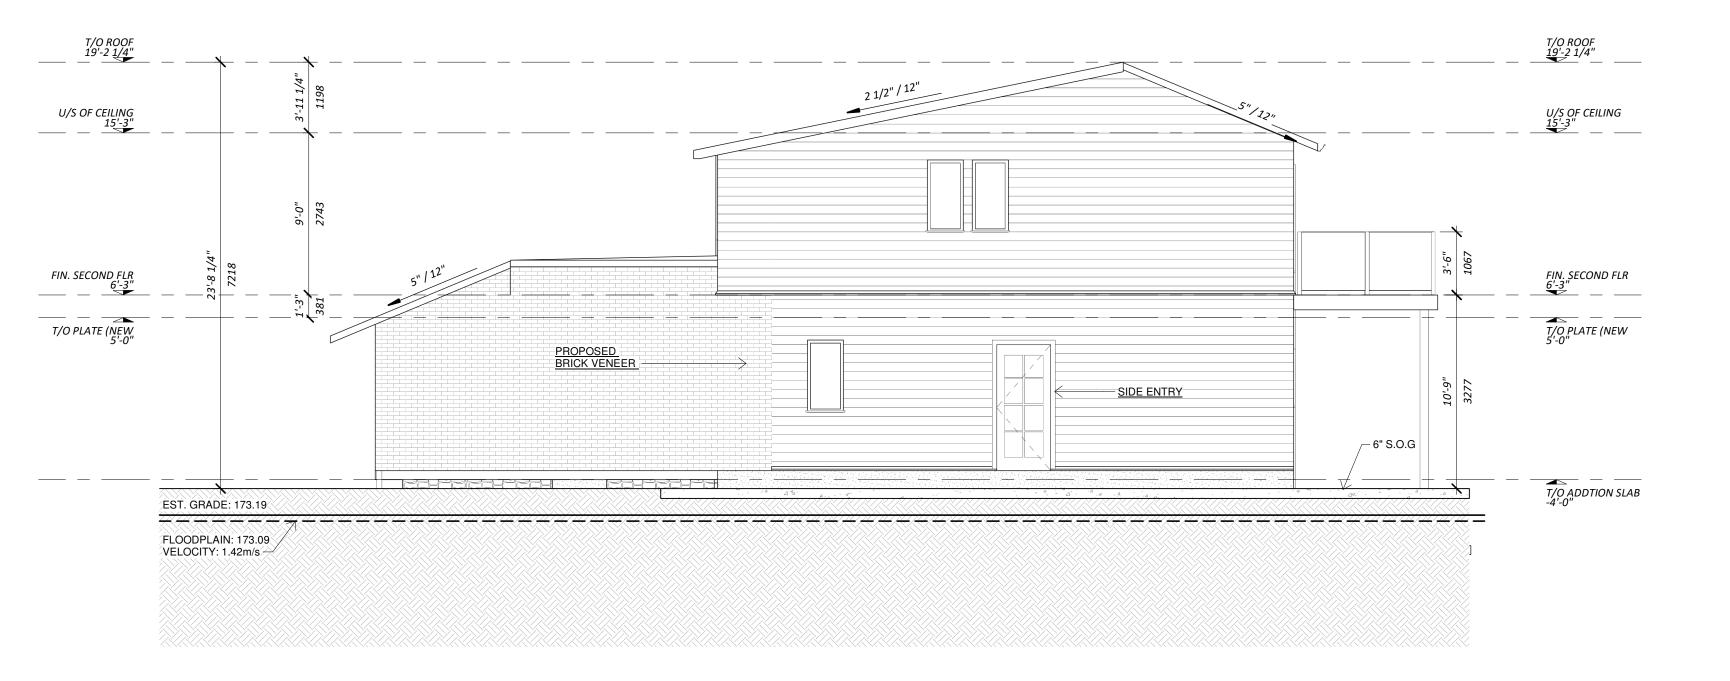


1.) THESE DRAWINGS MUST BE CHECKED BY THE CUSTOMER OR CONTRACTOR. ANY ERRORS OR OMISSIONS MUST BE REPORTED IN WRITING TO NUTIMA DESIGN & PROJECT MANAGEMENT PRIOR TO COMMENCEMENT OF CONSTRUCTION.

2.) OWNER OR CONTRACTOR MUST CHECK AND VERIFY ALL SITE CONDITIONS BEFORE PROCEEDING WITH THE WORK.

3.) ALL DIMENSIONS SHOWN ON THESE DRAWINGS MUST BE CHECKED AGAINST ALL OTHER PROJECT DRAWINGS. ALL DISCREPANCIES MUST BE REPORTED TO THE CONSULTANT BEFORE PROCEEDING WITH THE WORK.

4.) FOR CONSTRUCTION PURPOSES, USE ONLY THE LATEST APPROVED DRAWINGS LABELLED ISSUED FOR CONSTRUCTION'.

5.) DO NOT SCALE THE DRAWINGS.

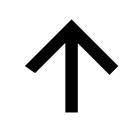

Revision Schedule					
No.	Description	Date			
19	Issued for Client Review	26/08/2022			
20	ISSUED PER HERITAGE MEETING	12/06/2023			



Project Status:
FOR HERITAGE **REVIEW** 

Nutima Design & Project Management Inc. 289-327-1311

Creditview Residence

Address: 7699 Creditview Rd, Brampton, ON Project No:

2021-35

Drawn By: W.K. Date: MAY 2021 Chkd By: W.K | Scale: 3/16" = 1'-0"

Revision: A201 20

RIGHT ELEVATIONS

∞

LEFT

Dwg Title:

PROPOSED RIGHT ELEVATION 2 PROPOSED | Scale: 3/16" = 1'-0"