Flower City





For Office Use Only (to be inserted by the Secretary-Treasurer after application is deemed complete)

FILE NUMBER:

A-2024-0041

The Personal Information collected on this form is collected pursuant to section 45 of the Planning Act and will be used in the processing of this application. Applicants are advised that the Committee of Adjustment is a public process and the information contained in the Committee of Adjustment files is considered public information and is available to anyone upon request and will be published on the City's website. Questions about the collection of personal information should be directed to the Secretary-Treasurer, Committee of Adjustment, City of Brampton.

		APPLICAT			
		Minor Variance or Spe	· · · · · · · · · · · · · · · · · · ·		
		(Please read Ins			
NOTE:	It is required that this application be filed with the Secretary-Treasurer of the Committee of Adjustment and be accompanied by the applicable fee.				
		ersigned hereby applies to the Committee of a ning Act, 1990, for relief as described in this a	Adjustment for the City of Brampton under section 45 of application from By-Law 270-2004 .		
1.	Name of	Owner(s) Kevin Michael & Christine Mic	hael		
		4 Alderway Avenue, Brampton, ON, L6Y	2B6		
	Phone #		Fax #		
	Email	kevin.michael.905@gmail.com			
2.	Name of Address	Agent Sarah Mahdi 135 Weir Chase, Misissauga, L5V 2W9, O	N		
	71441000				
	Phone #	647-281-9294	Fax #		
	Email	sarah@snsdesignandbuild.com			
3.	Nature a	nd extent of relief applied for (variances re	equested):		
			eet) on the flankage lot line, whereas the bylaw		
	_permits a	<u>a maximum driveway width of 6.71 metres (2</u>	22 feet) on the flankage lot line.		
	2. To per	rmit a proposed exterior stairway eading to a	a below grade entrance in the front yard, whereas		
			ucted below established grade in the front yard.		
	3. To per	rmit a front yard setback of 4.45m to a propo	osed exterior stairway leading to a below grade		
		e, whereas the by-law requires a minimum fr			
4.		not possible to comply with the provision			
	1. The lo	t has a width of 100ft which would ordinarily	permit a driveway of this size, however, the driveway is		
	on the fla	ankage lot line therefore it is restricted to 6.7	1 m.		
	2. The ex	xisting driveway has 4 parking spaces, howe	ever, 2 of those parking spaces are outside of the lot		

- boundaries and within the city's right of way. 3 parking spaces are required for a 3-unit dwelling.
- 5. Legal Description of the subject land:

Lot Number 152

Plan Number/Concession Number

646

Municipal Address 4 Alderway Ave. Brampton, ON L6Y 2B6

6. Dimension of subject land (in metric units)

Frontage 18.29
Depth 30.48

557.418 Area

7. Access to the subject land is by: **Provincial Highway Municipal Road Maintained All Year** Private Right-of-Way

Seasonal Road Other Public Road Water

Particulars of all buildings and structures on or proposed for the subject land: (specify in metric units ground floor area, gross floor area, number of

8.

storeys, width, length, height, etc., where possible) EXISTING BUILDINGS/STRUCTURES on the subject land: <u>List all structures (dwelling, shed, gazebo, etc.)</u> Ground floor area: 195.28 sq.m GFA: 195.28 1-storey dwelling Porch: 10.81 PROPOSED BUILDINGS/STRUCTURES on the subject land: 2-units in basement floor: total area 151.36 sq.m. GFA: 346.64 sq.m 9. Location of all buildings and structures on or proposed for the subject lands: (specify distance from side, rear and front lot lines in metric units) **EXISTING** Front yard setback 5.78 3.97 1.73 Rear yard setback Side yard setback Side yard setback 5.49 **PROPOSED** Front yard setback 5.78 3.97 1.73 Rear yard setback Side yard setback Side yard setback 5.49 January 31, 2024 10. Date of Acquisition of subject land: 11. Existing uses of subject property: Single family dwelling 12. Proposed uses of subject property: 3-unit dwelling 13. Existing uses of abutting properties: Single family dwelling 1963 Date of construction of all buildings & structures on subject land: 14. 60 years Length of time the existing uses of the subject property have been continued: 15. What water supply is existing/proposed? 16. (a) V Other (specify) Municipal Well (b) What sewage disposal is/will be provided? Other (specify) Municipal Septic (c) What storm drainage system is existing/proposed? Sewers Other (specify) Ditches **Swales**

17.		n or consent?	-	Ct Of all a	opiication ui	ider the	Planning Act,	тог аррі	IOVAI OI A	Jian oi
	Yes	No								
	lf answer i	s yes, provide	details:	File #			Sta	itus		
18.	Has a pre-	consultation a	applicatio	n been file	ed?					
	Yes	No								
19.	Has the su	ibject property	y ever be	en the sub	ject of an ap	plication	n for minor var	iance?		
	Yes	No			Unknown					
	If answer	is yes, provide	details:							
	File #	5	Decision							
	File # File #	:	Decision _ Decision _				Dollof			
							300			
					Sig	nature of	Applicant(s) or	Authoriz	zed Agent	
DATE	ED AT THE			OF			· · · · · · · · · · · · · · · · · · ·			
THIS	19	DAY OF Ja	nuary		, 20 <u>24</u> .					
							ERSON OTHE			
		CANTON AND RESIDENCE OF THE PROPERTY OF THE PR					T ACCOMPANE SIGNED BY			
CORPOR	ATION AND	THE CORPO	RATION'S	SEAL SH	ALL BE AFF	IXED.				
1					, OF TH	IE	OF	:		
IN THE	·				SOLEMNLY	DECLAR	RE THAT:	-		
							MN DECLARAT	דוטאו ככ	MECIENTI	OLIGI V
							RCE AND EFF			
DECLARE	ED BEFORE	ME AT THE								
	OF] 							
	_ 01									
IN THE			OF							
	_ THIS		DAY OF							
		_, 20			S	ignature o	of Applicant or	Authorize	ed Agent	
<u> </u>	A Commi	ssioner etc.								
				FOR OFF	ICE USE ON	ILY				
	Present C	official Plan De	esignatio	n:						
	Present Z	oning By-law	Classific	ation:						
	This app						required and the	e results	of the	
		s	aid reviev	w are outlin	ed on the att	ached ch	ecklist.			
		Zoning O	officer		_		Da	te		
		DATE D	ECEN/ED							
	Da	DATE RI te Application	ECEIVED Deemed					_	Revised 202	2/02/17
		ete by the Mu						- 1		

APPOINTMENT AND AUTHORIZATION OF AGENT

To: The Secretary-Treasurer
Committee of Adjustment
City of Brampton
2 Wellington Street West
Brampton, Ontario
L6Y 4R2

coa@brampton.ca

LOCATION OF THE SUBJECT LAND: 4 Alderway Ave.
I/We, Kevin Michael & Christine Michael
please print/type the full name of the owner(s)
the undersigned, being the registered owner(s) of the subject lands, hereby authorize
Sarah Mahdi
please print/type the full name of the agent(s)
to make application to the City of Brampton Committee of Adjustment in the matter of an application for minor variance with respect to the subject land.
Dated this 19 day of January , 2024.
fle book
(signature of the owner[s], or where the owner is a firm or corporation, the signature of an officer of the owner.)
(where the owner is a firm or corporation, please print or type the full name of the person signing.)

NOTE: If the owner is a firm or corporation, the corporate seal shall be affixed hereto.

NOTE: Unit owners within a Peel Standard Condominium Corporation are to secure authorization from the Directors of the Condominium Corporation in a form satisfactory to the City of Brampton, prior to submission of an application. Signatures from all Members of the Board of Directors are required.

PERMISSION TO ENTER

To: The Secretary-Treasurer
Committee of Adjustment
City of Brampton
2 Wellington Street West
Brampton, Ontario
L6Y 4R2
coa@brampton.ca

LOCATIO	N OF TH	E SUBJEC	T LAND: 4 Alderway	Av.	
I/We,	Kevin Mic	hael & Chris	stine Michael	,	54
			please print/type	e the full name o	the owner(s)
the City of	of Brampt	on Comm	ittee of Adjustment a	and City of Bra	and, hereby authorize the Members of ampton staff members, to enter upon
			the purpose of cond e and/or consent.	ucting a site i	nspection with respect to the attached
Dated thi	s 1	day of	February		, 20 <u>24</u> .
(signa	ature of the	owner[s], or	where the owner is a firm	n or corporation,	the signature of an officer of the owner.)
					-1
	(where the	owner is a	firm or corporation, pleas	e print or type th	e full name of the person signing.)

NOTE: If the owner is a firm or corporation, the corporate seal shall be affixed hereto.

NO DISCUSSION SHALL TAKE PLACE BETWEEN THE COMMITTEE MEMBERS AND THE APPLICANT DURING THE SITE INSPECTION

GENERAL TAGS (UNLESS OTHERWISE NOTED)

ALL CONSTRUCTION TO ADHERE TO THESE PLANS AND SPEC'S AND TO CONFORM TO THE ONTARIO BUILDING CODE AND ALL OTHER APPLICABLE CODES AND AUTHORITIES HAVING JURISDICTION. THESE REQUIREMENTS ARE TO BE TAKEN AS MINIMUM SPECIFICATIONS.

ROOF CONSTRUCTION

ROOF FINISH, ON
2-PLY ROOF MEMBRANE,
3/4" EXT. PLYWOOD SHEATHING WITH "H"
CLIPS. APPROVED JOISTS AS PER PLANS. APPROVED
EAVES PROTECTION TO EXTEND 900 mm (3"-0") FROM
EDGE OF ROOF AND MIN. 300 mm (12") BEYOND INNER
FACE OF EXTERIOR WALL. PREFIN. ALUM.
EAVESTROUGH, FASCIA, RWL.

- RSI 10.57 (R60) ROOF INSULATION AND APPROVED VAPOUR BARRIER, 16mm (5/8") INT. DRYWALL FINISH OR APPROVED EQUAL. (R31) ROOF INSULATION IF NO ATTIC SPACE.
- FOUNDATION WALL/ FOOTINGS: -SEE OBC 9.15.4-

POURED CONC, FDTN, WALL WITH BITUMINOUS DAMPROOFING WITH DRAINAGE LAYER, PROVIDE PARGING COVER ON (22'X8") CONTIN.
KEYED CONC, FTG, REINFORCED WITH 2-15M CONT.
PROVIDE DOWLES INTO FTG TO MATCH VERTICAL STEEL IN WALLS AND COLUMNS EXCEPT WHEN NOTED OTHERWISE. BRACE FOUNDATION WALL.
PRIOR TO BACKFILLING. ALL FOOTINGS SHALL REST ON NATURAL UNDISTURBED SOIL OR COMPACTED ENGINEERED FILL, WITH MINIMUM BEARING CAPACITY OF 150kPa SERVICIBILITY LIMIT STATES (SLS) OR GREATER AND 200kPa ULTIMATE LIMIT STATES (ULS).

- 100mm (4") DIA. WEEPING TILE 150mm (6")
 CRUSHED STONE OVER AND AROUND WEEPING
- BASEMENT SLAB

80mm (3") MIN. 25MPa (3600psi) CONC. SLAB ON 100mm (4") COARSE GRANULAR FILL, OR 15MPa (2200psi) CONC. WITH DAMPROOFING BELOW SLAB.

- 39X140 (2"X6") SILL PLATE WITH 13mm (1/2")
 DIA. ANCHOR BOLTS 200mm (8") LONG,
 EMBEDDED MIN. 100mm (4") INTO CONC. @
 1200mm (4"-0") O.C., CAULKING OR 25mm (1")
 MIN. MINERAL WOOL BETWEEN PLATE AND TOP
 FOTN. WALL, USE NON-SHRINK GROUT TO LEVEL
 SILL PLATE WHEN REQUIRED.
- BEARING STUD PARTITION

38X150 (2"X6") STUDS @ 400mm (16") O.C.
38X150 (2"X6") STUDS @ 400mm (16") O.C.
38X150 (2"X6") STUD N.ANCHOR BOLTS
200mm (8") LONG, EMBEDDED MIN. 100mm
(4") INTO CONC. @ 1200mm (4"0") O.C.
100mm (4") HIGH CONC. CURB ON 350X155
(14"X6") CONC. FOOTING. ADD HORIZ. BLOCKING
AT MID-HEIGHT IF WALL IS UNFINISHED.

8 INTERIOR STUD PARTITIONS

BEARING PARTITIONS 38X89 (2"X4") @ 400mm (16") O.C. FOR 2 STOREYS AND 300mm (12") O.C. FOR 2 STOREYS AND 300mm (12") O.G. FOR 3 STOREYS. NON-BEARING PARTITIONS 38X89 (2"X4") @ 600mm (24") O.C. PROVIDE 38X89 (2"X4") BOTTOM PLATE AND 2 (38X89 (2-2"X4") TOP PLATE. 13mm (1/2") INTERIOR DRYWALL BOTH SIDES OF STUD, PROVIDE 38/140 (2"X4" OR 2"X6") STUDS/PLATES WHERE NOTED.

EXPOSED FLOOR TO EXTERIOR

PROVIDE (R31) INSULATION, APPROVED
VAPOUR BARRIER AND CONTINUOUS AIR BARRIER,
FINISHED SOFFIT.

10 STEEL COLUMN (SEE O.B.C 9.15.3.3)

HSS 4"X4"X1/4" ST. COL. C/W 6"X6"X1/2" PL. TOP WELD TO BEAM & 6"X8"X1/2" BASE PL. C/W 2 - 1/2" DIA. 12" LONG 2" HOOK ANCHORS SET INTO CONC. FIELD WELD COL. TO BASE PL.

STEEL BASEMENT COLUMN (SEE O.B.C. 9.15.3.3)

90mm (3-1/2") DIA x 4.78mm (.188") FIXED OR ADJUSTABLE STL. COL. W/MAX ALLOWABLE LOAD OF 108.6kN (24,000LBS) W/ 150X150X9.5 (6"X6"3/8") STL. TOP & BOTTOM PLATE ON 1070X1070X460 (42"X42"X18") CONC. FOOTING ON UNDISTURBED SOIL OR ENG. FILL CAPABLE OF SUSTAINING A PRESSURE OF 125 kPa. MIN. AND AS PER SOILS REPORT.

STEEL COLUMN

90mm (3-1/2") DIA x 4.78mm (.188) NON-ADJUSTABLE STL. COLUMN WITH 150X150X9.5 (6"X6")*3" STEEL TOP PLATE. BASE PLATE 120X250X12.5 (4 1/2"X10"X1/2") WITH 2-12mm DIA. x 300mm LONG x 50mm HOOK ANCHORS (2-1/2"X12"X2") FIELD WELD COLUMN TO BASE PLATE.

- BEAM POCKET OR 200X200 (8"X8") POURED CONCRETE NIB WALLS.
 MINIMUM BEARING 90mm (3-1/2").
- STEEL BEARING PLATE FOR MASONRY WALLS

280X280X16 (11"X11"X 5/8") STL. PLATE FOR STL. BEAMS AND 280X280X12 (11"X1"X1"X12") STL. PLATE FOR WOOD BEAMS BEARING ON CONC. BLK. PARTYWALL, ANCHORED W/ 2-19mm (3/4") X200mm (8") LONG GALV. ANCHORS WITHIN SOLID BLOCK COURSE. LEVEL WITH NON-SHRINK GROUT.

SOLID WOOD BEARING FOR WOOD STUD WALLS

SOLID BEARING TO BE AT LEAST AS WIDE AS THE SUPPORTED MEMBER. SOLID WOOD BEARING COMPRISED OF BUILT-UP WOOD STUDS TO BE CONSTRUCTED IN ACCORDANCE WITH OBC. 9.17-4.2 (2).

- 3-38X89 (3-2"X4") BUILT-UP-POST ON METAL BASE SHOE ANCHORED TO CONC. WITH 12.7 (1/2") DIA. BOLT, 610X610X300 (24"X24"X12") CONCRETE FOOTING.
- (2-10"), MAX. VERT. STEP = 864mm (2-10"), MAX. VERT. STEP = 600mm (23 5/8") FOR FOR SAND AND GRAVEL.
- COLD CELLAR PORCH SLAB

6" 32MPa CONC. SLAB WITH 5-8% AIR ENTRAINMENT. WITH REINF. BARS AS NOTED. SLOPE SLAB MIN. 1.0% FROM DOOR.

- THE FDTN. WALL SHALL NOT BE REDUCED TO LESS THAN 90mm (3-1/2") THICK TO A MAX. DEPTH OF 600mm (24") AND SHALL BE TIED TO THE FACING MATERIAL WITH METAL TIES SPACED 200mm (8) O.C. VERTICALLY AND 900mm (36") O.C. HORIZONTALLY. FILL SPACE BETWEEN WALL AND FACING SOLID WITH MORTAR.
- GARAGE SLAB: 100mm (4") 32 MPa (4640psi)
 CONC. SLAB WITH 5-8% AIR ENTRAINMENT ON
 MIN. 100 (4") COARSE GRANULAR FILL WITH
 COMPACTED SUB-BASE OR COMPACTED NATIVE
 FILL SLOPE TO FRONT AT 1" 48M IS
- 20 13mm (1/2") GYPSUM BD. ON WALL AND CEILING BETWEEN HOUSE AND GARAGE, (R22) IN WALLS, (R31) IN CEILING. TAPE AND SEAL ALL JOINTS GAS TIGHT.
- DOOR AND FRAME GASPROOFED. DOOR EQUIPPED WITH SELF CLOSING DEVICE AND WEATHERSTRIPPING

22) FIREPLACE CHIMNEYS - OBC. 9.21.(3-0") ABOVE THE HIGHEST POINT AT WHICH IT COMES IN CONTACT WITH THE ROOF AND 610mm (2-0") ABOVE THE HIGHEST POINT AT WHICH IT COMES IN CONTACT WITH THE ROOF WITHIN A HORIZ. DISTANCE OF 3050mm (10-0") FROM THE CHIMNEY.

- MECHANICAL EXHAUST FAN, VENTED TO EXTERIOR, TO PROVIDE AT LEAST ONE AIR CHANGE PER HOUR.
- 24 U.L.C. RATED CLASS "B" VENT 610mm (2'-0")
 ABOVE THE POINT IN CONTACT WITH THE
 ROOF FOR SLOPES UP TO 9/12.
 REFER TO THE ONTARIO GAS UTILIZATION CODE.
- CAPPED DRYER EXHAUST VENTED TO EXTERIOR CW INSECT SCREEN.
- ATTIC ACCESS HATCH MIN. 545X700 (22"X28") WITH WEATHERSTRIPPING. RSI 5.4 (R40) RIGID INSLII ATION BACKING.
- 27 DIRECT VENT FURNACE TERMINAL MIN. 900mm (38°) FROM A GAS REGULATOR. MIN. 300mm (12°) ABOVE FIN. GRADE, FROM ALL OPENINGS, EXHAUST & INTAKE VENTS. HRV INTAKE TO BE A MIN. OF 1830mm (6°-0") FROM ALL EXHAUST TERMINALS. REFER TO GAS UTILIZATION CODE.
- 28 DIRECT VENT GAS FIREPLACE. VENT TO BE A MINIMUM 300mm (12") FROM ANY OPENING AND ABOVE FIN. GRADE. REFER TO GAS UTILIZATION CODE.

$\langle 29 \rangle$ ALL STAIRS/EXTERIOR STAIRS -OBC. 9.8.-

MAX. RISE = 200 (7-7/8")
MIN. RISE = 125 (4-7/8")
MIN. RUN
MAX. NOSING = 255 (1")
MIN. HEADROOM = 1950 (6-5")
RAIL @ LANDING
RAIL @ STAIR
MIN. STAIR WIDTH = 865 (2-10")

FOR CURVED STAIRS
MIN. RUN NARROW END = 150 (6")
MIN. RUN = 200 (8")

- 30) FINISHED RAILING ON PICKETS SPACED MAXIMUM 100mm (4") BETWEEN PICKETS. GUARDS 096. 9.8.8.2.INTERIOR GUARD: 900mm (2'-11") MIN. EXTERIOR GUARDS: 1070mm (3'-6") MIN.
- (31) RESIDENTIAL GUARD DESIGN LOADS SINGLE FAMILY DWELLING 9.8.7.7.(1)(a)

a) a concetrated load at any point of not less than 0.9KN (202lbs). b) for handrails other than those serving a single dwelling unit, a uniformly distributed load of 0.7KN/m (48lbs/ ft)

- 32 SUBFLOOR, JOIST STRAPPING AND BRIDGING
 - -16mm (5/8") T & G SUBFLOOR ON WOOD FLOOR JOISTS. FOR CERAMIC TILE APPLICATION (*SEE OBC 9.30.6.*)
 6mm (1/4") PANEL TYPE UNDERLAY UNDER RESILIENT & PARQUET FLOORING.
 (*SEE OBC 9.23.9.4")
 ALL JOISTS TO BE BRIDGED WITH 38X38 (2"X2")
 CROSS BRACING OR SOLID BLOCKING @ 2100mm (6"1") O.C. MAX. ALL JOISTS TO BE STRAPPED WITH 19X84 ("TX3") @ 2100mm (6"1") O.C. UNLESS A PANEL TYPE CEILING FINISH IS APPLIED.
- EXPOSED BUILDING FACE -OBC, 9.10.14.11EXTERIOR WALLS TO HAVE A FIRE RESISTANCE
 RATING OF NOT LESS THAN 45 mins. WHERE
 LIMITING DISTANCE IS LESS THAN 1.2M (3'-11').
 WHERE THE LIMITING DISTANCE IS LESS THAN
 600mm (1'-11') THE EXPOSING FACE SHALL
 BE CLAD IN NON-COMBUSTBILE MATERIAL.

CONVENTIONAL ROOF FRAMING

38X140 (2"X6") RAFTERS @ 400mm (16" O.C.), 38x184 (2"X6") RIDGE BOARD 38X89 (2"X4") COLLAR TIES AT MIDSPANS. CEILING JOISTS TO BE 38X69 (2"X4") @ 400mm (16") O.C. FOR MAX. 2830mm (9"3") SPAN & 38X140 (2"X6") @ 400 (16") O.C. FOR MAX. 4450mm (14"-7") SPAN. RAFTERS FOR BUILT-UP ROOF TO BE 38X89 (2"X4") @ 600mm (24") O.C. WITH A 38X89 (2"X4") @ 600mm (24") O.C. WITH A 38X80 LATERALLY BRACED @ 1800mm (6"0") O.C. VERTICALLY BRACED @ 1800mm (6"0") O.C.

TWO STOREY VOLUME SPACES

FOR A MAXIMUM 5490mm (18-0") HEIGHT, PROVIDE 2-38X140 (2-2"X6") CONTINUOUS STUDS @ 300mm (12") O.C. FOR BRICK AND 400mm (16") O.C. FOR SIDING, PROVIDE SOLID WOOD BLOCKING BETWEEN STUDS @ 1202mm (41-0") O.C. VERT. FOR HORIZ, DISTANCES NOT EXCEEDING 2900 mm (9-6"), PROVIDE 38-140 (2"X6") STUDS @ 400 mm (16") O.C. WITH A CONTINUOUS HEADER AT THE GROUND FLOOR CEILING LEVEL. TOENAILED AND GLUED TO TOP PLATES.

GASPROOFING NOTES FOR CONSTRUCTION BETWEEN GARAGE & DWELLING

ATTACHED GARAGES MUST BE COMPLETELY SEALED TO PREVENT INFILTRATION OF GASES INTO DWFLLING.

a) PROVIDE 13mm (1/2") GYPSUM BOARD WITH MIN. 2 COATS OF JOINT COMPOUND AT ALL WALLS ADJACENT TO DWELLING. b) CAULK JOINTS BETWEEN GYPSUM BOARD COLLK FINE SURFACES WITH ACOUSTIC SEALANT c) CAULK PENETRATIONS SUCH AS HOSE BISS WITH ACOUSTIC SEALANT. D) 9.10.13.15. Doors Between Garages & dwelling units and a dwelling unit shall be tight-fitting and weatherstripped to provide an effective barrier against the passage of gases & exhaust fumes and shall be fitted with a self-closing device.

O.B.C. 9.10.9.16

NOTE:
ALL CONSTRUCTION NOTES TO BE USED AS A
REFERENCE. NOTES AND ASSEMBLIES MAY DIFFER AS
INDICATED ON PLANS.

NOTE:
ROOF TRUSS INFORMATION REFER TO ROOF TRUSS
SHOP DRAWINGS FOR ALL ROOF FRAMING
INFORMATION UNI ESS OTHERWISE NOTED.

NOTE: ALL BEAMS SUPPORTING FLOOR LOADS ARE SPECIFIED AS PER P. ENG. THE FLOOR TRUSS MANUFACTURER TO VERIFY ALL LVL BEAM SIZES FOR SHOP DRAWINGS.

NOTE: FLOOR FRAMING INFO REFER TO TJI SHOP DRAWINGS FOR ALL TRUSS-JOIST INFORMATION AND DETAILS. UNLESS OTHERWISE NOTED.

NOTE:

TYPICAL FOR ALL FLOORS:

- FLOOR SHALL BE 3/4" PLYWOOD. GLUED AND NAILED TO JOISTS TYP.
- ALL JOISTS SHALL HAVE A MIN. BEARING OF 1 3/4" AT SUPPORTS TYP. U/ND
- WOOD/PSL/LVL BEAMS SHALL HAVE A MIN. BEARING OF 3-1/2" AT SUPPORT TYP. U/ND



NOTES:

DRAWINGS MUST NOT BE SCALED
DRAWINGS TO BE READ IN CONJUNCTION WITH THE
GENERAL NOTES AND THE O.B.C.

All drawings & information shown on these drawings must be checked & verified on site prior to construction or fabrication of its components. Unless noted otherwise, no provision has been made in the design for conditions occurring during construction.

It shall be the responsibility of the contractor to provide all necessary bracing, shoring, sheet piling, or other temporary supports, to safeguard all existing or adjacent structures affected by construction. All dimensions are given in impracts units unless otherwise indirected.

All drawings are the property of the Architect / Designer & must be returned upon request.



ADDRESS:

4 Alderway Ave. Brampton, ON L6Y 2B6

PROJECT:

THREE UNIT DWELLING

GENERAL NOTES

 Date:
 2024-03-13

 Drawn by:
 S.M

 Checked by:
 S.I

A100

Scale:

GENERAL NOTES

- ALL DIMENSIONS ARE IN IMPERIAL UNLESS OTHERWISE NOTED
- CONTRACTOR SHALL CHECK AND VERIFY ALL 2. DIMENSIONS ON SITE AND REPORT ANY DISCREPANCIES.
- DO NOT SCALE DRAWINGS
- ALL WORK SHALL COMPLY WITH THE ONTARIO **BUILDING CODE 2012 AND THE REQUIREMENTS** OF ALL AUTHORITIES HAVING JURISDICTION.
- THIS DRAWING SET IS THE EXCLUSIVE PROPERTY OF HNS ENGINEERING INC COPYRIGHT RESERVED.
- CONTRACTOR SHALL NOT MAKE ANY CHANGES OR MODIFICATIONS WITHOUT CONSULTANT'S WRITTEN CONSENT. CONTRACTOR ASSUMES FULL LEGAL AND CONTRACTUAL LIABILITY FOR ANY UNAUTHORIZED CHANGES. CONTRACTOR
- SHALL CORRECT THEM AT HIS/HER OWN COST. CONTRACTOR TO SCHEDULE WORK SO IT DOES NOT INTERFERE WITH NORMAL TENANT OPERATIONS.
- COORDINATE ALL INTERIOR WORK WITH TENANTS. PROVIDE MIN. 72 HOURS NOTICE TO TENANTS.
- THE CONTRACTOR, HIS TRADES & SUPPLIERS SHALL PROVIDE SERVICES AND MATERIALS IN COMPLIANCE WITH THE EXISTING CODES, STANDARDS AND INDUSTRY GUIDELINES
- ALL WORK UPON COMPLETION SHALL BE SUFFICIENT TO OBTAIN THE OCCUPANCY PERMIT ANY REVISIONS REQUIRED BY THE AUTHORITIES HAVING JURISDICTION SHALL BE AT THE EXPENSE OF
- THE CONTRACTOR, TRADE OR SUPPLIER.
 COORDINATE GARBAGE CONTAINER LOCATION 11. WITH CONSULTANT AND/OR HOME OWNER.
- COORDINATE ANY POWER SHUT-OFFS WITH 12. HOME OWNER.
- ALL EXISTING WALL AND FLOOR THICKNESSES 13. AND DETAILING TO BE VERIFIED ON SITE FOR COHESION WITH PLANNED WORK
- EXISTING ROOF HEIGHTS AND SLOPES TO BE VERIFIED ON SITE

GENERAL DEMOLITION NOTES

- FOR USE OF ON-SITE FACILITIES COORDINATE WITH HOME OWNER AND/OR CONSULTANT.
- FOR ANY FRIABLE ASBESTOS CONTAINING MATERIALS (ACM) ENCOUNTERED, SUSPECTED, OR ANY ACM DAMAGED DURING WORK OPERATIONS, NOTIFY CONSULTANT, DO NOT DISTURB SUCH MATERIAL PENDING INSTRUCTIONS FROM ENVIRONMENTAL CONSULTANT.
- CONTRACTOR TO STORE ALL REMOVED MATERIALS IN SECURE WASTE CONTAINER.
- ALL SECURITY SYSTEM REMOVALS TO BE COORDINATED WITH OWNER'S SECURITY CONTRACTOR PRIOR TO COMMENCEMENT OF WORK
- CONTRACTOR SHALL VERIFY ALL SECURITY AND ACCESS SYSTEM INSTALLATIONS AND ENSURE THAT SUCH INSTALLATIONS HAVE NOT REDUCED THE PERFORMANCE OF COMPONENTS OR RENDERED THE PRODUCT'S WARRANTY VOID. PROVIDE COMMISIONING REPORTS FOR ALL
- SECURITY AND ACCESS SYSTEMS CONTRACTOR TO PROTECT ALL ADJACENT SURFACES AND ASSEMBLIES FROM DAMAGE ALL SURFACES AND ASSEMBLIES DAMAGED BY CONTRACTOR TO BE REPAIRED OR REPLACED AT
- CONTRACTOR'S EXPENSE.
 PROTECT EXISTING HVAC SYSTEM THROUGHOUT DURATION OF WORK. SHUT DOWN HVAC SYSTEM PRIOR TO SANDING AND/OR DEMOLISHING GYPSUM ASSEMBLIES, CLEAR ALL DUST AND POLLUTED AIR BEFORE TURNING SYSTEM ON. NOTIFY AND COORDINATE WITH CONSULTANT AND HOME OWNER PRIOR TO SHUTTING DOWN HVAC SYSTEM.
- SHUT DOWN AFFECTED FIRE ALARM ZONE DURING HOT WORK, REACTIVE FIRE ALARM ZONE
- STEEL CUTTING WITH POWER EQUIPMENT SHALL BE DONE WITH BURR-FREE SAW BLADES. KEEP SAW BLADES WELL LUBRICATED (SPARKS & FUMES ARE PROHIBITED)
- CONTRACTOR TO REMOVE TO SOURCE ALL ABANDONED AND UNUSED INFRASTRUCTURE WIRES & CABLES IN CEILING CAVITIES, PLENUMS, & WALLS AFFECTED BY WORK UNDER THIS
- CONTRACT. PROTECT EXISTING FLOOR FINISHES 11. WITH THICK POLYETHYLENE BARRIERS OR PAINTER'S SHEETS THROUGHOUT DEMOLITION & CONSTRUCTION.
- PROTECT ADJACENT SURFACES AT ALL 12. TIMES WHEN PAINTING AND/OR REPAINTING. DAMAGED OR STAINED SURFACES RESULTING FROM NEGLIGENCE SHALL BE RECTIFIED AT THE
- CONTRACTOR'S EXPENSE. CONTRACTOR SHALL PROVIDE ADEQUATE CONSTRUCTION FENCING, HOARDING. AND DUST/FUME BARRIERS AT ALL AREAS OF WORK & THROUGHOUT ENTIRE
- DURATION OF WORK IN ALL PHASES. EXISTING DRAWINGS REPRESENT RECORD DOCUMENTATION OF EXISTING BUILDING CONDITIONS. THE ARCHITECT DOES NOT WARRANT THE ACCURACY OF THE INFORMATION PROVIDED

WALL SCHEDULE (EXTERIOR TO INTERIOR)



EXIST. FOUNDATION WALL (UNINSULATED)

- BITUMINOUS DAMPROOFING WITH DRAINAGE LAYER TO
- POURED CONCRETE FOUNDATION WALL (REFER TO PLANS



EXISTING FOUNDATION WALL (INSULATED)

- REFER TO FN1, ADD -2" RIGID INSULATION BOARD (R10 CONT.), ON
- 2"x4" WOOD STUDS @ 16" O.C. W/BATTS INSULATION (R20), ON
- VAPOUR BARRIER, ON
- 1/2" DRYWALL

EXTERIOR DOUBLE BRICK (EXISTING)

- W1
- 3-1/2" BRICK VENEER AS PER ELEVATION, ON - 1" AIR SPACE, ON - BASE FLASHING UP MIN. 150mm (6") BEHIND BUILDING PAPER ON
- 3 1/2" BRICK VENEER, LATH & PLASTER



NEW INTERIOR 2"x4" WALL

-1/2" DRYWALL, ON -2"x4" WOOD STUD @16" O.C, ON



NEW INTERIOR FIRE RATED WALL

CONSTRUCTION COMPLIES WITH SUPPLEMENTARY STANDARDS TO THE O.B.C 2012 SB-3 TABLE 1 WALL NUMBER W4a -38X89 mm (2X4) WOOD STUDS AT 400 mm (16") O.C. -SINGLE 38X89mm (2X4) TOP AND BOTTOM PLATES. -89mm (3 1/2") THICK ABSORPTIVE MATERIAL PROCESSED FROM ROCK, SLAG, GLASS, OR CELLULOSE FIBRE ON ONE SIDE -RESILIANT CHANNEL @400mm O.C ON ONE SIDE OF WALL
-1 LAYER 15.9mm (5/8") TYPE "X" GYPSUM BOARD ON RESILIENT METAL CHANNEL SIDE -15.9 mm (5/8") TYPE "X" DRYWALL ON OTHER SIDE

ROOF SCHEDULE



EXISTING SLOPED ROOF

FLOOR SCHEDULE



EXISTING CONCRETE SLAB

- 4" POURED CONCRETE SLAB, ON - 4" COARSE GRANULAR FILL



EXISTING 2X10 WOOD JOISTS

- FINISHED FLOORING, ON - 3/4" PLYWOOD SUBFLOOR, ON -2X10 AS PER PLANS, ON
- -1/2" DRYWALL

STRUCTURAL NOTES

WINDOW LINTEL SCHEDULE

W1= 2-2X8 (3'-0" MAX. SPAN)

W2= 2-2X10 (4'-6" MAX. SPAN)

W3= 3-2X10 (6'-0" MAX. SPAN)

W4= 3-2X12 (8'-0" MAX. SPAN)

STEEL LINTELS

L1 = L3.5" X 3.5" X 1/4"(4'-0" MAX)

L2 = L5" X 3.5" X 3/8" (7'-0" MAX)

 $L3 = L6" \times 4" \times 3/8"(9'-0" MAX)$

 $L4 = L7" \times 4" \times 3/8"(11'-0" MAX)$

BOLT STEEL ANGLES TO WOOD LINTEL @24" O.C. ROVIDING MIN. OF 6" BEARING AT ENDS.

ALL PRE-ENGINEERED JOISTS AND LVL TO BE HANDLED & INSTALLED AS PER MANUFACTURE'S INSTRUCTIONS.



NOTES:

DRAWINGS MUST NOT BE SCALED DRAWINGS TO BE READ IN CONJUNCTION WITH THE GENERAL NOTES AND THE O.B.C.

All drawings & information shown on these drawings must be checked & verified on site prior to construction or fabrication of its Unless noted otherwise, no provision has been made in the design for conditions occurring during construction

It shall be the responsibility of the contractor to provide all necessary bracing, shoring, sheet piling, or other temporary supports, to safeguard all existing or adjacent structures affected by construction. All dimensions are given in imperial units unless otherwise indicated.

All drawings are the property of the Architect / Designer & must be returned upon request



ADDRESS:

4 Alderway Ave. Brampton, ON L6Y 2B6 PROJECT: THREE UNIT DWELLING

WALL TYPE & STRUCTURAL NOTES A101

2024-03-13

S.M


S.I

Scale:


Date:

Drawn by:

Checked by:

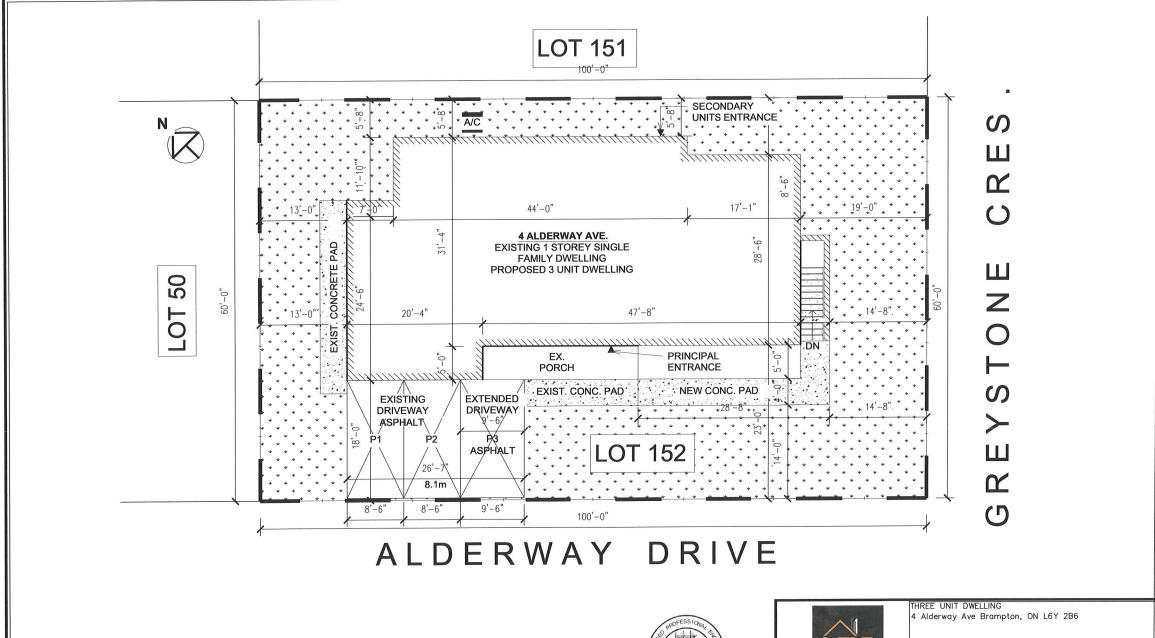



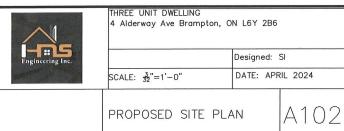


PROPOSED SITE PLAN



3/16" = 1'-0"

AREA: 1,629 SQFT CEILING: 7'-6"

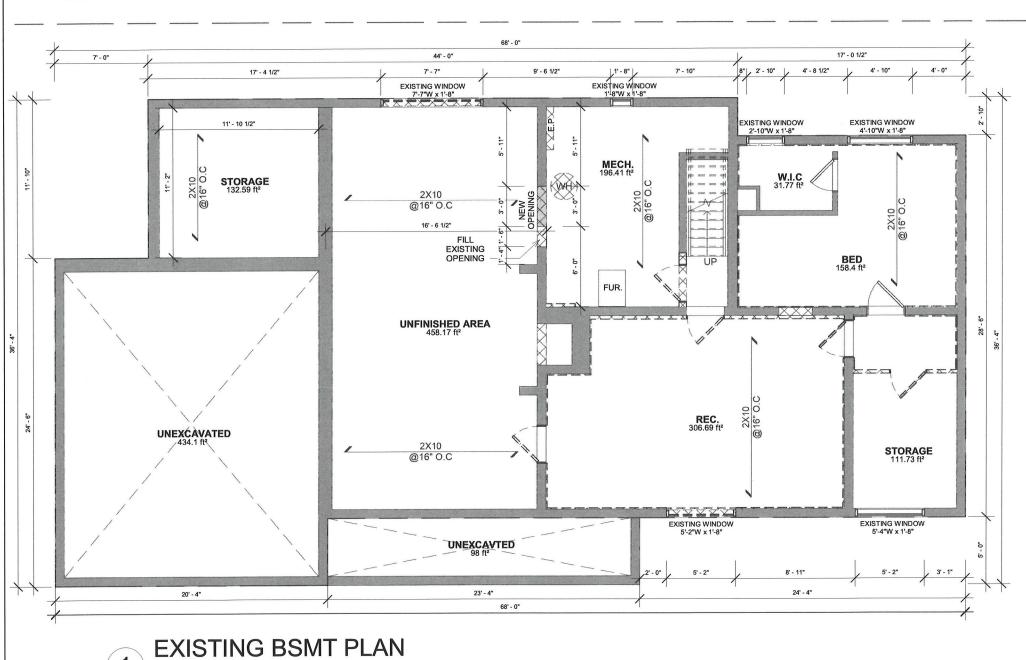



NOTE

DRAWINGS MUST NOT BE SCALED DRAWINGS TO BE READ IN CONJUNCTION WITH THE GENERAL NOTES AND THE O.B.C.

All drawings & information shown on these drawings must be checked & verified on site prior to construction or fabrication of its components. Unless noted otherwise, no provision has been made in the design for conditions occurring during construction.

It shall be the responsibility of the contractor to provide all necessary bracing, shoring, sheet piling, or other temporary supports, to safeguard all existing or adjacent structures affected by construction. All dimensions are given in imperial units unless otherwise indicated.

All drawings are the property of the Architect / Designer & must be returned upon request.



ADDRESS:

4 Alderway Ave. Brampton, ON L6Y 2B6


PROJECT:

THREE UNIT DWELLING

EXISTING BASEMENT PLAN


Date:	2024-03-13
Drawn by:	S.M
Checked by:	S.I

A103

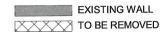

3/16" = 1'-0"

AREA: 2,119 SQFT CEILING: 8'-0"

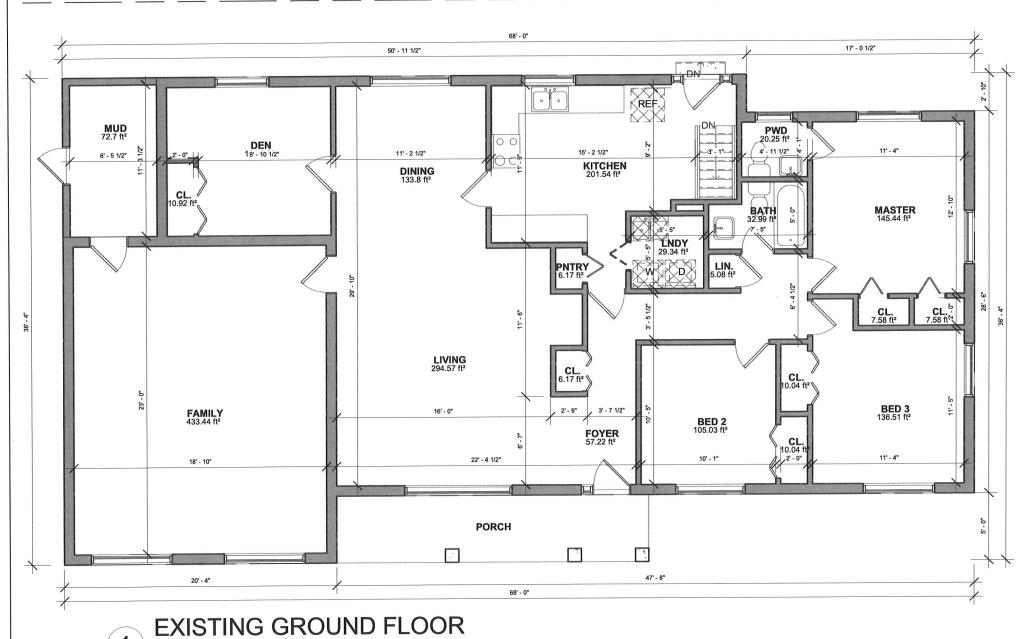



NOTE

DRAWINGS MUST NOT BE SCALED
DRAWINGS TO BE READ IN CONJUNCTION WITH THE
GENERAL NOTES AND THE O.B.C.

All drawings & information shown on these drawings must be checked & verified on site prior to construction or fabrication of its components. Unless noted otherwise, no provision has been made in the design for conditions occurring during construction.

It shall be the responsibility of the contractor to provide all necessary bracing, shoring, sheet piling, or other temporary supports, to safeguard all existing or adjacent structures affected by construction. All dimensions are given in imperial units unless otherwise indicated.

All drawings are the property of the Architect / Designer & must be returned upon request.



ADDRESS:

4 Alderway Ave. Brampton, ON L6Y 2B6

PROJECT:

THREE UNIT DWELLING

EXISTING GROUND FLOOR PLAN

Date:	2024-03-13
Drawn by:	S.M
Checked by:	S.I

A104




AREA: 1,599 SQFT

UNIT #1: 739 SQFT UNIT #2: 727 SQFT CEILING: 7'-6"

*NOTE: EXISTING 1/2" DRYWALL CEILLING TO REMAIN FURNACE MAY SERVE BOTH UNITS PROVIDED A SMOKE DETECTOR IS INSTALLED IN THE SUPPLY OR RETURN AIR DUCT SYSTEM WHICH WOULD TURN OFF THE FUEL SUPPLY AND ELECTRICAL POWER TO THE HEATING SYSTEM UPON ACTIVATION OF SUCH DETECTOR.

[AS PER OBC PART 11: C152 & C153] SPRINKLERED FURNACE RM. (NO FIRE RATED CEILING) DUCT-TYPE SMOKE DETECTOR SHALL BE INSTALLED IN DUCT SYSTEM IN FURNACE

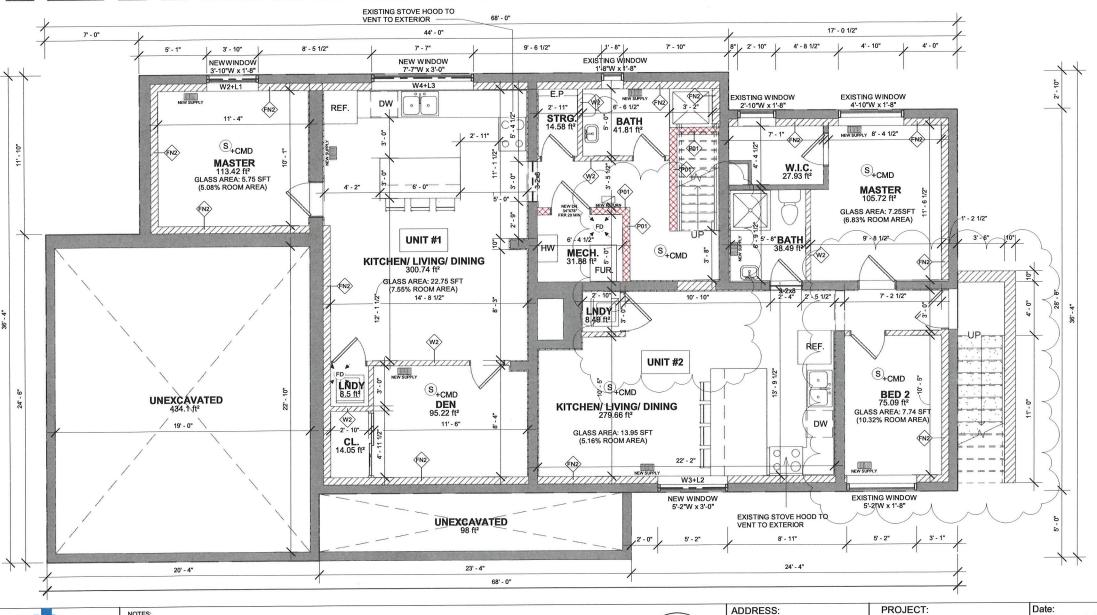



NOTES:

DRAWINGS MUST NOT BE SCALED DRAWINGS TO BE READ IN CONJUNCTION WITH THE GENERAL NOTES AND THE O.B.C.

All drawings & information shown on these drawings must be checked & verified on site prior to construction or fabrication of its components. Unless noted otherwise, no provision has been made in the design for conditions occurring during construction.

It shall be the responsibility of the contractor to provide all necessary bracing, shoring, sheet piling, or other temporary supports, to safeguard all existing or adjacent structures affected by construction. All dimensions are given in imperial units unless otherwise indicated

All drawings are the property of the Architect / Designer & must be returned upon request



4 Alderway Ave

4 Alderway Ave. Brampton, ON L6Y 2B6

 Date:
 2024-03-13

 Drawn by:
 S.M


 Checked by:
 S.I

PROPOSED BASEMENT PLAN A105



AREA: 2,119 SQFT CEILING: 8'-0"

3/16" = 1'-0"

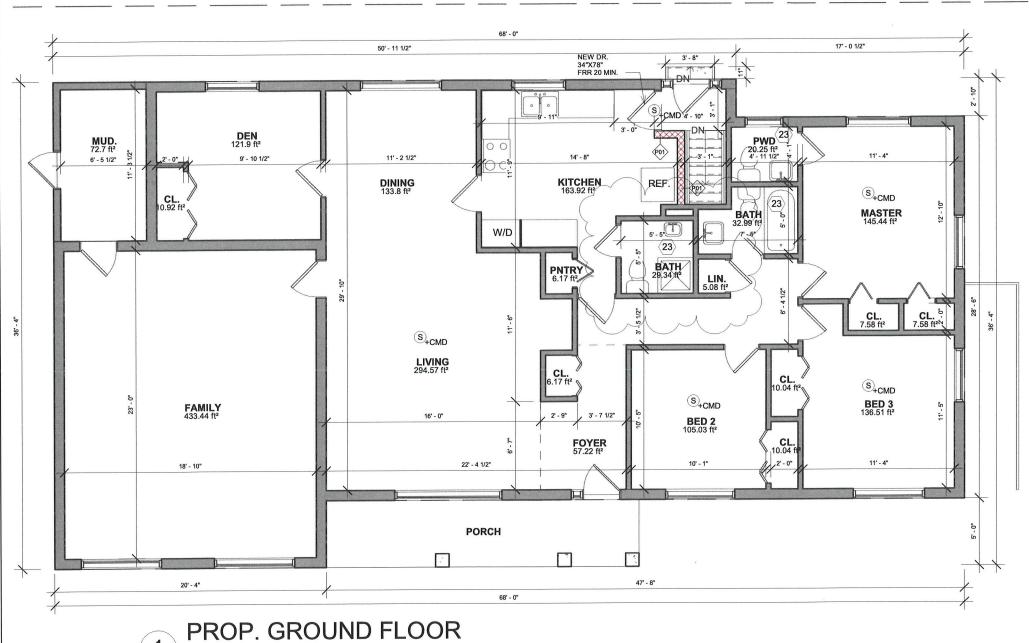



NOTE

DRAWINGS MUST NOT BE SCALED DRAWINGS TO BE READ IN CONJUNCTION WITH THE GENERAL NOTES AND THE O.B.C.

All drawings & information shown on these drawings must be checked & verified on site prior to construction or fabrication of its components. Unless noted otherwise, no provision has been made in the design for conditions occurring during construction.

It shall be the responsibility of the contractor to provide all necessary bracing, shoring, sheet piling, or other temporary supports, to safeguard all existing or adjacent structures affected by construction. All dimensions are given in imperial units unless otherwise indicated.

All drawings are the property of the Architect / Designer & must be returned upon request.



ADDRESS:

4 Alderway Ave. Brampton, ON L6Y 2B6

PROJECT:

THREE UNIT DWELLING

PROPOSED GROUND FLOOR PLAN


Date:	2024-03-13	
Drawn by:	S.M	
Checked by:	S.I	


A106

PO) as per SB-3
INTERIOR PARTITIONS WITHIN UNITS
AT STAIRCASE 1 HOUR FIRE RATED

Construction complies with supplementary standards to the O.B.C 2012 SB-3 table 1 wall number W4b

- to the C.B.C. 2012 SB-3 table 1 wall infillment (16") o.c. 38 X 89 mm (2 X 4) wood studs at 400 mm (16") o.c. single 38 X 89 mm (2 X 4) top and bottom plates 89mm (3 172") thick absorptive material processed from rock, slag, glass, or cellulose fibre on one side Resiliant channel @ 400mm o.c. on one side of wall 2 layer 15 9mm (58") type "X" gypsum board on resilient metal channel side 15.9 mm (5/8") type "X" drywall on other side

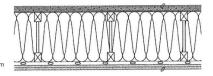

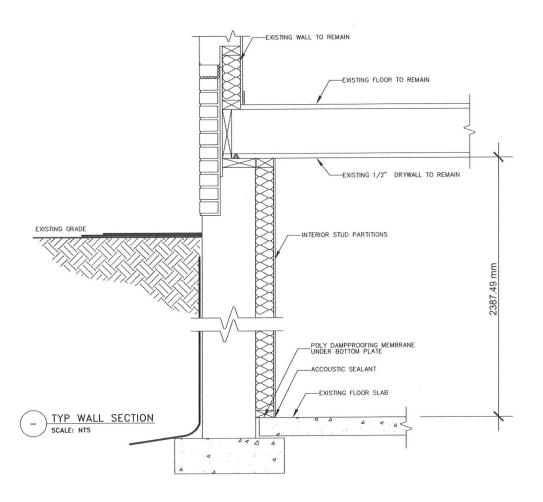



NOTES:

DRAWINGS MUST NOT BE SCALED DRAWINGS TO BE READ IN CONJUNCTION WITH THE GENERAL NOTES AND THE O.B.C.

All drawings & information shown on these drawings must be checked & verified on site prior to construction or fabrication of its components. Unless noted otherwise, no provision has been made in the design for conditions occurring during construction.

It shall be the responsibility of the contractor to provide all necessary bracing, shoring, sheet piling, or other temporary supports, to safeguard all existing or adjacent structures affected by construction. All dimensions are given in imperial units unless otherwise indicated.

All drawings are the property of the Architect / Designer & must be returned upon request.



ADDRESS:
4 Alderway Ave.

Brampton, ON L6Y 2B6


PROJECT:	
THREE UNIT	DWELLING

Date:	2024-03-13
Drawn by:	S.M
Checked by:	S.I
Δ.	107

TYP.	WALL	SECTION
------	------	---------

AIUI

Scale:

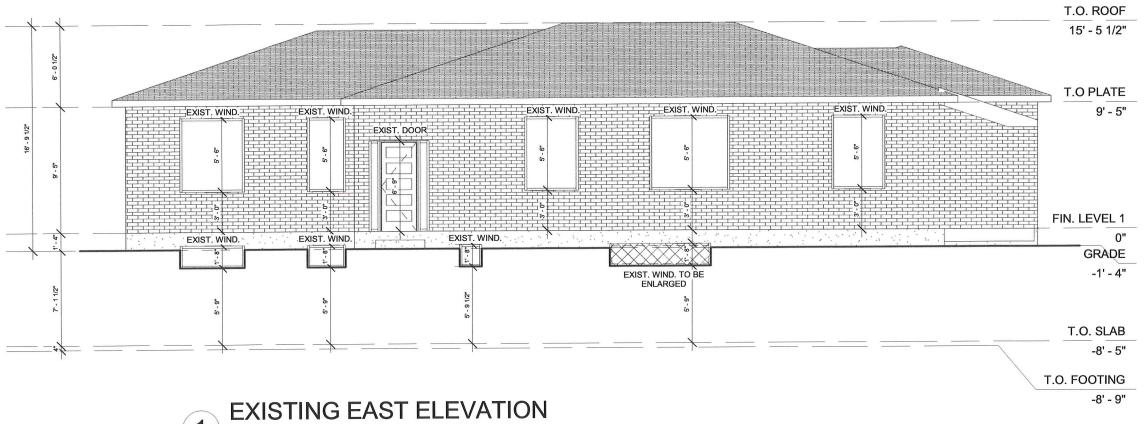





DRAWINGS MUST NOT BE SCALED DRAWINGS TO BE READ IN CONJUNCTION WITH THE GENERAL NOTES AND THE O.B.C.


All drawings & information shown on these drawings must be checked & verified on site prior to construction or fabrication of its components. Unless noted otherwise, no provision has been made in the design for conditions occurring during construction.



ADDRESS: 4 Alderway Ave. Brampton, ON L6Y 2B6 PROJECT: THREE UNIT DWELLING Date: 2024-03-13 S.M Drawn by: Checked by: A108

EXISTING EAST ELEVATION

3/16" = 1'-0"

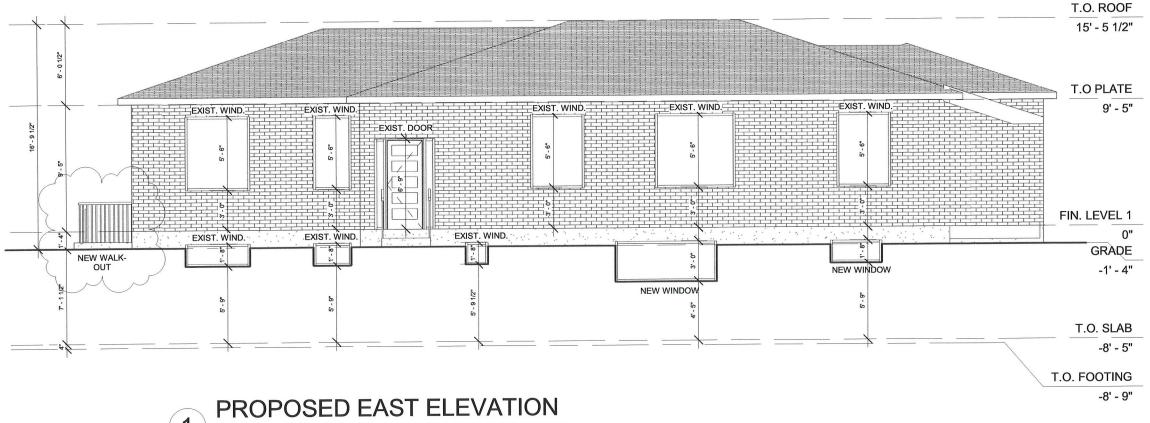



3/16" = 1'-0"



DRAWINGS MUST NOT BE SCALED DRAWINGS TO BE READ IN CONJUNCTION WITH THE GENERAL NOTES AND THE O.B.C.

All drawings & information shown on these drawings must be checked & verified on site prior to construction or fabrication of its components. Unless noted otherwise, no provision has been made in the design for conditions occurring during construction.

All drawings are the property of the Architect / Designer & must be returned upon request



ADDRESS:

4 Alderway Ave. Brampton, ON L6Y 2B6

PROJECT		
THREE	UNIT	DWELLING

PROPOSED EAS **ELEVATION**

Date:	2024-03-13
Drawn by:	S.M
Checked by:	S.I
A1	09

ST	A109	
	Scale:	3/16" = 1'-0"

Zoning Non-compliance Checklist

File No.	024-0041
A-2	024-0041

Applicant: Kevin and Christine Michael

Address: 4 Alderway

Zoning: RIB and Mature Neighbourhood

By-law 270-2004, as amended

Category	Proposal	By-law Requirement	Section #
USE			
LOT DIMENSIONS AREA / DEPTH / WIDTH			
BUILDING SETBACKS FRONT / SIDE / REAR	To permit a front yard setback of 4.47m to a proposed exterior stairway leading to a below grade entrance,	whereas the by-law requires a minimum front side yard setback of 6.0m.	12.5.2.d)
BUILDING SIZE			
BUILDING HEIGHT			
GFA			
TOWER SEPARATION			
BELOW GRADE ENTRANCE	To permit a proposed exterior stairway leading to a below grade entrance in a required front yard,	whereas the by-law does not permit exterior stairways constructed below established grade in the required interior side yard.	10.23
ACCESSORY STRUCTURE SIZE / HEIGHT			
MULTIPLE ACCESSORY STRUCTURES			
DRIVEWAY WIDTH	To permit a driveway width of 8.1 metres	Whereas the by-law permits a maximum driveway width of 6.71m	10.9
LANDSCAPED OPEN SPACE			
ENCROACHMENTS			
PARKING			
SCHEDULE "C"			

AMANDA DICKIE	
Reviewed by Zoning	

April 29, 2024

Date