Flower City



Provincial Highway

Private Right-of-Way

Municipal Road Maintained All Year

For Office Use Only (to be inserted by the Secretary-Treasurer after application is deemed complete)

FILE NUMBER:

A-2024-0202

The Personal Information collected on this form is collected pursuant to section 45 of the Planning Act and will be used in the processing of this application. Applicants are advised that the Committee of Adjustment files is considered public information and is available to anyone upon request and will be published on the City's website. Questions about the collection of personal information should be directed to the Secretary-Treasurer. Committee of Adjustment. City of Brampton.

APPLICATION Minor Variance or Special Permission

(Please read Instructions)

NOTE: It is required that this application be filed with the Secretary-Treasurer of the Committee of Adjustment and be accompanied by the applicable fee.

The undersigned hereby applies to the Committee of Adjustment for the City of Brampton under section 45 of the Planning Act, 1990, for relief as described in this application from By-Law 270-2004. Name of Owner(s) 1. Address 21 Hodgson St., Brampton On L6Y 3G8 Phone # Fax # 4168252082 **Email** limanialbana@gmail.com 2. Name of Agent Wassay Gulrez Address 3487 Bala Drive, Mississauga, ON L5M 0G6 Phone # 437-684-5252 Fax # **Email** alphhomes@gmail.com 3. Nature and extent of relief applied for (variances requested): The property is situated as a corner house on a dead-end road (Hodgson St.). There is neither a side walk nor a front-line walkway on the premises, and that side of the street is not a right of way to any other property or street. Due to its layout and the presence of a pool in the backyard, it is constrained a viable option for an entrance from the side-yard, between the main wall of the dwelling and flankage lot line. Why is it not possible to comply with the provisions of the by-law? 4 Below grade exterior stairs are not permitted in a yard located between the main wall of a dwelling and a flankage lot line. 5. Legal Description of the subject land: Lot Number 179 Plan Number/Concession Number 43M-518 Municipal Address 21 Hodgson St., Brampton ON L6Y 3G8 Dimension of subject land (in metric units) Frontage 7.2 m & R= 8 m Depth 30.5 m 449.49 sq.m Area 7. Access to the subject land is by:

Seasonal Road

Water

Other Public Road

8.	Particulars of all buildings and structures on or proposed for the sub- land: (specify <u>in metric units</u> ground floor area, gross floor area, numbe storeys, width, length, height, etc., where possible)				
	EXISTING BUILDING	SS/STRUCTURES on t	he subject land: List all structures (dwelling, shed, gazebo, etc.)		
	Single family dwelling GFA = 206.51 sq.m. Ground Floor Area = 109.4 sq.m. Second Floor Area = 97.11 sq.m.				
PROPOSED BUILDINGS/STRUCTURES on the subject land:					
	2nd dwelling base 2nd Dwelling Area	ement apartment			
9.		_	ructures on or proposed for the subject lands: r and front lot lines in <u>metric units</u>)		
	EXISTING	0.44			
	Front yard setback Rear yard setback	6.14 m 8.18 m			
	Side yard setback	1.65 m			
	Side yard setback	3.8 m	·		
	PROPOSED Front yard setback Rear yard setback	6.14 m 8.18 m			
	Side yard setback	1.65 m			
	Side yard setback	3.8 m			
10.	Date of Acquisition	of subject land:	1987		
11.	Existing uses of sul	bject property:	Single family house		
12.	Proposed uses of s	ubject property:	2 dwellings house		
13.	Existing uses of abo	utting properties:	Single family house		
14.	Date of construction	n of all buildings & str	uctures on subject land: 1987		
15.	Length of time the e	existing uses of the su	bject property have been continued: 36 years		
16. (a)	What water supply Municipal Well	is existing/proposed?	Other (specify)		
(b)	What sewage dispo	osal is/will be provided	l? Other (specify)		
(c)	What storm drainag	ge system is existing/p	proposed?		
, ,	Sewers Ditches Swales		Other (specify)		

	aubdivision or c	onsent?	application under th	a running Act, for a	pproval of a plan of
	Yes 🗆	No 🗹			
	If answer is yes,	provide details: File	n	Status	
18.	Has a pre-consu	Itation application been	filed?		
	Yes 🔲	No 🕝			
19.	Has the subject	property ever been the s	ubject of an applicat	on for minor variance	107
	Yes 🗆	No 🗷	Unknown 🔲		
	If answer is yes,	provide details:			
	File #	Decision		Relief_	
	File #	Decision		Relief	
				Q.,,,,,	
			Clanatura	of Applicant(s) or Au	thorized Apent
D. ***	DATE OF		MISSISSAUGA	of Appacant(s) or Au	gionzed Agein
	DAT THE CITY	A CONTROL OF THE PARTY OF THE P			
	19th DAY		20_24		
THE SUBJ	ECT LANDS, WR	IGNED BY AN AGENT, ITTEN AUTHORIZATION PRPORATION, THE AP ORPORATION'S SEAL	OF THE OWNER M	BE SIGNED BY	THE APPLICATION. IF
1,	WASSAY GULR	EZ	OF THE	CITY OF	MISSISSAUGA
IN THE	CITY OF	MISSISSAUGA	SOLEMNLY DEC	LARE THAT:	
BELIEVING OATH.	E ABOVE STATE IT TO BE TRUE BEFORE ME AT	AND KNOWING THAT I	ID I MAKE THIS SO IT IS OF THE SAME	LEMN DECLARATION FORCE AND EFFEC	ON CONSCIENTIOUSLY OT AS IF MADE UNDER
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IN THE	RESTORA	BEO OF		^	
	THIS 30			Warsay	
			Classic	are of Applicant or A	uthorized Appet
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4 4 B	A Franciscoper of	Oaths & Notary Publi	lo		
Canada 90	05.617.2762 ch resent Official Pi	Mississauga, Edited audhry@Ismaillaw.c an Designation:	a		
		-law Classification:			
7	his application h	as been reviewed with re said review are out	espect to the variand dined on the attache	ces required and the d checklist.	results of the
	Zon	ing Officer		Da	le
	DAT	TE RECEIVED	JUNE VI	6,202	-3

APPOINTMENT AND AUTHORIZATION OF AGENT

To: The Secretary-Treasurer
Committee of Adjustment
City of Brampton
2 Wellington Street West
Brampton, Ontario
L6Y 4R2
coa@brampton.ca

OCATION OF THE SUBJECT LAND: 21 Hodgson St.
We, Limani Albana
please print/type the full name of the owner(s)
he undersigned, being the registered owner(s) of the subject lands, hereby authorize
Vassay Gulrez
please print/type the full name of the agent(s)
o make application to the City of Brampton Committee of Adjustment in the matter of an application for minor variance with respect to the subject land.
Dated this 18th day of April , 2024.
(signature of the owner[s], or where the owner is a firm or corporation, the signature of an officer of the owner.)
Albana Limani
(where the owner is a firm or corporation, please print or type the full name of the person signing.)

NOTE: If the owner is a firm or corporation, the corporate seal shall be affixed hereto.

NOTE: Unit owners within a Peel Standard Condominium Corporation are to secure authorization from the Directors of the Condominium Corporation in a form satisfactory to the City of Brampton, prior to submission of an application. Signatures from all Members of the Board of Directors are required.

PERMISSION TO ENTER

To: The Secretary-Treasurer
Committee of Adjustment
City of Brampton
2 Wellington Street West
Brampton, Ontario
L6Y 4R2
coa@brampton.ca

LOCATION	ON OF THE SUBJECT LAND: 21 Hodgson St.
I/We,	Limani Albana
	please print/type the full name of the owner(s)
the City the abov	ersigned, being the registered owner(s) of the subject land, hereby authorize the Members of of Brampton Committee of Adjustment and City of Brampton staff members, to enter upon we noted property for the purpose of conducting a site inspection with respect to the attached ion for Minor Variance and/or consent.
Dated th	nis 18th day of April , 20 24 .
(sign	nature of the owner(s), or where the owner is a firm or corporation, the signature of an officer of the owner.)
e son o design transportation des	Albana Limani
	(where the owner is a firm or corporation, please print or type the full name of the person signing.)

NOTE: If the owner is a firm or corporation, the corporate seal shall be affixed hereto.

NO DISCUSSION SHALL TAKE PLACE BETWEEN THE COMMITTEE MEMBERS AND THE APPLICANT DURING THE SITE INSPECTION

PROJECT BRIEF:

PROJECT OBJECTIVE AND PROPOSED CHANGE:

- Objective of the project is to have second unit approval.
- All changes and design solutions have been proposed aligned with building code and concerned city requirements
- Design meets all safety requirements and conforms Ontario building code (OBC).

IMPORTANT NOTES AND CODE COMPLIANCE:

GENERAL NOTES:

- All work shall conform the requirements of OBC, O.Reg. 332/12.
- All dimensions to be verified by the contractor on site and discuss in case of any discrepancy before construction.
- Shop drawings to be prepared for approval if required.
- All materials and construction methods must comply with building codes, CMHC (Canada Mortgage and Housing Corporation) and CSA (Canadian Standards Association) and the authorities having jurisdiction.
- All construction activities to be supervised by a qualified engineer/supervisor. Contractor is responsible for the construction of the project, not the designer.
- All drawings to be read with notes, specifications and code references.

DESIGN NOTES AND CODE COMPLIANCE:

- Bottom rail of the framing shall be separated by concrete with 0.6mm thick polyethylene sheet or equivalent to avoid moisture.
- FRR Doors: All doors in FRR (Fire Resistance Rated) walls shall have 20 minutes fire rating and shall be equipped with self-closing device.
- Except for bathrooms, corridors and exits, interior walls and ceiling finishes shall have surface flame spread rating of not more than 150
- All doors for the spaces where return register is not there, will have 1" undercut to allow air passing. Return grill shall be near the floor.

- All supply registers shall comply with OBC [9.33.3.1(1)]
- Handrail for stairs shall be provided on one side of the stairs conforming to OBC – [9.8.7]
- 10) Egress window shall be provided with minimum 22" clear dimension outside and openable from the inside without the use of tools, to comply with OBC [9.9.10]
- All exhaust fans shall have discharge directly outside in open area as per OBC 9.32.1.3(3).
- 12) Lights with switches shall be provided in all areas – living room, bed rooms, kitchen, bathroom hallway, utility, garage and storage. Receptacles operated by switch may be provided in living and bed rooms and 3-way switch for stairs.
- Battery powered emergency lighting equipment shall be provided conforming to CSA 22.2 – no.
- 14) Sprinkler system shall be provided for the furnace room incase fire resistant rated ceiling is not provided. Sprinkler system shall be connected with ¾" copper water supply pipes and fittings. (If Applicable)
- 15) Max. Hot water temp. Shall not exceed 49OC (120OF) as per OBC 7.6.5.1. Dishwashers and cloth washers are exempted.
- 16) All thermostatic mixing valves shall conform to CAN/CSA-b125, "Plumbing Fixtures" and shall be labelled accordingly.
- 17) All intakes from building envelope penetrations that are potential sources of contaminants (gas, vents etc.) shall be separated by min. 900mm as per OBC 9.32.3.12
- New electrical work shall conform Code requirement and inspected by the ESA (Electrical Safety Authority).

19) Smoke Alarms [9.10.19]

Compliant to OBC 9.10.19 – Smoke Alarms, "Smoke Alarms (W/ Strobe light)", shall be installed in each dwelling unit and in each sleeping room, shall be installed on or near the ceiling, and all have to be interconnected.

20) Carbon Monoxide Alarms [9.33.4]

Compliant to OBC 9.33.4 – A carbon monoxide alarm shall be installed adjacent to each sleeping area in the suite where a fuel-burning appliance is installed in a suite of residential occupancy. (if applicable for the project)
Install carbon monoxide detector conforming to CAN/CGA-6.19 OR UL 2034

21) Mechanical ventilation to be provided min. 5.0 l/s in kitchens and bathrooms, 37.5 l/s for principal exhaust fan

22) STAIRS DIMENSIONS:

Risers = 125mm - 200mm, Treads=210mm - 355mm,

- 23) All steps to be uniform through flight (Conforming to obc-9.8.4, Table 9.8.4.1)
- 24) Handrail for stairs shall be provided for the stairs conforming to obc-9.8.7
- 25) Guards are required around conc. slab if more than 600mm above grade, on both sides of the stairs minimum 900mm high for stairs and minimum 900mm high for porches upto 1800mm above grade.
- 26) Minimum 1070mm high for greater heights.
- 27) Max. 100mm between pickets and no member designed to facilitate climbing between 140mm and 900mm.

OBC PART 11- COMPLIANCE ALTERNATIVES REFERENCE

Part 9 Requirement - 9.10.9.14.(1) and (3); 9.10.9.15.(1) PART 11- COMPLIANCE ALTERNATIVE- C152:

- (a) Except as provided in (b) and (c), 30 min fire separation is acceptable.
- (b) In a house, 15 min horizontal fire separation is acceptable where,
 (i) smoke alarms are installed in every dwelling
 - (i) smoke alarms are installed in every dwelling unit and in common areas in conformance with Subsection 9.10.19., and
- (ii) smoke alarms are interconnected.(c) In a house, the fire-resistance rating of the fire separation is waived where the building is sprinklered.

Part 6 Requirement - 6.2.4.7 (10) PART 11- COMPLIANCE ALTERNATIVE- C95:

In a building containing not more than four dwelling units or residential suites, the existing heating or airconditioning system may be altered to serve more than one dwelling unit or suite, provided smoke alarms are installed in each dwelling unit or suite and provided a smoke detector is installed in the supply or return air duct system serving the entire building which would turn off the fuel supply and electrical power to the heating system upon activation of such detector.

Part 9 Requirement - 9.5.3.1. PART 11- COMPLIANCE ALTERNATIVE- C102:

In a house

(a) Minimum room height shall not be less than 1 950 mm over the required floor area and in any location that would normally be used as a means of egress, or (b) Minimum room height shall not be less than 2030 mm over at least 50% of the required floor area, provided that any part of the floor having a clear height of less than 1400 mm shall not be considered in computing the required floor area.

Part 9 Requirement - 9.9.9

PART 11- COMPLIANCE ALTERNATIVE- C136:

In a house, exit requirements are acceptable if at least one of the following conditions exists:

- (a) a door, including a sliding door, that opens directly to the exterior from a dwelling unit, serves only that dwelling unit and has reasonable access to ground level, and the dwelling units are equipped with smoke alarms installed in conformance with Subsection 9.10.19., (b) an exit that is accessible to more than one dwelling unit and provides the only means of egress from each dwelling unit, provided that the means of egress is separated from the remainder of the building and common areas by a fire separation having a 30 min fireresistance rating and provided further that the required access to exit from any dwelling unit cannot be through another dwelling unit, service room or other occupancy, and both dwelling units and common areas are provided with smoke alarms that are installed in conformance with Subsection 9.10.19. and are interconnected, or
- (c) access to an exit from one dwelling unit which leads through another dwelling unit where,
 - (i) an additional means of escape is provided through a window that conforms to the following:

 (A) the sill height is not more than 1,000 mm above.
 - (A) the sill height is not more than 1 000 mm above or below adjacent ground level,
 (B) the window can be opened from the inside
 - without the use of tools,
 (C) the window has an individual unobstructed open portion having a minimum area of 0.38 m²
 - with no dimension less than 460 mm,
 (D) the sill height does not exceed 900 mm above
 the floor or fixed steps.
 - (E) where the window opens into a window well, a clearance of not less than 1 000 mm shall be provided in front of the window, and
 - (F) smoke alarms are installed in every dwelling unit and in common areas in conformance with Subsection 9.10.19. and are interconnected,
 - (ii) an additional means of escape is provided through a window that conforms to the following:
 - (A) the window is a casement window not less than 1 060 mm high, 560 mm wide, with a sill height not more than 900 mm above the inside floor.
 - (B) the sill height of the window is not more than 5 m above adjacent ground level, and
 - (C) smoke alarms are installed in every dwelling unit and in common areas in conformance with Subsection 9.10.19. and are interconnected, or
 - (iii) the building is sprinklered and the dwelling units are equipped with smoke alarms installed in conformance with Subsection 9.10.19.



ALPH HOMES3487 BALA DR. MISSISSAUGA,
ON L5M0G6. TEL: +1 (437) 684-5252

DESIGNED BY

WASSAY GULREZ Ph.D, P.Eng.

Seal & SIG:



TITLE

NOTES

ADDRESS:

21 HODGSON ST, BRAMPTON

NOTES

- 1- CONTRACTOR TO CONFIRM ON SITE PRIOR TO COMMENCEMENT THAT ALL THE EXISTING STRUCTURAL MEMBERS MATCH THE INFORMATION STATED IN ALL THIS PERMIT DRAWINGS.
- 2- CONTRACTOR TO REPORT TO THE DESIGNER FOR ANY DISCREPANCIES BETWEEN THE EXISTING STRUCTURAL MEMBERS AND INFORMATION STATED IN ANY OF THIS PERMIT DRAWINGS.

DRAWN BY: A.M

DATE: SCALE: NTS

PEN/ISED DWG:

DRAWING NO

A-01

LEGEND



WALL TYPE

CEILING TYPE

CLG. HT. CEILING HEIGHT (CH)

F1 FLOOR TYPE

100.00 FLOOR LEVEL

O DRAIN PIPE

CI FLOOR DRAIN

RETURN AIR REGISTER

SUPPLY AIR REGISTER (CEILING MOUNTED)

SUPPLY AIR REGISTER (WALL MOUNTED)

SUPPLY AIR REGISTER (FLOOR MOUNTED)

MIN. 50 CFM EXHAUST FAN DUCTED OUTSIDE (5"DIA)

---- DUCT-WORK

---- BULKHEAD

A.P ACCESS PANEL

O POT LIGHT FIX. (CEILING)

-O- LIGHT FIXTURE (CEILING)

-O LIGHT FIXTURE (WALL)

→ EXT. LIGHT FIX. (WALL)

E EMERGENCY LIGHTING

→ SWITCH

3 WAY SWITCH

SA INTERCONNECTED SMOKE ALARM

CMD CARBON MONOXIDE DETECTOR

WALL LEGEND

(ABOVE GRADE)

BRICK VINEER/SIDING WITH WEEPHOLES

±1½"CAVITY BTW SHEATHING AND FACING
 2"x6" WOODEN STUDS @ 16" O/C

- R-20 BATT INSULATION

- 6 MIL POLYETHYLENE VAPOUR BARRIER

- Introduction of the state of

EXTERIOR WALLS (BELOW GRADE) (FIRE RESISTANCE RATING-30 MIN.)

(FIRE RESISTANCE RATING-50

CONCRETE WALLMOISTURE BARRIER

- 2"X4" WOODEN STUDS @ 16" O/C

6 MIL POLYETHYLENE UNDER BOTTOM PLATE
 R12 BATT INSULATION

- 6 MIL POLYETHELENE VAPOUR BARRIER

 - ½" THICK GYPSUM BOARD (WATER RESISTANT FOR WET AREAS)

M3 INTERIOR CONCRETE WALL

1" THICK GYPSUM BOARD CONCRETE IN-FILL

- ½" THICK GYPSUM BOARD
(WATER RESISTANT FOR WET AREAS)

W4 INTERIOR WALL

- 1" THICK GYPSUM BOARD
- 2"x4"/2"x6" WOODEN STUD @ 16" O/C
- 6 MIL POLYETHYLENE UNDER BOTTOM PLATE

- ½" THICK GYPSUM BOARD
(WATER RESISTANT FOR WET AREAS)

W5 INTERIOR WALL (FRR-30 MIN.& 32 STC- W1c)

- ½" (12.7MM) THICK GYPSUM BOARD - 2"v4"/2"v6" WOODEN STUD @ 16" OR 24"O/C

2"x4"/2"x6" WOODEN STUD @ 16" OR 24"O/C
 89MM THICK ABSORPTIVE MATERIAL

- 6 MIL POLYETHYLENE UNDER BOTTOM PLATE
- 1" (12.7MM) THICK GYPSUM BOARD

(WATER RESISTANT FOR WET AREAS)

W6 INTERIOR WALL (FRR-45 MIN.& 32 STC- W1e)

- ½" (12.7MM) THICK TYPE "X" GYPSUM BOARD - 2"x4"/2"x6" WOODEN STUD @ 16" OR 24" O/C

- 6 MIL POLYETHYLENE UNDER BOTTOM PLATE
- 3" THICK TYPE "X" GYPSUM BOARD

- ½" THICK TYPE "X" GYPSUM BOARD (WATER RESISTANT FOR WET AREAS)

VT INTERIOR WALL (FRR-45 MIN.& 51 STC- W50)

- §" (15.9MM) THICK TYPE "X" GYPSUM BOARD OVER RESILLIENT METAL CHANNELS ON ONE SIDE - W/ 89MM THICK ABSORPTIVE MATERIAL

2"x4"/2"x6" WOODEN STUD ® 16" (406MM)0/C
 6 MIL POLYETHYLENE UNDER BOTTOM PLATE

- ½" (12.7MM) THICK GYPSUM BOARD (2-LAYERS) (WATER RESISTANT FOR WET AREAS)

CEILING LEGEND

REGULAR CEILING

 SUB-FLOOR LAYER 11MM SANDED PLYWOOD, OR OSB OR WAFER BOARD

 SUB-FLOOR LAYER 15.5MM PLYWOOD, OSB OR WAFER BOARD OR 17MM TONGUE & GROVE LUMBER

- EXISTING WOOD I-JOISTS @ MAX 610MM O/C

 12.7MM THICK GYPSUM BOARD (WATER RESISTANT FOR WET AREAS)

FIRE RATED CEILING (FRR-15 MIN.)

SUB-FLOOR LAYER 11MM SANDED PLYWOOD, OR OSB OR WAFER BOARD

- SUB-FLOOR LAYER 15.5MM PLYWOOD, OSB OR WAFER BOARD OR 17MM TONGUE & GROVE LUMBER

- EXISTING WOOD I-JOISTS @ MAX 610MM O/C

 12.7MM THICK GYPSUM BOARD (WATER RESISTANT FOR WET AREAS)

FIRE RATED CEILING (FRR-30 MIN. & 46 STC)

 SUB-FLOOR LAYER 11MM SANDED PLYWOOD, OR OSB OR WAFER BOARD

- SUB-FLOOR LAYER 15.5MM PLYWOOD, OSB OR WAFER BOARD OR 17MM TONGUE & GROVE

EXISTING WOOD I-JOISTS @ MAX 610MM O/C

- 15.9MM TYPE-X GYPSUM BOARD

OR 12.7MM GYP. BD @ CHANNELS @ 406 O/C
(WATER RESISTANT FOR WET AREAS)

FIRE RATED CEILING

(FRR-45 MIN. & 51 STC- F10c)

 SUB-FLOOR LAYER 11MM SANDED PLYWOOD, OR OSB OR WAFER BOARD

 SUB-FLOOR LAYER 15.5MM PLYWOOD, OSB OR WAFER BOARD OR 17MM TONGUE & GROVE LUMBER

- EXISTING WOOD I-JOISTS @ MAX 610MM O/C

ABSORPTIVE* MATERIAL IN CAVITY

- 15.9MM TYPE-X GYPSUM BOARD (WATER RESISTANT FOR WET AREAS)

CS CEILING UNDER STAIRS

(FIRE RESISTANCE RATING-15 MIN.)
WOOD FRAME OR STAIR STRUCTURE

 12.7MM THICK GYPSUM BOARD (WATER RESISTANT FOR WET AREAS)

MINISHED CEILING

EXISTING WOOD I—JOISTS

- SPRINKLER SYSTEM (IF APPLICABLE)

(FIRE RESISTANCE RATING-15 MIN.)

- EXISTING WOOD I-JOISTS - R31 BATT INSULATION



3487 BALA DR. MISSISSAUGA, ON L5M0G6. TEL: +1 (437) 684-5252

DESIGNED BY:

WASSAY GULREZ Ph.D, P.Eng.

Seal & SIG:



TITLE

LEGENDS

ADDRESS:

21 HODGSON ST, BRAMPTON

NOTES:

1- CONTRACTOR TO CONFIRM ON SITE PRIOR TO COMMENCEMENT THAT ALL THE EXISTING STRUCTURAL MEMBERS MATCH THE INFORMATION STATED IN ALL THIS PERMIT DRAWINGS.

2- CONTRACTOR TO REPORT TO THE DESIGNER FOR ANY DISCREPANCIES BETWEEN THE EXISTING STRUCTURAL MEMBERS AND INFORMATION STATED IN ANY OF THIS PERMIT DRAWINGS.


DRAWN BY: A.M

DATE: | SCALE: | NTS

REVISED DWG:

DRAWING NO:

A-02

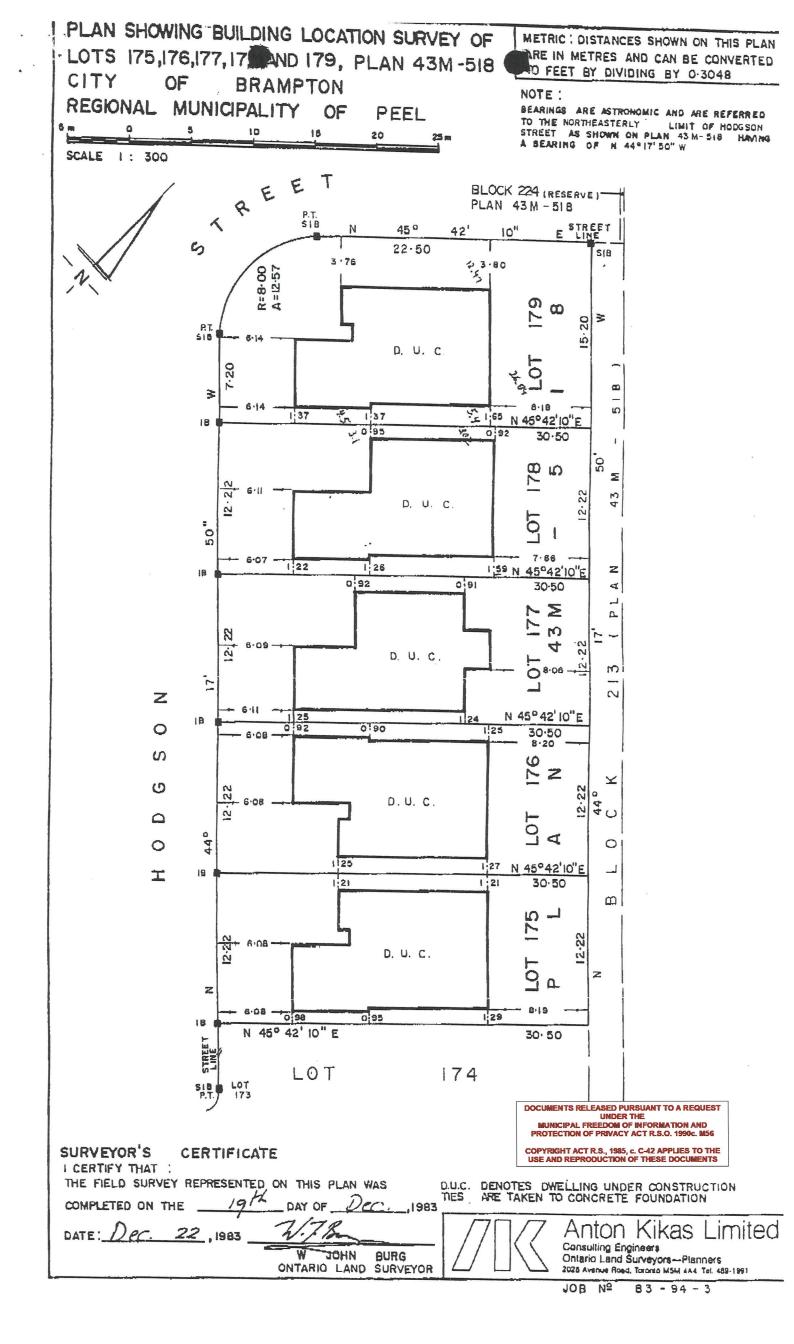

Total GFA area: 2572.07 SFT / 238.95 m² Basement covered area excluding furnace :

1,111.78 sft / 103.28 m²


Ground floor covered area excluding garage:


1177.63 SFT / 109.40 m² Second floor covered area: 1045.33 SFT / 97.11 m² Parking required: 03 Parking provided: 03 Located 1 in garage


Primary Dewelling Area: 231.95 $\text{m}^2(\text{DUFA})$ (GROUND FLOOR + SECOND FLOOR + BASEMENT-OWNER'S AREA) Secondary Dewelling Area: 82.45 $\text{m}^2(\text{DUFA})$

(BASEMENT)

FRONT LANDSCAPING AREA = $724.05 \text{ sft } (67.26 \text{ m}^2) = 60.63 \%$

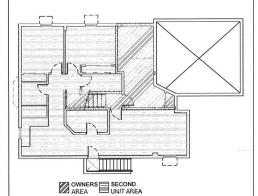

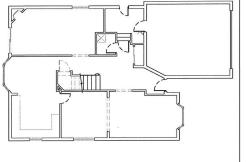

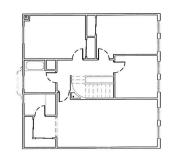



3487 BALA DR. MISSISSAUGA,

DESIGNED B

WASSAY GULREZ Ph.D, P.Eng.

Seal & SIG:



TITLE

SITE PLAN

ADDRESS:

21 HODGSON ST, BRAMPTON

NOTE


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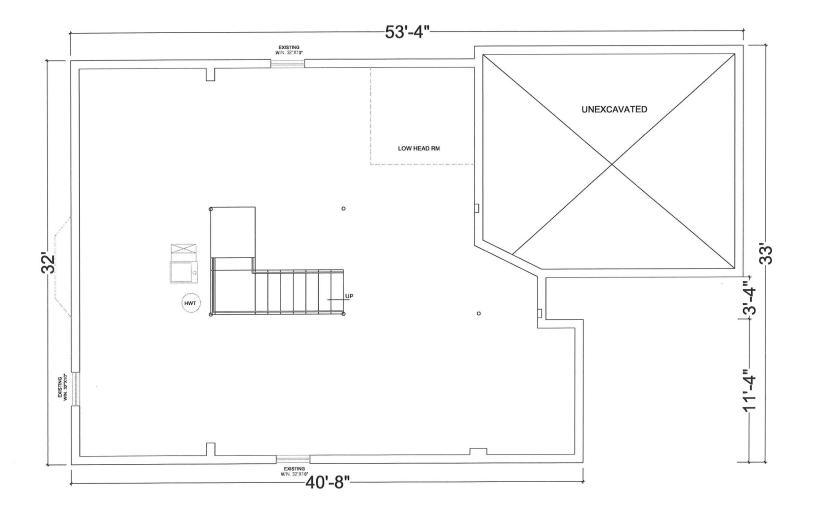
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DRAWN BY:	A.M
DATE: 18-01	SCA 1-24 = 1
REVISED DW	VG:

DRAWING NO:

A-03



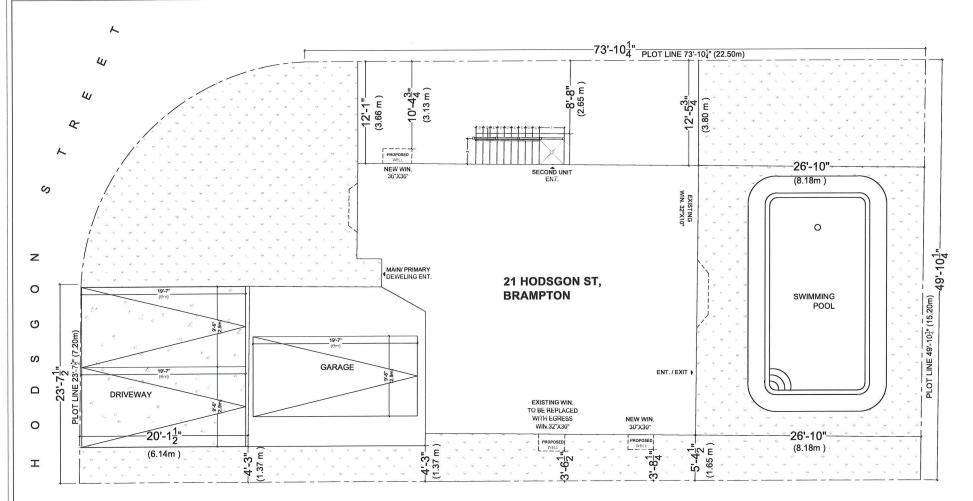

EXISTING BASEMENT PLAN



3487 BALA DR. MISSISSAUGA, ON L5M0G6. TEL: +1 (437) 684-5252

DESIGNED BY:

WASSAY GULREZ Ph.D, P.Eng.

Seal & SIG:



TITLE

EXISTING BASEMENT PLAN

ADDRESS:

21 HODGSON ST, BRAMPTON

NOTE


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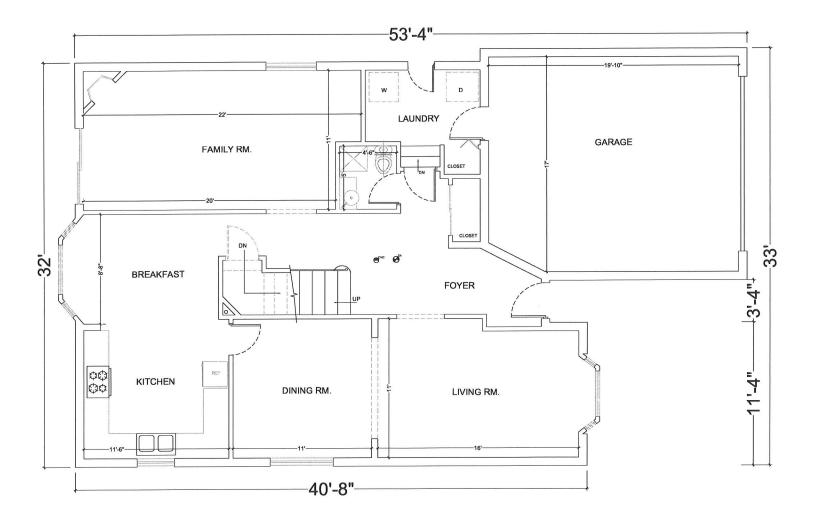
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DRAWN BY:	A.M	
DATE: 18-01-24	SCALE:	
REVISED DWG:		

DRAWING NO:

A-04



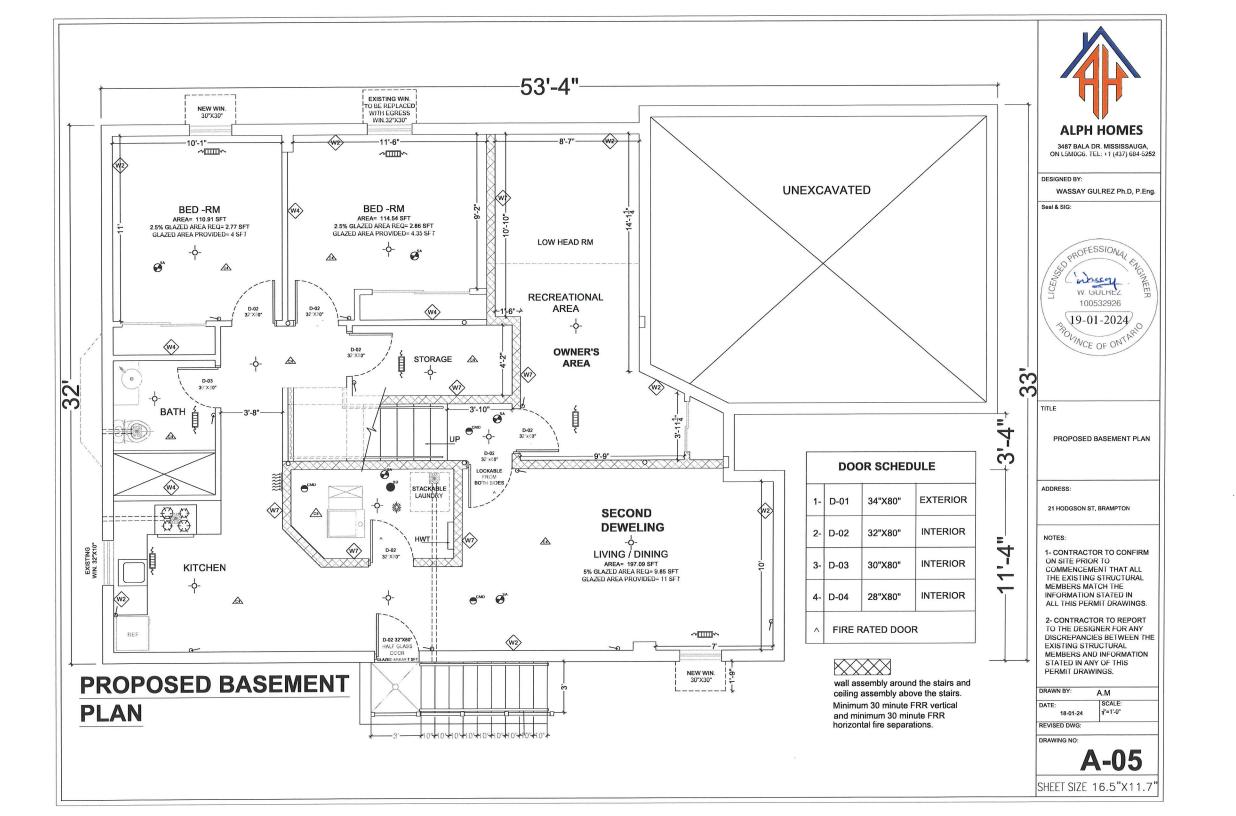

EXISTING GROUND FLOOR PLAN



ALPH HOMES 3487 BALA DR. MISSISSAUGA, ON L5M0G6. TEL: +1 (437) 684-5252

DESIGNED BY:

WASSAY GULREZ Ph.D, P.Eng.

Seal & SIG:



TITLE

EXISTING GROUND FLOOR PLAN

ADDRESS:

21 HODGSON ST, BRAMPTON


NOTE

1- CONTRACTOR TO CONFIRM ON SITE PRIOR TO COMMENCEMENT THAT ALL THE EXISTING STRUCTURAL MEMBERS MATCH THE INFORMATION STATED IN ALL THIS PERMIT DRAWINGS.

2- CONTRACTOR TO REPORT TO THE DESIGNER FOR ANY DISCREPANCIES BETWEEN THE EXISTING STRUCTURAL MEMBERS AND INFORMATION STATED IN ANY OF THIS PERMIT DRAWINGS.

DRAWING NO:

A-06

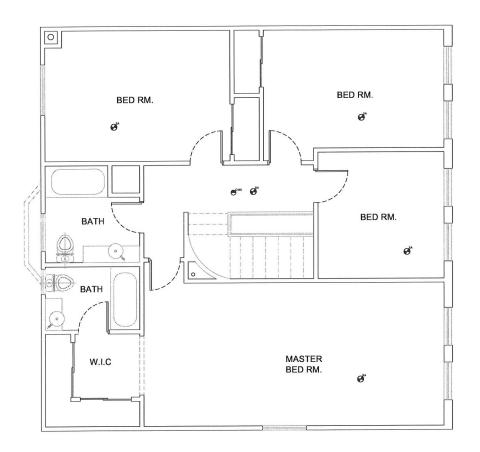

EXISTING SECOND FLOOR PLAN



3487 BALA DR. MISSISSAUGA, ON L5M0G6. TEL: +1 (437) 684-5252

DESIGNED BY:

WASSAY GULREZ Ph.D, P.Eng.

Seal & SIG:



TITLE

EXISTING SECOND FLOOR PLAN

ADDRESS:

21 HODGSON ST, BRAMPTON

NOTE

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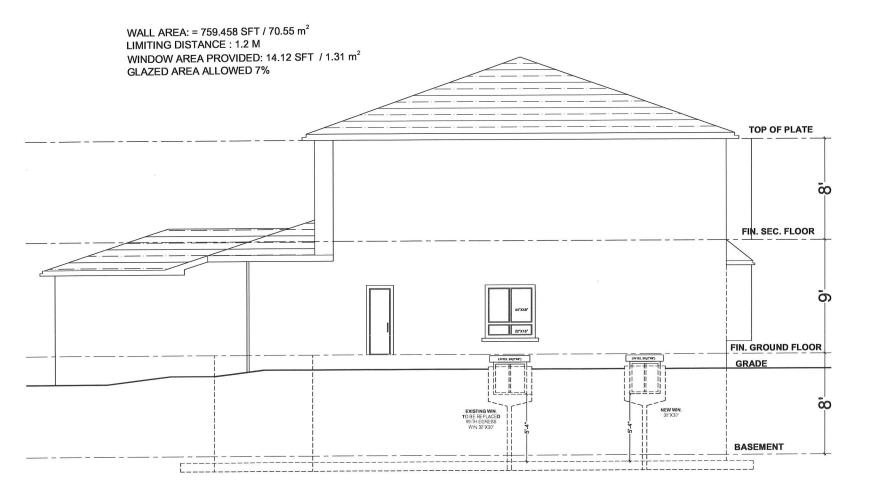
DRAWN BY: A.M

DATE: SCALE: 18-01-24 15" 1 1-0"

REVISED DWG:

DRAWING NO:

A-07



LEFT SIDE ELEVATION



3487 BALA DR. MISSISSAUGA, ON L5M0G6. TEL: +1 (437) 684-5252

DESIGNED BY:

WASSAY GULREZ Ph.D, P.Eng.

Seal & SIC



TITL

LEFT SIDE ELEVATION

ADDRESS:

21 HODGSON ST, BRAMPTON

NOTES

1- CONTRACTOR TO CONFIRM ON SITE PRIOR TO COMMENCEMENT THAT ALL THE EXISTING STRUCTURAL MEMBERS MATCH THE INFORMATION STATED IN ALL THIS PERMIT DRAWINGS.

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DRAWN BY: A, M


DATE:

18-01-24

REVISED DWG:

DRAWING NO

A-08

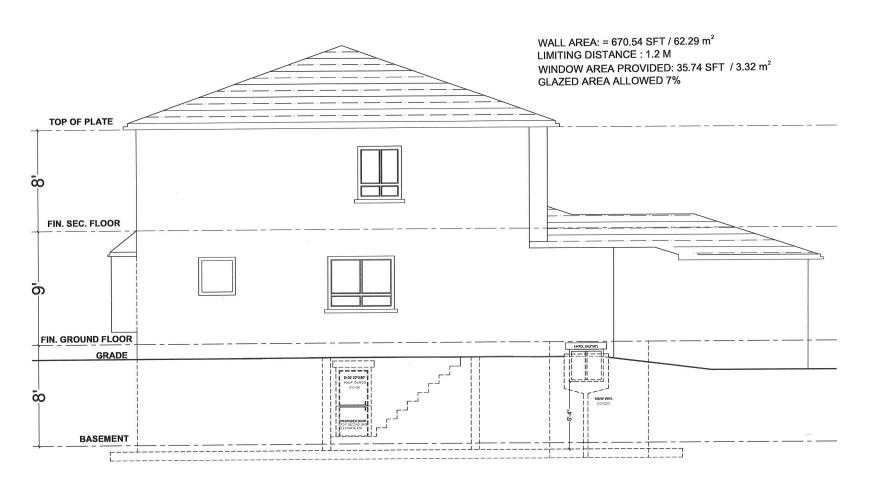

RIGHT SIDE ELEVATION



3487 BALA DR. MISSISSAUGA, ON L5M0G6. TEL: +1 (437) 684-5252

DESIGNED BY:

WASSAY GULREZ Ph.D, P.Eng.

Seal & SIG



IIIL

RIGHT SIDE ELEVATION

ADDRESS:

21 HODGSON ST, BRAMPTON

NOTE


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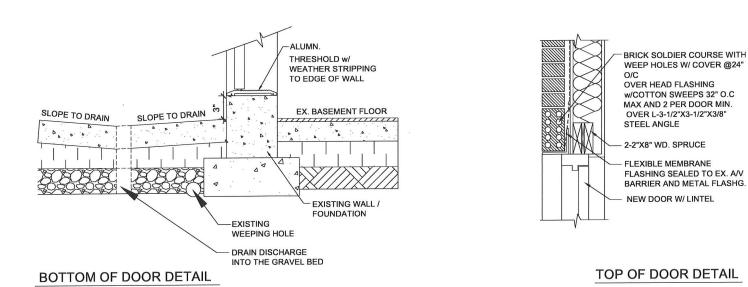
KEVISED DWG

DRAWING NO

A-09



BELOW GRADE STAIRS BLOWUP

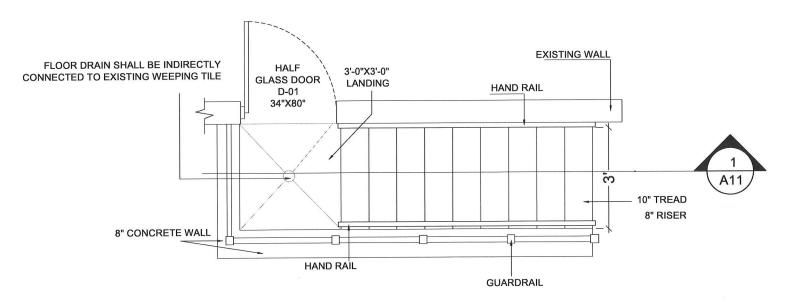



3487 BALA DR. MISSISSAUGA, ON L5M0G6. TEL: +1 (437) 684-5252

DESIGNED BY:

WASSAY GULREZ Ph.D, P.Eng.

Seal & SIG:



TITLE

BELOW GRADE STAIRS DETAIL

ADDRESS:

21 HODGSON ST, BRAMPTON


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DRAWING NO:

A-10





3487 BALA DR. MISSISSAUGA, ON L5M0G6. TEL: +1 (437) 684-5252

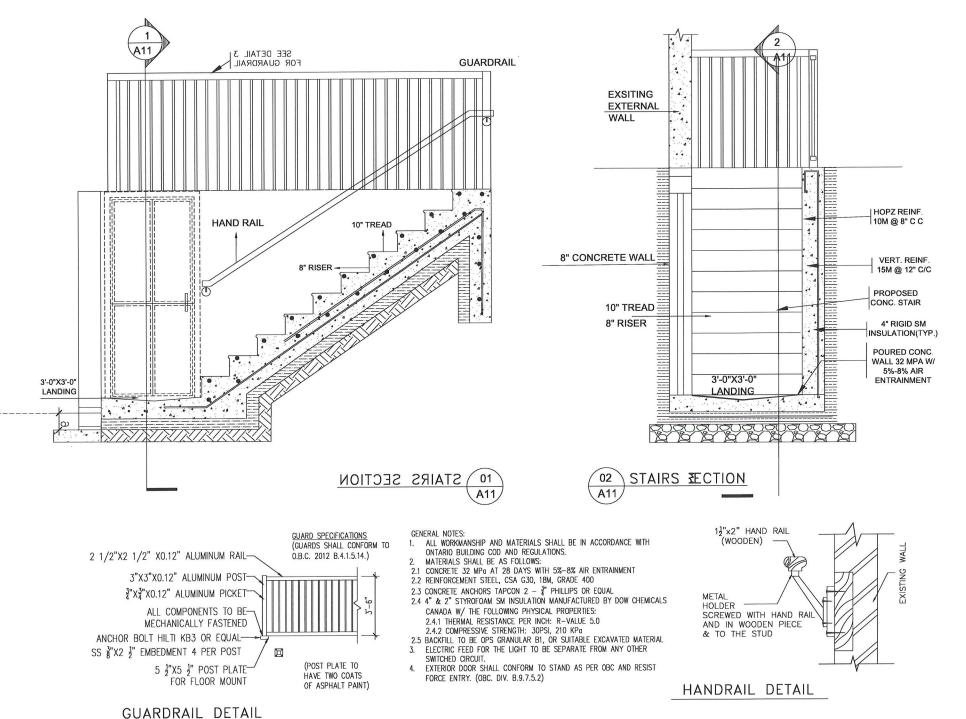DESIGNED BY:

WASSAY GULREZ Ph.D, P.Eng.

Seal & SIG:



TITLE

BELOW GRADE STAIRS SECTIONAL DETAILS

ADDRESS:

21 HODGSON ST, BRAMPTON

NOTE

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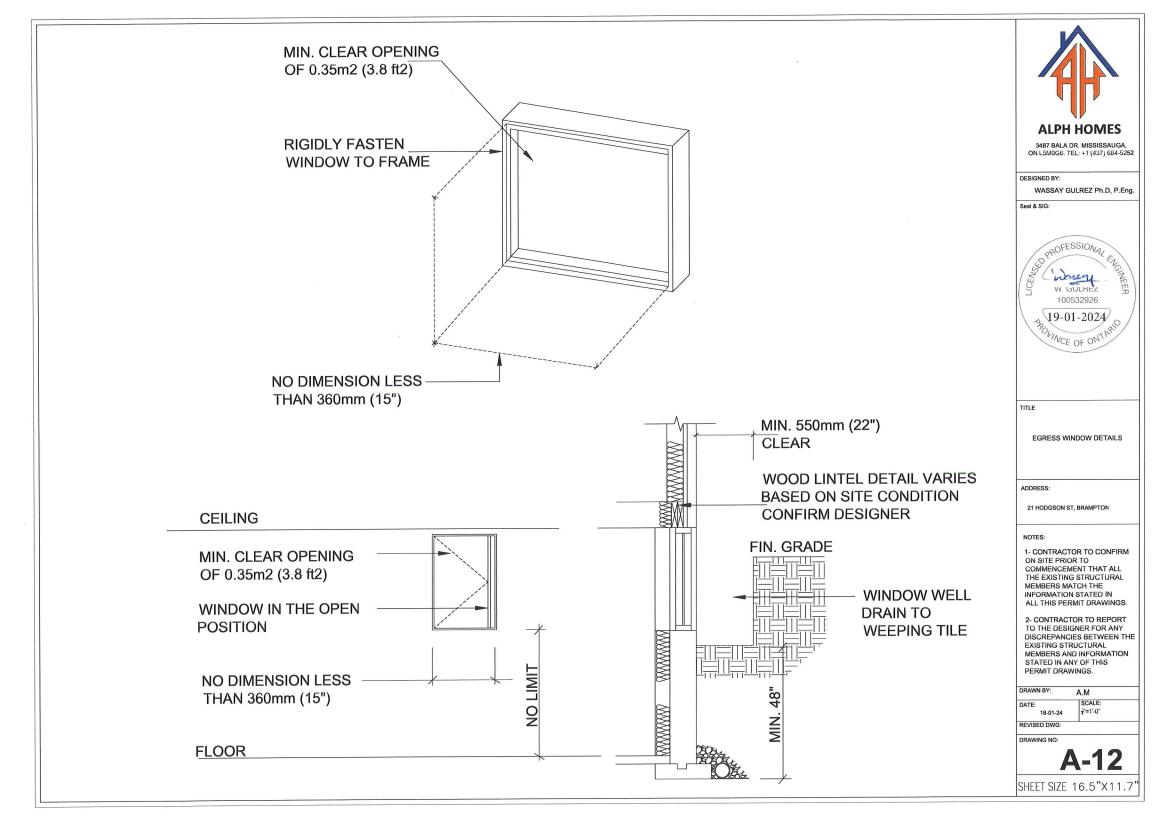
DRAWN BY: A.M

DATE: SCALE: 3"=1"-0"

REVISED DWG:

DRAWING NO:

Δ_1



Zoning Non-compliance Checklist

File No. A-2024- O 202

Applicant:

Limani Albana

Address:

21 Hodgson Street

Zoning:

R1C

By-law 270-2004, as amended

Category	Proposal	By-law Requirement	Section #
USE			
LOT DIMENSIONS AREA / DEPTH / WIDTH			
BUILDING SETBACKS FRONT/ SIDE / REAR	To permit a proposed exterior side yard setback of 2.65 metres to a stairway leading to a below grade entrance.	Whereas the by-law requires a minimum exterior side yard setback of 3 metres.	13.1.2 (f)
BUILDING SIZE			
SIDE DOOR			
COVERAGE			
PARKING	,		
DRIVEWAY			
ACCESSORY STRUCTURE			
ACCESSORY STRUCTURE SIZE / HEIGHT			
MULTIPLE ACCESSORY STRUCTURES			
DRIVEWAY WIDTH			
LANDSCAPE OPEN SPACE	N		
SCHEDULE 'C'			
FENCE HEIGHT			

Rose Bruno Reviewed by Zoning

May 3 , 2024 Date