Flower City



REVISEO.

MAR 2 2 2024

CITY CLERK'S OFFICE

FILE NUMBER:

A-2024-0067

The Personal Information collected on this form is collected pursuant to section 45 of the Planning Act and will be used in the processing of this application. Applicants are advised that the Committee of Adjustment is a public process and the information contained in the Committee of Adjustment files is considered public information and is available to anyone upon request. Questions about the collection of personal information should be directed to the Freedom of Information and Privacy Coordinator, City of Brampton.

APPLICATION Minor Variance or Special Permission

(Please read Instructions)

NOTE: It is required that this application be filed with the Secretary-Treasurer of the Committee of Adjustment and be accompanied by the applicable fee.

The undersigned hereby applies to the Committee of Adjustment for the City of Brampton under section 45 of the <u>Planning Act</u>, 1990, for relief as described in this application from By-Law **270-2004**.

1.	Name of Owner(s)	Binu Mathew A	Abraham& Mercy N	1athew	
	Address		rampton, ON L6X (
	361 SECONDAY - 255 (80-13)		, , , , , , , , , , , , , , , , , , , ,		
	Phone #	(647) 710-7753	3	Fax #	
	Email	binumabraham	@hotmail.com		
			(000 4 1 1 1 1	11.10	
2.	Name of Agent		no (QBS Architects		
	Address	14 Crofton Rd.	Toronto ON, M4G	i 2 B4	
	Phone #	(440) 540 0046	`	Fax #	
		(416) 546-2040			
		saba@qbsarchit	ects.com	_	
3.	Nature and extent o	f relief applied for	(variances requested	D:	
٥.	riataro aria oxioni o	. Tonor applica to	(141.41.600.044.00.04	.,-	
	- Maximum GFA				
	- Minimum Setback to t	he Interior Side Lot Li	ine		
	- Maximum Building He	ight for a garden suite	е		
4.	Why is it not possib	le to comply with	the provisions of the	by-law?	
	It is an existing situation	n			
	- Maximum GFA: 80 se	q. m.			
	- Minimum Setback to	the Interior Side Lot L	ine: 1.8m		
			e in a Residential Hamle	t zone is 7.5 metres or the heigh	nt of
	the principal building, v	whichever is less.			
5.	Legal Description o	f the subject land:			
	Lot Number		Part of lot 5 8		
	Plan Number/Conce	ession Number	Concession		
	Municipal Address		14 River Rd B	Brampton, ON L6X 0A6	
	Dimension of subje	at land (in matric :	·mita)		
6.	Dimension of subje		units)		
	Frontage 48.46				
	Depth 49.86				
	Area <u>2259.3</u>	38 m2			
7	Access to the cubic	not land is by			
7.	Access to the subject	_		Seasonal Road	
	Provincial Highway		片	Other Public Road	H
	Municipal Road Ma		<u>X</u>		H
	Private Right-of-Wa	ıy		Water	

	EXISTING BUILDING	S/STRUCTURES on th	ne subject land: Please refer to the following page
	La verson (section and section		
•	PROPOSED BUILDIN	NGS/STRUCTURES on	the subject land:
			N/A
	and the state of t		,
	WWW.downston.	11-1-0-001-000-00-00-00-00-00-00-00-00-0	
	Loostion of all	huildings and str	weturns on ar proposed for the subject len
		_	ructures on or proposed for the subject lan rand front lot lines in <u>metric units</u>)
	(specify distant	se from Side, rear	and from lot lines in <u>metric units</u>)
	EXISTING		
	Front yard setback	6.98 m	
	Rear yard setback	24.65 m	
	Side yard setback	0.17 m	A CONTRACTOR OF THE CONTRACTOR
	Side yard setback	41.25 m	
	PROPOSED		
	Front yard setback	6.98 m	
	Rear yard setback	24.65 m	
	Side yard setback	0.17 m	A. W. C
	Side yard setback	41.25 m	
	Date of Acquisition	of subject land:	September 14, 2020
	•	-	
	Existing uses of sub	viact proporty:	Residential
	Existing uses of sur	Ject property.	residential
	Proposed uses of su	ubject property:	Residential
	Existing uses of abu	utting properties:	Residential
	•		
	Data of constant the	11	and the second s
	Date of construction	i of all buildings & stru	uctures on subject land: <u>1960</u>
	Length of time the e	xisting uses of the sul	bject property have been continued: 64
a)	What water supply i	s existing/proposed?	
•,	Municipal		Other (specify)
	Well		
			•
	What sewage disposal is/will be provided		
)		7	Other (checifu)
ı)	Municipal]	Other (specify)
)			Other (specify)
	Municipal Septic	e system is existing/p	
o) :)	Municipal Septic	ge system is existing/p	

Swales

EXISTING SECONDARY UNIT INFORM	ATION			
PROP. LEGAL SECONDARY UNIT GROUND FLOOR AR PROP LEGAL SECONDARY UNIT SECOND FLOOR ARE TOTAL: 2	70.36 m² 58.92 m² 129.28 m²	757.38 SF 634.22 SF 1391.60 SF		
PROP. SECONDARY UNIT COVERAGE 74.50/2259.38 = 3.30%				757 SF
SETBACKS EXISTING			1	1 1
SETBACKS	EXISTI	1G	PROPO	SED
SETBACKS	EXISTIN (m)	NG (ft)	PROPO	SED (ft)

17.	ls the subj subdivision	ect property n or consen	the subje	ct of an a	application ι	ınder th	e Planning Act, for approval of a plan of
	Yes	N	lo X				
	If answer is	s yes, provid	de details:	File #	#	· 	Status
18.	Has a pre-	consultation	applicatio	n been fil	ed?		
	Yes	N	lo X				
19.	Has the su	bject prope	ty ever bee	en the sul	bject of an a	pplication	on for minor variance?
	Yes	N	lo x		Unknown		
	If answer is	s yes, provid	de details:				
	File# File#		Decision_				Relief
	File #		Decision _ Decision _				Relief
						Sa	Bai
					Si	gnature	of Applicant(s) or Authorized Agent
	ED AT THE						
THIS	S	DAY OF _			_ , 20		
HE APP	LICANT IS	A CORPO	RATION, T	HE APP		SHALL FIXED.	IST ACCOMPANY THE APPLICATION. IF BE SIGNED BY AN OFFICER OF THE
IN THE	′ <u></u>	OF			' SOLEMNL'	— Y DECL	ARE THAT:
BELIEVIN DATH.		TRUE AND					EMN DECLARATION CONSCIENTIOUSLY ORCE AND EFFECT AS IF MADE UNDER
	OF		1				
N THE			OF				
	THIS		DAY OF				
	_	, 20 .				Signatur	e of Applicant or Authorized Agent
		•	i 1 1 1 1			-	
	A Commis	sioner etc.					
			·				
				FOR OF	FICE USE O	NLY	
		fficial Plan [oning By-lav				-	
			een reviewe	ed with re	spect to the v		s required and the results of the checklist.
		Zoning	Officer	1,444		_	Date
		Zoning	Omo o i				

DATE RECEIVED ______ Revised 2023/01/12

APPOINTMENT AND AUTHORIZATION OF AGENT

To The Secretary-Treasurer
Committee of Adjustment
City of Brampton
2 Wellington Street West
Brampton, Ontario
L6Y 4R2
Cos Berampton ca

LOCATION OF THE SUBJECT LAND	14 River Rd Brampton, ON L6X 0A6
I/We. Binu Mathew Abraham& Me	
ple:	ase print/type the full name of the owner(s)
the undersigned, being the registered of	wner(s) of the subject lands, hereby authorize
Saba Al Mathno (QBS	3 Architects INC)
piease pi	rinthype the full name of the agent(s)
to make application to the City of E application for minor variance with res	Brampton Committee of Adjustment in the matter of an pect to the subject land
Dated this 21 day of Februa	, 20 <u>24</u>
(signature of the owner(s) or where the o	wher is a firm or corporation, the signature of an officer of the owner.)
MAN	
(where the owner is a firm or corpo	ration, please print or type the full name of the person signing.)

NOTE: If the owner is a firm or corporation, the corporate seal shall be affixed hereto.

PERMISSION TO ENTER

The Secretary-Treasurer
Committee of Adjustment
City of Brampton
2 Wellington Street West
Brampton, Ontario
L6Y 4R2
sea@brampton.ca

LOCATION OF THE SUBJECT LAND _	14 River Rd Brampton, ON L6X 0A6		
I/We,	Binu Mathew Abraham& Mercy Mathew		
pica	ise printitype the full name of the owner(s)		
the City of Brampton Committee of Adj	winer(s) of the subject land, hereby authorize the Members of justment and City of Brampton staff members, to enter upon se of conducting a site inspection with respect to the attached prisent		
Dated this 21 day of Februa	ary . 20 <u>24</u>		
(signature of the owner(s), or where the ov	wher is a firm or corporation, the signature of an officer of the owner.)		
(where the owner is a firm or corpor	ration, please print or type the full name of the person signing)		

NOTE: If the owner is a firm or corporation, the corporate seal shall be affixed hereto.

NO DISCUSSION SHALL TAKE PLACE BETWEEN THE COMMITTEE MEMBERS AND THE APPLICANT DURING THE SITE INSPECTION

Flower City



FILE NUMBER: A 2024-0067

The Personal Information collected on this form is collected pursuant to section 45 of the Planning Act and will be used in the processing of this application. Applicants are advised that the Committee of Adjustment is a public process and the information contained in the Committee of Adjustment files is considered public information and is available to anyone upon request. Questions about the collection of personal information should be directed to the Freedom of Information and Privacy Coordinator, City of Brampton.

APPLICATION Minor Variance or Special Permission

(Please read Instructions)

NOTE: It is required that this application be filed with the Secretary-Treasurer of the Committee of Adjustment and be accompanied by the applicable fee.

The undersigned hereby applies to the Committee of Adjustment for the City of Brampton under section 45 of the <u>Planning Act</u>, 1990, for relief as described in this application from By-Law **270-2004**.

1.	Name of Owner(s) Binu Mathew Abraham& Mercy M	athew
	Address 14 River Rd Brampton, ON L6X 0.	
	Phone # (647) 710-7753	Fax #
	Email binumabraham@hotmail.com	-
2.	Name of Agent Saba Al Mathno (QBS Architects	INC)
	Address 14 Crofton Rd, Toronto ON, M4G	
	Phone # (416) 546-2040	Fax #
	Email saba@qbsarchitects.com	
	O .	
3.	Nature and extent of relief applied for (variances requested)	:
	Proposed ground floor addition does not comply with the m	
	12.0 metres	
	Proposed front yard landscaping does not comply with the	minimum 70% required front yard
	landscaping.	minimani 7070 required front yard
4.	Why is it not possible to comply with the provisions of the b	ov-law?
₹.	The proposed addition lines up with the edge of the	
	the allowable setback	
5	Legal Description of the subject land:	
0.	Lot Number Part of lot 5 &	6
	Plan Number/Concession Number Concession 5	
	Municipal Address14 River Rd Br	rampton, ON L6X 0A6
6.	Dimension of subject land (in metric units)	
	Frontage 48.46 m	
	Depth 49.86 m	
	Area <u>2259.38 m2</u>	,
7.	Access to the subject land is by:	Second Pool
	Provincial Highway Municipal Road Maintained All Year	Seasonal Road Other Public Road
	Private Right-of-Way	Water

8.

	EVICTING DAY 55:0	O/OTDI IOTUDEO	Aho andria Ahondi	
	EXISTING BUILDING	SS/STRUCTURES on t	Please refer to the following page	
	PROPOSED BUILDIN	NGS/STRUCTURES o	on the subject land: Please refer to the following pag	 ge
9.		_	tructures on or proposed for the subject lan or and front lot lines in <u>metric units</u>)	ıds
	EXISTING Front yard setback Rear yard setback Side yard setback	3.88 m 28.80 m		
	Side yard setback	(right) 6.61 m (left)30.14 m		
	PROPOSED Front yard setback Rear yard setback Side yard setback	2.60 m 27.52 m (right): 6.61 m		,
10.	Side yard setback Date of Acquisition	(left): 16: 20 m	September 14, 2020	
11.	Existing uses of sub	oject property:	Residential	
12.	Proposed uses of si	ubject property:	Residential	
13.	Existing uses of abu	utting properties:	Residential	/
14.	Date of construction	n of all buildings & st	ructures on subject land: <u>1960</u>	
15.	Length of time the e	existing uses of the su	ubject property have been continued: 64	
6. (a)	What water supply i Municipal Well	is existing/proposed?	Other (specify)	
	What sawara diana	sal is/will be provided	d?	
(b)	Municipal Septic		Other (specify)	

Existing building (main house):

ground floor area: 155.62sm gross floor area: 218.47sm

number of storeys: above grade 2, below grade 1

width: 10.65m length: 17.21m height: 7.21m

Existing secondary unit:

ground floor area: 64.00sm gross floor area: 123.32sm

number of storeys: above grade 2 (existing to remain)

width: 12.24m length: 6.29m height: 8.29m

Proposed building (main house):

ground floor area: 300.59sm gross floor area: 417.65sm

number of storeys: above grade 2, below grade 1 (existing to

remain) width: 16.14m length: 18.55m

height: 7.21m (existing to remain)

Proposed secondary unit:

ground floor area: 82.70sm gross floor area: 156.56sm

number of storeys: above grade 2 (existing to remain)

width: 13.88m

length: 6.29m (existing to remain) height: 8.29m (existing to remain)

17.	subdivision or consent?	of an application un	der the Planning Act, for approval of a plan of
	Yes No X		
	If answer is yes, provide details:	File #	Status
18.	Has a pre-consultation application	been filed?	
	Yes No X		
19.	Has the subject property ever been	the subject of an app	plication for minor variance?
	Yes No x	Unknown	
	If answer is yes, provide details:		
	File # Decision File # Decision		Relief Relief
	File # Decision		Relief
			Sobor Con
	Chi	Ω	nature of Applicant(s) or Authorized Agent
DATI	ED AT THE COM	OF DIA	mpron.
THIS	DAY OF FEDRU	any, 20 24,	,
THE SUB-	JECT LANDS, WRITTEN AUTHORIZ	ATION OF THE OWNE	ANY PERSON OTHER THAN THE OWNER OF ER MUST ACCOMPANY THE APPLICATION. IF IALL BE SIGNED BY AN OFFICER OF THE XED.
	Burn Malley Mo	wham.	City Branch
IN THE	Raionor Peel	,	DECLARE THAT:
			S SOLEMN DECLARATION CONSCIENTIOUSLY AME FORCE AND EFFECT AS IF MADE UNDER
DECLARE	D BEFORE ME AT THE		
City	of Brampton.		
IN THE	Rayon of		()
Peel	THIS DAY OF	(
Febr	rang, 20 D.Y	Siç	gnature of Applicant or Authorized Agent
$\bigcap_{\mathcal{U}}$	Clara Van a Commis	i sioner, etc.,	
	A Commissioner etc	of Ontario,	
	City of Bra	rporation of the ampton	
	Expires S	FOR OFFICE USE ON	LY
	Present Official Plan Designation:		
	Present Zoning By-law Classificati	ion:	RHM1
		with respect to the var are outlined on the atta	riances required and the results of the ached checklist.
	Connor Cowan		2024-02-28
	Zoning Officer		Date

DATE RECEIVED_

APPOINTMENT AND AUTHORIZATION OF AGENT

To The Secretary-Treasurer
Committee of Adjustment
City of Brampton
2 Wellington Street West
Brampton, Ontario
L6Y 4R2

LOCATION OF THE SUBJECT LAND

14 River Rd Brampton, ON L6X 0A6

I/We, Binu Mathew Abraham& Mercy Mathew
please print/type the full name of the owner(s)

the undersigned, being the registered owner(s) of the subject lands, hereby authorize
Saba Al Mathno (QBS Architects INC)
please print/type the full name of the agent(s)

to make application to the City of Brampton Committee of Adjustment in the matter of an application for minor variance with respect to the subject land

Dated this 21 day of February .2024

(signature of the owner(s) or where the owner is a firm or corporation, the signature of an officer of the owner)

(where the owner is a firm or corporation, please print or type the full name of the person signing.)

NOTE: If the owner is a firm or corporation, the corporate seal shall be affixed hereto.

PERMISSION TO ENTER


To The Secretary-Treasurer
Committee of Adjustment
City of Brampton
2 Wellington Street West
Brampton, Ontario
L6Y 4R2
csa@trampton.ca

LOCATION OF THE SUBJECT LAND _	14 River Rd Brampton, ON L6X 0A6	
l/We,	Binu Mathew Abraham& Mercy Mathew	
pica	ise printitype the full name of the owner(s)	
the City of Brampton Committee of Adj	wher(s) of the subject land, hereby authorize the Members of justment and City of Brampton staff members, to enter upon se of conducting a site inspection with respect to the attached onsent	
Dated this 21 day of Februs	ery , 20 <u>24</u>	
M Clyl	wher is a firm or corporation, the signature of an officer of the owner.)	
Antigen and produced to be selled by the bible	ration, please print or type the full name of the person signing)	

NOTE: If the owner is a firm or corporation, the corporate seal shall be affixed hereto.

NO DISCUSSION SHALL TAKE PLACE BETWEEN THE COMMITTEE MEMBERS AND THE APPLICANT DURING THE SITE INSPECTION



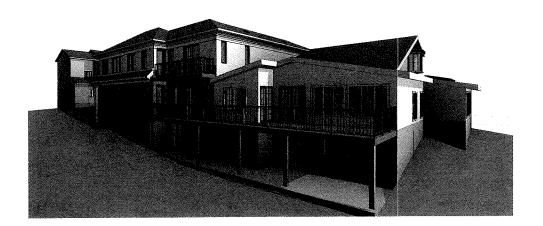


ARCHITECTURAL SHEET LIST			
Sheet Number	Sheet Name	Current Revision	
A0-00	ICOVER	1016	
A0-01	PERSPECTIVE	016	
A0-02	SITEPLAN	016	
40.05	SURVEY	016	
A0.06	LOT AREA AND COVERAGE	016	
A0-07	FLOOR AREA PLAN	016	
AO-OR	LANDSCAPE AREA PLAN	016	
40.09	SECONDARY UNIT FLOOR AREA PLAN	013	
A0.10	CONSTRUCTION NOTES	016	
A1-00	PROP. FOUNDATION PLAN	1016	
A1-01	PROP, UNFINISHED BASEMENT	016	
A1-02	PROP. GROUND FLOOR	016	
A1-03	PROP. SECOND FLOOR	016	
A1-04	PROP, ROOF PLAN	016	
A1-05	PROP. SECONDARY UNIT FOUNDATION PLAN	014	
A1-06	IPROP, SECONDARY UNIT GROUND FLOOR PLAN	014	
A1-07	PROP. SECONDARY UNIT SECOND FLOOR	014	
A1-08	PROP, SECONDARY UNIT ROOF PLAN	014	
A2-01	PROP. FRONT AND REAR ELEVATION	016	
A2-02	PROP. SIDE ELEVATION	015	
A2-03	PROP SECONDARY UNIT FRONT AND REAR ELEVATION	013	
A2-04	PROP. SECONDARY UNIT RIGHT AND LEFT ELEVATION	013	
A3-01	INTOP, GECTION	010	
A3-02	PROP, SECONDARY UNIT SECTION	013	
A6-01	DOOR WINDOW SCHEDULE & WALL ASSEMBLIES	016	
A4-02	DETAILS	016	
A5-01	EXISTING BASEMENT	015	
AS-02	EXISTING GROUND FLOOR PLAN	016	
A5-03	EXISTING SECOND FLOOR PLAN	016	
A5-04	EXISTING ROOF PLAN	016	
A5-05	EXISTING SECONDARY UNIT GROUND FLOOR PLAN	013	
A5-06	EXISTING SECONDARY UNIT FIRST FLOOR PLAN	013	
A5-07	EXISTING SECONDARY UNIT ROOF PLAN	013	
A6-01	EXISTING FRONT AND REAR ELEVATION	016	
A6-02	EXISTING SIDE ELEVATION	016	
A6-03	EXISTING SECONDARY UNIT SIDE ELEVATION	013	
A6-04	EXISTING SECONDARY UNIT FRONT & REAR ELEVATION	013	
Grand total: 3	,		

14 RIVER ROAD

BRAMPTON, ON L6X 0A6

Owner

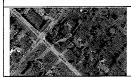

No.	Description	Date
016	ISSUED FOR COFA	02/14/2024
015	REISSUED FOR BULDING PERMIT	02/14/2024
013	ISSUED FOR BUILDING PERMIT	12/01/2023
011 04	ISSUED FOR CLIENT	11/06/2023
Q4	ISSUED FOR ZONING REVIEW	02/17/2023
02	REISSUED FOR REVIEW	10/21/2022
01	ISSUED FOR CVC	05/27/2022

Discrepancies must be reported immediately to the Architect before proceeding. Only figured dimensors a to be used. Contractors must check all dimensions on site. This drawing is protected by copyright.

ALL DIMENSIONS ARE SHOWN IN IMPERIAL & METRIC



COVER

SA
11/03/2

PROJECT NO.

200155

COFA A0-00

LOCATION HALTON HILLS 016



14 RIVER ROAD BRAMPTON, ON L6X 0A6

Owner



No.	Description	Date
016	ISSUED FOR COFA	02/14/2024
015	REISSUED FOR BUILDING PERMIT	02/14/2024
013	ISSUED FOR BUILDING PERMIT	12/01/2023
04	ISSUED FOR ZONING REVIEW	02/17/2023
02	REISSUED FOR REVIEW	10/21/2022
01	ISSUED FOR CVC	05/27/2022

CONSULTANTS





TORONTO - CANADA 416.546.2040

DRAWING TITLE

PERSPECTIVE


DRAWN	CHECKED
PP	SA
SCALE @ ARCH D	DATE
	10/20/22


200155

PROJECT NO.

COFA A0-01

LOCATION HALTON HILLS 016

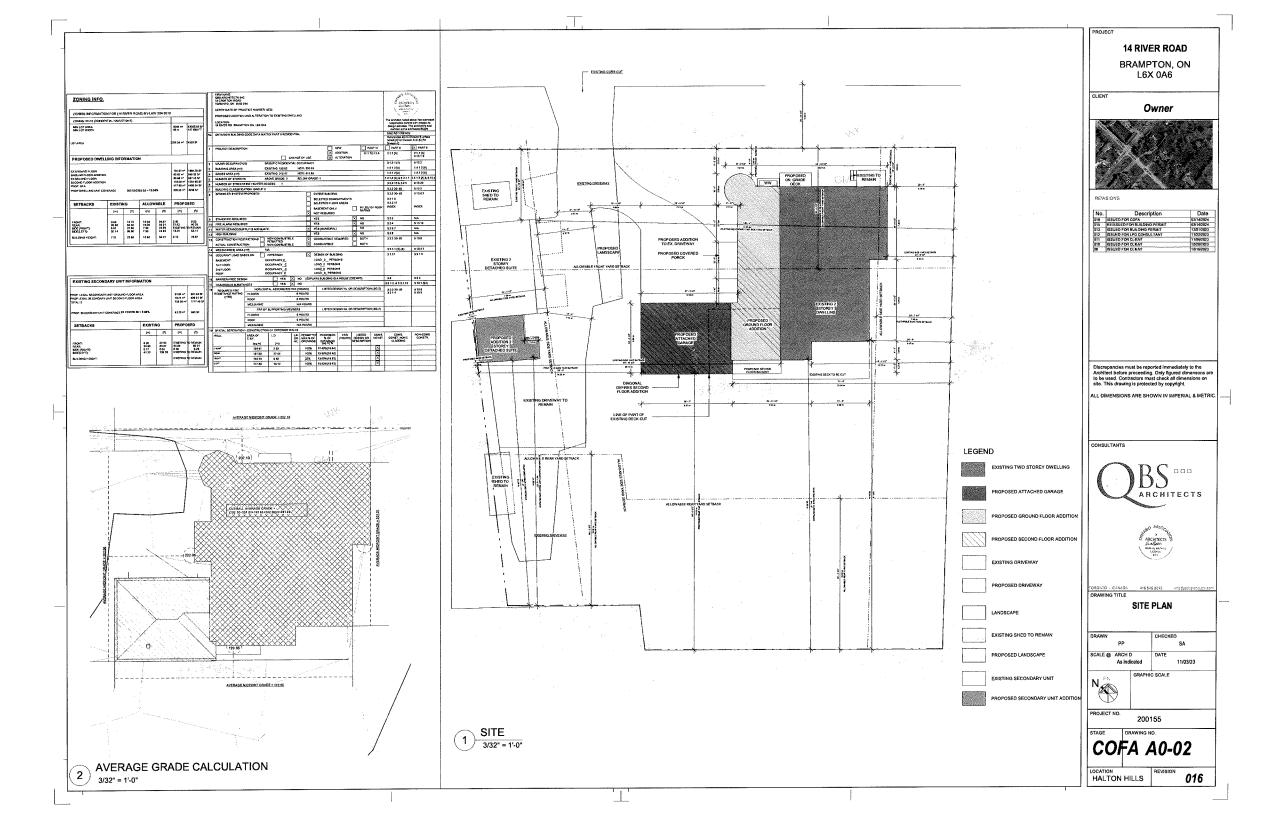

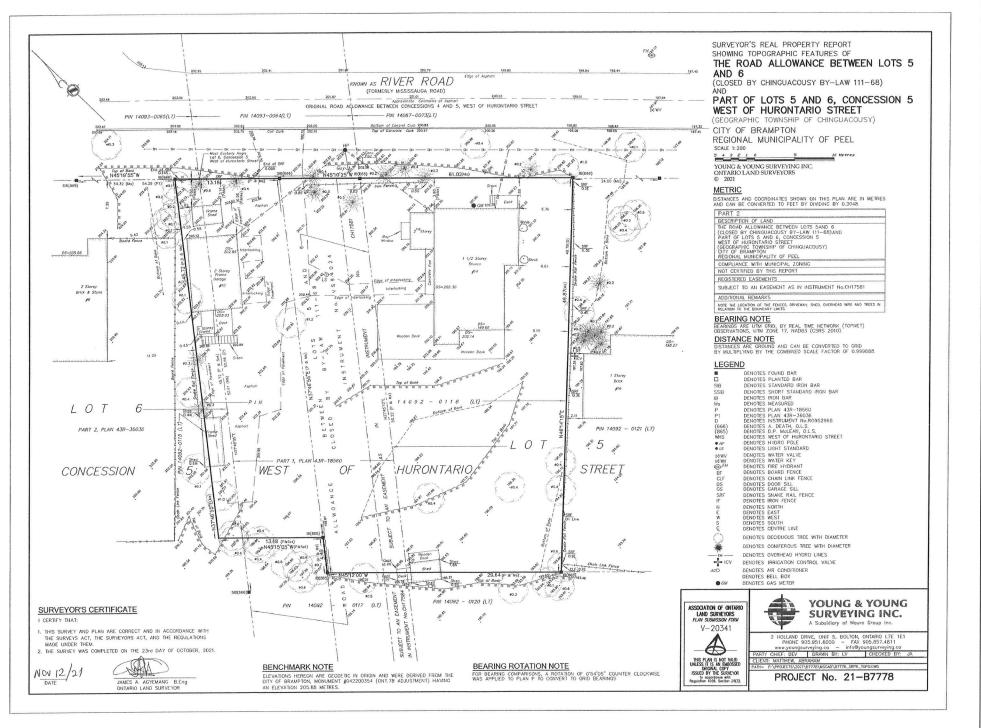

PROJE

14 RIVER ROAD

BRAMPTON, ON L6X 0A6

CLIENT

Owner



REVISIONS

No.	Description	Date
016	ISSUED FOR COFA	02/14/2024
)15	REISSUED FOR BUILDING PERMIT	02/14/2024
113	ISSUED FOR BUILDING PERMIT	12/01/2023
)6	ISSUED FOR BUILDING PERMIT	06/22/2023
и	ISSUED FOR ZONING REVIEW	02/17/2023
_		_

Discrepancies must be reported immediately to the Architect before proceeding. Only figured dimensions a to be used. Contractors must check all dimensions on

ALL DIMENSIONS ARE SHOWN IN IMPERIAL & METRIC.

CONSULTANTS



TORONTO - CANADA 416.545.2840 info@qbs.airchbirots

DRAWING TITLE

SURVEY

SURVEY


DRAWN	CHECKED
PP	SA
SCALE @ ARCH D	DATE 10/20/22
	GRAPHIC SCALE

PROJECT NO.

200155


COFA A0-05

HALTON HILLS

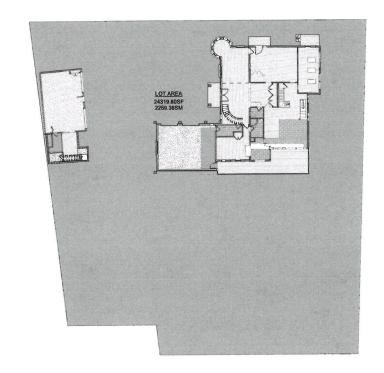

1 LOT AREA
1/16" = 1'-0"

LOT AREA 24320 SF LOT AREA 2259.38 m²

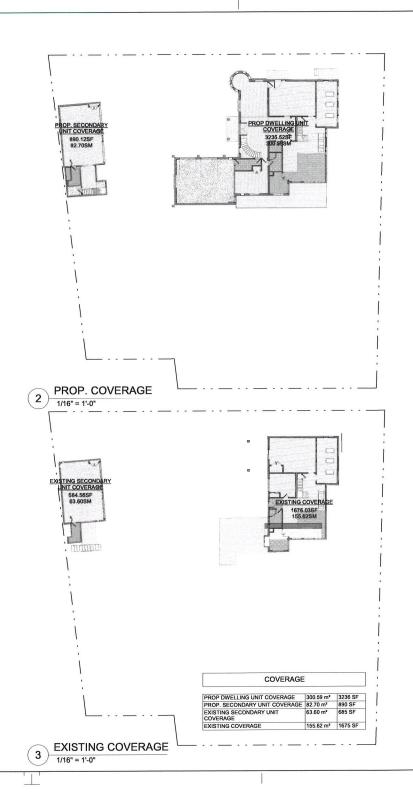

14 RIVER ROAD BRAMPTON, ON L6X 0A6

CLIENT

Owner



REVISIONS

No.	Description	Date
016	ISSUED FOR COFA	02/14/2024
015	REISSUED FOR BUILDING PERMIT	02/14/2024
013	ISSUED FOR BUILDING PERMIT	12/01/2023
06	ISSUED FOR BUILDING PERMIT	06/22/2023
04	ISSUED FOR ZONING REVIEW	02/17/2023

Discrepancies must be reported immediately to the Architect before proceeding. Only figured dimensons are to be used. Contractors must check all dimensions on site. This drawing is protected by copyright.

CONSULTANTS





DRAWING TITLE

LOT AREA AND COVERAGE


DRAWN		CHECKED
PP		SA
SCALE @ ARCH 1/16	D ' = 1'-0"	DATE 02/09/23
	GRAPH	IC SCALE





200155

COFA A0-06

LOCATION HALTON HILLS

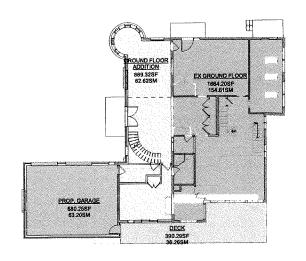

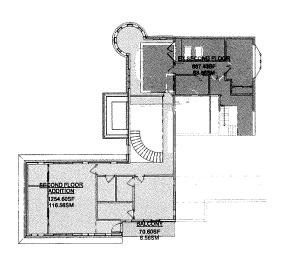

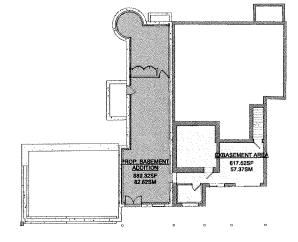

GROUND FLOOR-PROPOSED

1" = 10'-0"

2 SECOND FLOOR-PROPOSED

BASEMENT-PROPOSED

1" = 10'-0"


PROJECT

14 RIVER ROAD

BRAMPTON, ON . L6X 0A6

CLIENT

Owner

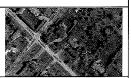

REVISION

No.	Description	Date
016	ISSUED FOR COFA	02/14/202
015	REISSUED FOR BUILDING PERMIT	02/14/202
013	ISSUED FOR BUILDING PERMIT	12/01/202
011	ISSUED FOR CLENT	11/06/202
08 04	ISSUED FOR CLIENT	10/16/202
O4	ISSUED FOR ZONING REVIEW	02/17/202

Discrepancies must be reported immediately to the Architect before proceeding. Only figured dimensions are to be used. Confractors must check all dimensions on site. This drawing is protected by copyright.

ALL DIMENSIONS ARE SHOWN IN IMPERIAL & METRIC.

CONSULTANTS





TORONTO - CANADA 416 546 2040 info@gourretrasis

ORAWING TITLE

FLOOR AREA PLAN

PP	SA
	071
SCALE @ ARCH D	-0" DATE 11/03/2



GRAPHIC SCALE

PROJECT NO. 200155

COFA A0-07

LOCATION HILLS REVISION 016

FRONT YARD LANDSCAPING CALCULATION

DRIVEWAY

FRONT YARD SOFT LANDSCAPING

HARD SURFACE

PORCH

Area	Schedule (Front Yard Area - Pr	oposed)
Name	Are	AREA M2
DODOWAY	Tithe SF	166.14 m²
RONT YARD SOFT LANDSCAPING	2746 55	255.12 =*
HARD BURFACE	60 F	59.77 m²
PORCH	121 5	1126

	SQFT	SQM
TOTAL FRONT YARD AREA	5299	492.29
FRONT YARD SOFT LANDSCAPING AREA	2746	255.12
FRONT YARD SOFT LANDSCAPING RATIO	2756/5299 = 52.00%	



PROJE

14 RIVER ROAD

BRAMPTON, ON L6X 0A6

CLIENT

Owner



REVISIONS

No.	Description	Date
016	ISSUED FOR COFA	02/14/2024
015	REISSUED FOR BUILDING PERMIT	02/14/2024
013	ISSUED FOR BUILDING PERMIT	12/01/2023
04	ISSUED FOR ZONING REVIEW	02/17/2023

Discrepancies must be reported immediately to the Architect before proceeding. Only figured dimensons ar to be used. Contractors must check all dimensions on

ALL DIMENSIONS ARE SHOWN IN IMPERIAL & METRIC.

CONSULTANTS





TORONTO - CANADA 416.546.2040 info@qbtatc

DRAWING TITLE

LANDSCAPE AREA PLAN

DRAWN	CHECKED
PP	SA
SCALE @ ARCH D	DATE



PHIC SCALE

PROJECT NO.

200155

COFA A0-08

LOCATION HALTON HILLS

CONSTRUCTION NOTES

PURITY EDICHMATION SHALL BE UNDERTAKEN IN SUCH A MANNER AS TO PRETYEN MOVEMENT WHICH WOULD CAUSE DIMAGE TO ADMICIST PROPERTY, EXISTING STRUCTURES, UTILITIES, ROADS, AND SECWALKS, AT ALL STAGES OF CONSTRUCTURE. WHERE THE DEPTH OF EXCAVATION EXCEEDS 4-0° EXCAVATE AT A 45 do ANGLE OR IN ACORDANCE WITH APPROVED BHORING DETAIL. STRUCTURE IS NOT TO BE LOCATED ON GROUNDS HAVING A SLOPE STEEPER THAN ONE VERTICAL TO TWO HORIZONTA.

(2) EDOTING 3) DODING 19 TO SERVICE OF SERVIC

- APPLY 12" CLEAR STONE COVER OVER WEEPING TILES
- BACYTLL WITH GRANLLAR B MATERIAL APPLED IN 20" LET'S
- PROVIDE 12" LAYER OF COMPACTED TOP SOL SLOPPED MY FROM FOUNDATION WALL

S EXAMAZION MAIL.

IN N. OF FREE DRAINING GRANILIAN MATERIAL, AND A B.M.E.C. APPROVED DRAINING LAYER BUDY AS TOUT TO ME TO A TOUT TO ME TO A TOUT TO A TOUT

(8) FOLHOLATION BE FOUNDED ON NATIVE, INORGANIC, UNDISTURBED BOX, CAPABLE OF SUSTEMING MINIBAUM 2000 per OF ALL OWARLE BEARING PRESSURE. SLOPE BETWEEN STEPPED OR ADJACENT FOOTINGS SHALL HAVE A MAXIMUM OF 7 VERTICAL AND 10 HORIZONTAL AND STEPS SHALL NOT EXCEED 2-5" VERTICALLY. EXTERIOR FOOTINGS WILL BE FOUNDED AT A LEVEL AT LEAST 4-0" BELOW FINISHED GRADE.

CONCRETE N. AR ON GRADE DOMESTIES MAIN GRAME.

MACHINET ROWLED OF POLICED CONCRETE WITH A MINIMAN COMPRESSIVE STRINGATION OF SURFAMILIES. THE MAIN CONCRETE SAFETY OF SURFAMILIES AND SURFAMILIES.

(7) WEEPING TILES - 4" DIA CONRUGATED PLASTIC WEEPING TLE WIFE TER 15000" (TERRAFIX 270R OR SMELAT PORTOUS FIBRE GEOTEXTEE) SET AT BOTTOM OF FOOTING SURROUND WEEPING TILE WITH 12" MIN. LAYER OF 34" MZE CLEAR LIMESTONE AND SUBSEQUENTLY WRAPPED IN A SECOND LAYER OF MON CLOGGING GEOTEXTILE FILTER OF 10TH. - SLOPE WEEPING THE TO FROST FREE SUMP PIT & PUMP OR TO DRAIN, NOTE: PROMOE ACCESS FOR WEEPING THE CLEAN OUT AT MAMERICUS LOCATIONS.

NOTE: CONTRACTOR TO SUPPORT LARGE SLAB AREAS WITH IF DIA. SONO TUBE. FOUNDATIONS OW REBAIL TYPING SLAB TO SONO TUBE.

SLOPE TO DEAIN BE MINIMAN 1 % SLOPE TO SPLATE.

 EXPOSED FOURBATION MAIL

 # If YOR YNSHESS SOCIOTION TO IT COMMERTE IS, COX (MORTAN FILL SPACE

 # If YOR YNSHESS SOCIOTION WALL

 # INTO ALL YOUR SOCIOTION WALL

 * INTO ALL YOUR SOCIETY

 * INTO ALL (B) BELLATIO FOLKMANDA MAT.

- HAR "FO" FREE DORANGE GUAULUM MATERIA, NAO A M.E.C. APPROVED DINANGE
L'OCATA SAPPAT MARAGON

- 120 "CERRITA TRANSPOR CONTO DURE FOOTING AND TO I" MOVIE GIAVOR EXCEPT AS
OTHERSMENT OF MICHIGANIS AND REPROVINCIALISM AS NOTED IN FAMILY CANADA

- 120 "CERRITA" TRANSPOR CONTO DURE FOOTING AND TO I" MOVIE GIAVOR EXCEPT AS
OTHERSMENT OF MICHIGANISM AND REPROVINCIALISM AS NOTED IN FAMILY CANADA

- 121 "EN CONTO A TO CO. CAMPROPORTIO AND THE OTHER TO A THE TO GIAVANO

- 121 EN CONTO A TO CO. CAMPROPORTIO AND THE OTHER TO GIAVANO

- 121 EN CONTO AND TO CO. CAMPROPORTIO AND THE OTHER TO GIAVANO

- 121 EN CONTO AND THE CO. CAMPROPORTIO AND THE OTHER TO GIAVANO

- 121 EN CONTO AND THE CO. CAMPROPORTIO AND THE OTHER THE OTHER CONTO

2 24 S STUDS AT 18°D C DAMPRIOD PRO LATE. TO THE STUDY OF STUDY OF STUDY DATE OF STUDY DATE.

NOT THRUSH.

IF I SECOND AND SECOND AND COLUMN TO THE SECOND AND COLUMN

197 OWNALL SP "THING WHALL WAILS SEED ON BLOSS HOME WHALL SP CONTINUED HIS ARROWS HAVE NOT SEED OF THE SEED OF THE

THE STATE OF THE S

(1) STLECO EXTERIOR MALL:

JOHTS AS PER ROLLISTIN STANCING MID AS PER ELEVATIONS SEE ELEVATIONS:

JOHTS AS PER ROLLISTIN STANCING WINDOW AND DOOR CARNING, MELL CHOWN

MID LOOP AND RADROMS - POLICIES CONCRITE THEREOF AD GR P CUT INSTERIOR SELL

AT ALL DOORS-ASE ELEVATIONS

OSE TIMES OUT AT JOHN STUCKO, COLOUR AND FINISH TO BE SELECTED BY COS FINEST COAT ACTIVIST STUDOCO, COLOUR AND I WAS TO BE EXCELLED BY MANY THE ACTIVIST STUDOCO, COLOUR AND I WAS TO BE EXCELLED BY MANY THE ACTIVIST ACTIVIST AND CORRESPOND CONTRIBUTION BOAD GRAVED BY THE ACTIVIST ACTIV

Without Section And College Assertance (
Description of Description of College Assertance (
Description of Description o

(S) CURVED CORNER BEAD.

-FLEDDILE CORNER BEAD AT RADIUSED DRYWALL EDGES MUST BE USED.

- 3M*X 2 NF SELECT RED GAX T & G STRIP FLOORING - BLIND NAL TO EXISTING I NEW SUBFLOOR, INSTALL WAXED BUILDING PAPER GYER SUBFLOOR PROOR (USE PREFWISHED HARDWOOD FLOORING - CONFIRM WI OWNER / ARCHITECT)

AND MILE OF THE CORN TO EXPOSE NATURAL WOOD USING THREE (I) STAGE SANDING PROCESS.

- NOW STEP PLOORING TO EXPOSE NATURAL WOOD USING THREE (I) STAGE SANDING PROCESS.
- NOW WITH 100 DOTF PARTY.
- NOT NO SEALED TO BE USED.

(T) DISTING HARDWOOD FLOORING ISENDATION

-SNO DISTING STAP FLOORING AND IN FLIT TO DOOSE NATURAL WOOD USING THREE BY STARS FROORING. IN PARK BY MARKED,

-ARRY THREE BY CONTROL FOR FLOORING WARRAND,

-ARRY THREE BY CONTROL FOR FLOORING WARRAND,

NOT BY OS SELECT FOR BUSING.

LANGELIMEER

LAY ASPALT SHEATHING PAPER, FELT OR POLYETHYLENE F.M.
-CALVANZED WINE MESS (2" X 7"), SCRATCH CEMENT COAT (1 M" MIN THOCK)
-TIMO / GROUNTHS (COC OUT TO BE CETERAINED)
-NOTE: APPLY 2 COATS OF SEALER FOR STONE FLOORING (AS PER
SUPPLIER'S MANUFACTURER'S SPECEFICATION.

CONTINUOUS 2 - 2 X 10 OR AS PER PLANS GLUED LEDGER BOLTED WITH STAGGERED SIF DIA, RAM SET RED HEAD DYNA BOLTS @ 18" O.C. - MIN. 2 1/2" EUREDMENT IN EDISTING SOLID MACONTY WALL.

Displacements and Chinocola (Lond Made)

If the place interpolate in the control of the control

AND CONTRACT IN A CONTRACT IN

THE CHARGE ALONG ALONG AND ADDRESS OF A STATE OF THE STAT

IMPORTANT NOTE: THE ABOVE IS A QUIDE LINE. INSTALLER MUST FOLLOW MAN IF ACTURES INSTALLATION INSTRUCTIONS ASSOCIATED WITH THE PRODUCT

(F) BANDO SERVICIONE

(F) BANDO SERVICIONE

ATTO FOR THE TOP OF TH

O CONTROL CONTROL STREET, A AND SE A AND THE CONTROL C

) SOFFIT

- PREPINSHED ALUMINUM SOFFIT WITH INSECT SCREENING
- LAY ALUMINUM PANELS WITH CORRUGATIONS PERPENDICULAR TO FASCIA
- SEE PLANS FOR OVERHANG DIMENSION.

(8) DEBIGILATION
- DEAD LADAT TOP CHARD 9 LB / BOTT
- DEAD LADA T TOP CHARD 9 LB / BOTT
- LDE LOD STANDAMON AS PER LOCAL MANAGEM, REQUIREMENTS (MALESS NOTED
- LOT EXTERNOR GRADE PL, YMOOD BHEATH-NO WITH CUPS
- LOT EXTERNOR GRADE PL, YMOOD BHEATH-NO WITH CUPS

(27) BOOMATTIC VENTRATION SOOPLITEC VERTILATION

CONTINUED TO PROVIDE ADDIQUATE VENTILATION AT BOTH NEW
AND DISTRIPS STRUCTURE. HEN VENTILATED, 1999 (1999 FOR FLAT ROOFS) OF
BULLATION CERN, ANAME, INSURE PROSECT SOFTER

-VENTS TO BE UNYORANY, DISTRIBUTION
-INTERIOR PROVIDENT VENTILATION FOR THE PLACED AT FRONT
ELEVATION FROOT INTERIOR STRUCTURE VENTILATION FOR THE PLACED AT FRONT
ELEVATION FROOT INTERIOR STRUCTURE VENTILATION FOR THE PLACED AT FRONT
ELEVATION FROOT INTERIOR STRUCTURE VENTILATION FOR THE PLACED AT FRONT
ELEVATION FROOT STRUCTURE VENTILATION FOR THE PLACED AT FRONT
ELEVATION FROOT STRUCTURE VENTILATION FOR THE PLACED AT FRONT
ELEVATION FROOT STRUCTURE VENTILATION FROM THE PLACED AT FRONT
ELEVATION FROOT STRUCTURE VENTILATION FROM THE PLACED AT FRONT
ELEVATION FROOT FROM THE PLACED AT FRONT
ELEVATION FROM THE PLACED AT FRONT FR - DECK ELEVATION
LOCATIONS
- SOFFIT VENTS TO BE INSECT SCREENED
- COLOUR OF ROOF VENTS TO MATCH SHINGLES.

(28) INSULATED INTERIOR WALL / ISBLATE CONTROL OF THE CONTROL OF

(2) BRILATION ON DOWN'S MALL

-YOU SHAPMAN FRI TO GROUP

-YA STUDEN AT YOUR

-DAMPHOCOPPIOL LATER BLACK POLY BRILOW STUD PLATE

- STUDEN HIS BRACK POLY BRILOW STUD PLATE

- STUDEN HIS BRACK POLY BRILOW STUDENTS

- STUDENT HIS BRACK POLY BRACK POLY BRILOW STUDENTS

- STU

(30) ACQUISTICAL TREATMENT.

-4" SOUND ATTENUATION BLANKET INSTALLED BETWEEN STUDS
-TYPICAL BETWEEN BEDROOMS AND BATHS

(31) BEARING STUD WALL

3 X 4 STUDS AT 15" O.C. (W) DOUBLE PLATES)

- 52" DRYWALL ON ONE SIDE.

- ST DYWAL ON ONE SIDE.

**DEPMAL BEST AND SALES WITH BENELLED FOR E-WATS FACHO BACH STHER AND SALES WITH BENELLED FOR E-WATS FACHO BACH STHER AND SALES WITH BENELLED FOR E-WAS CONTROL HOMEOFORM, JOHN IN REQUIRED BLY ON MAIL HOMEN'S HE ALLOWED IN AN CONTROL HOMEOFORM, JOHN THE WALL IS THE SALESDAY WITH, JOHN SALES HE FLACED AT THE SOTTOM OF THE WALL IS THE SALESDAY OF HE HAD CONTROL WITH BE FLACED AT THE SOTTOM OF

(B) DRYWAL ON DOSTING WALL ISENOVATION:

- 10° DRYWAL GLIED DIRECTLY ON DOST, MASONIY WALL / OR USE STRAPPING AS ROUSING.
- GUEZ 2'X STRAMPING, 1 SIZ DOW "SIZ" ROUSI INSULATION AND "SUPER SO" VAPOUR / ARI BARRER ON EXTEROR WANDOW WALLS.)

MASONRY INFELL MARCHET IPELL.

BYSICK FACE TO MATCH EXISTING NOTE: MARCHITY MUST BE TOOTHED IN AT PETIMETER OF OPENING (THIT MORTRA TO MATCH EXISTING).

**NON CORPORATE METAL TEST & 2F OF CHESTICAL.

BYSICK CONCRETE BLOCK BACKUP ON 2F6 STUDS AND 56° EXTERIOR GRADE FIRE, WHOOD F WHERET THE CONSTITUTION.

M SILPLATE SO JENANDIAS

2.2 SE PRESSURE TREATED BALL PLATE SET ON CONTINUOUS BORTAN BED WITT DAL 192.2 SE PRESSURE TREATED BALL PLATE SET ON CONTINUOUS BORTAN BED WITT DAL 192. SEPTEMBER TREATED BACKET BOTHER BALLED TOP COURSE.

4. ROLL THEY CAM GASSET BETWEEN PLATE AND BEDOING & SILL POLY VAPOUR / ARE
ARROSED REJUGAT.

- 1/2" DRYWALL BOTH SIDES - 2" X 4" STUDG AT 16" O.C. - "2 X 6 STUDS WHERE NOTED".

(37) PAINTING
- ALL INTERIOR WOOD TRIM: ONE COAT OIL BASED PRIMER, TWO (2) COATS SEMI-GLOSS OIL.

ALL DRIVMAL BURNACES ONE COAT LATEX BEALET. TWO [7] COAT'S BATN/ ESGSHELL.

ALL EXTERON WOOD TIME ONE COAT OIL MADED PRIMET, 2 COATS OF FINIH- ENAMEL.

BOSON, COATS OF THE RESECTION AND PARTET OF LOATS.

LIGHT REPRINT ALL WOOD DOORS AND WINDOWS PRIME PLUS ONE FRESH COAT PRIOR TO INSTALLATION.

(a) EXTERIOR WINDOWS LOCKS

ALL WINDOWS ARE TO BE WOOD PRAMED CASEMENTS SEALED CLEAR WOOD INTERIOR
AND 91 EDUCATION FACTORY PREF INSHED EXTERIOR SURFACES AND 91 EDUCATION FACTORY PREF INSHED EXTERIOR SURFACES AND 91 EDUCATION FACTORY SHEET INSHED EXTERIO Many INJUSTMENT AND THE REPORT OF THE PROPERTY OF THE PROPERTY

(41) DOORS

- SOLID WOOD SUNLESS NOTED OTHERWISE) 1 SW THICK WITH TWO RECESSED RANSED OR RECESSED FLAT WOOD PANELS AS PER DETAIL SKETCH PROVIDED BY THE ADOLFTICE.

DOOR HEIGHTS: GROUND FLOOR = 95° DOORS SECOND FLOOR = 95° DOORS BASEMENT = 84° DOORS

NOTE: BUILDER/ OWNER TO CONTACT ARCHITECT FOR FINAL DECISION REGARD DOOR & FLAT ARCH HEIGHTS / WIDTHS NOTE: STRUCTURAL FRAMING AT DOORS! WINDOWS: FLAT ARCHES TO BE KEPT AS HIGH AS POSSIBLE TO ALLOW FOR FUTURE DISCUSSION: HEIGHT ADJUSTMENT

(4) BEINER DOOR!

THE STATE OF OR AS PER PLAN, TEMPERED GLASS DOOR

FROM THE BUY STATE ABOVE DOOR

HARMARE FRASH TO BE POLISHED GHORE ULL ES NOTED OTHERWISE

NET'ALL GRANTE FMARK, E BARDOND AROUND SHOWER OPENING.

(#) SHOWER LLANDRY MICHER FLOOR PAN

- BHOWER LIVER BY MAJUPROOF AG 390 (OR EQUAL) RETURN UP PAN CURE AND ALL

- SHOWER LIVER TO GRAIN

- BLOFF CORREST TO GRAIN

- BLOFF CORREST TO BRAIN

- BLOFF CORR

- USE TILE-BACKER WATER-RESISTANT
- 10° TORN-BHEILD'TILE BACKER BY GEORGIA-PACETIC AT ALL
BURROLANDER WALLE TAPE WITH 2 WICH 10 X 10 GLASS MESH SELF ADHESIVE TAPE
AND SPACIE.
- USE BULEDAND AT REMAINING BATHROOM WALLS.

(46) HANG ROO & SHELF

CO STATE A SEASON AS A SEASON

(4) SHELVING PROVIDE (6) THE DEEP ADJUSTABLE SHELVES

(4) WOOD STRUCTURE INSTALLATION

ALL DE SIGN DETALS, HANDLING AND INSTALLATION OF PROPRIETARY WOOD PRODUCTS SHALL BE IN STREET COMPLIANCE WITH MANUFACTURERS SPECIFICATIONS AND INSTRUCTIONS PROVIDE POSTS UNDER ALL BEAMS/SIPDER TRUSSES ETC. POSTS ARE TO RUN CONTINUOUS TO THE FOUNDATION OR EQUIVALENT SUPPORT

(6) STARS MAX. RISS: 7 7/2" ISN RUN S 1 9/1" ISN ROOMS 11 WHEN RUN LESS THAN 9 7/8" ISN WOTH 2-10" SETWEEN WALL FACES ISN HANDRUN HESSTT 2-4" ISN HANDRUN HESSTT 2-4" MAX. HANDRUN HESSTT 2-4"

(a) BALCORY

-BALTT TEST POWER WITH GOINGTS
-BALTT TEST POWER TO BE ALMANED WITE ME SH (FYOY)
-BOLATON BEAUTHER POWER
-BOLATON BEAUTHER POWER
-BOLATON BEAUTHER POWER
-BOLATON BEAUTHER POWER TO BE DETERMINED.
-BOLATON BEAUTHER POWER POWER OF BEAUTHER SHOWN ACTUATION SHOWS A STATE OF THE PLACEMENT AND APPLIENTS SHOWS ACTUATION SHOWS A STATE OF THE PLACEMENT AND APPLIENTS.
-BOLATON BEAUTHER SHOWS AND ADMINISTRATION AND APPLIENTS AND APPLIENTS AND APPLIENTS.
-BOLATON BEAUTHER SHOWS AND ADMINISTRATION AND ADMINISTRATION AND ADMINISTRATION.
-BOLATON BEAUTHER SHOWS AND ADMINISTRATION AND ADMINISTRATION.
-BOLATON BEAUTHER SHOWS AND ADMINISTRATION AND ADMINISTRATION AND ADMINISTRATION AND ADMINISTRATION.
-BOLATON BEAUTHER SHOWS AND ADMINISTRATION ADMINISTRATION AND ADMINISTRATION ADMINISTRATION AND ADMINISTRATION AND ADMINISTRATION ADMINISTRATION ADMINISTRATION ADMINISTRATION AND ADMINISTRATION ADMINISTR

) REMARKATIONS - SEMENTIAL TRANSPORT OF THE PROPERTY OF THE PR OPENING THROUGH ANY GUARD SHALL BE OF SIZE WHICH WILL PREVENT THE PASSAGE OF A BHERDOL OBJECT HAVING A DIMETER OF MORE THAN I IN GUARDS SHALL BE DESIGNED INSTALLED SO THAN NO MEMBER ATTACHED OR OPENING LOCATED BETWEEN 45 THAN 355 ABOVE THE FLOOR OR WALKING SURFACE WILL HAVE OFFICE OF MEMBERS AS DEED A 184 OF THE

(SI) EQUALISTRUCT

- PRODUCTED, OPERA DOVALIST DUCT
- PLASTIC EDALIST GRELE COMPLETE WITH INSECT SCREEN SECURELY FASTENED TO

- METAL GRALE WITH INSECT SCREEN
- DMENSION TO SLIT EGOMUST REQUIREMENTS
- NOTE CONTRACTOR TO COORDINATE DUCT RUN WITH OTHER MECHANICAL RUNS.
RUMBING RUNS AND STRUCTURE TO ELIMINATE NEED FOR BUILKHEADS.

(8) GAS & DOHALST FLIMES PROTECTION

- (1/* P. VWGOO BEHEN

- (8)*** "THE Y DOWNALL FOR FRE PROTECTION. TAPED MO SPACKED

- PROVIDE 1904 DOWNALL FOR FRE PROTECTION. TAPED MO SPACKED

- PROVIDE 1904 DOWNAL FOR OCERNO

WALLS MO CERNO

(57) MEDIANNAL DUCTS
ALL MEDIANDAL EXQUEST VENTS, EXQUEST AND INTIMES, TO BE INSTALLED AS PER PERTINENT CODE REQUIREMENTS AND MANUFACTURERS INSTRUCTIONS

(9) CARBON MONOXIDE DETECTOR

- NISTALL CARBON MONOXIDE DETECTOR CONFORMING TO CANCGAR 19 OR U.C 2004

- MUST COMPLY TO DESC 333.4

(E) SOCIEDA AND MANONERA WITH BATTERY MACAIP REACH FLOOR AND N EACH RETIRED ROOM.

SEAR HEETING ROOM.

SEA

(B) STEP FOOTBOSS


- VERTICAL STEP 23 59" MAX, FOR FIRM BOIL, 15 34" MAX, FOR BAND OR GRAVEL 23 58" MIN. HORIZONTAL RUN.

PROJECT

14 RIVER ROAD BRAMPTON, ON L6X 0A6

CLIENT

Owner

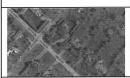

REVISIONS

No.	Description	Date
016	ISSUED FOR COFA	02/14/202
015	REISSUED FOR BUILDING PERMIT	02/14/202
013	ISSUED FOR BUILDING PERMIT	12/01/202
07	ISSUED FOR CLIENT	07/20/202

Discrepancies must be reported immediately to the Architect before proceeding. Only figured dimensions ar to be used. Contractors must check all dimensions on site. This drawing is protected by copyright.

ALL DIMENSIONS ARE SHOWN IN IMPERIAL & METRIC.

CONSULTANTS





DRAWING TITLE

CONSTRUCTION NOTES


DRAWN		CHECKED	
PP		SA	
SCALE @ ARCH D		DATE 07/19/23	
	GRAP	HIC SCALE	


PROJECT NO. 200155

STAGE DRAWING NO.

COFA A0-10

LOCATION REVISION HALTON HILLS

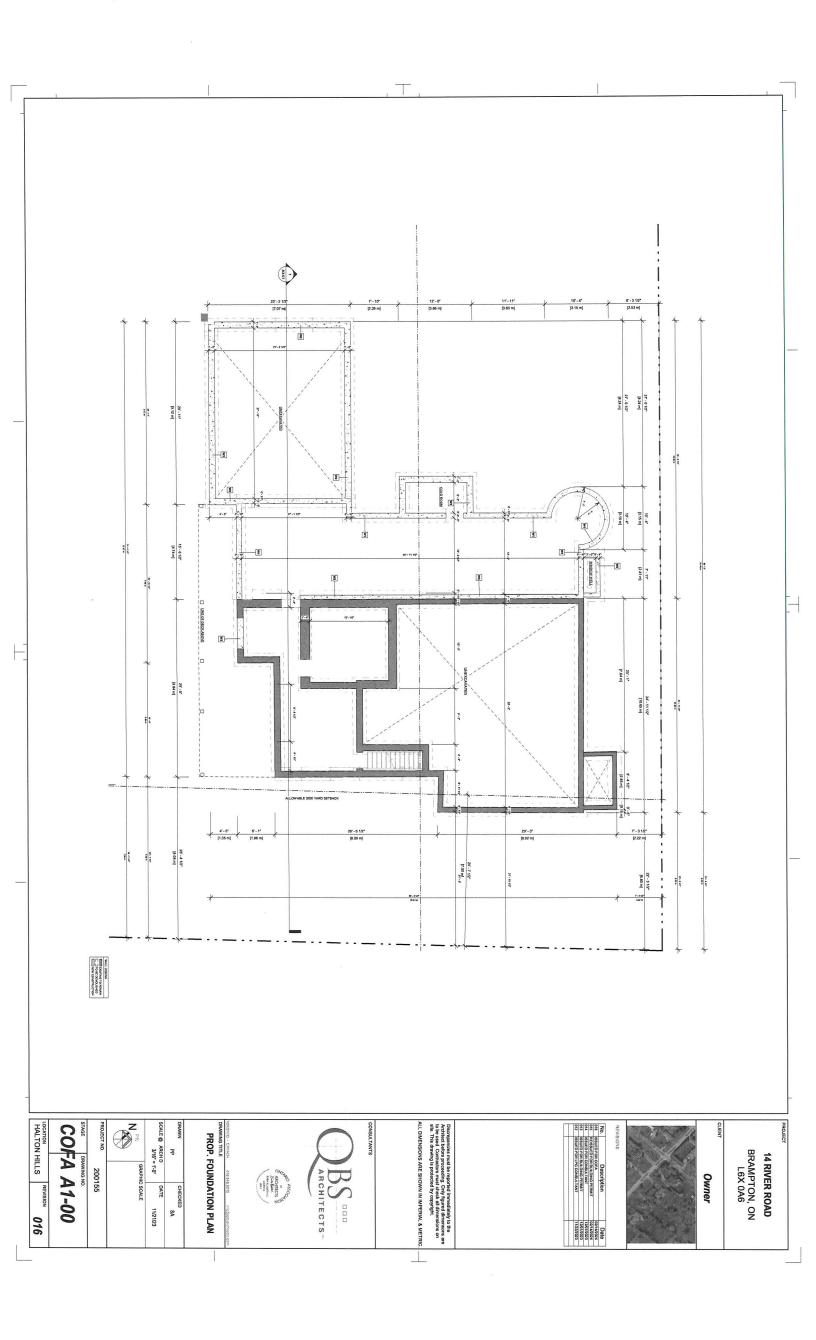

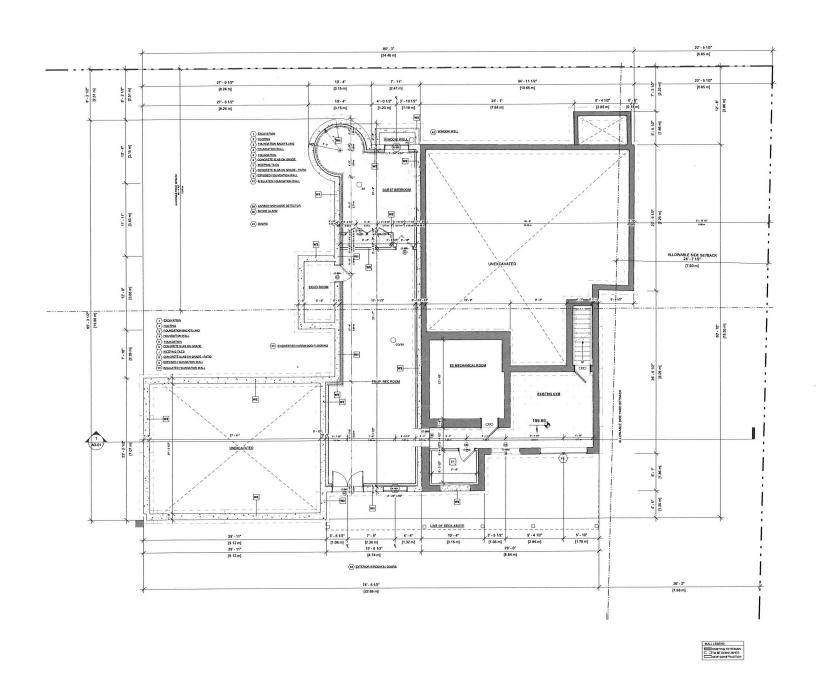

CLIENT

14 RIVER ROAD BRAMPTON, ON L6X 0A6

Owner



REVISIONS

No.	Description	Date
016	ISSUED FOR COFA	02/14/2024
015	REISSUED FOR BUILDING PERMIT	02/14/202
014	ISSUED FOR CONSULTANT	12/07/202
013	ISSUED FOR BUILDING PERMIT	12/01/202
012	ISSUED FOR LPG CONSULTANT	11/22/202
011	ISSUED FOR CLIENT	11/06/2023
010	ISSUED FOR CLIENT	10/26/202

Discrepancies must be reported immediately to the Architect before proceeding. Only figured dimensons ar to be used. Contractors must check all dimensions on site. This drawing is protected by copyright.

ALL DIMENSIONS ARE SHOWN IN IMPERIAL & METRIC

CONSULTANTS





DRAWING TITLE

PROP. UNFINISHED BASEMENT

DRAWN		CHECKED
PP		SA
SCALE @ ARCH I 3/16*	o = 1'-0"	DATE 11/03/23
.01	GRAPH	IIC SCALE




016

PROJECT NO.

200155

COFA A1-01

LOCATION HALTON HILLS

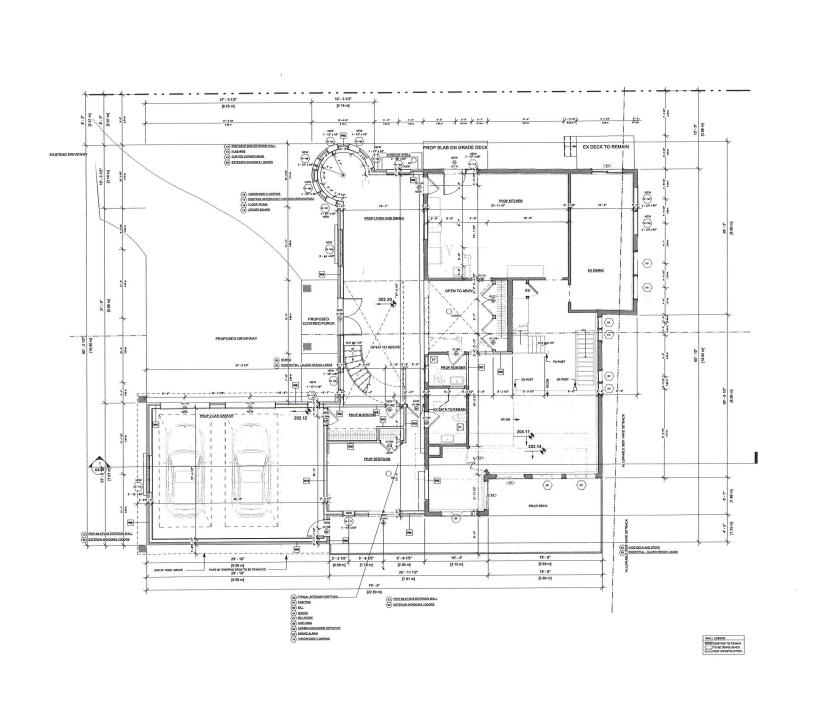

PROJE

14 RIVER ROAD

BRAMPTON, ON L6X 0A6

CLIENT

Owner



REVISIO

No.	Description	Date
016	ISSUED FOR COFA	02/14/202
015	REISSUED FOR BUILDING PERMIT	02/14/202
014	ISSUED FOR CONSULTANT	12/07/202
013	ISSUED FOR BUILDING PERMIT	12/01/202
012	ISSUED FOR LPG CONSULTANT	11/22/202
011	ISSUED FOR CLIENT	11/06/202
010	ISSUED FOR CLIENT	10/26/202

Discrepancies must be reported immediately to the Architect before proceeding. Only figured dimensons are to be used. Contractors must check all dimensions on site. This drawing is protected by copyright.

ALL DIMENSIONS ARE SHOWN IN IMPERIAL & METRI

CONSULTANTS





TORONTO - CANADA 416.546.2040 info@qtearchitects.co

DRAWING TITLE

PROP. GROUND FLOOR


DRAWN		CHECKED
PP		SA
SCALE @ ARCH 3/16	D " = 1'-0"	DATE 11/03/23
N. PN	GRAPH	IC SCALE

N N

PROJECT NO. 200155

COFA A1-02

LOCATION HALTON HILLS

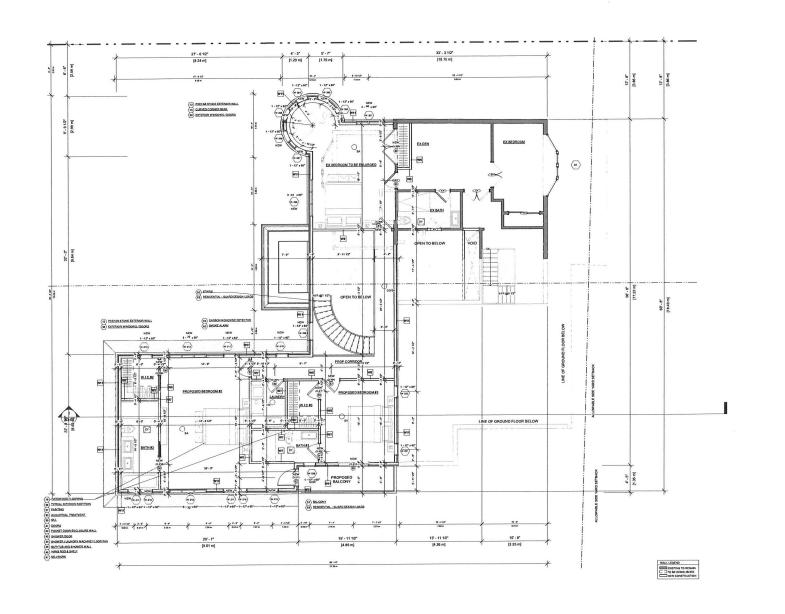

14 RIVER ROAD BRAMPTON, ON L6X 0A6

Owner



No.	Description	Date
016	ISSUED FOR COFA	02/14/2024
015	REISSUED FOR BUILDING PERMIT	02/14/2024
014	ISSUED FOR CONSULTANT	12/07/2023
013	ISSUED FOR BUILDING PERMIT	12/01/2023
012	ISSUED FOR LPG CONSULTANT	11/22/2023
011	ISSUED FOR CLIENT	11/06/2023
010	ISSUED FOR CLIENT	10/26/2023

Discrepancies must be reported immediately to the Architect before proceeding. Only figured dimensons are to be used. Contractors must check all dimensions on site. This drawing is protected by copyright.

ALL DIMENSIONS ARE SHOWN IN IMPERIAL & METRIC.






PROP. SECOND FLOOR

DRAWN	CHECKED
PP	SA
SCALE @ ARCH	DATE
3/16*	1'-0" 11/03/23


PROJECT NO. 200155

COFA A1-03

HALTON HILLS

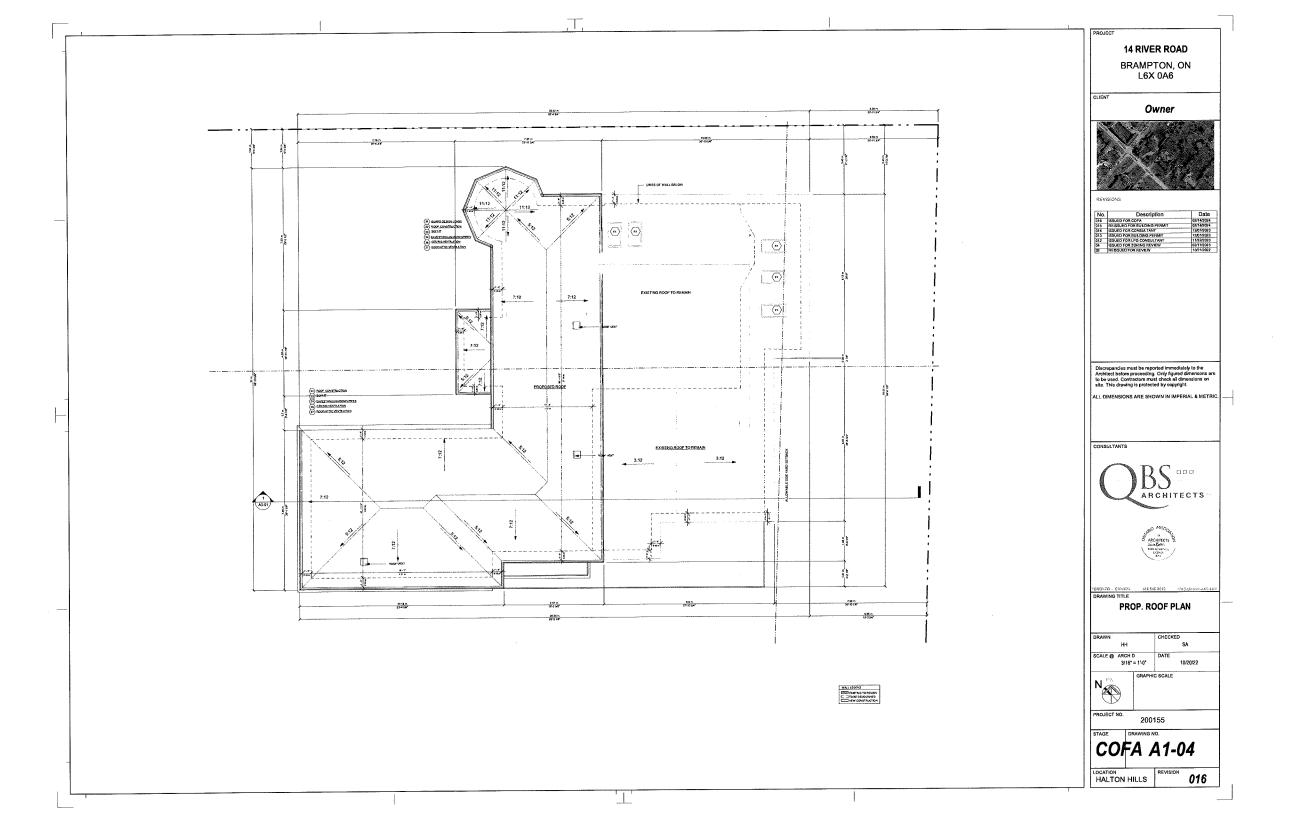



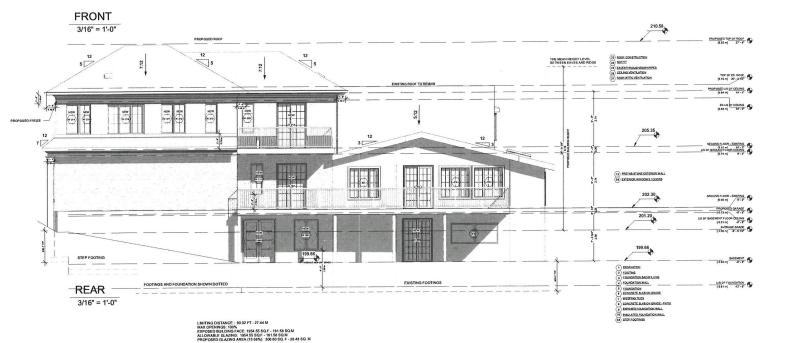

PROJECT

14 RIVER ROAD

BRAMPTON, ON L6X 0A6

CLIENT

Owner



REVISIONS

No.	Description	Dat
016	ISSUED FOR COFA	02/14/200
015	REISSUED FOR BUILDING PERMIT	02/14/20
013	ISSUED FOR BUILDING PERMIT	12/01/20
012	ISSUED FOR LPG CONSULTANT	11/22/200
011	ISSUED FOR CLIENT	11/06/20
010	ISSUED FOR CLIENT	10/26/202
09	ISSUED FOR CLIENT	10/25/20

Discrepancies must be reported immediately to the Architect before proceeding. Only figured dimensions are to be used. Contractors must check all dimensions on site. This drawing is protected by copyright.

ALL DIMENSIONS ARE SHOWN IN IMPERIAL & METRIC.

CONSULTANTS





TORONTO - CANADA 416.546 2040 info@qbsarchitects.c

PROP. FRONT AND REAR ELEVATION


DRAWN		CHECKED
PP		SA
SCALE @ ARCH D 3/16" :		DATE 11/03/23
	GRAPH	IC SCALE


PROJECT NO.

FAGE DRAWING NO

COFA A2-01

HALTON HILLS

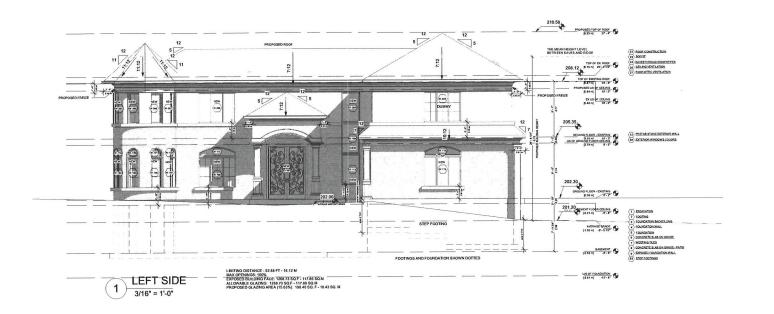

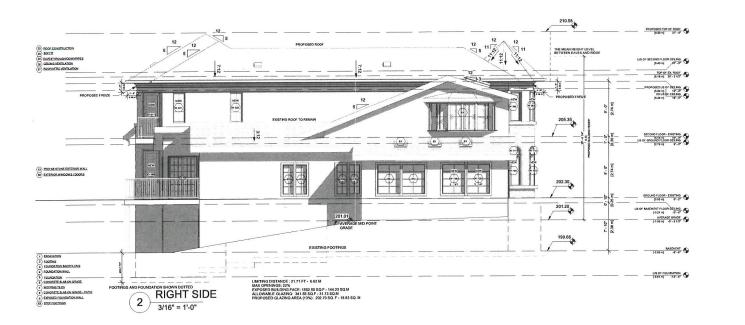

PROJECT

14 RIVER ROAD BRAMPTON, ON L6X 0A6

CLIENT

Owner



REVISIONS

No.	Description	Date
016	ISSUED FOR COFA	02/14/2024
015	REISSUED FOR BUILDING PERMIT	02/14/2024
013	ISSUED FOR BUILDING PERMIT	12/01/2023
012	ISSUED FOR LPG CONSULTANT	11/22/2023
011	ISSUED FOR CLIENT	11/06/2023
010	ISSUED FOR CLIENT	10/26/2023
09	ISSUED FOR CLIENT	10/25/2023

Discrepancies must be reported immediately to the Architect before proceeding. Only figured dimensons at to be used. Contractors must check all dimensions on site. This drawing is protected by copyright.

ALL DIMENSIONS ARE SHOWN IN IMPERIAL & METRIC.

CONSULTANTS





DRAWING TITLE

PROP. SIDE ELEVATION


DRAWN	CHECKED
PP	SA
SCALE @ ARCH D	DATE
3/16" = 1'-0"	11/03/23
GRAPH	IIC SCALE

200155

PROJECT NO.

COFA A2-02

HALTON HILLS

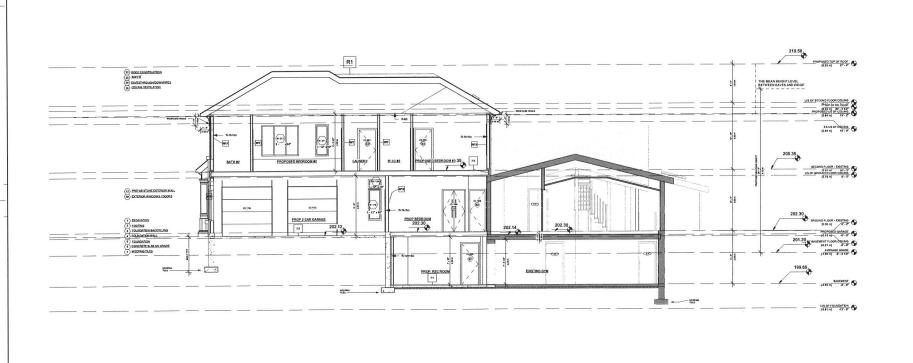

PROJECT

14 RIVER ROAD BRAMPTON, ON L6X 0A6

CLIENT

Owner



No.	Description	Date
	ISSUED FOR COFA	02/14/202
015	REISSUED FOR BUILDING PERMIT	02/14/202
013	ISSUED FOR BUILDING PERMIT	12/01/202
012	ISSUED FOR LPG CONSULTANT	11/22/202

Discrepancies must be reported immediately to the Architect before proceeding. Only figured dimensions are to be used. Contractors must check all dimensions on site. This drawing is protected by copyright.

CONSULTANTS





TORONTO - CANADA

DRAWING TITLE

PROP. SECTION

CHECKED SCALE @ ARCH D 3/16" = 1'-0" 11/21/23 GRAPHIC SCALE

PROJECT NO.


200155

COFA A3-01

LOCATION HALTON HILLS

		DOC	OR SCHE	DULE		
Mark	Level	Width	Height	From Room	To Room	Operation
		5'- 0"	7 - 0*	EXTERIOR	PROP REC ROOM	DOUBLE DOOR
	BASEMENT	2'-6"	6'-8"	BATH	EXISTING GYM	SINGLE SWING
	BASEMENT	4'-8"	7'-0"	EXISTING GYM	EXTERIOR	SLIDING DOOR
	BASEMENT	2' - 8"	6'-8"	PROP COLD ROOM	PROP REC ROOM	SINGLE SWING
D-004	BASEMENT	2'-8"	6'-8"	PROP COLD ROOM	PROP REC ROOM PROP GUEST BEDROOM	SINGLE SWING
D-005	BASEMENT	3'-4"	7' - 0"	PROP CLOSET	PROP GUEST BEDROOM	DOUBLE DOOR
	BASEMENT	3'-4"	7'-0"	PROP CLOSET	PROP GUEST BEDROOM	DOUBLE DOOR
D-007	BASEMENT	3' - 4'	6'-8"	PROP CLOSE I	EXISTING GYM	OPENING
D-008	BASEMENT	6'-0"	8'-0"	PROP PORCH	PROP LIVING AND DINING	DOUBLE DOOR
	GROUND FLOOR - EXISTING		6'-8"	PROP LIVING AND DINING	PROP MUD ROOM	SINGLE SWING
	GROUND FLOOR - EXISTING	2' - 8"	6'-8"	PROP LIVING AND DINING	PROP BED ROOM	SINGLE SWING
D-103	GROUND FLOOR - EXISTING		6'-8"	PROP LIVING AND DINING	PROP CAR GARAGE	SINGLE SWING
D-104	GROUND FLOOR - EXISTING	2' - 8"	6'-8"	PROP BED ROOM	RATH	SINGLE SWING
D-105	GROUND FLOOR - EXISTING	2' - 6"		CLOSET	PROP BED ROOM	DOUBLE DOOR
D-106	GROUND FLOOR - EXISTING	1' - 9"	6' - 8" 7' - 6"	PROP BED ROOM	DECK	SLIDING DOOR
D-107	GROUND FLOOR - EXISTING	5' - 0"			PROP CAR GARAGE	SINGLE SWING
D-108	GROUND FLOOR - EXISTING	2'-8"	8' - 0"	DECK		SINGLE SWING
D-109	GROUND FLOOR - EXISTING	2' - 6"	6' - 8"	PROP FOYER	PROP POWDER PROP FOYER	DOUBLE DOOR
D-110	GROUND FLOOR - EXISTING	2' - 6"	6' - 8"	PROP CLOSET	PROP FOYER	DOUBLE DOOR
D-111	GROUND FLOOR - EXISTING	2'-6"	6' - 8"	PROP CLOSET	PROP FOTER PROP KITCHEN	OPENING
D-112	GROUND FLOOR - EXISTING	3'-0"	6' - 8"	PROP FOYER		
D-113	GROUND FLOOR - EXISTING	2' - 8"	6' - 8"	PROP LIVING AND DINING	PROP KITCHEN	SINGLE SWING
D-114	GROUND FLOOR - EXISTING	3' - 6"	8' - 0"	PROP KITCHEN	EXTERIOR	
D-115	PROPOSED GARAGE	8' - 0"	8' - 0"	PROP CAR GARAGE	EXTERIOR	ROLL UP
D-116	PROPOSED GARAGE	8' - 0"	8 0.	PROP CAR GARAGE	EXTERIOR	ROLL UP
D-117	SECONDARY UNIT GROUND FLOOR LEVEL	2' - 6"	6' - 0*	PROP HALL	LOW HEADROOM STORAGE	SINGLE SWING
D-202	SECOND FLOOR - EXISTING	2' - 10"	6' - 8"	PROP CLOSET	EXISTING BEDROOM	DOUBLE DOOF
D-203	SECOND FLOOR - EXISTING	2' - 6"	6' - 8"	PROP CLOSET	EXISTING BEDROOM	SINGLE SWING
D-204	SECOND FLOOR - EXISTING	2' - 8"	6' - 8"	PROP CORRIDOR	PROP BEDROOM #3	SINGLE SWING
D-205	SECOND FLOOR - EXISTING	2' - 6"	6' - 8"	PROP BEDROOM #3	PROP W.I.C #3	SINGLE SWING
D-206	SECOND FLOOR - EXISTING	2' - 6"	6' - 8"	PROP BEDROOM #3	PROP BATH #3	SINGLE SWING
D-207	SECOND FLOOR - EXISTING	2' - 8"	6' - 8"	PROP CORRIDOR	PROP LAUNDRY	SINGLE SWING
D-208	SECOND FLOOR - EXISTING	2' - 8"	6' - 8"	PROP CORRIDOR	PROP BEDROOM #2	SINGLE SWING
D-209	SECOND FLOOR - EXISTING	2' - 6"	6' - 8"	PROP BEDROOM #2	PROP W.I.C #2	POCKET
D-210	SECOND FLOOR - EXISTING	2' - 6"	6' - 8"	PROP BEDROOM #2	PROP BATH #2	POCKET
D-211	SECOND FLOOR - EXISTING	2'-8"	7' - 6"	PROP BALCONY	PROP BEDROOM #2	SINGLE SWING
D-212	SECOND FLOOR - EXISTING	5' - 0"	7' - 6"	PROP BALCONY	PROP BEDROOM #3	SLIDING DOOR
D-213	SECONDARY UNIT U/S OF GROUND FLOOR CEILING	6' - 0"	7-0	PROP DEN	EXISTING DECK	SLIDING DOOR

	,	Window Sch	edule 2		
Mark	Level	Sill Height	Height	Width	From Room: Name
W-001	RASEMENT	2' - 0"	5' - 0"	4' - 0"	PROP. REC ROOM
W-001	BASEMENT	5' - 6"	2'-0"	4' - 0"	GUEST BEDROOM
W-101	GROUND FLOOR - EXISTING	2'-0"	5' - 0"	4' - 0"	PROP LIVING AND DINING
W-101 W-102	GROUND FLOOR - EXISTING	2'-0"	5' - 0"	2'-0"	PROP LIVING AND DINING
W-102 W-103	GROUND FLOOR - EXISTING	2'-0"	5' - 0"	2'-0"	PROP LIVING AND DINING
W-103 W-104	GROUND FLOOR - EXISTING	2'-0"	5' - 0"	2 - 0*	PROP LIVING AND DINING
W-104 W-105	GROUND FLOOR - EXISTING	2' - 0"	5' - 0"	2'-0"	PROP LIVING AND DINING
W-105	GROUND FLOOR - EXISTING	2' - 0"	5' - 0"	2'-0"	PROP LIVING AND DINING
W-100	GROUND FLOOR - EXISTING	2' - 0"	5' - 0"	2' - 0"	PROP LIVING AND DINING
W-107	GROUND FLOOR - EXISTING	2'-0"	5' - 0"	6' - 0"	PROP LIVING AND DINING
W-109	GROUND FLOOR - EXISTING	7' - 5 1/2"	5' - 0°	3' - 0"	PROP FOYER
W-110	GROUND FLOOR - EXISTING	2' - 0"	5' - 0"	2'-0"	PROP 2 CAR GARAGE
W-111	GROUND FLOOR - EXISTING	2'-6"	5' - 0"	2'-0"	PROP BEDROOM
W-112	GROUND FLOOR - EXISTING	00.	8' - 0"	2 - 0*	PROP KITCHEN
W-113	GROUND FLOOR - EXISTING	2' - 0"	5' - 0"	6' - 0"	PROP 2 CAR GARAGE
W-114	GROUND FLOOR - EXISTING	7'-0"	1' - 6"	10' - 0"	PROP LIVING AND DINING
W-115	GROUND FLOOR - EXISTING	2' - 4 1/2"	5' - 0"	3' - 0"	PROP FOYER
W-116	GROUND FLOOR - EXISTING	7'-0"	1' - 6"	10" - 0"	PROP 2 CAR GARAGE
W-117	GROUND FLOOR - EXISTING	7' - 0"	1'-6"	2 - 0*	PROP LIVING AND DINING
W-118	GROUND FLOOR - EXISTING	7'-0"	1'-6"	2'-0"	PROP LIVING AND DINING
W-119	GROUND FLOOR - EXISTING	7' - 0"	1'-6"	2'-0"	PROP LIVING AND DINING
W-120	GROUND FLOOR - EXISTING	7' - 0"	1'-6"	2 - 0*	PROP LIVING AND DINING
W-121	GROUND FLOOR - EXISTING	7' - 0"	1' - 6"	2'-0"	PROP LIVING AND DINING
W-121	GROUND FLOOR - EXISTING	7' - 0"	1'-6"	2'-0"	PROP LIVING AND DINING
W-123	GROUND FLOOR - EXISTING	7' - 0"	1' - 6"	4' - 0"	EX BEDROOM TO BE ENLARGE
W-124	GROUND FLOOR - EXISTING	7'-0"	1'-6"	2'-0"	PROP 2 CAR GARAGE
W-125	GROUND FLOOR - EXISTING	0' - 8"	5' - 0"	3' - 11"	EX DINING
W-126	GROUND FLOOR - EXISTING	0'-8"	5' - 0°	3' - 11"	EX DINING
W-127	SECONDARY UNIT GROUND FLOOR LEVEL	2' - 9"	5' - 6"	3' - 0"	PROP HALLROOM STORAGE
W-201	SECOND FLOOR - EXISTING	2' - 6"	5' - 0"	4' - 0"	EX BEDROOM TO BE ENLARGE
W-202	SECOND FLOOR - EXISTING	2'-6"	5' - 0"	2'-0"	EX BEDROOM TO BE ENLARGE
W-203	SECOND FLOOR - EXISTING	2'-6"	5' - 0"	2' - 0"	EX BEDROOM TO BE ENLARGE
W-204	SECOND FLOOR - EXISTING	2'-6"	5' - 0"	2'-0"	EX BEDROOM TO BE ENLARGE
W-205	SECOND FLOOR - EXISTING	2' - 6"	5' - 0"	2'-0"	EX BEDROOM TO BE ENLARGE
W-206	SECOND FLOOR - EXISTING	2' - 6"	5' - 0"	2'-0"	EX BEDROOM TO BE ENLARGE
W-207	SECOND FLOOR - EXISTING	2'-6"	5' - 0"	2'-0"	EX BEDROOM TO BE ENLARGE
W-208	SECOND FLOOR - EXISTING	2' - 6"	5' - 0"	6' - 0"	EX BEDROOM TO BE ENLARGE
W-209	SECOND FLOOR - EXISTING	2' - 6"	5' - 0"	3" - 0"	OPEN TO BELOW -PROP FOYE
W-210	SECOND FLOOR - EXISTING	2' - 6"	5' - 0"	2'-0"	PROP CORRIDOR
W-211	SECOND FLOOR - EXISTING	2' - 6"	5' - 0"	2'-0"	PROPOSED BEDROOM #2
W-212	SECOND FLOOR - EXISTING	2' - 6"	5' - 0"	6' - 0"	PROPOSED BEDROOM #2
W-213	SECOND FLOOR - EXISTING	2' - 6"	5' - 0"	2'-0"	W.I.C #2
W-214	SECOND FLOOR - EXISTING	2'-6"	5' - 0"	2'-0"	BATH #2
W-215	SECOND FLOOR - EXISTING	2' - 6"	5' - 0"	2' - 0"	BATH #2
W-216	SECOND FLOOR - EXISTING	2' - 6"	5' - 0"	6' - 0"	PROPOSED BEDROOM #2
W-217	SECOND FLOOR - EXISTING	2' - 6"	5' - 0"	2'-0"	PROPOSED BEDROOM #2
W-218	SECOND FLOOR - EXISTING	2'-6"	5' - 0"	2' - 0"	PROPOSED BEDROOM #2
W-219	SECOND FLOOR - EXISTING	2' - 6"	5' - 0"	2' - 0"	
W-219	SECOND FLOOR - EXISTING	2'-6"	5' - 0"	2'-0"	
W-221	SECOND FLOOR - EXISTING	2'-6"	5' - 0"	2' - 0"	PROPOSED BEDROOM #3
W-222	SECOND FLOOR - EXISTING	2'-6"	5' - 0"	2' - 0"	PROPOSED BEDROOM #3

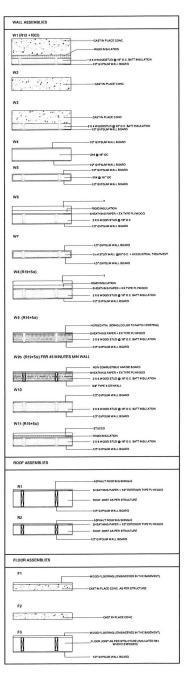

ASSEMBLIES

1:20

PROJECT 14 RIVER ROAD BRAMPTON, ON L6X 0A6 CLIENT Owner REVISIONS No.

DBSM-y-.


016 ISSUED FOR COFA


015 RESSUED FOR BUILDING PERMIT


013 ISSUED FOR BUILDING PERMIT Discrepancies must be reported immediately to the Architect before proceeding. Only figured dimensons are to be used. Contractors must check all dimensions on site. This drawing is protected by copyright. ALL DIMENSIONS ARE SHOWN IN IMPERIAL & METRIC. CONSULTANTS BS ARCHITECTS TORONTO - CANADA


DRAWING TITLE DOOR WINDOW SCHEDULE & WALL ASSEMBLIES DRAWN CHECKED SA SCALE @ ARCH D 11/23/23 GRAPHIC SCALE PROJECT NO. 200155 STAGE DRAWING NO.


LOCATION HALTON HILLS

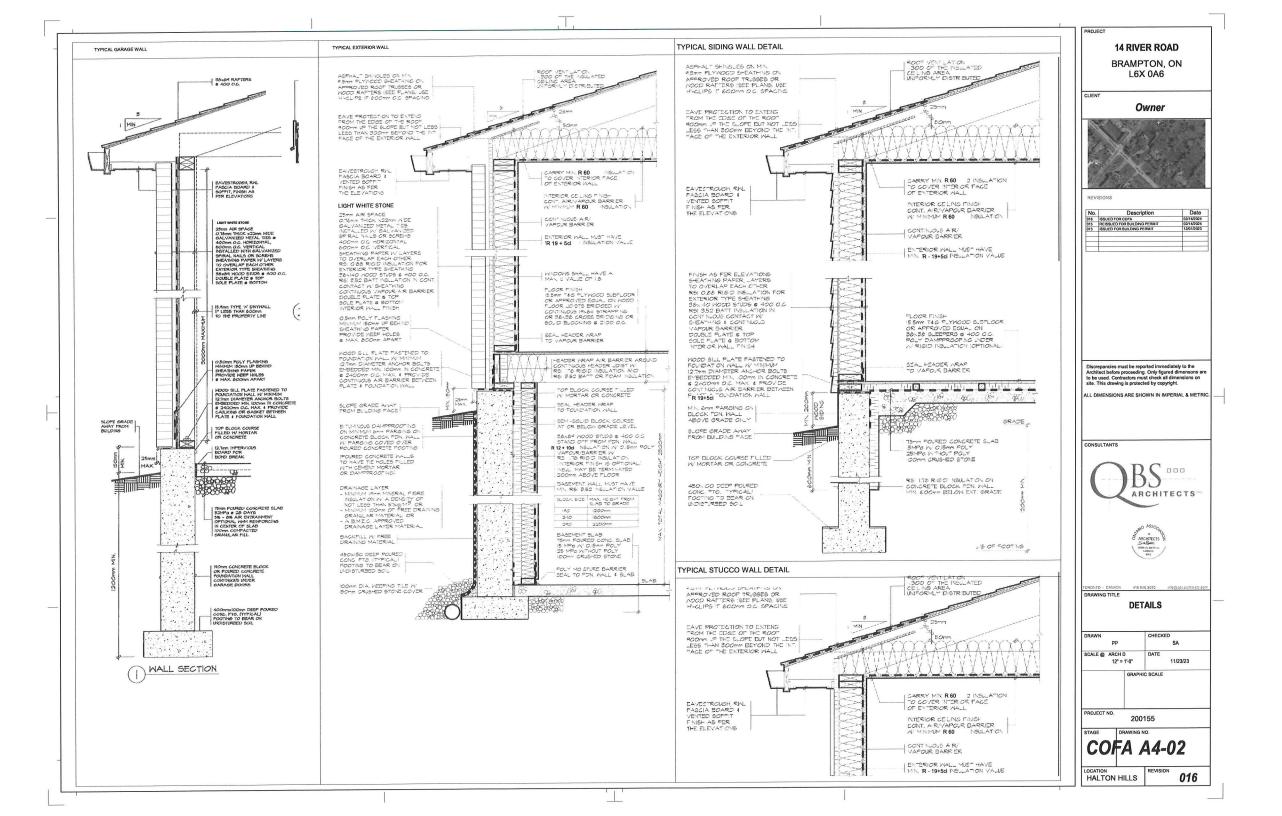


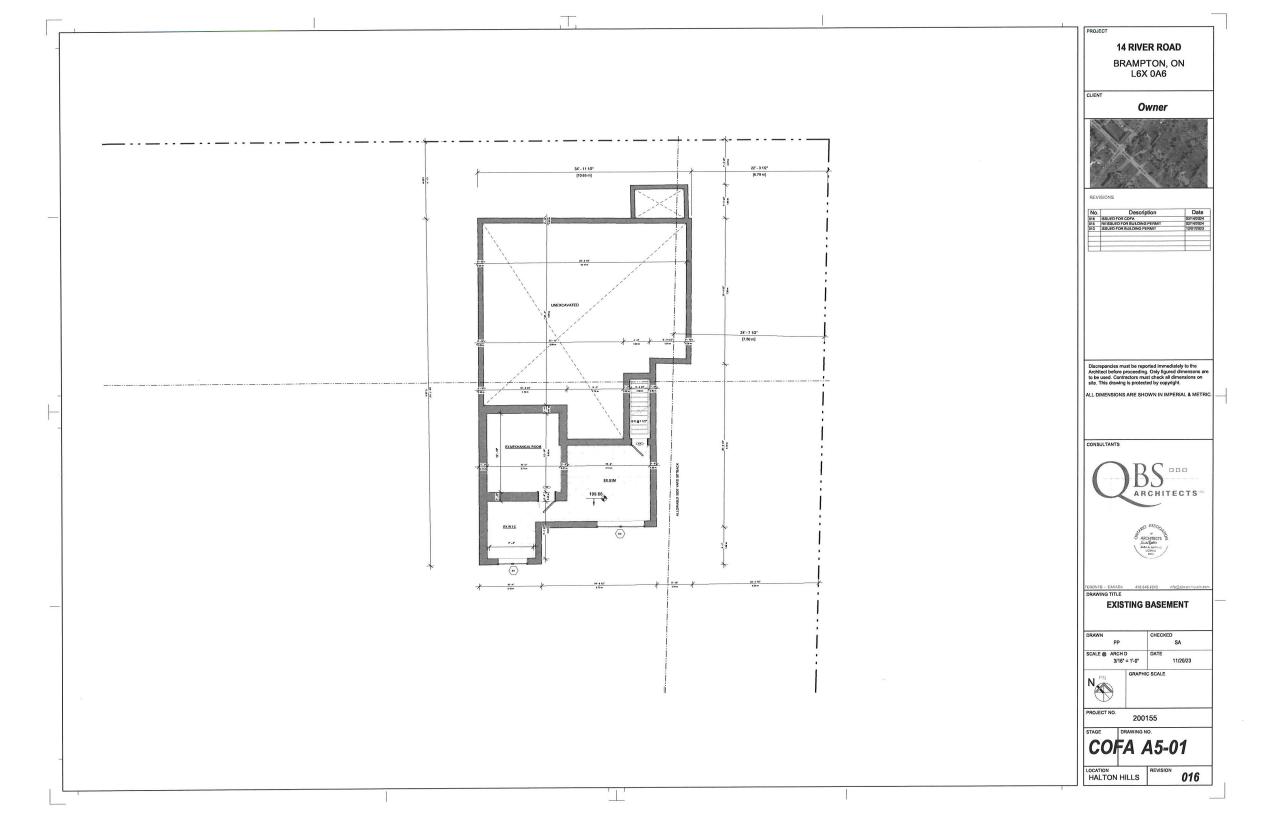

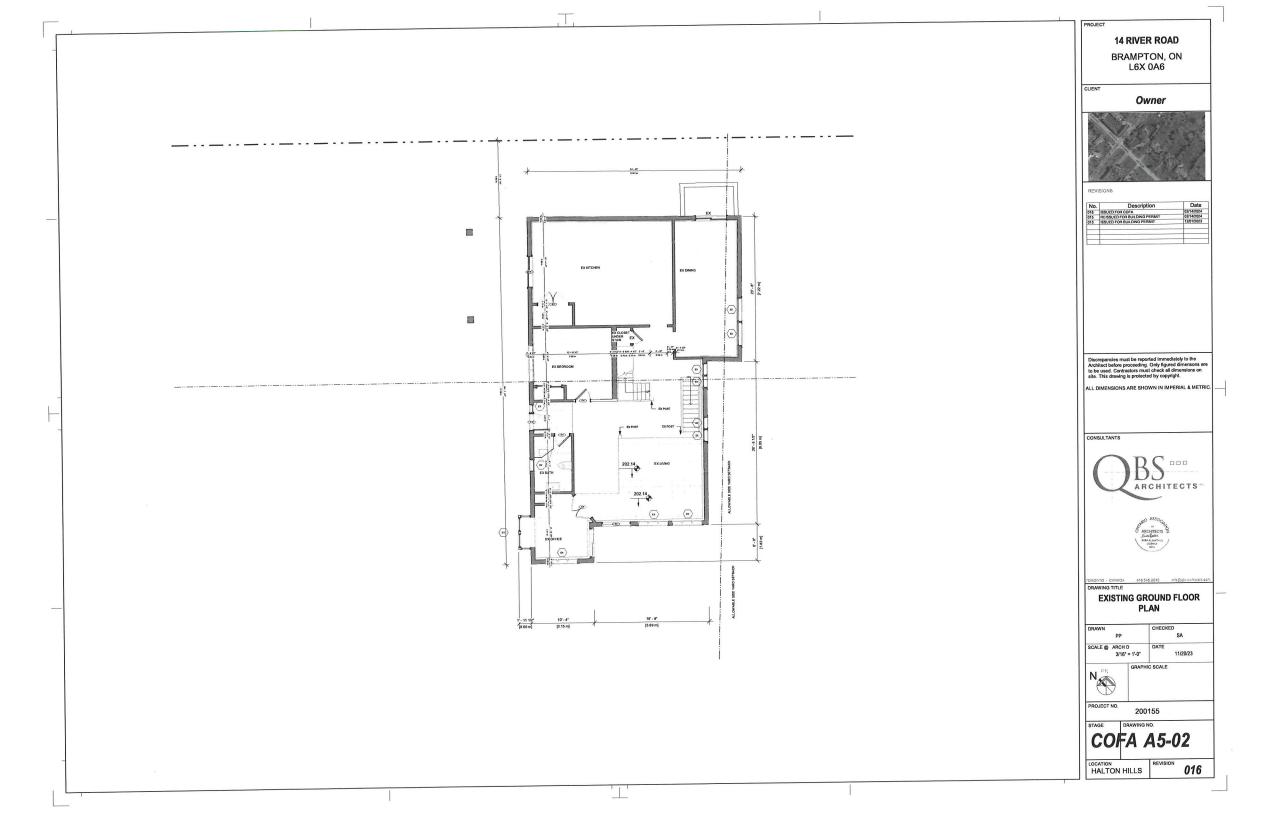

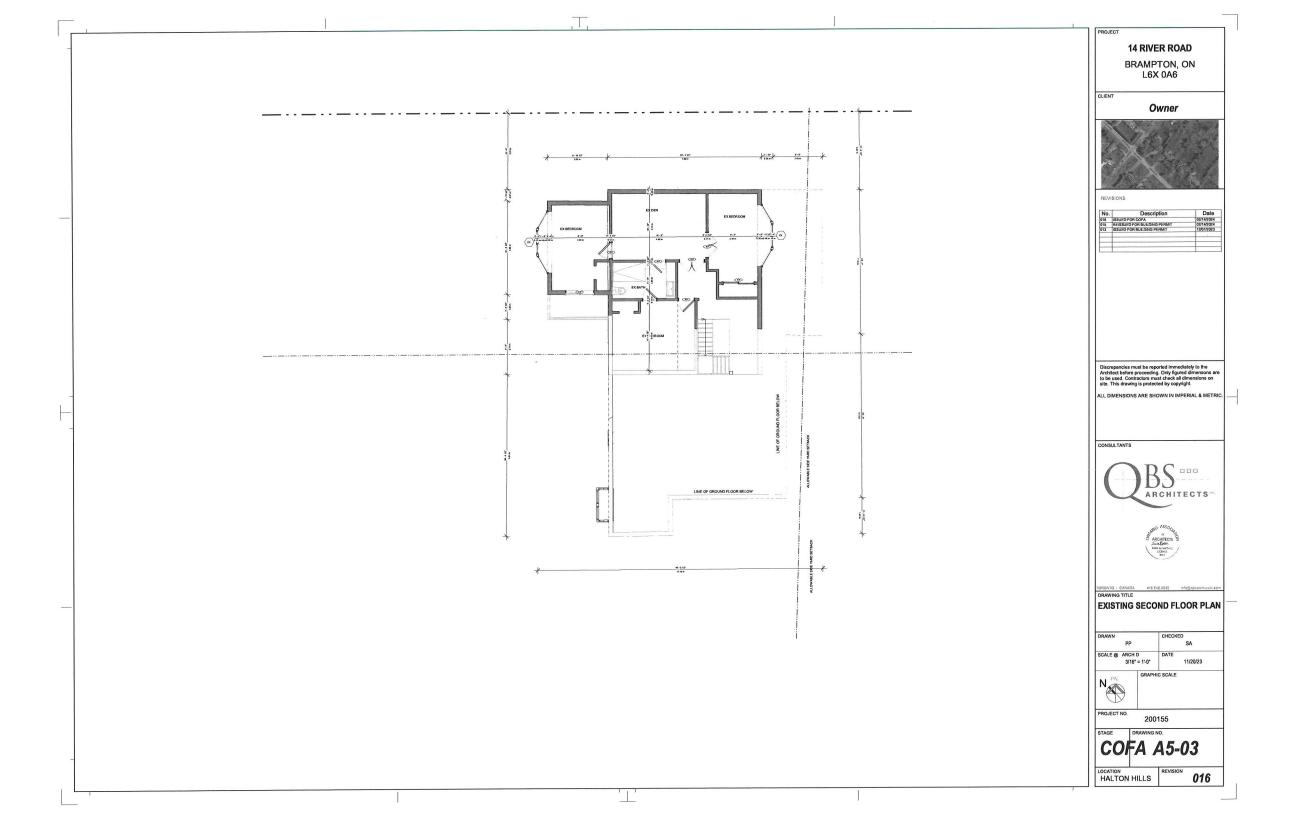

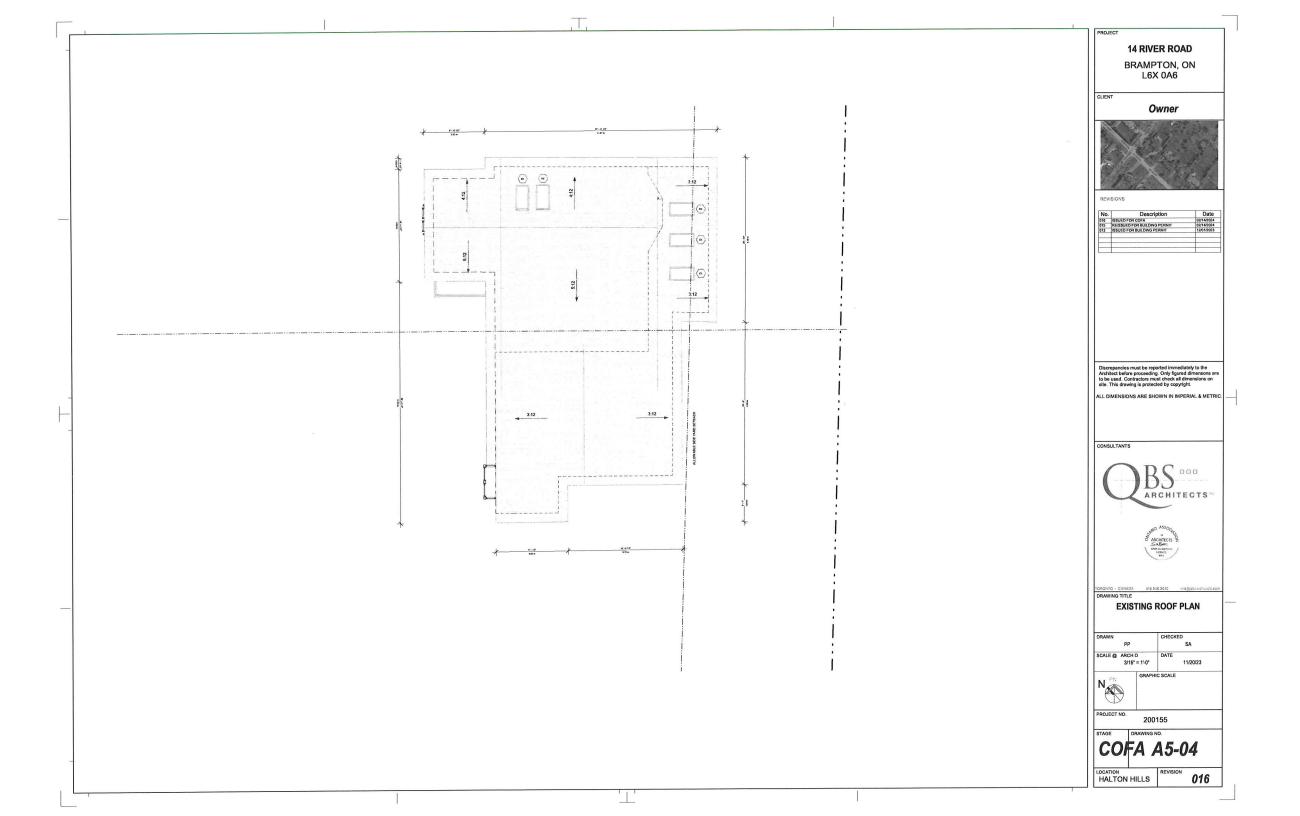

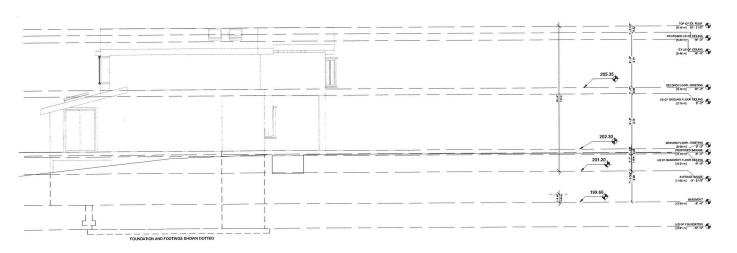

FRONT EX 2 FRUNT L 3/16" = 1'-0"



1 REAR EX 3/16" = 1'-0"

14 RIVER ROAD

BRAMPTON, ON L6X 0A6

CLIENT

Owner



REVISIONS

No.	Description	Dat
016	ISSUED FOR COFA	02/14/20
015	REISSUED FOR BUILDING PERMIT	02/14/20
013	ISSUED FOR BUILDING PERMIT	12/01/20
		_

Discrepancies must be reported immediately to the Architect before proceeding. Only figured dimensons are to be used. Contractors must check all dimensions on site. This drawing is protected by copyright.

ALL DIMENSIONS ARE SHOWN IN IMPERIAL & METRIC.

CONSULTANTS






DRAWING TITLE

EXISTING FRONT AND REAR ELEVATION


PP SCALE @ ARCH D 3/16" = 1'-0" GRAPHIC SCALE	SA
3/16" = 1'-0"	
CRAPHIC SCALE	
CRAPHIC CCALE	11/20/2
GROWING SCALE	

COFA A6-01

LOCATION HALTON HILLS 016

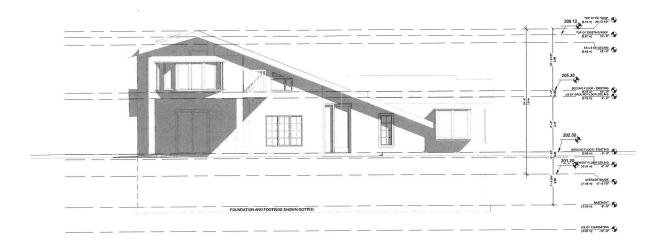

1 RIGHT EX 3/16" = 1'-0"

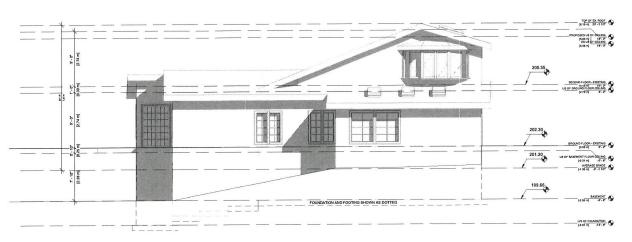

2 LEFT EX 3/16" = 1'-0" PROJE

14 RIVER ROAD

BRAMPTON, ON L6X 0A6

CLIENT

Owner



REVISIO

No.	Description	Date
016	ISSUED FOR COFA	02/14/2024
015	REISSUED FOR BUILDING PERMIT	02/14/2024
013	ISSUED FOR BUILDING PERMIT	12/01/2023

Discrepancies must be reported immediately to the Architect before proceeding. Only figured dimensons are to be used. Contractors must check all dimensions on site. This drawing is protected by copyright.

ALL DIMENSIONS ARE SHOWN IN IMPERIAL & METRI

CONSULTANTS





TORONTO - CAMADA 416 546 2040 info@qboarchitects.com DRAWING TITLE

EXISTING SIDE ELEVATION

SA
DATE 11/20/23
IIC SCALE

PROJECT NO.

200155

COFA A6-02

HALTON HILLS REVISION 016

Zoning Non-compliance Checklist

File No.	_
A-2024	-0067

Applicant: Saba Al Mathno

Address: 14 River Rd

Zoning: RHM1

By-law 270-2004, as amended

Category	Proposal	By-law Requirement	Section #
USE			
LOT DIMENSIONS AREA / DEPTH / WIDTH			
BUILDING SETBACKS - FRONT	To permit a front yard setback of 2.6m to a proposed two-storey addition to an existing single detached dwelling	whereas the by-law requires a minimum front yard setback of 12m.	11.4.2(d)
BUILDING SIZE			
BUILDING HEIGHT			
COVERAGE			
BELOW GRADE ENTRANCE			
ACCESSORY STRUCTURE SETBACKS			
ACCESSORY STRUCTURE SIZE / HEIGHT			
MULTIPLE ACCESSORY STRUCTURES			
DRIVEWAY WIDTH			
LANDSCAPED OPEN SPACE	To permit a minimum landscaped open space of 63.3% of the front yard	whereas the by-law a minimum landscaped open space of 70% of the front yard	11.4.2(j)
ENCROACHMENTS			
TWO-UNIT DWELLING			
SCHEDULE "C"			
OTHER - DECK			

Connor Cowan	
Reviewed by Zoning	
2024-02-28	
Date	

Zoning Non-compliance Checklist

File No.	

Applicant: Saba Al Mathno


Address: 14 River Rd, Brampton, ON L6X 0A6

Zoning: RHM1

By-law 270-2004, as amended

Category	Proposal	By-law Requirement	Section
			#
USE			
LOT DIMENSIONS AREA / DEPTH / WIDTH	To permit a front yard setback of 2.6m to a proposed two-storey addition to an existing single detached dwelling	Whereas the by-law requires a minimum front yard setback of 12m	11.4.2(d)
BELOW GRADE ENTRANCE			
SETBACKS			
BUILDING HEIGHT			
OUTSIDE STORAGE			
LOT COVERAGE			
DRIVEWAY			
FENCE HEIGHT			
GARDEN SUITE SETBACK	To permit an addition to an existing Legal Non-Conforming Garden Suite having a setback of 0.0m to the interior property line	Whereas the by-law requires a minimum interior side yard width of 1.2m	10.16.2(e)
GARDEN SUITE GFA	To permit an increase of GFA of 65.33m² to an existing legal nonconforming garden suite, with an existing gross floor area of 63.95m² resulting in a total GFA of 129.28m²	Whereas the by-law permits a maximum of Garden Suite Gross Floor Area of 80m² on a lot in a Residential Hamlet zone	10.16.2(c)(i)
ACCESSORY STRUCTURE SETBACK			
DRIVEWAY WIDTH			
LANDSCAPE OPEN SPACE	To permit a minimum landscaped open space of 68.71% of the front yard	whereas the by-law a minimum landscaped open space of 70% of the front yard	11.4.2(j)
GARAGE DOOR HEIGHT			



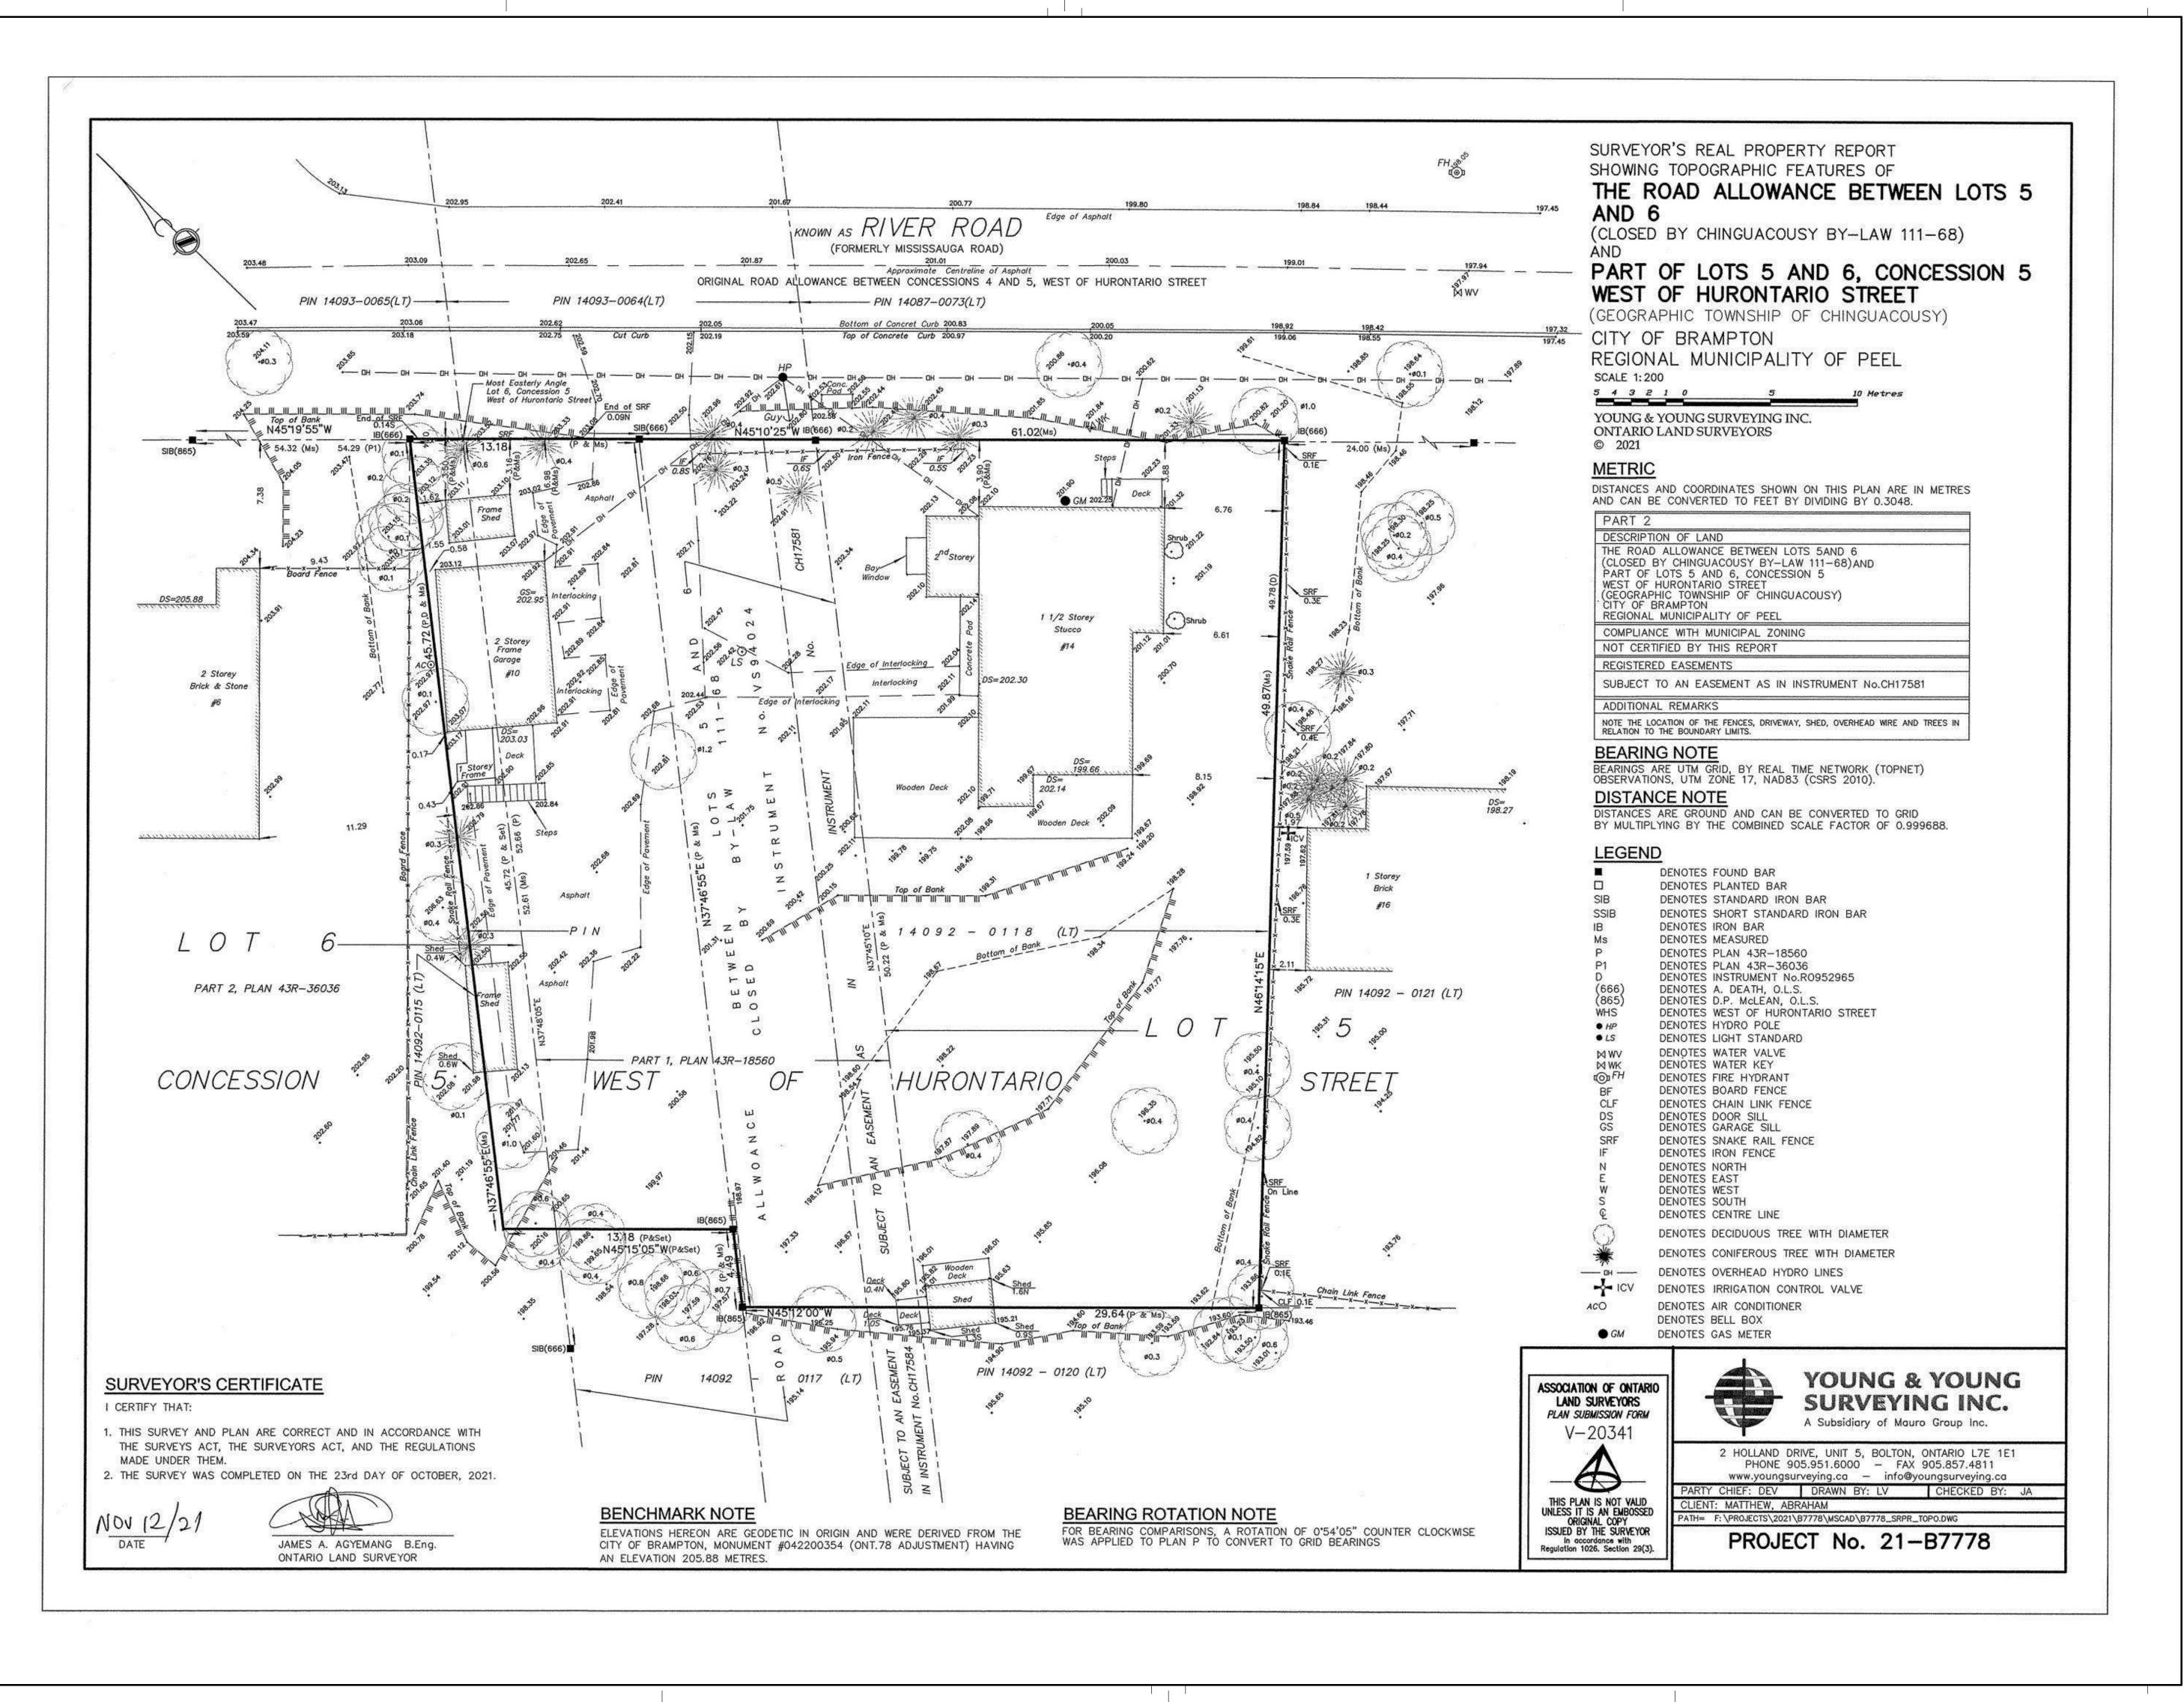

14 RIVER ROAD

BRAMPTON, ON L6X 0A6

CLIENT

Owner



REVISIONS

No.	Description	Date
INO.	Description	Date
018	ISSUED FOR COFA	03/14/2024
016	ISSUED FOR COFA	02/14/2024
015	REISSUED FOR BUILDING PERMIT	02/14/2024
013	ISSUED FOR BUILDING PERMIT	12/01/2023
06	ISSUED FOR BUILDING PERMIT	06/22/2023
04	ISSUED FOR ZONING REVIEW	02/17/2023

Discrepancies must be reported immediately to the Architect before proceeding. Only figured dimensons are to be used. Contractors must check all dimensions on site. This drawing is protected by copyright.

ALL DIMENSIONS ARE SHOWN IN IMPERIAL & METRIC

CONSULTANTS



TORONTO - CANADA 416.546.2040 info@qbsarchitects.cc

SURVEY

DRAWN
PP
SA

SCALE @ ARCH D
DATE
10/20/22

GRAPHIC SCALE


200155


PROJECT NO.

STAGE DRAWING NO.


COFA A0-05

LOCATION HILLS

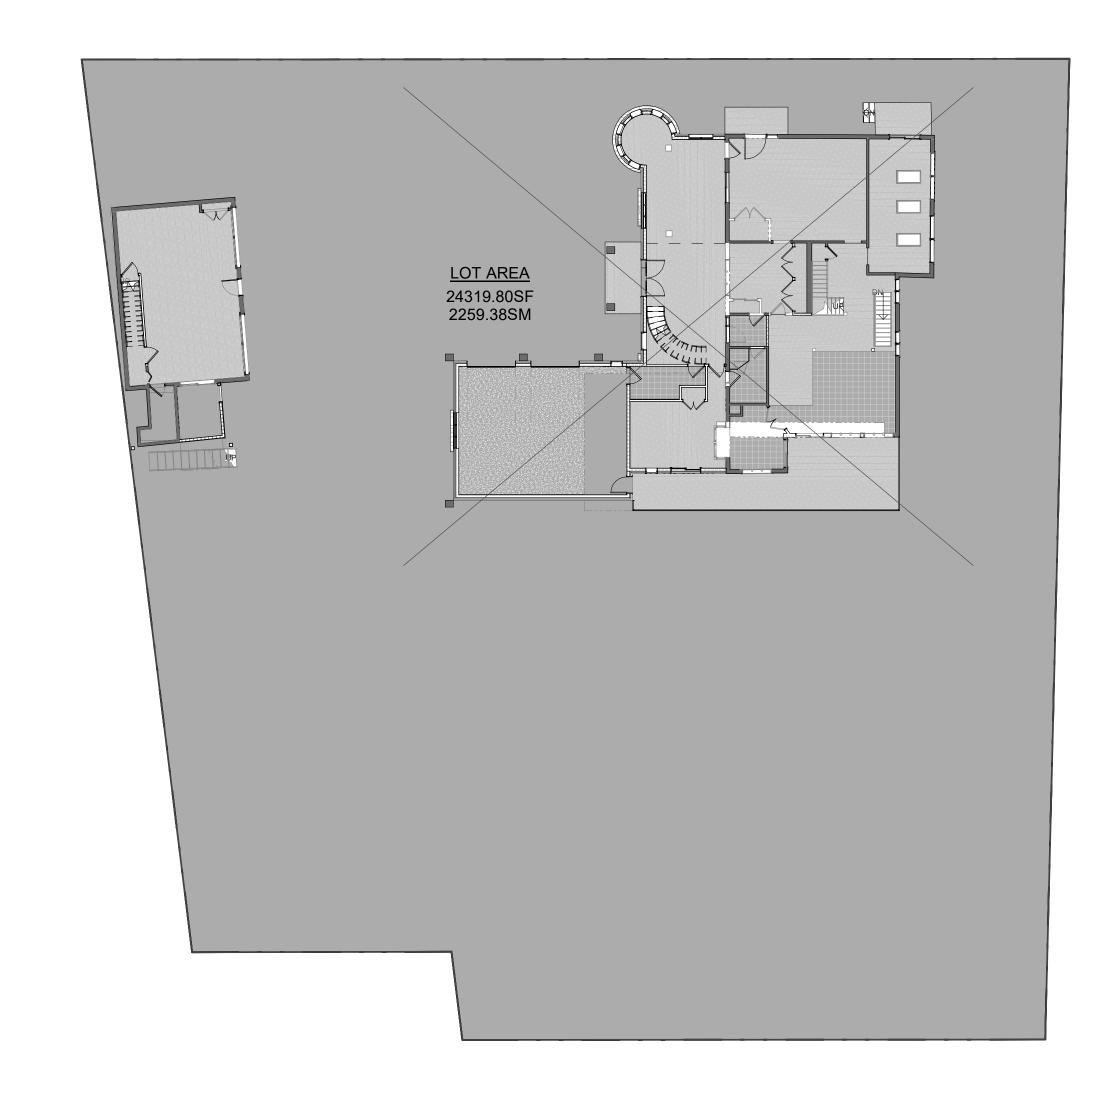

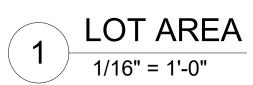

	LOT AREA	
LOT AREA	2259.38 m ²	24320 SF

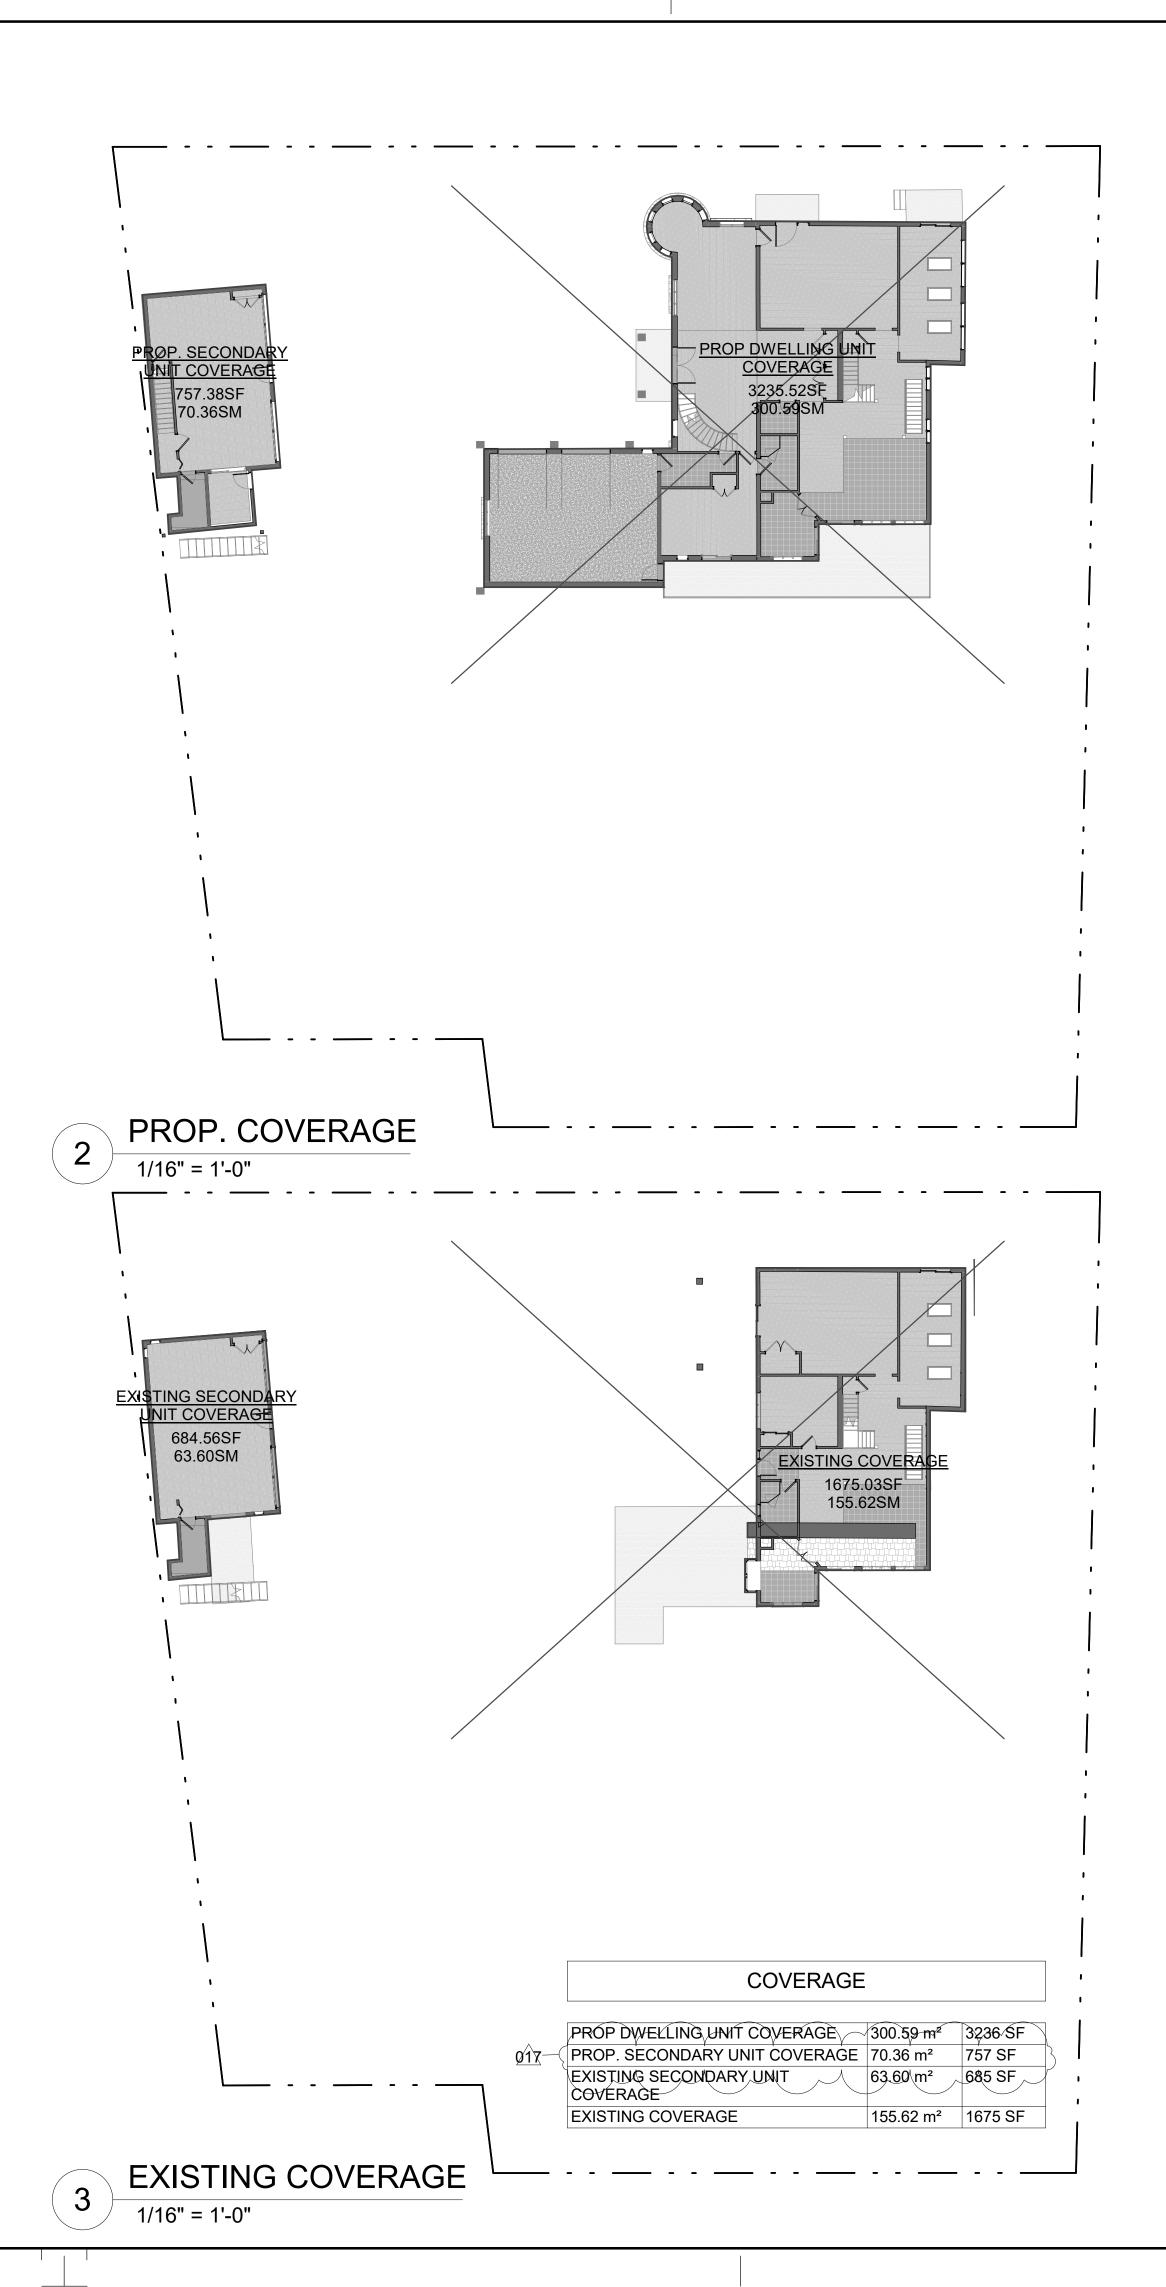

14 RIVER ROAD

BRAMPTON, ON L6X 0A6

Owner



REVISIONS

No.	Description	Date
INO.	Description	Date
018	ISSUED FOR COFA	03/14/2024
017	REISSUED FOR BUILDING PERMIT	03/07/2024
016	ISSUED FOR COFA	02/14/2024
015	REISSUED FOR BUILDING PERMIT	02/14/2024
013	ISSUED FOR BUILDING PERMIT	12/01/2023
06	ISSUED FOR BUILDING PERMIT	06/22/2023
04	ISSUED FOR ZONING REVIEW	02/17/2023

Discrepancies must be reported immediately to the Architect before proceeding. Only figured dimensons are to be used. Contractors must check all dimensions on site. This drawing is protected by copyright.

ALL DIMENSIONS ARE SHOWN IN IMPERIAL & METRIC

CONSULTANTS





TORONTO - CANADA 416.546.2040 info@qbsarchitects.co DRAWING TITLE

LOT AREA AND COVERAGE

CHECKED SCALE @ ARCH D 1/16" = 1'-0"

GRAPHIC SCALE


PROJECT NO. 200155


DRAWING NO.

COFA A0-06


018

HALTON HILLS

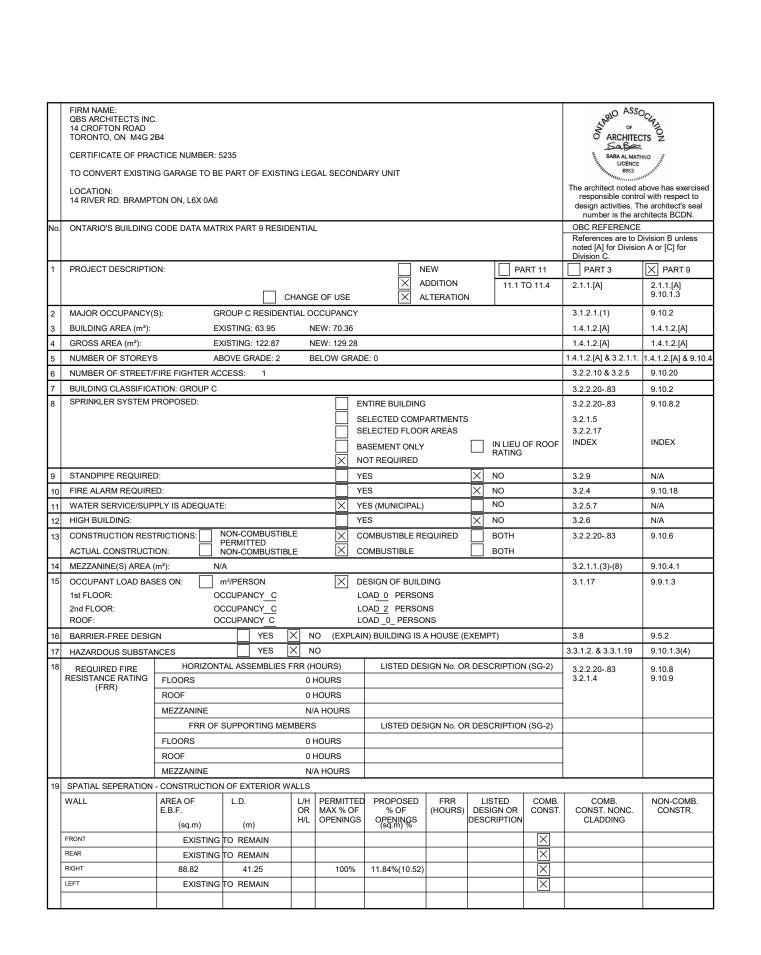


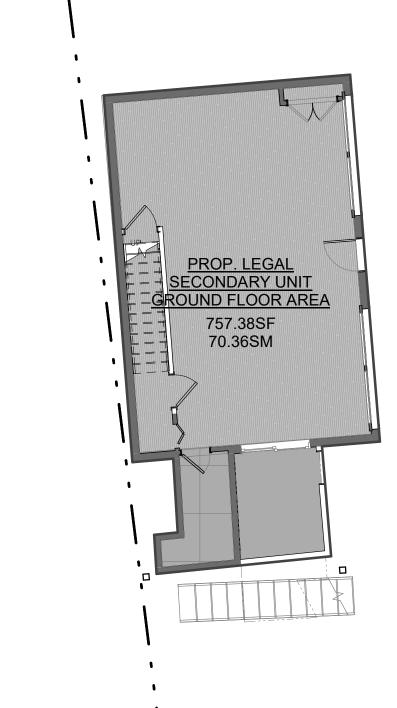


PROPOSED SECONDARY UNIT GROUND FLOOR - EXISTING GARAGE

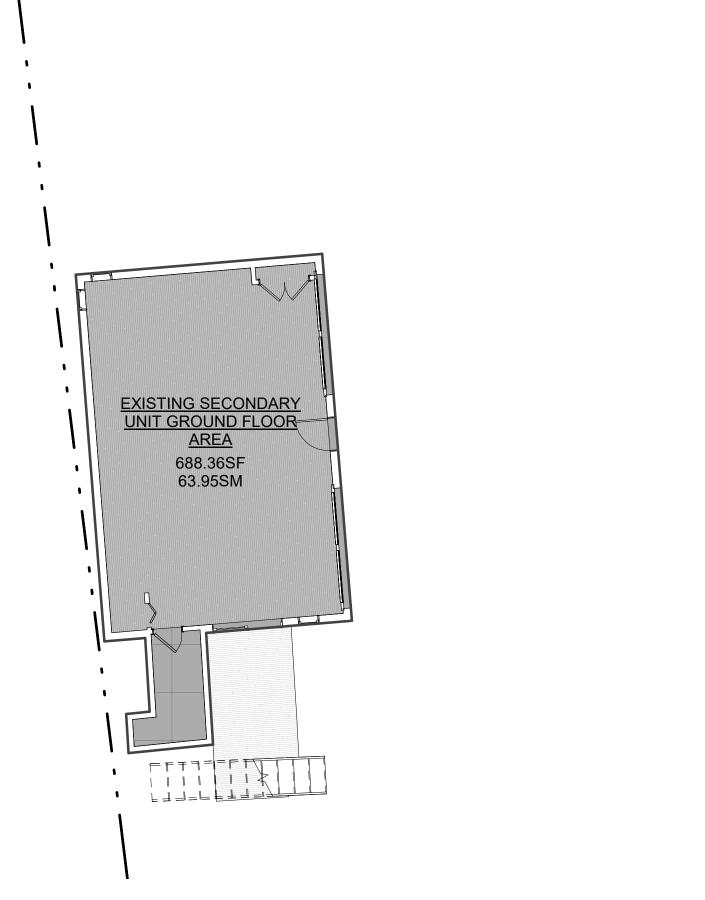

EX SECONDARY UNIT GROUND FLOOR LEVEL

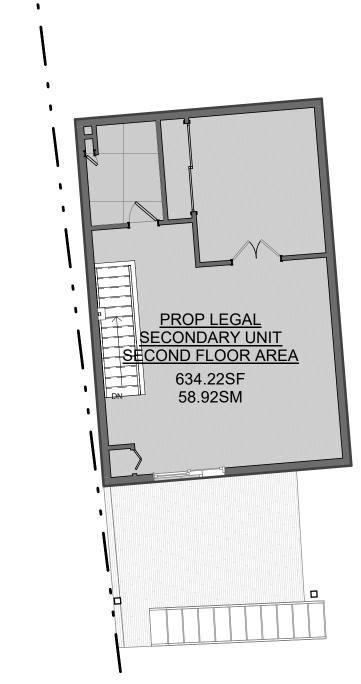

PROPOSED SECONDARY UNIT SECOND FLOOR 1/8" = 1'-0"

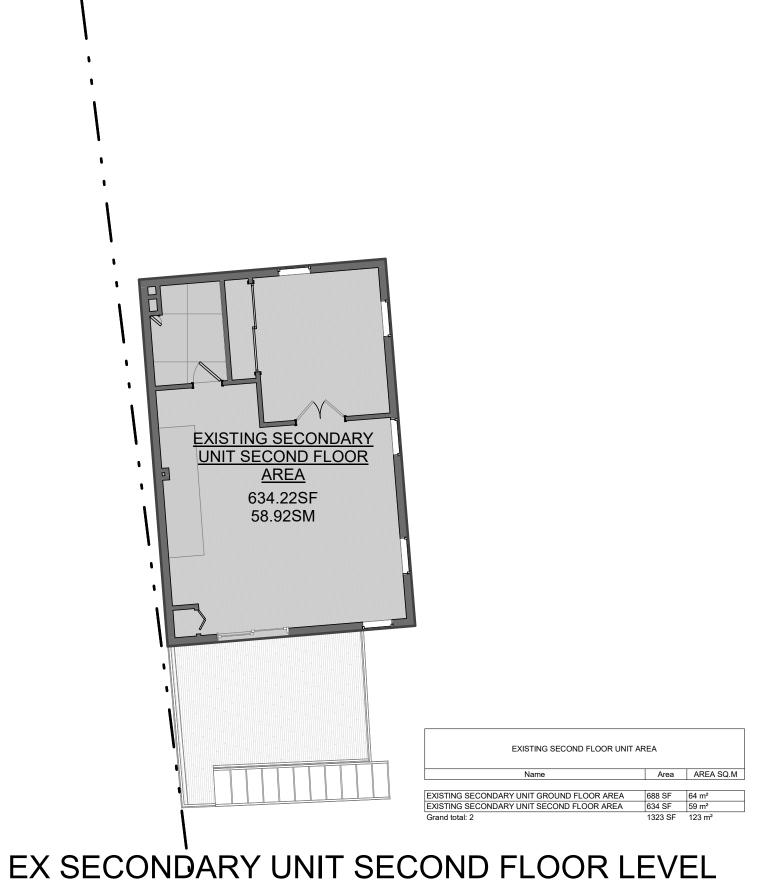

PROJECT

PROPOSED SECONDARY UNIT FLOOR AREAS

PROP. LEGAL SECONDARY UNIT GROUND FLOOR 757.38 SF 70.36 m² | AREA | | PROP LEGAL SECONDARY UNIT SECOND FLOOR | 634.22 SF | 58.92 m² |

14 RIVER ROAD

BRAMPTON, ON L6X 0A6

Owner



REVISIONS

No.	Description	Date
018	ISSUED FOR COFA	03/14/2024
017	REISSUED FOR BUILDING PERMIT	03/07/2024
013	ISSUED FOR BUILDING PERMIT	12/01/2023
06	ISSUED FOR BUILDING PERMIT	06/22/2023

Discrepancies must be reported immediately to the Architect before proceeding. Only figured dimensons are to be used. Contractors must check all dimensions on site. This drawing is protected by copyright.

ALL DIMENSIONS ARE SHOWN IN IMPERIAL & METRIC





TORONTO - CANADA 416.546.2040 info@gbsarchitects.ce DRAWING TITLE

SECONDARY UNIT FLOOR AREA **PLAN**

DRAWN		CHECKE	D
PP			SA
SCALE @ ARCH I As indi		DATE	06/21/23
GRAPHIC		C SCALE	

PROJECT NO.

200155

STAGE DRAWING NO. COFA A0-09

018

HALTON HILLS

CONSTRUCTION NOTES

1 EXCAVATION EVERY EXCAVATION SHALL BE UNDERTAKEN IN SUCH A MANNER AS TO PREVENT MOVEMENT WHICH WOULD CAUSE DAMAGE TO ADJACENT PROPERTY EXISTING STRUCTURES, UTILIITIES, ROADS, AND SIDEWALKS, AT ALL STAGES OF CONSTRUCTION.

WHERE THE DEPTH OF EXCAVATION EXCEEDS 4'-0" EXCAVATE AT A 45 deg ANGLE OR IN ACORDANCE WITH APPROVED SHORING DETAIL. STRUCTURE IS NOT TO BE LOCATED ON GROUNDS HAVING A SLOPE STEEPER THAN ONE VERTICAL TO TWO HORIZONTAL.

- 5" MIN. PROJECTION X 8" DEEP POURED CONCRETE
- 2 - 15M HORIZONTAL BARS CONTINUOUS KEY FOOTING TO FOUNDATION WALL W / 10 M
REBAR DOWELS @ 32" O.C.
- FOOTINGS (MINIMUM 2200 PSI @ 28 DAYS CONCRETE) MUST BEAR ON UNDISTURBED
SOIL CAPABLE OF 3,000 PSF LOADING BOTTOM OF FOOTING TO BE MIN. 4' - 0" BELOW
LOWEST GRADE ON UNDISTURBED SOIL
- NOTE: CONTRACTOR RESPONSIBLE FOR DETERMINING SHORING METHOD AND / ORTHE EXTENT OF UNDERPINNING (IF REQUIRED) AT NEIGHBOURING PROPERTIES STRUCTURES. NOTE ANGLE OF REPOSE BETWEEN FOOTINGS NOT TO EXCEED 7:11 (VERT.: HORIZ.) ALL FOOTINGS TO BE HAND CLEANED AND CONCRETED IMMEDIATELY AFTER EXCAVATION. POUR A SKIM COAT OF CONCRETE ON THE BEARING SURFACES OF ALL FOOTING EXCAVATIONS IMMEDIATELY AFTER THE FOOTINGS HAVE BEEN CLEANED, INSPECTED AND APPROVED BY A GEOTECHNICAL ENGINEER

- IF VARIABLE SUBSOIL CONDITIONS OCCUR, A GEOTECHNICAL ENGINEER SHOULD INSPECT ALL FOOTING FOUNDING LEVELS IMMEDIATELY PRIOR TO PLACING OF EITHER REINFORCING BARS OR CONCRETE TO ENSURE COMPLIANCE WITH THE ALLOWABLE SOIL

3 FOUNDATION BACKFILLING - APPLY 12" CLEAR STONE COVER OVER WEEPING TILES - BACKFILL WITH GRANULAR B MATERIAL APPLIED IN 24" LIFTS - PROVIDE 12" LAYER OF COMPACTED TOP SOIL SLOPED AWAY FROM FOUNDATION WALL.

4 FOUNDATION WALL MIN. 4" OF FREE DRAINAGE GRANULAR MATERIAL, AND A B.M.E.C. APPROVED DRAINAGE - 2 COATS ASPHALT EMULSION - 1/2 " CEMENT PARGING COVED OVER FOOTING AND TO 8" ABOVE GRADE EXCEPT AS OTHERWISE NOTED
- POURED CONCRETE (SPECS AS NOTED ON DRAWINGS)

5 FOUNDATION FOOTINGS TO BE FOUNDED ON NATIVE, INORGANIC, UNDISTURBED SOIL CAPABLE OF SUSTAINING MINIMUM 3000 psf OF ALLOWABLE BEARING PRESSURE SLOPE BETWEEN STEPPED OR ADJACENT FOOTINGS SHALL HAVE A MAXIMUM OF 7 VERTICAL AND 10 HORIZONTAL AND STEPS SHALL NOT EXCEED 2'-0" VERTICALLY EXTERIOR FOOTINGS WILL BE FOUNDED AT A LEVEL AT LEAST 4'-0" BELOW FINISHED

6 CONCRETE SLAB ON GRADE - MACHINE TROWELLED 4" POURED CONCRETE WITH A MINIMUM COMPRESSIVE STRENGTH OF 32 MPA AND 5 - 8% AIR ENTRAINMENT
- 6 MIL. VAPOR / MOISTURE BARRIER "SUPER SIX" TURNED AT INSIDE FACE OF FOUNDATION WALL
-5" MIN. COMPACTED CRUSHED CLEAR LIMESTONE ON UNDISTURBED SOIL - NOTE: USE 32MPA AND 5-8% AIR ENTRAINMENT MIN. COMPRESSIVE STRENGHT CONCRETE IN ALLGARAGE (INCLUDING INTERIOR GARAGES) AND EXTERIOR SLABS - SLOPE TO DRAIN @ MINIMUM 1 % SLOPE AS APPLICABLE.

7 WEEPING TILES

- -4" DIA. CORRUGATED PLASTIC WEEPING TILE W/ FILTER "SOCK" (TERRAFIX 270R OR SIMILAR POROUS FIBRE GEOTEXTILE) SET AT BOTTOM OF FOOTING - SURROUND WEEPING TILE WITH 12" MIN. LAYER OF 3/4" SIZE CLEAR LIMESTONE AND SUBSEQUENTLY WRAPPED IN A SECOND LAYER OF NON CLOGGING GEOTEXTILE FILTER

- SLOPE WEEPING TILE TO FROST FREE SUMP PIT & PUMP OR TO DRAIN. NOTE: PROVIDE ACCESS FOR WEEPING TILE CLEAN OUT AT NUMEROUS LOCATIONS. 8 CONCRETE SLAB ON GRADE - PATIO

- "CREDIT VALLEY" FLAGSTONE OR APPROVED EQUAL. RANDOM SQUARE CUT PATTERN OR AS PER PLANS.

- MACHINE TROWELLED 4" POURED CONCRETE WITH A MINIMUM COMPRESSIVE STRENGTH OF 32 MPA AND 5 - 8% AIR ENTRAINMENT - 6 X 6 X 6/6 W.W.M. REINFORCEMENT - 6" MIL. VAPOUR BARRIER "SUPER SIX"
- 5" MIN. COMPACTED CRUSHED CLEAR LIMESTONE ON UNDISTURBED SOIL FOUNDATION AS PER PLAN

- NOTE: CONTRACTOR TO SUPPORT LARGE SLAB AREAS WITH 8" DIA. SONO TUBE FOUNDATIONS C/W REBAR TYING SLAB TO SONO TUBE.
- SLOPE TO DRAIN @ MINIMUM 1 % SLOPE AS APPLICABLE.

9 EXPOSED FOUNDATION WALL - 4" STONE VENEER BONDED SOLID TO 6" CONCRETE BLOCK (MORTAR FILL SPACE BETWEEN STONE AND FOUNDATION WALL)
- 3/16" DIA. CORROSION RESISTANT WIRE TIES, WITH 2" HOOK AT EACH END @ 8"
VERTICALLY, 36" HORIZONTALLY
- 3/16" BLOCK-LOCK @ 16" O.C. VERTICALLY, ALLOW FOR FULL CONTACT WITH STONE

10 INSULATED FOUNDATION WALL - MIN 4" OF EREF DRAINAGE GRANLII AR MATERIAL AND A B M F C APPROVED DRAINAGE LAYER SUCH AS "DELTA MS"

- 2 COATS ASPHALT EMULSION

- 1/2 "CEMENT PARGING COVED OVER FOOTING AND TO 8" ABOVE GRADE EXCEPT AS

OTHERWISE NOTED
- CONCRETE BLOCK (THICKNESS AND REINFORCEMENT AS NOTED IN PLANS) C/W HEAVY
GAUGE BLOCK LOCK (HORIZONTAL) EVERY SECOND COURSE
- 2 X 6 STUDS AT 16"O.C. DAMPPROOFING LAYER (POLY) BELOW STUD PLATE TO GROUND - 5 1/2" (R24) HIGH DENSITY BATT INSULATION - 3 II.2 (R24) HIGH DENSITY BATTINGSCATION - 6 MIL. VAPOUR / AIR BARRIER "SUPER SIX", LAP ALL JOINTS MIN. 3" AND SEAL W/ ACOUSTIC TYPE SEALANT

(11) EXTERIOR WALL HORIZONAL WOOD SIDING - 1" X 6" SOLID WOOD SIDING BY "MAIBEC" RABBITED BEVEL PROFILE, STAINED (COLOUR TO 'TYPAR' HOUSEWRAP BY REEMAY, INSTALL AS PER MANUFACTURER SPECIFICATIONS; LAP & TAPE ALL JOINTS
- 1/2" ORIENTED STRAND BOARD (OSB)

- 1/2 ORIENTED STRAND BOARD (USB)
- 2 X 6 STUDS AT 16" O.C.
- 5.5" HIGH DENSITY BATT INSULATION (R-24)
- 6 MIL. VAPOUR / AIR BARRIER "SUPER SIX". LAP ALL JOINTS MIN. 3" AND SEAL W/
ACOUSTIC TYPE SEALANT
- 1/2" DRYWALL. 5/8" "TYPEX" DRYWALL, WHERE SETBACK IS LESS THAN 4' AWAY FROM 12 PREFAB STONE EXTERIOR WALL

- 1" /2" PREFAB STONE (CONTRACTOR TO
CONFIRM STONE SELECTION W/ ARCHITECT PRIOR TO ORDERING)
- NON-CORROSIVE METAL TIES AT 32" O.C. HORIZONTAL, 16" O.C. VERTICAL
- MASONRY VENTS AT 24" O.C. TOP & BOTTOM OF CAVITY WALL C/W INSECT SCREENS;
COLOUR TO MATCH STONE ROVIDE THROUGH-WALL FLASHING AT BOTTOM OF CAVITY TO MINIMUM 6" UP BEHIND

- 1" AIR SPACE - "TYPAR" HOUSEWRAP BY REEMAY, INSTALL AS PER MANUFACTURER SPECIFICATIONS; LAP & TAPE ALL JOINTS - 1/2" ORIENTED STRAND BOARD (OSB) - "IZ GINERALD STRAIND BOARD (COSD)
- 2" X 6" STUDS AT 16" O.C., DOUBLE PLATE AT TOP
- 6" BATT INSULATION (R-19+5a)
- 6 MIL. VAPOUR / AIR BARRIER "SUPER SIX". LAP ALL JOINTS MIN. 3" AND SEAL W/
ACOUSTIC TYPE SEALANT - 1/2" DRYWALL. - 5/8" "TYPEX" DRYWALL, WHERE SETBACK IS LESS THAN 4' AWAY FROM PROPERTY LINE.

13 STUCCO EXTERIOR WALL - JOINTS AS PER INDUSTRY STANDARD AND AS PER ELEVATIONS (SEE ELEVATIONS / DETAILS FOR STANDARD DECORATIVE WINDOW AND DOOR CASINGS, SILLS, CROWN MOULDING AND BANDING - POURED CONCRETE THRESHOLD OR 6" CUT LIMESTONE SILL AT ALL DOORS)-SEE ELEVATIONS - CGC FINISH COAT ACRYLIC STUCCO, COLOUR AND FINISH TO BE SELECTED BY NOTE: MAINTAIN 8" MIN. BETWEEN STUCCO AND GRADE - NOTE: MAINTAIN 6 MIN. DETWEEN STOCCO AND GRADE - 3 UNDERCOATS OF CGC CEMENT BASED STUCCO - 2" FORMULAR CODEBOARD CONTINUOS INSULATION (R-10); LAP & TAPE ALL JOINTS

- 1/2 EXTERIOR GRADE FIR FLITTOGO -2" X 6" STUDS AT 16" O.C. -6" BATT INSULATION (R-19+5ci) -6 MIL. VAPOUR / AIR BARRIER "SUPER SIX". LAP ALL JOINTS MIN. 3" AND SEAL W/ ACOUSTIC TYPE SEALANT 1/2" DRYWALL. 5/8" "TYPEX" DRYWALL, WHERE SETBACK IS LESS THAN 4' AWAY FROM PROPERTY LINE

- 5/8" TYPEX UNTWALL, WHERE SEIDAGES LESS HEAVE AWATHOUT OF LAND.

- NOTE: CONTRACTOR RESPONSIBLE FOR LAYING MINIMUM 12" WIDE

WASHED RIVERSTONE STRIP OVER FILTER CLOTH AROUND ENTIRE PERIMETER TO PREVENT BACKSPLASH DURING RAINSTORMS (14) FLASHING - PROVIDE PREFINISHED ALUMINUM / COPPER FLASHING IN ALL THE FOLLOWING LOCATIONS
- BENEATH JOINTED MASONRY SILLS

OVER BACKS AND TOPS OF PARAPET WALLS - OVER HEADS OF GLASS BLOCK PANELS
- OVER HEADS OF WINDOWS AND DOORS SET FURTHER THAN 1/4 THE EAVES OVERHANG BELOW THE SOFFIT
- AROUND CHIMNEYS, OR ANY ELEMENTS CROSSING ROOF SURFACES THAT ARE NOT SUPPLIED WITH MANUFACTURERS FLASHING
- AT INTERSECTION OF ROOF SURFACES WITH EXTERIOR WALLS
- AT ALL ROOF VALLEYS

(15) CURVED CORNER BEAD - FLEXIBLE CORNER BEAD AT RADIUSED DRYWALL EDGES MUST BE USED.

/2" EXTERIOR GRADE FIR PLYWOOD

16 HARDWOOD FLOORING - 3/4" X 2 1/4" SELECT RED OAK T & G STRIP FLOORING - BLIND NAIL TO EXISTING / NEW SUBFLOOR. INSTALL WAXED BUILDING PAPER OVER SUBFLOOR PRIOR (USE PREFINISHED HARDWOOD FLOORING - CONFIRM W/ OWNER - SAND STRIP FLOORING TO EXPOSE NATURAL WOOD USING THREE (3) STAGE SANDING - FINISH WITH 100 GRIT PAPER. - STAIN COLOUR TO BE DETERMINED (IF APPLICABLE)

APPLY THREE (3) COATS HIGH QUALITY URETHANE, SANDING LIGHTLY BETWEEN COATS. - NOTE: NO SEALÉR TO BE USED!

(17) EXISTING HARDWOOD FLOORING (RENOVATION) - SAND EXISTING STRIP FLOORING AND IN FILL TO EXPOSE NATURAL WOOD USING THREE (3) STAGE PROCESS.
- FINISH WITH 100 GRIT PAPER (MINIMUM). - FINISH WITH 100 GNIT PAPER (WINNIMOW).
- APPLY THREE (3) COATS HIGH QUALITY URETHANE, SANDING LIGHTLY BETWEEN COATS.
- NOTE: NO SEALER TO BE USED!

18 FLOOR TILING

EMBEDMENT IN EXISTING SOLID MASONRY WALL

(19) LEDGER BOARD

- LAY ASPHALT SHEATHING PAPER, FELT OR POLYETHYLENE FILM GALVANIZED WIRE MESH (2" X 2"), SCRATCH CEMENT COAT (1 1/4" MIN. THICK) TILING / GROUTING (COLOUR TO BE DETERMINED) - NOTE: APPLY 2 COATS OF SEALER FOR STONE FLOORING (AS PER SUPPLIER'S / MANUFACTURER'S SPECIFICATIONS).

- CONTINUOUS 2 - 2 X 10 OR AS PER PLANS GLUED LEDGER BOLTED WITH STAGGERED 3/4" DIA. RAM SET RED HEAD DYNA BOLTS @ 18" O.C. - MIN. 2 1/2"

20) <u>ENGINEERED HARDWOOD FLOORING</u>
- CONCRETE SUBFLOORS: MUST BE DRY, SMOOTH (LEVEL WITHIN 3/16" IN A 10' RADIUS - CONCRETE SUBFLOORS: MUST BE DRY, SMIDOTH (LEVEL WITHIN 3/10 IN A 10 RADIOS 1/8" IN 6') AND FREE OF STRUCTURAL DEFECTS. HAND SCRAPE OR SAND WITH A 20-GRIT -#3-1/2" OPEN FACE PAPER TO REMOVE LOOSE, FLAKY CONCRETE. GRIND HIGH SPOTS IN CONCRETE AND FILL LOW SPOTS WITH A PORTLAND BASED LEVELING COMPOUND (MIN. 3,000 PS)). CONCRETE MUST BE FREE OF PAINT, OIL, EXISTING ADHESIVES, WAX, GREASE, DIRT AND CURING COMPOUNDS. THESE MAY BE REMOVED MECHANICALLY BUT DO NOT USE SOLVENT-BASED STRIPPERS UNDER ANY CIRCUMSTANCES. THE USE OF RESIDUAL SOLVENTS CAN PROHIBIT THE SATISFACTORY BOND OF FLOORING ADHESIVES.

- IT IS IMPORTANT TO ENSURE A PROPER BOND BETWEEN THE ADHESIVE AND THE CONCRETE, AND PLANKS OR STRIPS, ENGINEERED HARDWOOD FLOORING MAY BE NSTALLED ON-GRADE, AS WELL AS BELOW GRADE WHERE MOISTURE CONDITIONS

- LIGHTWEIGHT CONCRETE: LIGHTWEIGHT CONCRETE WITH A DRY DENSITY OF 100 POUNDS OR LESS PER CUBIC FOOT IS ONLY SUITABLE FOR ENGINEERED WOOD FLOORS WHEN USING THE FLOATING INSTALLATION METHOD. MANY PRODUCTS HAVE BEEN DEVELOPED AS SELF-LEVELING TOPPINGS OR FLOOR UNDERLAYMENTS. THESE INCLUDE CELLULAR CONCRETE, RESIN-REINFORCED CEMENTATIONS UNDERLAYMENTS, AND GYPSUM-BASED MATERIALS. ALTHOUGH SOME OF THESE PRODUCTS MAY HAVE THE NECESSARY QUALIFICATIONS FOR UNDERLAYMENT FOR WOOD FLOORING NSTALLATIONS, OTHERS DO NOT. TO TEST FOR LIGHTWEIGHT CONCRETE, SCRAPE A COIN OR KEY ACROSS THE SURFACE TO TEST FOR LIGHTWEIGHT CONCRETE, SCRAPE A COIN OR KEY ACROSS THE SURFACE
OF THE SUBFLOOR.
 IF THE SURFACE POWDERS EASILY OR HAS A DRY DENSITY OF 100 POUNDS OR LESS
PER CUBIC FOOT, USE ONLY THE FLOATING INSTALLATION METHOD.
 TO ENSURE A LONG LASTING BOND, MAKE SURE THAT THE PERIMETER OF THE
FOUNDATION HAS ADEQUATE DRAINAGE AND VAPOR BARRIER.

WOOD SUBFLOORS: WOOD SUBFLOORS NEED TO BE WELL NAILED OR SECURED WITH - WOOD SUBFLOORS: WOOD SUBFLOORS NEED TO BE WELL NAILED OR SECORED WITH SCREWS, NAILS SHOULD BE RING SHANKS AND SCREWS NEED TO BE COUNTER SUNK.

- THE WOOD SUBFLOOR NEEDS TO BE STRUCTURALLY SOUND AND DRY. IT SHOULD NOT EXCEED 13% MOISTURE PRIOR TO INSTALLATION.

- IF THE SUBFLOOR IS SINGLE LAYER, LESS THAN 3/4" THICK, ADD A SINGLE CROSS LAYER FOR STRENGTH AND STABILITY (MINIMUM 5/16" THICK FOR A TOTAL 1" THICKNESS).

- THIS IS TO REDUCE THE POSSIBILITY OF SQUEAKING.

- WOOD SUBFLOORS MUST BE FREE OF PAINT, OIL, EXISTING ADHESIVES, WAX, GREASE, DIRT LIREFTHANE VARRISH FTC. DIRT, URETHANE, VARNISH, ETC. · UNDERLAYMENT GRADE OSB (NOT THE WAX SIDE) IS ALSO A SUITABLE SUBFLOOR. PARTICLEBOARD IS NOT AN ACCEPTABLE SUBFLOOR FOR STAPLE OR NAIL DOWN INSTALLATIONS BUT CAN BE USED AS A SUBFLOOR IN

GLUE-DOWN INSTALLATIONS.
WHEN INSTALLING OVER EXISTING WOOD FLOORING, INSTALL AT RIGHT ANGLES TO THE - SUBFLOOR MOISTURE CHECK: ENGINEERED HARDWOOD FLOORING MAY BE USED FOR ABOVE-, ON-, AND BELOW-GRADE APPLICATIONS. ON ALL COMMON SUBSTRATES, ON-AND BELOW-GRADE APPLICATIONS ARE SUSCEPTIBLE TO MOISTURE AND SHOULD BE ON-AND BELOW-GRADE APPLICATIONS ARE SUSCEPTIBLE TO MOISTORE AND SHOULD BE TESTED FOR MOISTURE PRIOR TO INSTALLATION IN SEVERAL LOCATIONS WITHIN THE INSTALLATION AREA. - ACCEPTABLE CONDITIONS FOR ABOVE-, ON-, AND BELOW-GRADE APPLICATIONS ARE: LESS THAN 3 1BS. /1000 SF / 24 HRS. ON A CALCIUM CHLORIDE TEST
OR AN ACCEPTABLE READING ON AN ELECTRONIC CONCRETE MOISTURE METER
WOOD SUBSTRATES MUST HAVE A MOISTURE READING OF LESS THAN 13% WHEN USING AN ELECTRONIC WOOD MOISTURE METER

IIMPORTANT NOTE:THE ABOVE IS A GUIDE LINE. INSTALLER MUST FOLLOW MANUFACTURES INSTALLATION INSTRUCTIONS ASSOCIATED WITH THE PRODUCT

21 GUARD DESIGN LOADS MINIMUM SPECIFIED HORIZONTAL LOAD APPLIED INWARD OR OUTWARD AT THE TOP OF EVERY REQUIRED GUARD SHALL BE:

1) A UNIFORM LOAD OF 50 LB/FT OR A CONCENTRATED LOAD OF 225 LBS

2) A VERTICAL LOAD OF 100 LB/FT, WHICH NEED NOT ACT SIMULTANEOUSLY WITH THE HORIZONTAL LOAD 3) INDIVIDUAL ELEMENTS ARE TO BE DESIGNED FOR A CONCENTRATED LOAD OF 113 LBS 3) INDIVIDUAL ELEMENTS ARE TO BE DESIGNED FOR A CONCENTRATED LOAD OF 113 LBS AT ANY POINT OPENING THROUGH ANY GUARD SHALL BE OF SIZE, WHICH WILL PREVENT THE PASSAGE OF A SPHERICAL OBJECT HAVING A DIAMETER OF MORE THAN 4 IN. GUARDS SHALL BE DESIGNED/INSTALLED SO THAT NO MEMBER ATTACHED OR WALKING SURFACE WILL FACILITATE CLIMBING.
OR OPENING LOCATED BETWEEN 4 IN. AND 35 IN. ABOVE THE FLOOR

22 ROOF CONSTRUCTION - ASPHALT SHINGLES (25 YEARS) - COLOUR TO MATCH EXIST.
- 1/2" PLYWOOD SHEATHING (WITH "H"CLIPS IF USING TRUSSES)
- ROOF STRUCTURE AS SPECIFIED IN PLAN
- PROVIDE ICE AND WATER SHIELD EAVES PROTECTION TO EXTEND 36" MIN. BEYOND INTERIOR FACE OF EXTERIOR WALL. MIN. 3" LAP AND 6" END LAP (AS PER 9.26.5 OBC)
- PREFINISHED ALUMINUM DRIPEDGE BELOW SHINGLES
- PREFIN AL HIMMINIM FAVESTROLIGH ON WOOD FASCIA AND VENTED - PREFIN. ALUMINUM EAVESTROUGH ON WOOD FASCIA AND VENTED SOFFIT WITH INSECT SCREEN TO MATCH EXISTING - 2" X 6" CELING JOISTS @ 16" O.C. (OR AS NOTED IN PLANS)
- 11" (R-32) BATT INSULATION - BAFFLE AS REQUIRED FOR VENTILATION
- 6 MIL. VAPOUR / AIR BARRIER "SUPER SIX". LAP ALL JOINTS MIN. 3" AND SEAL W/ ACOUSTIC TYPE SEALANT

PREFINISHED ALUMINUM SOFFIT WITH INSECT SCREENING - LAY ALUMINUM PANELS WITH CORRUGATIONS PERPENDICULAR TO FASCIA - SEE PLANS FOR OVERHANG DIMENSION.

24 EAVESTHROUGH/DOWNPIPES - 5" -6" MAX WIDE PREFINISHED ALUMINUM EAVESTROUGH (COLOUR TO BE DETERMINED)
- 3" X 4" PREFINISHED ALUMINUM DOWNPIPES (COLOUR TO BE DETERMINED) C/W
CONCRETE SPILL PAD (SLOPE AWAY FROM BUILDING) NOTE: DOWNPIPES ROUTING TO BE DISCUSSED W/ ARCHITECT PRIOR TO INSTALLATION. 25 DESIGN LOADS - DEAD LOAD AT TOP CHORD 9 LB / SQFT - LIVE LOAD STANDARD AS PER LOCAL MUNICIPAL REQUIREMENTS (UNLESS NOTED

- 1/2" EXTERIOR GRADE PLYWOOD SHEATHING W/ "H" CLIPS. (26) CEILING VENTILATION - CONTRACTOR TO PROVIDE ADEQUATE VENTILATION - MIN. VENT AREA: 1/150 FOR FLAT

- CONTRACTOR TO PROVIDE ADEQUATE VENTILATION - MIN. VENT AREA. 17150 FOR FLAT ROOFS) OF INSULATED CEILING AREA; ENSURE INSECT SCREEN. - INSTALL "LEXSUCO" ROOF STACK VENTS TO BE UNIFORMLY DISTRIBUTED AND INSTALLED AS PER MANUFACTURER'S SPECS. (SIZE AND NUMBER TO BE DECIDED ON SITE) - SOFFIT VENTS TO BE INSECT SCREENED - COLOUR OF ROOF VENTS TO BE DECIDED 27 ROOF/ATTIC VENTILATION

- CONTRACTOR TO PROVIDE ADEQUATE VENTILATION AT BOTH NEW AND EXISTING STRUCTURE - MIN. VENT AREA: 1/300 (1/150 FOR FLAT ROOFS) OF INSULATED CEILING AREA; ENSURE INSECT SCREEN. VENTS TO BE UNIFORMLY DISTRIBUTED - NOTE: ROOF / ATTIC VENTS MUST NOT BE PLACED AT FRONT ELEVATION / ROOF LINE. - CHECK ELEVATION DRAWINGS FOR ANY SPECIFIC ROOF VENT SOFFIT VENTS TO BE INSECT SCREENED
COLOUR OF ROOF VENTS TO MATCH SHINGLES.

28 INSULATED INTERIOR WALL 1/2" DRYWALL - 2" X 6" STUDS - 6" (R22) BATT INSULATION - 6MIL VAPOUR / AIR BARRIER "SUPER SIX" WITH ALL JOINTS SEALED W/ ACOUSTIC TYPE 1/2" DRYWALL

29 INSULATION ON EXISTING WALL - NO. 15 ASPHALT FELT TO GRADE - 2" X 4" STUDS AT 16" O.C. AMPPROOFING LAYER (BLACK POLY) BELOW STUD PLATE DAMPPROUPING LATER (BLACK POLT) BELOW STOU PLATE

3 1/2" (R 14) BATT INSULATION

6 MIL. VAPOUR / AIR BARRIER "SUPER SIX" WITH ALL JOINTS SEALED W/ ACOUSTIC - 1/2" DRYWALL.

30 ACOUSTICAL TREATMENT 4" SOUND ATTENUATION BLANKET INSTALLED BETWEEN STUDS TYPICAL BETWEEN BEDROOMS AND BATHS

31 BEARING STUD WALL - 2 X 4 STUDS AT 16" O.C. (W/ DOUBLE PLATES)

32 DRYWALL INSTALLATION - ALL DRYWALL TO BE INSTALLED WITH BEVELLED EDGE JOINTS FACING EACH OTHER
- ONLY ONE HORIZONTAL JOINT WILL BE ALLOWED. IF AN ADDITIONAL HORIZONTAL JOINT IS REQUIRED DUE TO WALL HEIGHTS, THE JOINTS MUST BE PLACED AT THE BOTTOM OF THE WALL IN THE BASEBOARD AREA. USE 4'-6" WIDE BOARDS FOR 9'-0" HIGH CEILINGS.

33 DRYWALL ON EXISTING WALL (RENOVATION) - 1/2" DRYWALL GLUED DIRECTLY ON EXIST. MASONRY WALL / OR USE STRAPPING AS - (USE 2 X 2 STRAPPING, 1 1/2" DOW "SM" RIGID INSULATION AND "SUPER SIX" VAPOUR / AIR BARRIER ON EXTERIOR MASONRY WALLS.)

34 MASONRY INFILL - 4" BRICK FACE TO MATCH EXISTING. NOTE: MASONRY MUST BE TOOTHED IN AT PERIMETER OF OPENING (TINT MORTAR TO MATCH EXISTING - NON CORROSIVE METAL TIES @ 24" O/C VERTICAL - 4" BRICK / CONCRETE BLOCK BACKUP OR 2/ 6 STUDS AND 5/8" EXTERIOR GRADE FIR PLYWOOD IF VENEER TYPE CONSTRUCTION.

35 SILL PLATE - 2 X 6 PRESSURE TREATED SILL PLATE SET ON CONTINUOUS MORTAR BED W/1/2" DIA., 12" LONG (MIN. 4" IN CONCRETE.) ANCHOR BOLTS AT 7'-10" MAX. O.C. INTO CONCRETE FILLED TOP COURSE
- ROLL TYPE FOAM GASKET BETWEEN PLATE AND BEDDING & 6 MIL POLY VAPOUR / AIR

(36) TYPICAL INTERIOR PARTITION - 1/2" DRYWALL BOTH SIDES

37 PAINTING - ALL INTERIOR WOOD TRIM: ONE COAT OIL BASED PRIMER, TWO (2) COATS SEMI- GLOSS · ALL DRYWALL SURFACES: ONE COAT LATEX SEALER. TWO (2) COATS SATIN / EGGSHELL - ALL EXTERIOR WOOD TRIM: ONE COAT OIL BASED PRIMER, 2 COATS OIL FINISH - ENAMEL GLOSS - ALL COLOURS TO BE SELECTED BY ARCHITECT / CLIENT. - NOTE: REPAINT ALL WOOD DOORS AND WINDOWS PRIME PLUS ONE FINISH COAT PRIOR TO INSTALLATION.

38 EXTERIOR WINDOWS / DOORS - ALL WINDOWS ARE TO BE WOOD FRAMED CASEMENTS SEALED CLEAR WOOD INTERIOR AND "FLEXACRON" FACTORY PREFINISHED EXTERIOR SURFACES c/w FOLDING TYPE CHANK HANDLE
- ALL GLAZING TO BE CLEAR LOW "E" SEALED THERMOPANE UNITS, ARGON GAS FILLED,
7/8" OVERALL THICKNESS
- CONTRACTOR TO SUBMIT NAME AND TYPICAL DETAILS OF PROPOSED MANUFACTURER
TO THE ARCHITECT FOR APPROVAL.
- NOTE: CONTRACTOR TO SUPPLY AND INSTALL 6" SMOOTH CUT LIMESTONE THRESHOLD AT ALL EXTERIOR DOORS AND 5" AT ALL WINDOWS (UNLESS OTHERWISE NOTED). WINDOW/DOOR HEADER TO BE AT U/S OF JOISTS DIRECTLY ABOVE SWIMMING POOLS: WHERE A WALL OF A BUILDING FORMS PART OF THE SWIMMING POOL ENCLOSURE, ANY GROUND FLOOR WINDOWS IN THE SAID WALLS ARE TO HAVE A SILL HEIGHT OF 4'-11"(1, SM)min. OR A GUARD TO BE PERMANENTLY INSTALLED ON THE WINDOW TO PREVENT THE PASSAGE OF A 4" DIA. SPHERICAL OBJECT TO COMPLY WITH OBC 9.7

- 6" HEIGHT SMOOTH CUT PUFF INDIANA LIMESTONE SILL

- 6" GRANULAR "A" GRAVEL COMPACTED
- "LEGACY" RETAINING WALL BY "DECRA-LOC" OR SIMILAR C/W CAPS AND CORNER UNITS
INSTALLED AS PER MANUFACTURER'S SPECIFICATION
- FILL AREA DRAIN WITH GRAVEL AND TERMINATE AT WEEPING TILE
- NOTE: ENSURE 8" CLEARANCE FROM WINDOW SILL TO TOP OF GRAVEL FILL.
- INSTALL CLOSED CELL EXPANSION JOINT BETWEEN WINDOW WELL AND FOUNDATION

- SOLID WOOD (UNLESS NOTED OTHERWISE) 1 3/4" THICK WITH TWO RECESSED RAISED OR RECESSED FLAT WOOD PANELS AS PER DETAIL SKETCH PROVIDED BY THE

DOOR HEIGHTS: GROUND FLOOR = 96" DOORS NOTE: BUILDER/ OWNER TO CONTACT ARCHITECT FOR FINAL DECISION REGARDING NOTE: STRUCTURAL FRAMING AT DOORS/ WINDOWS/ FLAT ARCHES TO BE KEPT AS HIGH AS POSSIBLE TO ALLOW FOR FUTURE DISCUSSION/ HEIGHT ADJUSTMENT

42 POCKET DOOR ENCLOSURE WALL - MINIMUM WIDTH REQUIRED - 1/2" DRYWALL ON 1/2" PLYWOOD BOTH SIDES MINIMUM REQUIRED METAL STUDS - BOTH SIDES (UNLESS OTHERWISE NOTED) - MINIMOM REQUIRED MICH STUDY - BOTH SIDES (UNLESS OTHERWISE NOTED)
- REFER TO DRAWINGS FOR EASING
- INSTALL "N.C. CROWDER" (C-500 SINGLE POCKET DOOR TRACK, NYLON WHEELS W/ BEARING FOR 100 LB DOOR.

43 SHOWER DOOR - 2' - 0" X 6' - 0" (OR AS PER PLAN) TEMPERED GLASS DOOR - PROVIDE MIN. 6" CLEAR ABOVE DOOR - HARDWARE FINISH TO BE POLISHED CHROME UNLESS NOTED OTHERWISE - INSTALL GRANITE / MARBLE SURROUND AROUND SHOWER OPENING. 44 SHOWER / LAUNDRY MACHINE FLOOR PAN

- SHOWER LINER BY "AQUAPROOF AQ 530 (OR EQUAL) RETURN UP PAN CURB AND ALL SURROUNDING WALLS
- ADHERE LINER TO DRAIN SLOPE CEMENT BASE TO DRAIN - USE BRAIDED HOSES FOR WASHING MACHINE

45 BATHTUB AND SHOWER WALL - USE TILE-BACKER WATER-RESISTANT - 1/2" "DENS-SHIELD" TILE BACKER BY GEORGIA-PACIFIC AT ALL SURROUNDING WALLS. TAPE WITH 2' WIDE 10 X 10 GLASS MESH SELF ADHESIVE TAPE USE BLUEBOARD AT REMAINING BATHROOM WALLS.

46 HANG ROD & SHELF - 1 1/4" DIA. HANG ROD W/ BRACKETS - ALL CHROME FINISH INSTALL @ 5'-6" O.C. A.F.F. - 3/4" MELAMINE BOARD (WHITE), FINISHED EDGES, 1'-3" DEPTH, ON LEDGER BOARDS @ 2" OVER HANG ROD.

47 MILLWORK CASING # 106 / # 110 BACKBAND # 83 / # 24 STOOL # 80 / # 79 APRON # 106 / # 110 (CUT DOWN TO 3") BASEBOARD # 206 / # 54 /# 51 (ALL 1 X 8)
BASEBOARD # 206 / # 54 /# 53 (ALL 1 X 6 AT BASEMENT)
QUARTER ROUND # 65 / # 14
CROWN MOULDING # 4 (AT CEILINGS) 3 3/4" X 3 3/4" # 3 (AT COFFERS) 3" X 3" #77/#82 # 23 / # 64 / # 46 SHINGLE COVE #7/#9 DOOR STOP DOOR STOP #52 / #52B - NOTE: REFER TO REFLECTED CEILING PLANS FOR EXTENT OF ALL WINDOW OPENINGS TO BE TRIMMED WITH CASING, BACKBAND, STOOL AND APRON (NO PICTURE FRAMING UNLESS NOTED).

- MIN. 4' - 0" LENGTHS OF ALL WOOD TRIM SAMPLES TO BE MOUNTED ON SITE FOR FINAL APPROVAL. - ALL WOOD TO BE WHITE WOOD FOR PAINTING UNLESS OTHERWISE NOTED.

48 SHELVING PROVIDE (6) 1'-6" DEEP ADJUSTABLE SHELVES.

PAINT ALL WOOD TRIM, PRIME PLUS ONE FINISH COAT PRIOR T

49 WOOD STRUCTURE INSTALLATION ALL DESIGN DETAILS, HANDLING AND INSTALLATION OF PROPRIETARY WOOD PRODUCTS SHALL BE IN STRICT COMPLIANCE WITH MANUFACTURERS SPECIFICATIONS AND PROVIDE POSTS UNDER ALL BEAMS/GIRDER TRUSSES ETC. POSTS ARE TO RUN CONTINUOUS TO THE FOUNDATION OR EQUIVALENT SUPPORT

MIN. RUN: 8 1/4' MIN. TREAD: 9 1/4"
MIN. NOSING: 1" WHEN RUN LESS THAN 9 7/8" MIN. WIDTH: 2'-10" BETWEEN WALL FACES MIN. HEADROOM: 6'-8" MIN. HANDRAIL HEIGHT: 2'-8" MAX. HANDRAIL HEIGHT: 3'-2"

FACUTATE CLIMBING AS PER 9.8.8.6. (2)

- SLATE TILES (CONFIRM WITH OWNER)
- 2" LIGHT CONCRETE BEDDING W/ GALVANIZED WIRE MESH (2"X2") - 2 LIGHT COUNCETE BEDDING W. GALVANIZED WIRE MESH (2 A2)
- ISOLATION MEMBRANE
- SLOPE TO SCUPPER DRAIN
- TILING / GROUTING (COLOUR TO BE DETERMINED)
- NOTE: APPLY 2 COATS OF SEALER FOR STONE FLOORING (AS PER SUPPLIER'S / MANUFACTURER'S SPECIFICATIONS).
- REFER TO SPEC. # FOR ROOF CONSTRUCTION.

\$\langle 52 \rangle \text{WOOD DECK AND STEPS} USE PRESSURE TREATED WOOD - USE PRESSURE TREATED WOOD -2" X 4" / 2" X 6"DECKING AS PER PLANS (1/8" SPACING BETWEEN BOARDS) -2" X 8" @ 16" O.C. JOISTS - PROVIDE SOLID CROSS BRIDGING AT MAX. 6' - 0" O.C.

(53) RESIDENTIAL - GUARD DESIGN LOADS - MINIMUM SPECIFIED HORIZONTAL LOAD APPLIED INWARD OR OUTWARD AT THE TOP OF EVERY REQUIRED GAURD SHALL BE:

1) A UNIFORM LOAD OF 50 LB/FT OR A CONCENTRATED OAD OF 225 LBS

2) A VERTICAL LOAD OF 100 LB/FT, WHICH NEED NOT ACT SIMULTANEOUSLY WITH THE HORIZUNI AL LUAD.

3) INDIVIDUAL ELEMENTS ARE TO BE DESIGNED FOR A CONCENTRATED LOAD OF 113 LBS AT ANY POINT. OPENING THROUGH ANY GUARD SHALL BE OF SIZE WHICH WILL PREVENT THE PASSAGE OF A SPHERICAL OBJECT HAVING A DIAMETER OF MORE THAN 4 IN. GUARDS SHALL BE DESIGNED/ INSTALLED SO THAT NO MEMBER ATTACHED OR OPENING LOCATED BETWEEN 5.5" AND 35,5 ABOVE THE FLOOR OR WALKING SURFACE WILL

-4" RIGID METAL DRYER EXHAUST DUCT - PLASTIC EXHAUST GRILLE COMPLETE WITH INSECT SCREEN SECURELY FASTENED TO EXTERIOR WALL FACE AND CAULKED.

55 EXHAUST GRILL - METAL GRILLE WITH INSECT SCREEN
- DIMENSION TO SUIT EXHAUST REQUIREMENTS
- NOTE: CONTRACTOR TO COORDINATE DUCT RUN WITH OTHER MECHANICAL RUNS, PLUMBING RUNS AND STRUCTURE TO ELIMINATE NEED FOR BULKHEADS.

(56) GAS & EXHAUST FUMES PROTECTION - 1/2" PLYWOOD BEHIND - 5/8" "TYPE X" DRYWALL FOR FIRE PROTECTION. TAPED AND SPACKLED. - PROVIDE HIGH DENSITY POLYETHYLENE LAP, TAPE AND SEAL ALL JOINTS TO INTERIOR WALLS AND CEILING

ALL MECHANICAL EXHAUST VENTS, EXHAUST AND INTAKES, TO BE INSTALLED AS PER PERTINENT CODE REQUIREMENTS AND MANUFACTURERS INSTR 58 VENT GRILL

- METAL GRILLE WITH INSECT SCREEN
- DIMENSION TO SUIT EXHAUST REQUIREMENTS
- NOTE: CONTRACTOR TO COORDINATE DUCT RUN WITH OTHER MECHANICAL RUNS. PLUMBING RUNS AND STRUCTURE TO ELIMINATE NEED FOR BULKHEADS

(59) CARBON MONOXIDE DETECTOR - INSTALL CARBON MONOXIDE DETECTOR CONFORMING TO CAN/CGA-6.19 OR ULC 2034 - MUST COMPLY TO $\underline{\rm OBC}~9.33.4$

60 SMOKE ALARM - INSTALL SMOKE ALARM, HARDWIRED WITH BATTERY BACKUP IN EACH FLOOR AND IN EACH SLEEPING ROOM
- ALL SMOKE ALARMS TO CONFORM TO CAN/ULC-S531 AND S553 - MUST COMPLY TO OBC 9.10.19
- SHALL HAVE A SIGNALLING COMPONENT CONFORMING TO THE REQUIREMENTS IN 18.5.3 T, COLOUR, AND PULSE CHARACTERISTICS OF NFPA 72 (NATIONAL FIRE ALARM &

61 ZERO-CLEARANCE GAS FIREPLACE PROVIDE GAS OUTLET AND TYPE "B" VENT TO ROOF OR DIRECT VENT TO OUTSIDE WALL AS PER MANUFACTURER'S SPECIFICATION.
- DIAMETER OF FLUE AND VENT AS PER OBC 9.21.2.5

CONTRACTOR TO INSTALL ARCHITECT'S SIGN AND MAINTAINED THROUGHOUT DURATION
OF CONSTRUCTION AT AGREED UPON LOCATION ON SITE

- VERTICAL STEP 23 5/8" MAX. FOR FIRM SOIL, 15 3/4" MAX. FOR SAND OR GRAVEL 23 5/8" MIN. HORIZONTAL RUN.

- 2 PLY TORCHED ON ROOFING MEMBRANE - 5/8" PLYWOOD SHEATHING WITH H-CLIPS ON 2 X 4 OR AS REQUIRED SLEEPERS TO MAINTAIN POSITIVE SLOPE TO GUTTER / DRAIN - ROOF JOISTS AS NOTED ON PLANS, CROSS BRIDGING @ 6'-0" MAX.

PROJECT

14 RIVER ROAD

BRAMPTON, ON L6X 0A6

CLIENT

Owner



REVISIONS

No.	Description	Date
)18	ISSUED FOR COFA	03/14/2024
)16	ISSUED FOR COFA	02/14/2024
)15	REISSUED FOR BUILDING PERMIT	02/14/2024
)13	ISSUED FOR BUILDING PERMIT	12/01/2023
)7	ISSUED FOR CLIENT	07/20/2023

Discrepancies must be reported immediately to the Architect before proceeding. Only figured dimensons are to be used. Contractors must check all dimensions on site. This drawing is protected by copyright.

ALL DIMENSIONS ARE SHOWN IN IMPERIAL & METRIC

CONSULTANTS





ORONTO - CANADA 416.546.2040 info@ghsarchitects.co DRAWING TITLE

CONSTRUCTION NOTES


DRAWN	CHECKED
PP	SA
SCALE @ ARCH D	DATE
	07/19/23
CDADUI	CSCALE

GRAPHIC SCALE

PROJECT NO. 200155

STAGE DRAWING NO.

REVISION HALTON HILLS

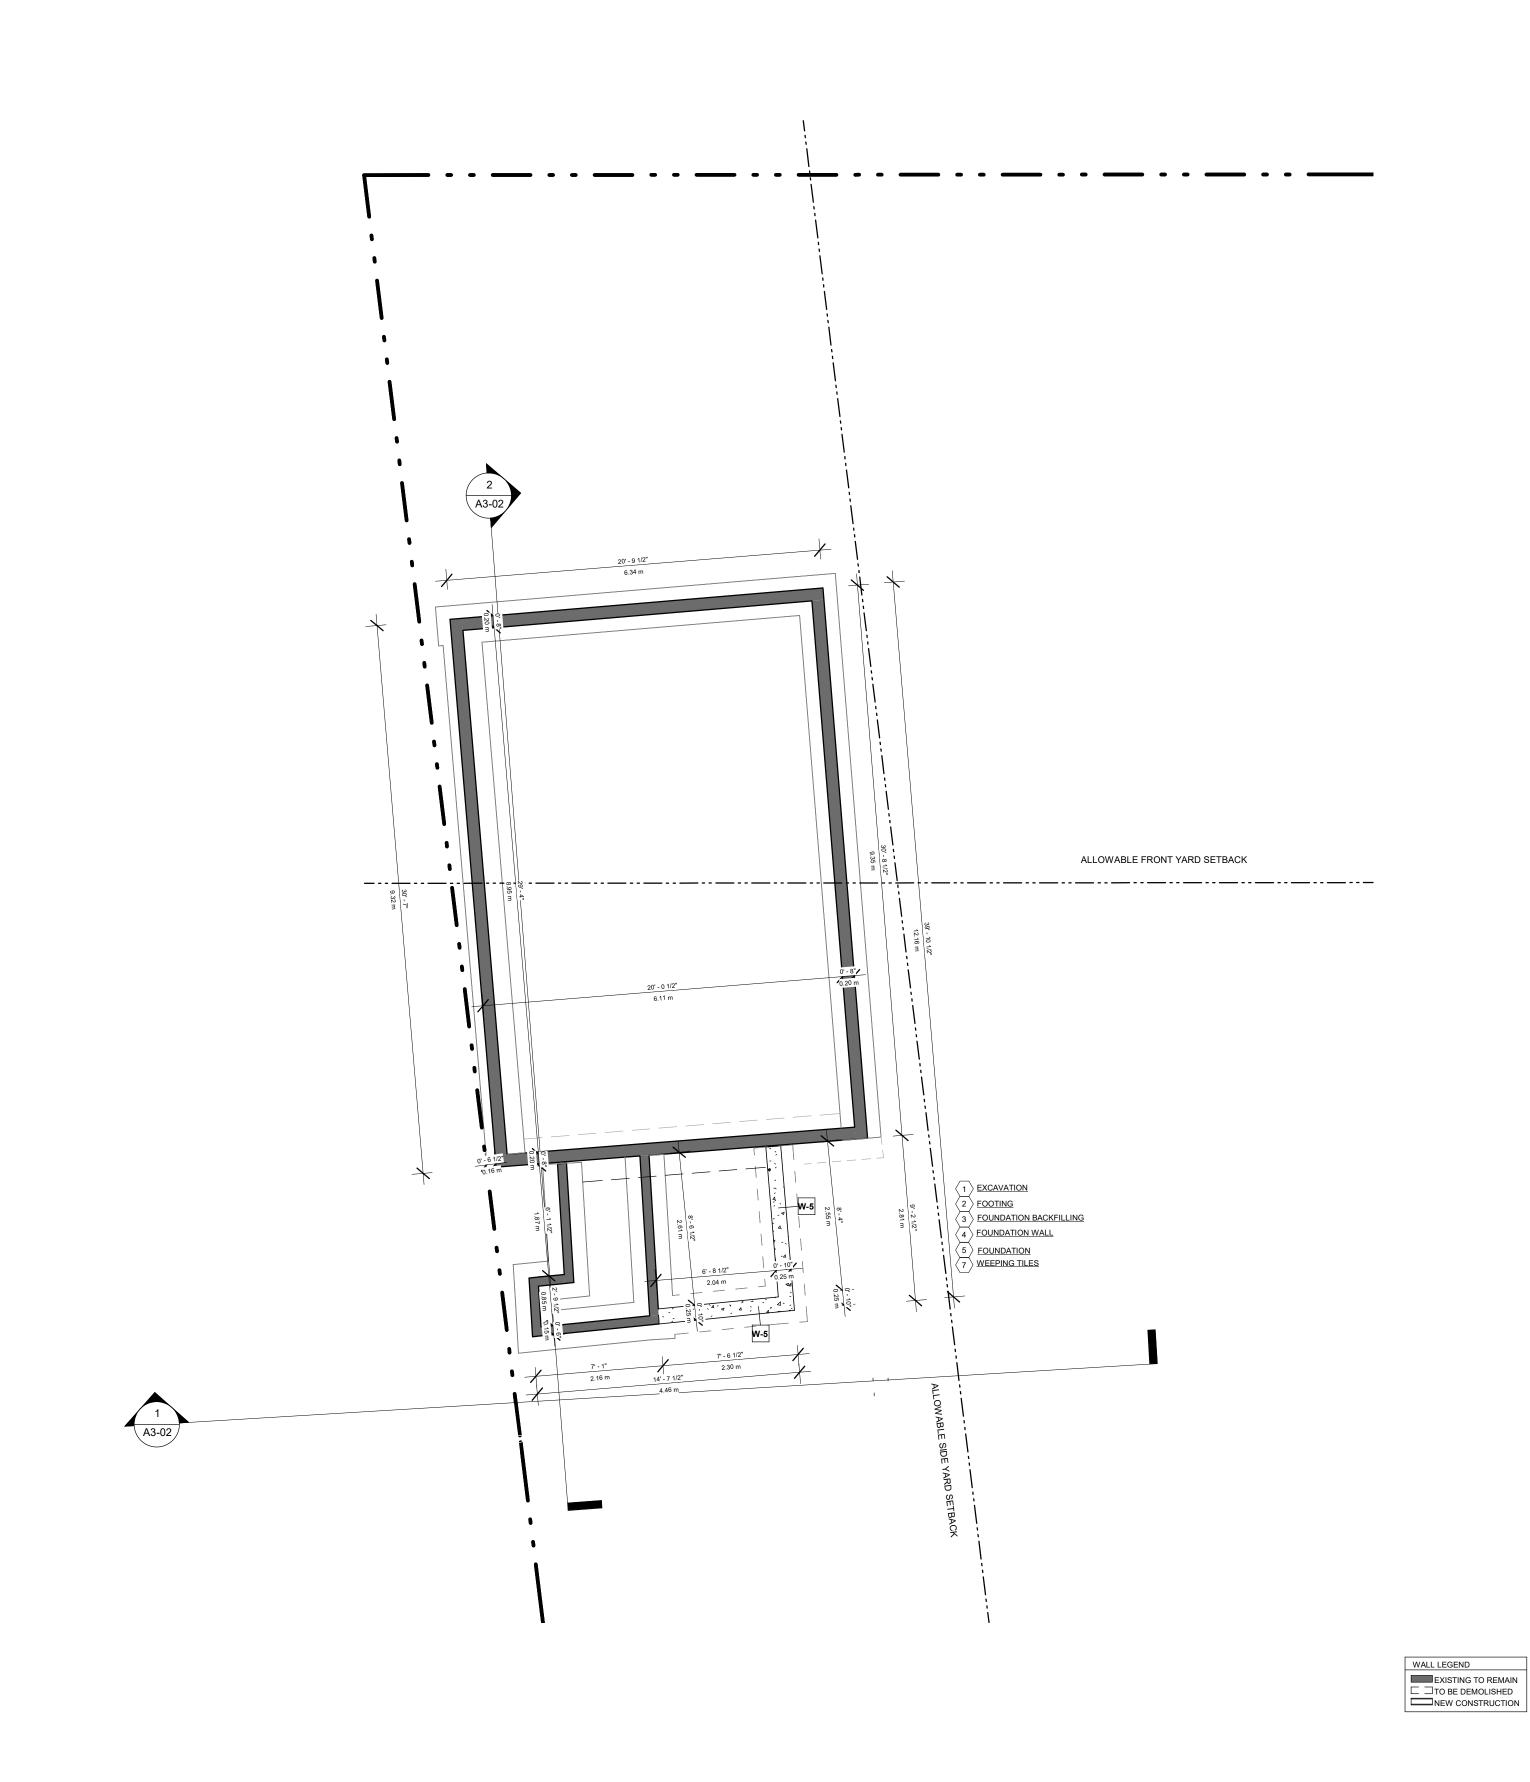

14 RIVER ROAD

BRAMPTON, ON L6X 0A6

Owner



REVISIONS

No.	Description	Date
18	ISSUED FOR COFA	03/14/2024
17	REISSUED FOR BUILDING PERMIT	03/07/2024
14	ISSUED FOR CONSULTANT	12/07/2023
13	ISSUED FOR BUILDING PERMIT	12/01/2023

Discrepancies must be reported immediately to the Architect before proceeding. Only figured dimensons are to be used. Contractors must check all dimensions on site. This drawing is protected by copyright.

ALL DIMENSIONS ARE SHOWN IN IMPERIAL & METRIC.

CONSULTANTS






TORONTO - CANADA 416.546.2040 info@qbsarchitects.co

DRAWING TITLE

PROP. SECONDARY UNIT **FOUNDATION PLAN**

DRAWN	CHECKED
PP	SA
SCALE @ ARCH D	DATE
3/16" = 1'-0"	11/28/23

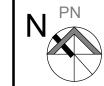

PROJECT NO.

COFA A1-05

200155

HALTON HILLS



14 RIVER ROAD

BRAMPTON, ON L6X 0A6

Owner



REVISIONS

No.	Description	Date
)18	ISSUED FOR COFA	03/14/2024
)17	REISSUED FOR BUILDING PERMIT	03/07/2024
)14	ISSUED FOR CONSULTANT	12/07/2023
)13	ISSUED FOR BUILDING PERMIT	12/01/2023
)12	ISSUED FOR LPG CONSULTANT	11/22/2023
)7	ISSUED FOR CLIENT	07/20/2023
)6	ISSUED FOR BUILDING PERMIT	06/22/2023

Discrepancies must be reported immediately to the Architect before proceeding. Only figured dimensons are to be used. Contractors must check all dimensions on site. This drawing is protected by copyright.

ALL DIMENSIONS ARE SHOWN IN IMPERIAL & METRIC.





TORONTO - CANADA 416.546.2040 info@qbsarchitects.co

PROP. SECONDARY UNIT

GROUND FLOOR PLAN

ı	DRAWN		CHECK	ΞD	
	PP			JB	
l	SCALE @ ARCH D		DATE		
	3/16" = 1'	'-0"		06/02/23	
1					




PROJECT NO.

200155

COFA A1-06

HALTON HILLS

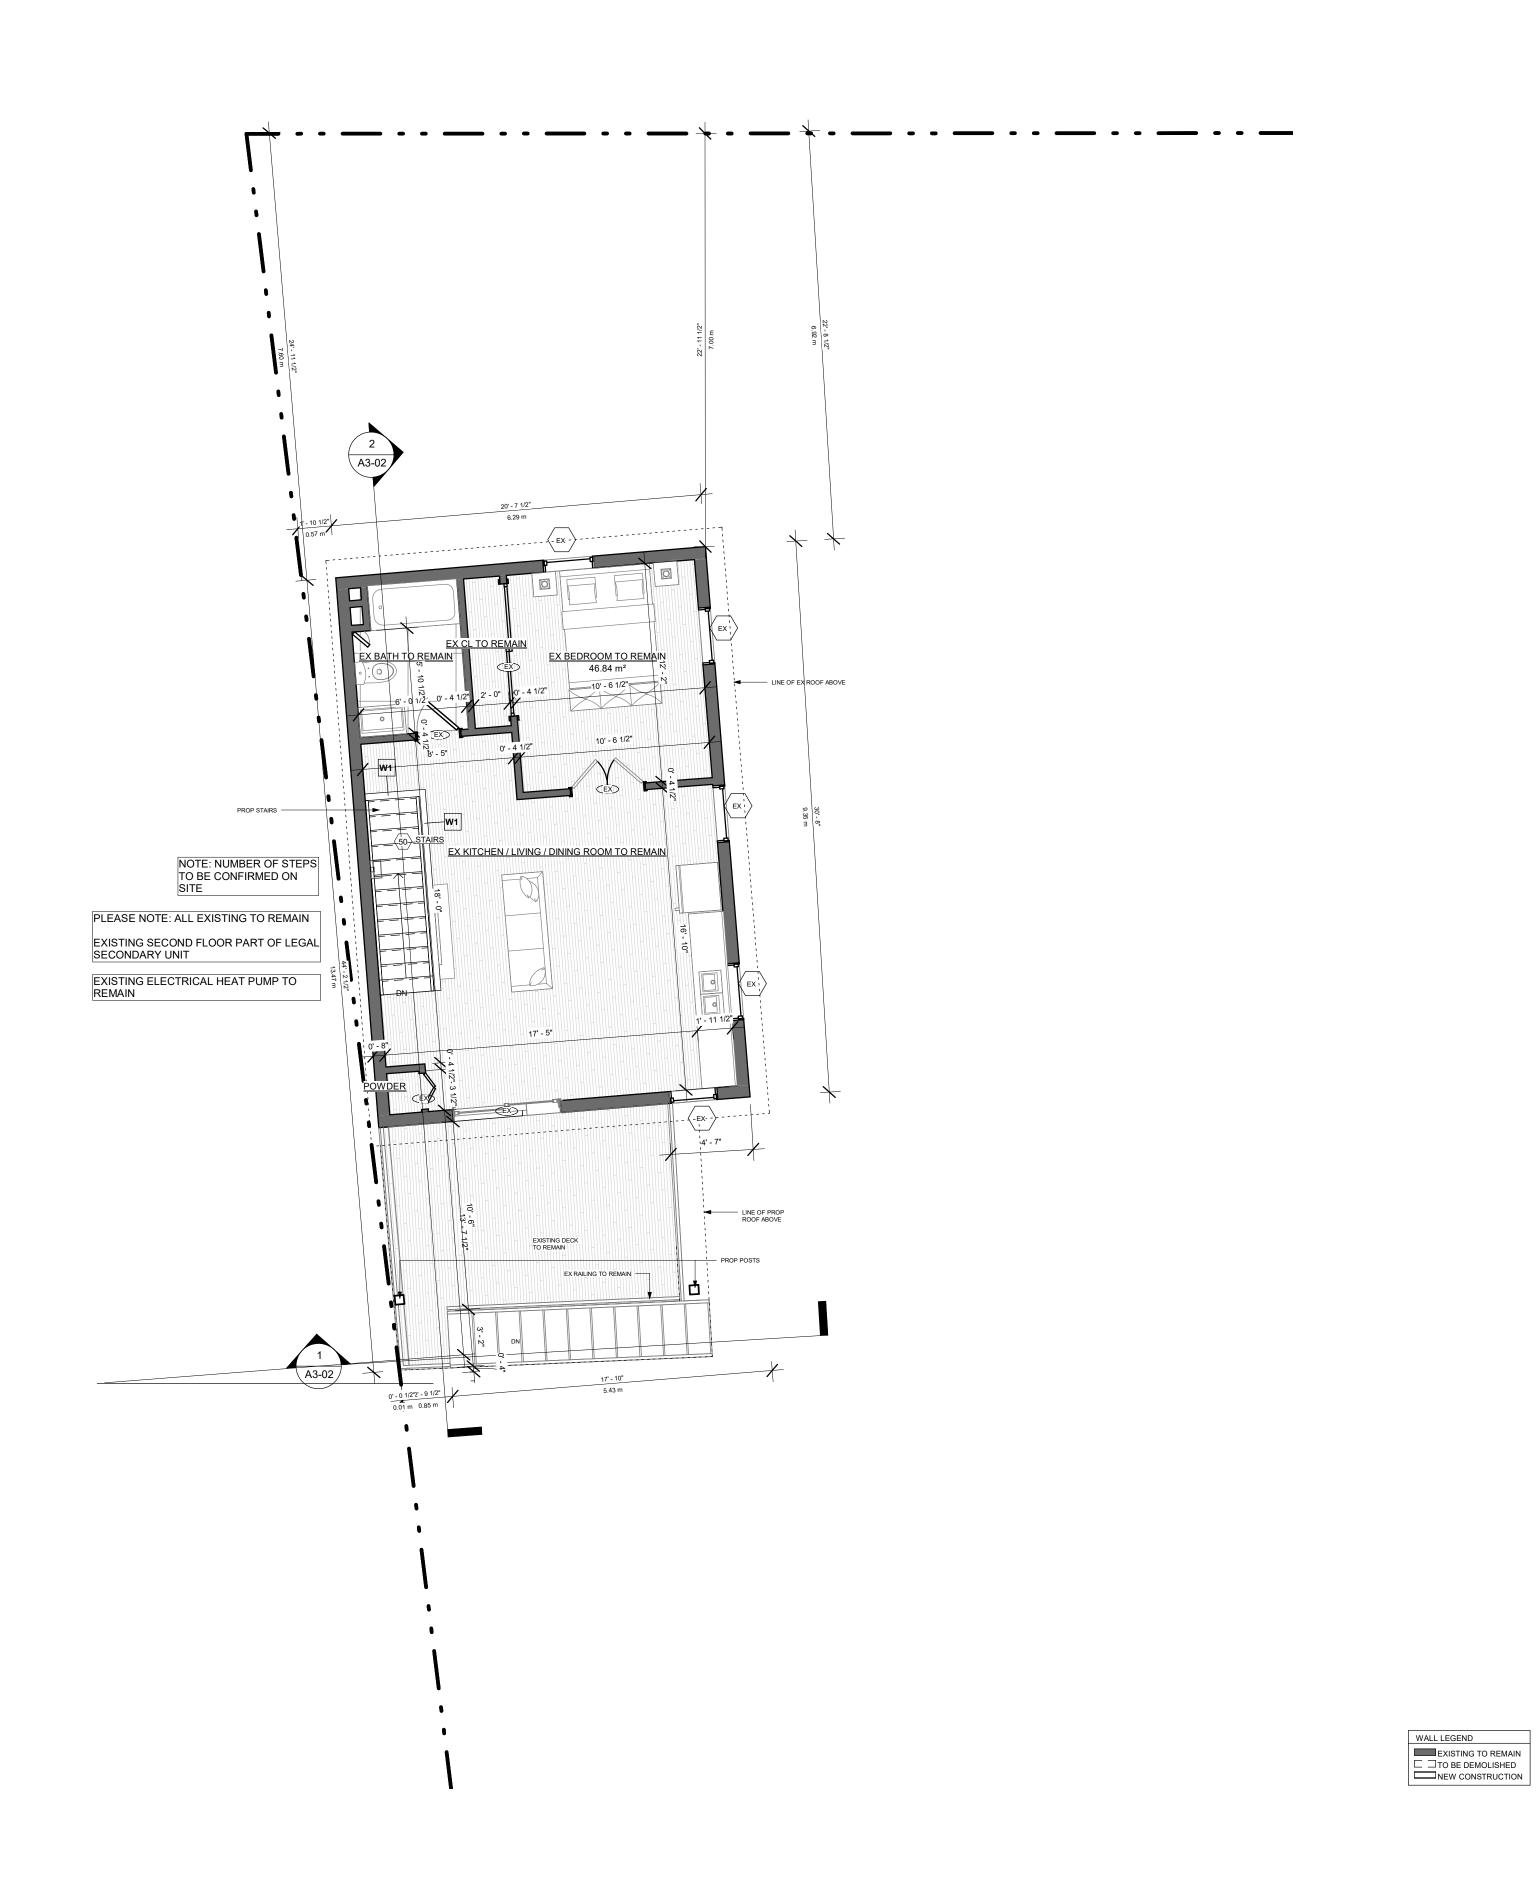

14 RIVER ROAD

BRAMPTON, ON L6X 0A6

CLIENT

Owner



REVISIONS

No.	Description	Date
)18	ISSUED FOR COFA	03/14/2024
)17	REISSUED FOR BUILDING PERMIT	03/07/2024
)14	ISSUED FOR CONSULTANT	12/07/2023
)13	ISSUED FOR BUILDING PERMIT	12/01/2023
)12	ISSUED FOR LPG CONSULTANT	11/22/2023
)7	ISSUED FOR CLIENT	07/20/2023
)6	ISSUED FOR BUILDING PERMIT	06/22/2023

Discrepancies must be reported immediately to the Architect before proceeding. Only figured dimensons are to be used. Contractors must check all dimensions on site. This drawing is protected by copyright.

ALL DIMENSIONS ARE SHOWN IN IMPERIAL & METRIC.

CONSULTANTS





TORONTO - CANADA 416.546.2040 info@qbsarchitects.cc

DRAWING TITLE

PROP. SECONDARY UNIT SECOND FLOOR

DRAWN		CHECKE	D
	PP		JB
SCALE @	ARCH D	DATE	
	3/16" = 1'-0"		06/02/23



GRAPHIC SCALE


PROJECT NO. 200155

STAGE DRAWING

COFA A1-07

LOCATION
HALTON HILLS

^N 018

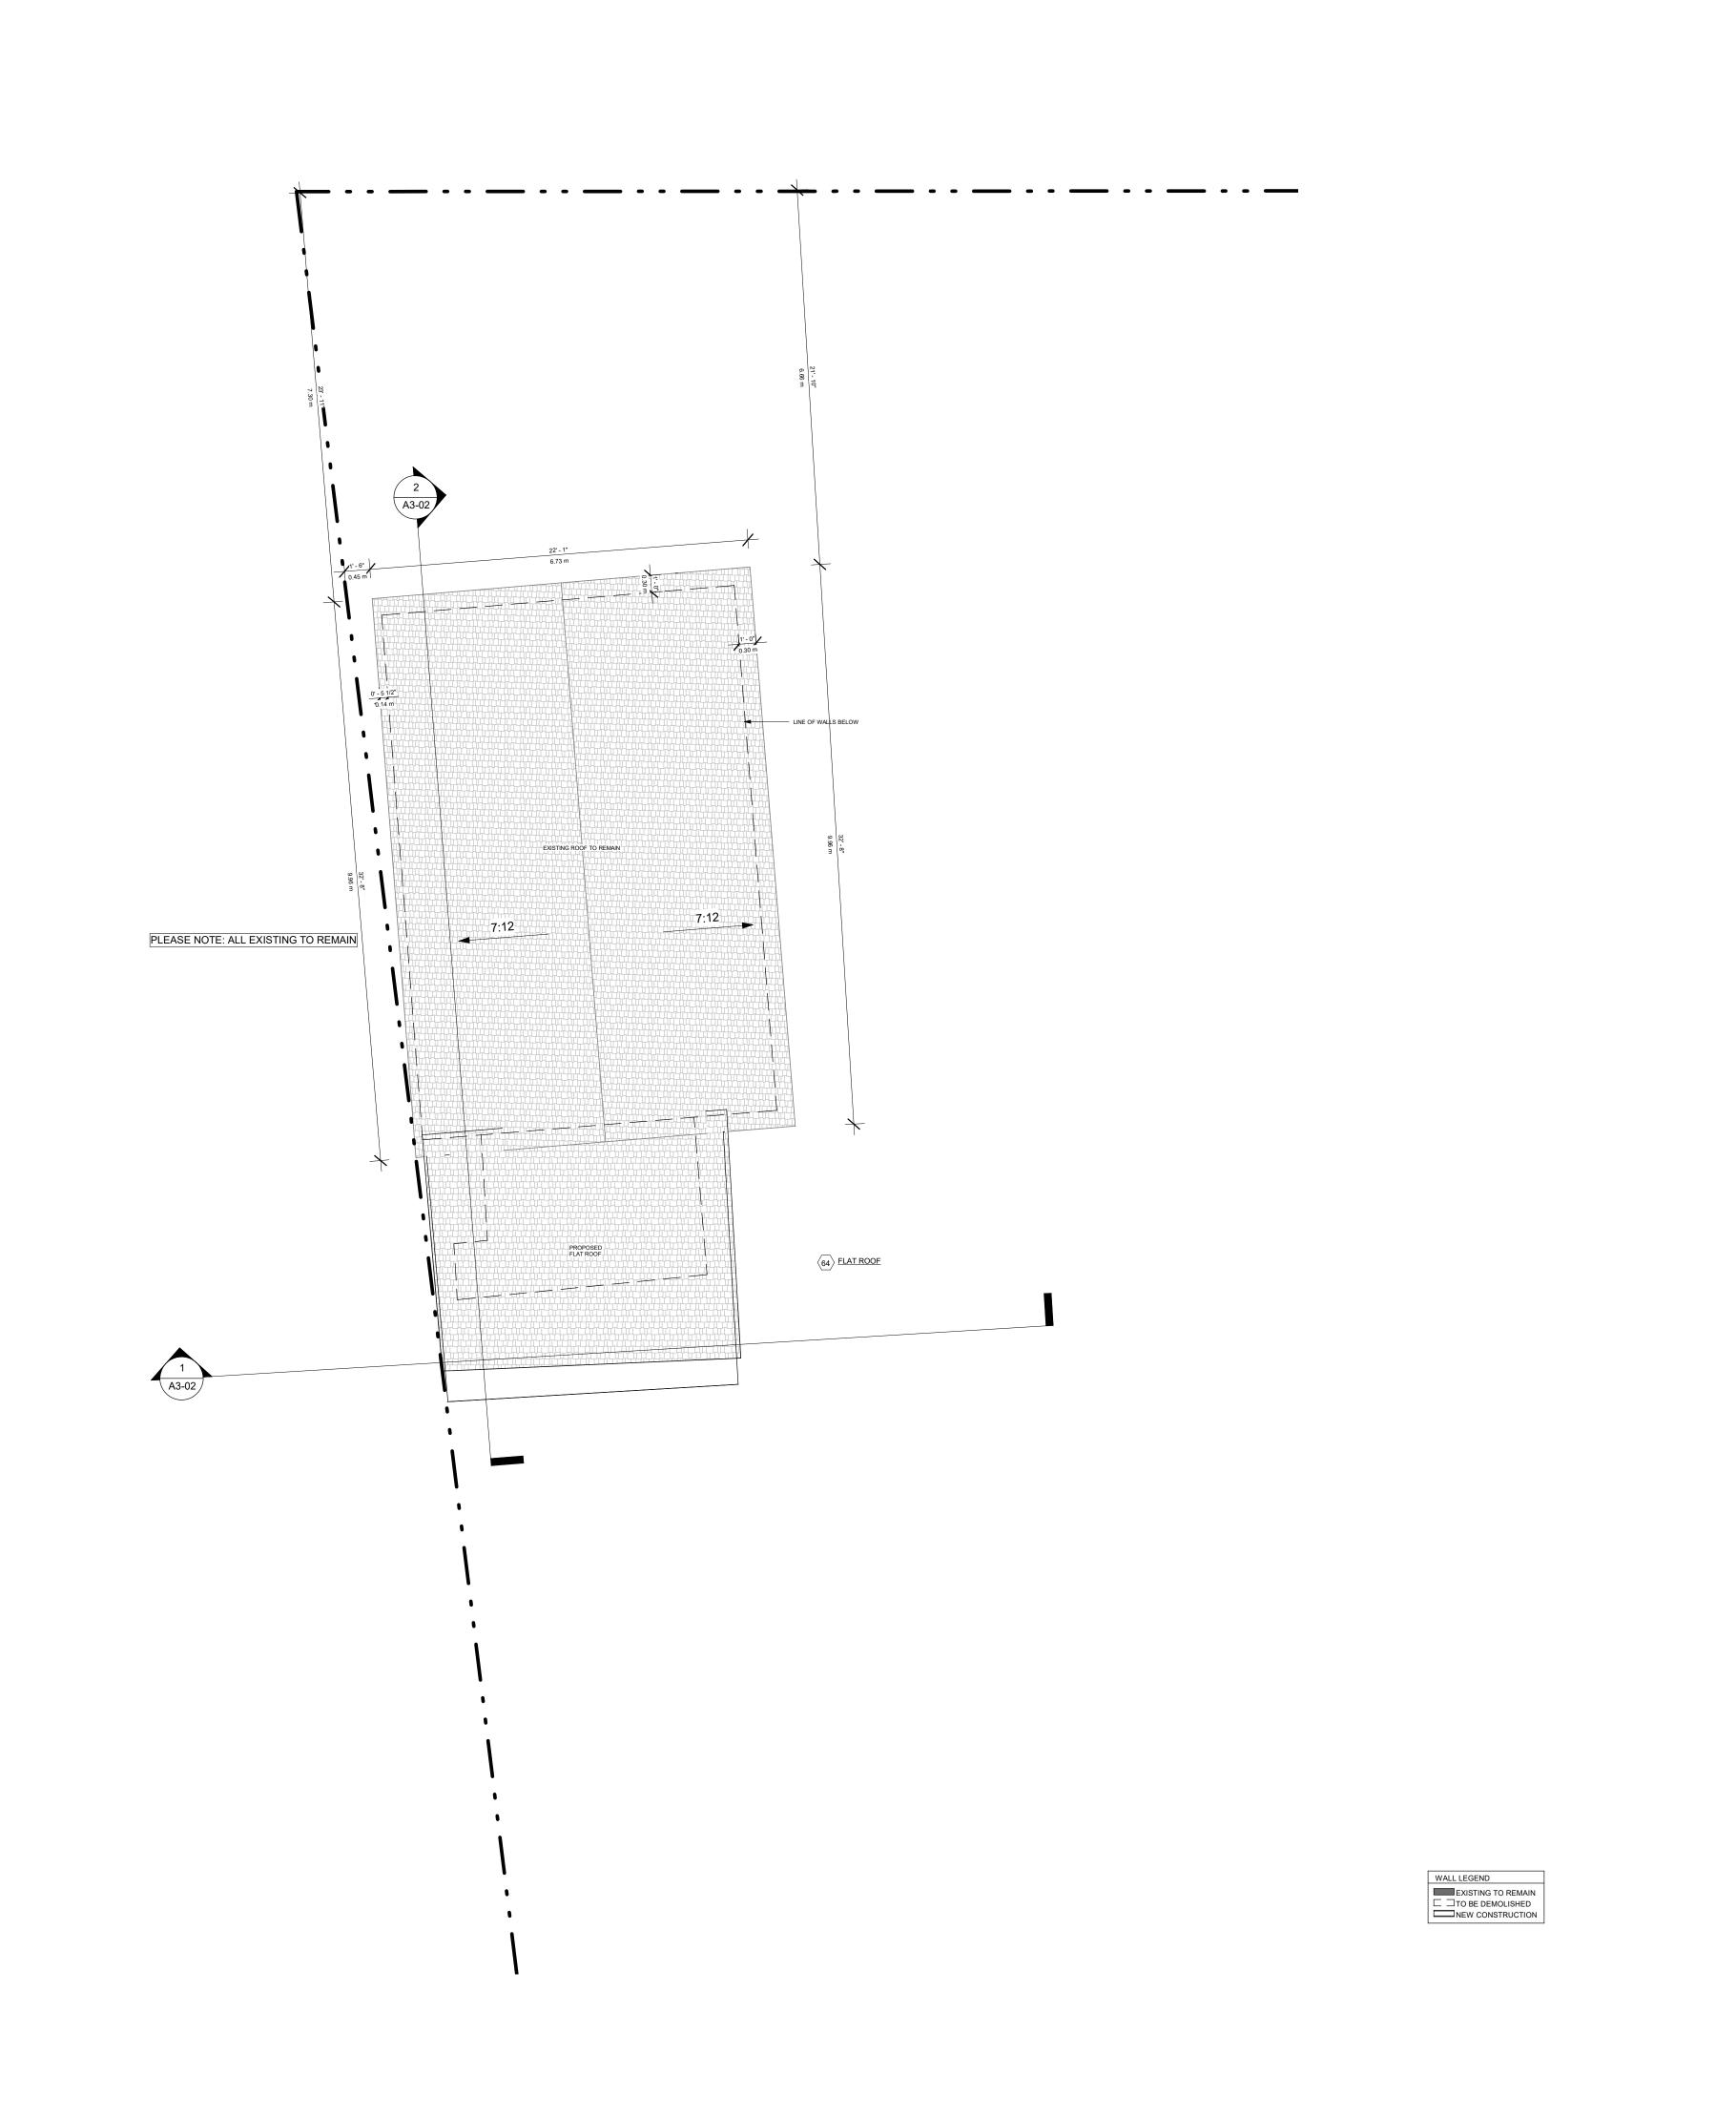

14 RIVER ROAD

BRAMPTON, ON L6X 0A6

Owner



REVISIONS

No.	Description	Date
018	ISSUED FOR COFA	03/14/2024
017	REISSUED FOR BUILDING PERMIT	03/07/2024
014	ISSUED FOR CONSULTANT	12/07/2023
013	ISSUED FOR BUILDING PERMIT	12/01/2023
012	ISSUED FOR LPG CONSULTANT	11/22/2023
07	ISSUED FOR CLIENT	07/20/2023
06	ISSUED FOR BUILDING PERMIT	06/22/2023

Discrepancies must be reported immediately to the Architect before proceeding. Only figured dimensons are to be used. Contractors must check all dimensions on site. This drawing is protected by copyright.

ALL DIMENSIONS ARE SHOWN IN IMPERIAL & METRIC.

CONSULTANTS

PROPOSED FLAT ROOF





TORONTO - CANADA 416.546.2040 info@qbsarchitects.co


PROP. SECONDARY UNIT ROOF PLAN

DRAW	N		CHECK	ED	
	PP			JB	
SCALE	@ ARCH D		DATE		
	3/16" = 1'-	0"		06/05/23	


PROJECT NO. 200155

COFA A1-08

HALTON HILLS

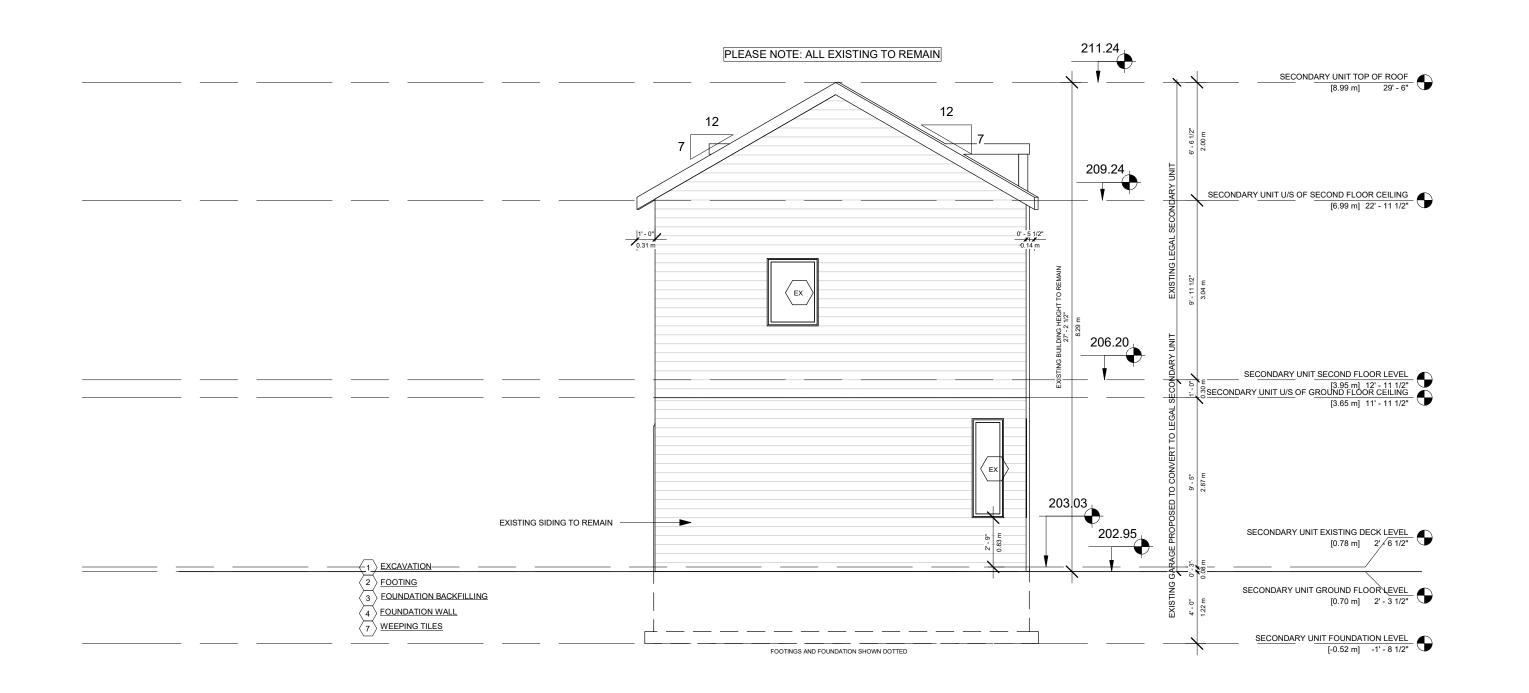

SECONDARY UNIT - FRONT ELEVATION 3/16" = 1'-0"

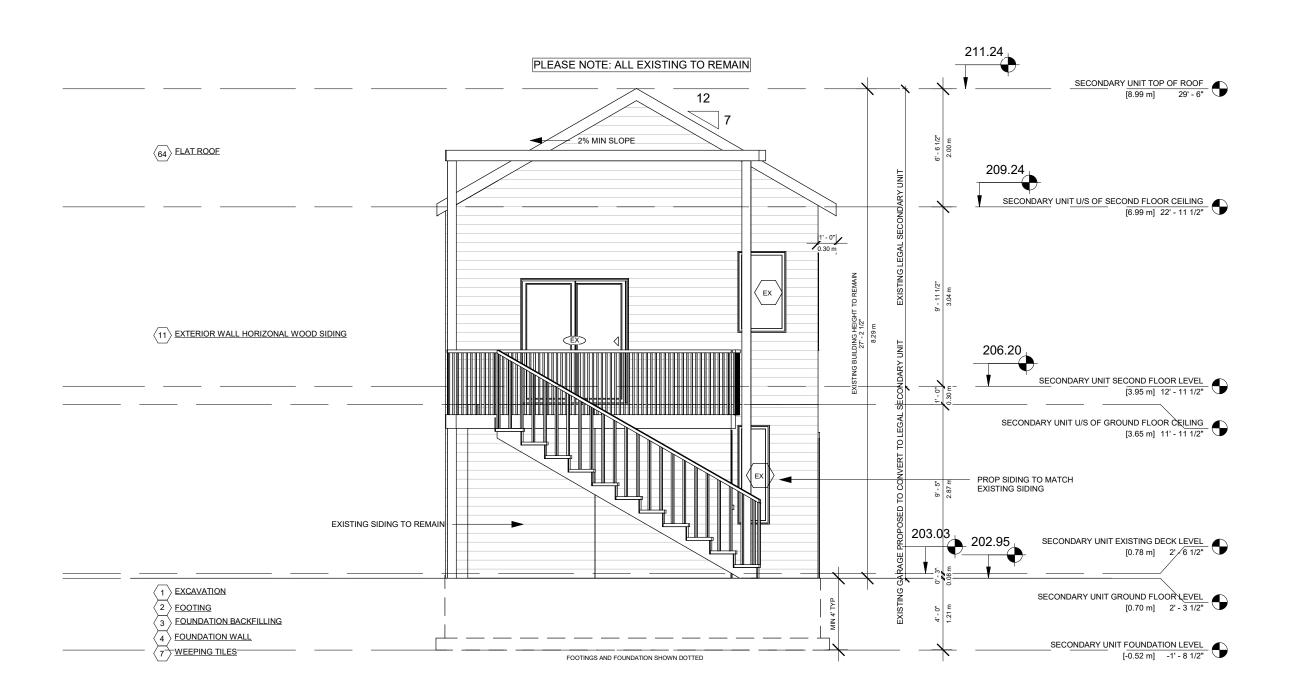

PROJECT

14 RIVER ROAD

BRAMPTON, ON L6X 0A6

CLIENT

Owner



REVISIONS

No.	Description	Date
018	ISSUED FOR COFA	03/14/2024
017	REISSUED FOR BUILDING PERMIT	03/07/2024
013	ISSUED FOR BUILDING PERMIT	12/01/2023
012	ISSUED FOR LPG CONSULTANT	11/22/2023
07	ISSUED FOR CLIENT	07/20/2023
06	ISSUED FOR BUILDING PERMIT	06/22/2023

Discrepancies must be reported immediately to the Architect before proceeding. Only figured dimensons are to be used. Contractors must check all dimensions on site. This drawing is protected by copyright.

ALL DIMENSIONS ARE SHOWN IN IMPERIAL & METRIC

CONSULTANTS





TORONTO - CANADA 416.546.2040 info@qbsarchitects.com

DRAWING TITLE

PROP SECONDARY UNIT FRONT AND REAR ELEVATION

DRAWN	CHECKED
PP	JB
SCALE @ ARCH D	DATE
3/16" = 1'-0"	06/21/23

GRAPHIC SCALE

PROJECT NO. 200155

STAGE DRAWING NO.

COFA A2-03


LOCATION
HALTON HILLS

018

SECONDARY UNIT - REAR ELEVATION

3/16" = 1'-0"



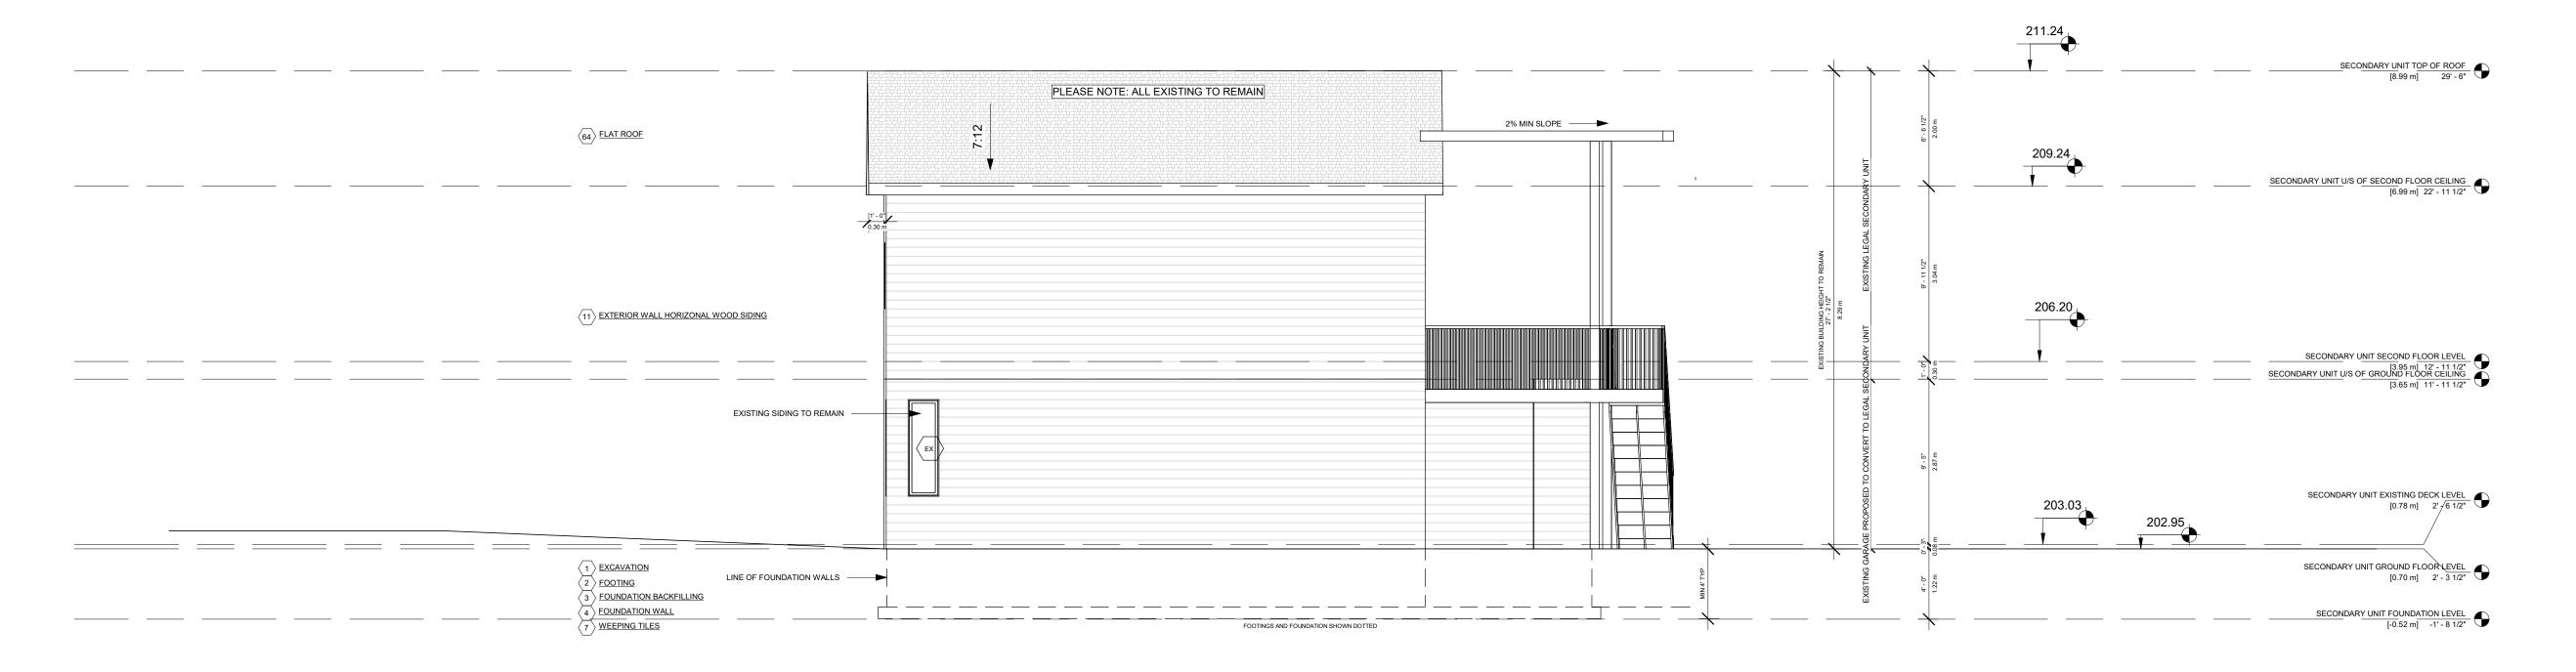

14 RIVER ROAD

BRAMPTON, ON L6X 0A6

CLIENT

Owner



REVISIONS

No.	Description	Date
018	ISSUED FOR COFA	03/14/2024
017	REISSUED FOR BUILDING PERMIT	03/07/2024
013	ISSUED FOR BUILDING PERMIT	12/01/2023
012	ISSUED FOR LPG CONSULTANT	11/22/2023
07	ISSUED FOR CLIENT	07/20/2023
06	ISSUED FOR BUILDING PERMIT	06/22/2023

Discrepancies must be reported immediately to the Architect before proceeding. Only figured dimensons are to be used. Contractors must check all dimensions on site. This drawing is protected by copyright.

ALL DIMENSIONS ARE SHOWN IN IMPERIAL & METRIC

CONSULTANTS





TORONTO - CANADA 416.546.2040 info@qbsarchitects.com

DRAWING TITLE

PROP. SECONDARY UNIT RIGHT AND LEFT ELEVATION

DRAWN		CHECKE	D
PP			JB
SCALE @ ARCH [3/16") = 1'-0"	DATE	06/21/23
	GRAPHIC	CSCALE	

31V 1110 337 122

PROJECT NO. **200155**

STAGE DRAWING NO.


COFA A2-04

LOCATION
HALTON HILLS

018

SECONDARY UNIT - LEFT SIDE ELEVATION

3/16" = 1'-0"

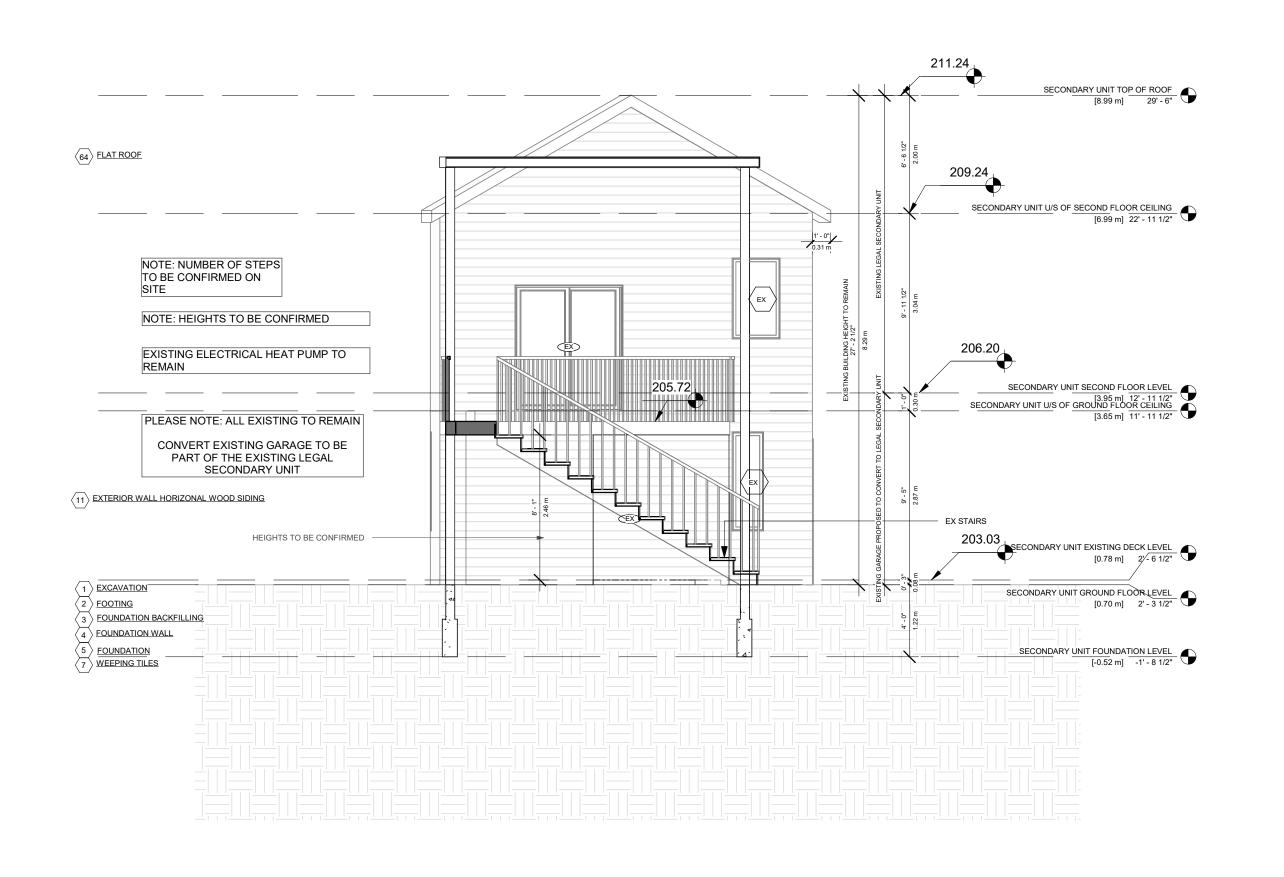



14 RIVER ROAD

BRAMPTON, ON L6X 0A6

CLIENT

Owner



REVISIONS

No.	Description	Date
)18	ISSUED FOR COFA	03/14/2024
)17	REISSUED FOR BUILDING PERMIT	03/07/2024
)13	ISSUED FOR BUILDING PERMIT	12/01/2023
)12	ISSUED FOR LPG CONSULTANT	11/22/2023
)7	ISSUED FOR CLIENT	07/20/2023

Discrepancies must be reported immediately to the Architect before proceeding. Only figured dimensons are to be used. Contractors must check all dimensions on site. This drawing is protected by copyright.

ALL DIMENSIONS ARE SHOWN IN IMPERIAL & METRIC.

CONSULTANTS





TORONTO - CANADA 416.546.2040 info@qbsarchitects.co
DRAWING TITLE

PROP. SECONDARY UNIT SECTION

DRAWN
PP
JB

SCALE @ ARCH D
3/16" = 1'-0"
DATE
07/19/23

GRAPHIC SCALE

PROJECT NO. **200155**

STAGE DRAWING NO.


COFA A3-02

LOCATION R
HALTON HILLS

^N 018

	DOOR SCHEDULE					
Mark	Level	Width	Height	From Room	To Room	Operation
D-001	BASEMENT	5' - 0"	7' - 0"		PROP. REC ROOM	DOUBLE DOOR
D-002	BASEMENT	2' - 6"	6' - 8"	PROP. BATH	EXISTING GYM	SINGLE SWING
D-003	BASEMENT	4' - 8"	7' - 0"	Tree : Brill	EXISTING GYM	SLIDING DOOR
D-004	BASEMENT	2' - 8"	6' - 8"	COLD ROOM	PROP. REC ROOM	SINGLE SWING
D-005	BASEMENT	2' - 8"	6' - 8"	PROP. REC ROOM	GUEST BEDROOM	SINGLE SWING
D-006	BASEMENT	3' - 4"	7' - 0"	PROP CL	GUEST BEDROOM	DOUBLE DOOR
D-007	BASEMENT	3' - 4"	7' - 0"	PROP CL	GUEST BEDROOM	DOUBLE DOOR
D-008	BASEMENT	3' - 0"	6' - 8"	PROP. REC ROOM	EXISTING GYM	OPENING
D-101	GROUND FLOOR - EXISTING	6' - 0"	8' - 0"	PROP FOYER	2,1311110 01111	DOUBLE DOOR
D-102	GROUND FLOOR - EXISTING	2' - 8"	6' - 8"	PROP FOYER	PROP MUDROOM	SINGLE SWING
D-103	GROUND FLOOR - EXISTING	2' - 6"	6' - 8"	PROP FOYER	PROP BEDROOM	SINGLE SWING
D-104	GROUND FLOOR - EXISTING	2' - 8"	6' - 8"	PROP 2 CAR GARAGE	PROP MUDROOM	SINGLE SWING
D-105	GROUND FLOOR - EXISTING	2' - 6"	6' - 8"	PROP BEDROOM	EX BATH TO REMAIN	SINGLE SWING
D-106	GROUND FLOOR - EXISTING	1' - 9"	6' - 8"	PROP CL	PROP BEDROOM	DOUBLE DOOR
)-107	GROUND FLOOR - EXISTING	5' - 0"	7' - 6"		PROP BEDROOM	SLIDING DOOR
D-108	GROUND FLOOR - EXISTING	2' - 8"	8' - 0"		PROP 2 CAR GARAGE	SINGLE SWING
D-109	GROUND FLOOR - EXISTING	2' - 6"	6' - 8"	PROP FOYER	PROP POWDER	SINGLE SWING
D-110	GROUND FLOOR - EXISTING	2' - 6"	6' - 8"	PROP CL	PROP FOYER	DOUBLE DOOR
D-111	GROUND FLOOR - EXISTING	2' - 6"	6' - 8"	PROP CL	PROP FOYER	DOUBLE DOOR
D-112	GROUND FLOOR - EXISTING	3' - 0"	6' - 8"	PROP FOYER	PROP KITCHEN	OPENING
D-113	GROUND FLOOR - EXISTING	2' - 8"	6' - 8"	PROP LIVING AND DINING	PROP KITCHEN	SINGLE SWING
D-114	GROUND FLOOR - EXISTING	3' - 6"	8' - 0"	THE ENTITE BITTING	PROP KITCHEN	SINGLE SWING
D-115	PROPOSED GARAGE	8' - 0"	8' - 0"		PROP 2 CAR GARAGE	ROLL UP
D-116	PROPOSED GARAGE	8' - 0"	8' - 0"		PROP 2 CAR GARAGE	ROLL UP
0-201	SECONDARY UNIT GROUND FLOOR LEVEL	2' - 8"	8' - 0"		PROP LAUNDRY	
D-202	SECOND FLOOR - EXISTING	2' - 10"	6' - 8"	PROP CL	EX BEDROOM TO BE ENLARGED	DOUBLE DOOR
D-203	SECOND FLOOR - EXISTING	2' - 6"	6' - 8"	PROP CORRIDOR	EX BEDROOM TO BE ENLARGED	SINGLE SWING
0-204	SECOND FLOOR - EXISTING	2' - 8"	6' - 8"	PROP CORRIDOR	PROPOSED BEDROOM #3	SINGLE SWING
)-205	SECOND FLOOR - EXISTING	2' - 6"	6' - 8"	PROPOSED BEDROOM #3	W.I.C #3	SINGLE SWING
D-206	SECOND FLOOR - EXISTING	2' - 6"	6' - 8"		PROPOSED BEDROOM #3	SINGLE SWING
0-207	SECOND FLOOR - EXISTING	2' - 8"	6' - 8"	PROP CORRIDOR	LAUNDRY	SINGLE SWING
D-208	SECOND FLOOR - EXISTING	2' - 8"	6' - 8"	PROP CORRIDOR	PROPOSED BEDROOM #2	SINGLE SWING
D-209	SECOND FLOOR - EXISTING	2' - 6"	6' - 8"	PROPOSED BEDROOM #2	W.I.C #2	POCKET
D-210	SECOND FLOOR - EXISTING	2' - 6"	6' - 8"	BATH #2	PROPOSED BEDROOM #2	POCKET
D-211	SECOND FLOOR - EXISTING	2' - 8"	7' - 6"			SINGLE SWING
D-212	SECOND FLOOR - EXISTING	5' - 0"	7' - 6"		PROPOSED BEDROOM #3	SLIDING DOOR

Mark	Level	Sill Height	Height	Width	From Room: Name
		<u> </u>	<u> </u>		
W-001	BASEMENT	2' - 0"	5' - 0"	4' - 0"	PROP. REC ROOM
W-002	BASEMENT	5' - 6"	2' - 0"	4' - 0"	GUEST BEDROOM
W-101	GROUND FLOOR - EXISTING	2' - 0"	5' - 0"	4' - 0"	PROP LIVING AND DINING
W-102	GROUND FLOOR - EXISTING	2' - 0"	5' - 0"	2' - 0"	PROP LIVING AND DINING
W-103	GROUND FLOOR - EXISTING	2' - 0"	5' - 0"	2' - 0"	PROP LIVING AND DINING
W-104	GROUND FLOOR - EXISTING	2' - 0"	5' - 0"	2' - 0"	PROP LIVING AND DINING
W-105	GROUND FLOOR - EXISTING	2' - 0"	5' - 0"	2' - 0"	PROP LIVING AND DINING
W-106	GROUND FLOOR - EXISTING	2' - 0"	5' - 0"	2' - 0"	PROP LIVING AND DINING
W-107	GROUND FLOOR - EXISTING	2' - 0"	5' - 0"	2' - 0"	PROP LIVING AND DINING
W-108	GROUND FLOOR - EXISTING	2' - 0"	5' - 0"	6' - 0"	PROP LIVING AND DINING
W-109	GROUND FLOOR - EXISTING	7' - 5 1/2"	5' - 0"	3' - 0"	PROP FOYER
W-110	GROUND FLOOR - EXISTING	2' - 0"	5' - 0"	2' - 0"	PROP 2 CAR GARAGE
W-111	GROUND FLOOR - EXISTING	2' - 6"	5' - 0"	2' - 0"	PROP BEDROOM
W-112	GROUND FLOOR - EXISTING	0' - 0"	8' - 0"	2' - 0"	PROP KITCHEN
W-113	GROUND FLOOR - EXISTING	2' - 0"	5' - 0"	6' - 0"	PROP 2 CAR GARAGE
W-114	GROUND FLOOR - EXISTING	7' - 0"	1' - 6"	10' - 0"	PROP LIVING AND DINING
W-115	GROUND FLOOR - EXISTING	2' - 4 1/2"	5' - 0"	3' - 0"	PROP FOYER
W-116	GROUND FLOOR - EXISTING	7' - 0"	1' - 6"	10' - 0"	PROP 2 CAR GARAGE
W-117	GROUND FLOOR - EXISTING	7' - 0"	1' - 6"	2' - 0"	PROP LIVING AND DINING
W-118	GROUND FLOOR - EXISTING	7' - 0"	1' - 6"	2' - 0"	PROP LIVING AND DINING
W-119	GROUND FLOOR - EXISTING	7' - 0"	1' - 6"	2' - 0"	PROP LIVING AND DINING
W-120	GROUND FLOOR - EXISTING	7' - 0"	1' - 6"	2' - 0"	PROP LIVING AND DINING
W-121	GROUND FLOOR - EXISTING	7' - 0"	1' - 6"	2' - 0"	PROP LIVING AND DINING
	GROUND FLOOR - EXISTING	7' - 0"	1' - 6"	2' - 0"	PROP LIVING AND DINING
W-123	GROUND FLOOR - EXISTING	7' - 0"	1' - 6"	4' - 0"	EX BEDROOM TO BE ENLARGE
W-124	GROUND FLOOR - EXISTING	7' - 0"	1' - 6"	2' - 0"	PROP 2 CAR GARAGE
W-125	GROUND FLOOR - EXISTING	0' - 8"	5' - 0"	3' - 11"	EX DINING
	GROUND FLOOR - EXISTING	0' - 8"	5' - 0"	3' - 11"	EX DINING
	SECOND FLOOR - EXISTING	2' - 6"	5' - 0"	4' - 0"	EX BEDROOM TO BE ENLARGE
	SECOND FLOOR - EXISTING	2' - 6"	5' - 0"	2' - 0"	EX BEDROOM TO BE ENLARGE
	SECOND FLOOR - EXISTING	2' - 6"	5' - 0"	2' - 0"	EX BEDROOM TO BE ENLARGE
	SECOND FLOOR - EXISTING	2' - 6"	5' - 0"	2' - 0"	EX BEDROOM TO BE ENLARGE
	SECOND FLOOR - EXISTING	2' - 6"	5' - 0"	2' - 0"	EX BEDROOM TO BE ENLARGE
	SECOND FLOOR - EXISTING	2' - 6"	5' - 0"	2' - 0"	EX BEDROOM TO BE ENLARGE
	SECOND FLOOR - EXISTING	2' - 6"	5' - 0"	2' - 0"	EX BEDROOM TO BE ENLARGE
	SECOND FLOOR - EXISTING	2' - 6"	5' - 0"	6' - 0"	EX BEDROOM TO BE ENLARGE
	SECOND FLOOR - EXISTING	2' - 6"	5' - 0"	3' - 0"	PROP HALL
		2' - 6"	5' - 0"	2' - 0"	
	SECOND FLOOR - EXISTING	2' - 6"	5' - 0"	2' - 0"	OPEN TO BELOW -PROP FOYE
	SECOND FLOOR - EXISTING				PROPOSED BEDROOM #2
	SECOND FLOOR - EXISTING	2' - 6"	5' - 0"	6' - 0"	PROPOSED BEDROOM #2
	SECOND FLOOR - EXISTING	2' - 6"	5' - 0"	2' - 0"	W.I.C #2
	SECOND FLOOR - EXISTING	2' - 6"	5' - 0"	2' - 0"	BATH #2
	SECOND FLOOR - EXISTING	2' - 6"	5' - 0"	2' - 0"	BATH #2
	SECOND FLOOR - EXISTING	2' - 6"	5' - 0"	6' - 0"	PROPOSED BEDROOM #2
	SECOND FLOOR - EXISTING	2' - 6"	5' - 0"	2' - 0"	PROPOSED BEDROOM #2
	SECOND FLOOR - EXISTING	2' - 6"	5' - 0"	2' - 0"	PROPOSED BEDROOM #2
	SECOND FLOOR - EXISTING	2' - 6"	5' - 0"	2' - 0"	
	SECOND FLOOR - EXISTING	2' - 6"	5' - 0"	2' - 0"	
	SECOND FLOOR - EXISTING	2' - 6"	5' - 0"	2' - 0"	PROPOSED BEDROOM #3
	SECOND FLOOR - EXISTING	2' - 6"	5' - 0"	2' - 0"	PROPOSED BEDROOM #3
N-301	SECONDARY UNIT GROUND FLOOR LEVEL	4' - 0"	4' - 0"	3' - 0"	PROP LAUNDRY

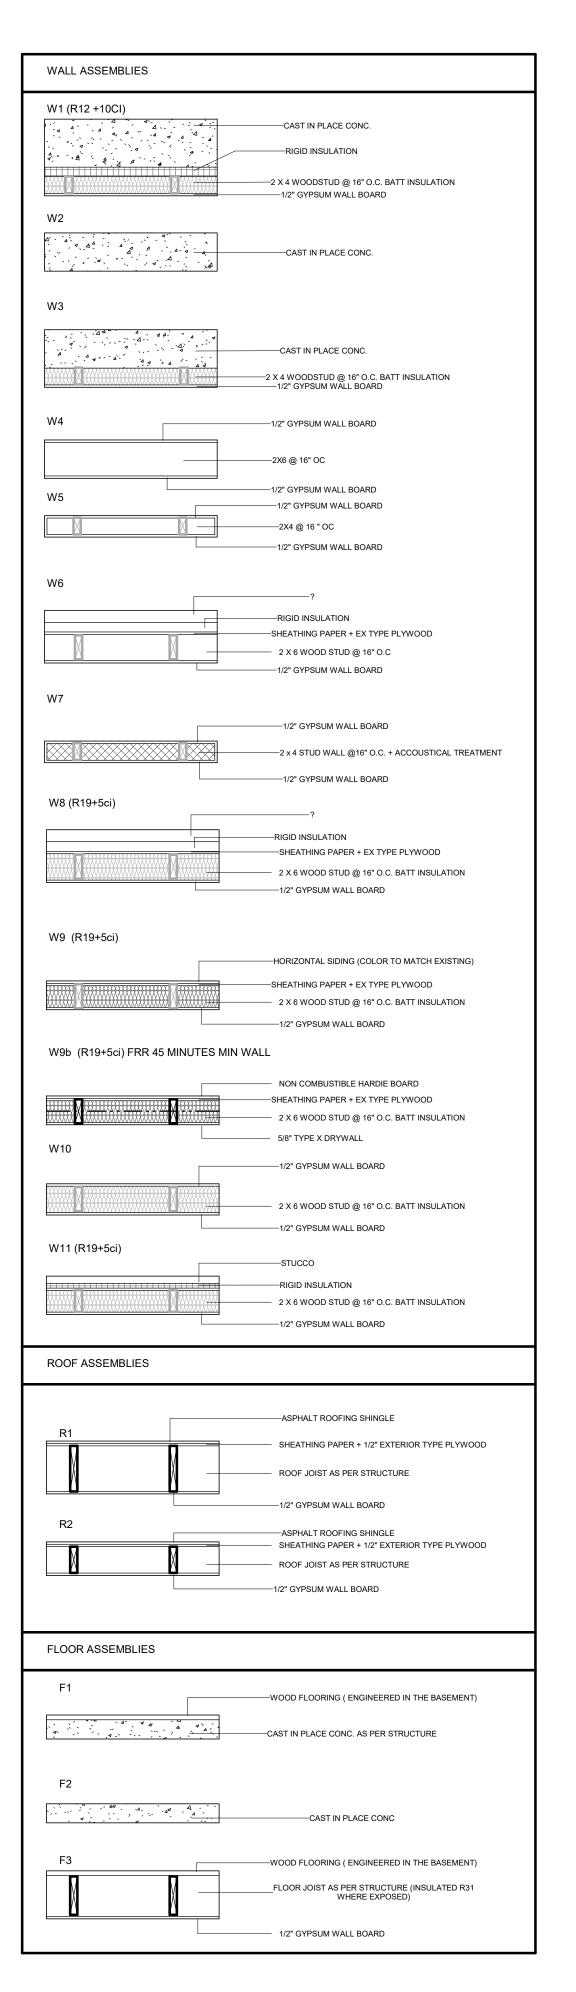

ASSEMBLIES

1:20

PROJECT

14 RIVER ROAD

BRAMPTON, ON L6X 0A6

CLIENT

Owner



REVISIONS

No.	Description	Date
018	ISSUED FOR COFA	03/14/2024
017	REISSUED FOR BUILDING PERMIT	03/07/2024
016	ISSUED FOR COFA	02/14/2024
015	REISSUED FOR BUILDING PERMIT	02/14/2024
013	ISSUED FOR BUILDING PERMIT	12/01/2023

Discrepancies must be reported immediately to the Architect before proceeding. Only figured dimensons are to be used. Contractors must check all dimensions on site. This drawing is protected by copyright.

ALL DIMENSIONS ARE SHOWN IN IMPERIAL & METRIC.

CONSULTANTS





TORONTO - CANADA 416.546.2040 info@qbsarchitects.com

DRAWING TITLE

DOOR WINDOW SCHEDULE & WALL ASSEMBLIES

DRAWN	CHECKED
PP	SA
SCALE @ ARCH D	DATE
1 : 20	11/23/23
GRAPHI	C SCALE

31V W 1113 337 WEE

PROJECT NO.


200155

STAGE DRAWING NO.

COFA A4-01

HALTON HILLS



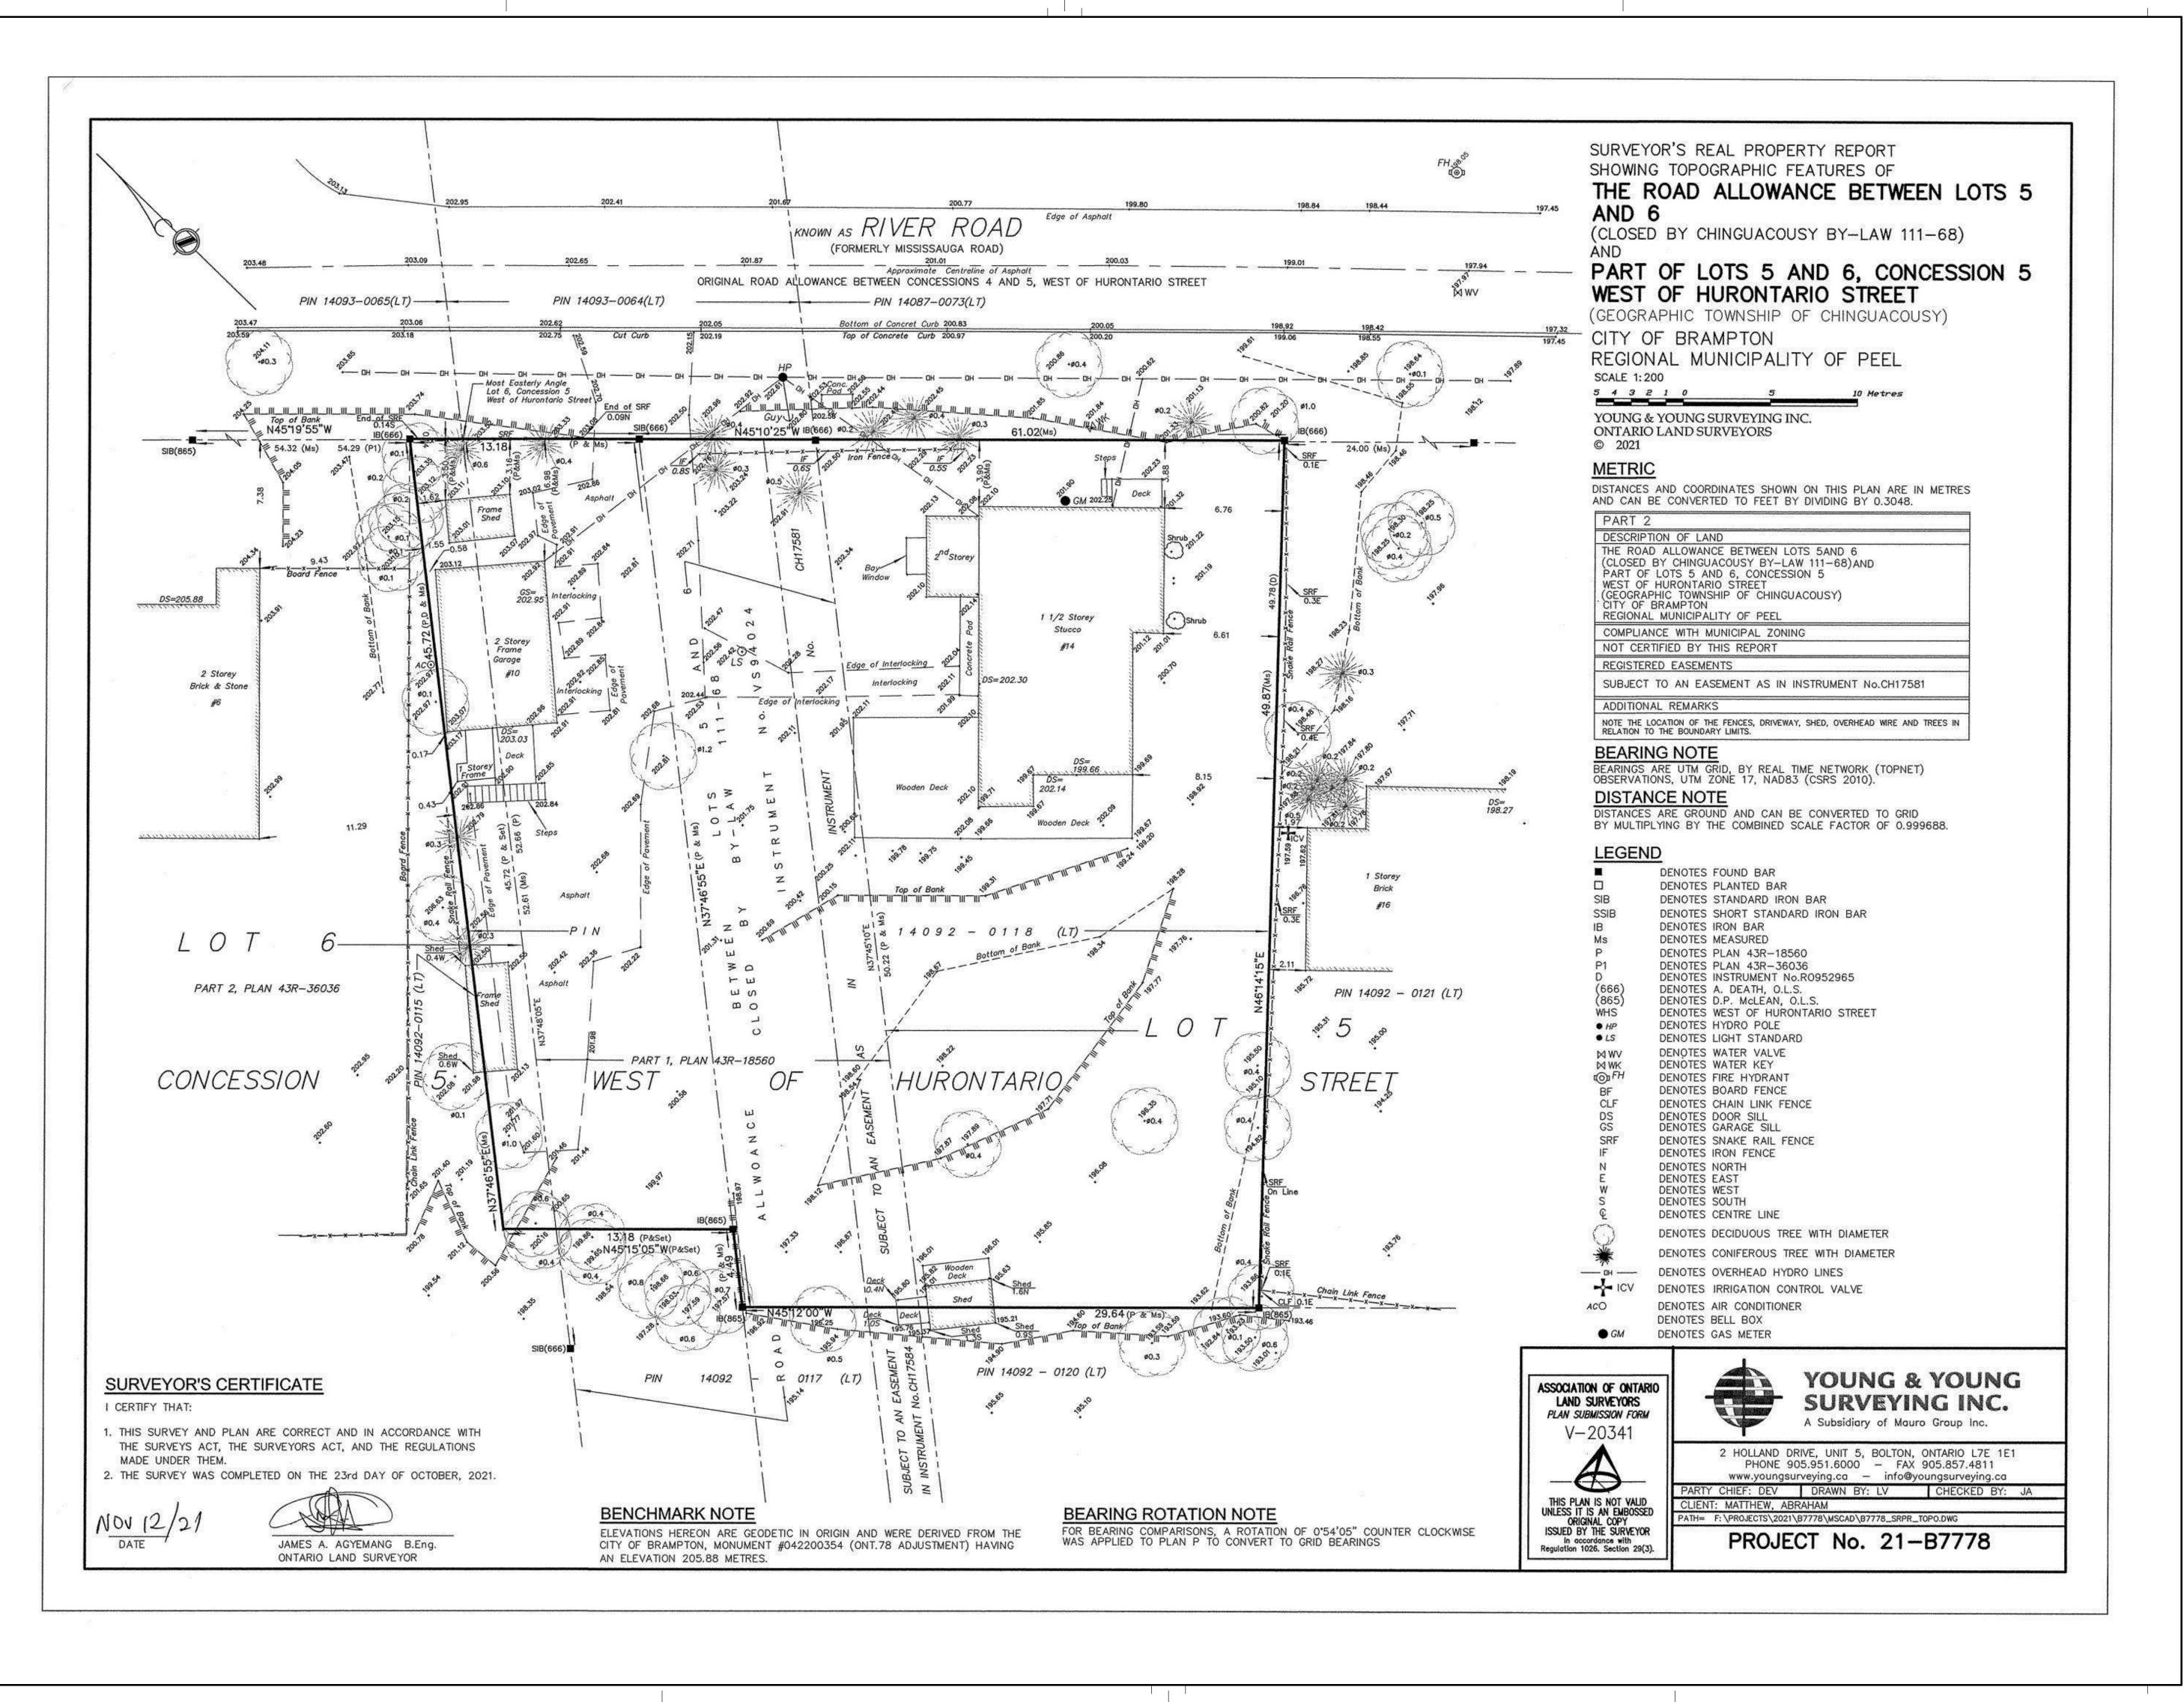

14 RIVER ROAD

BRAMPTON, ON L6X 0A6

CLIENT

Owner



REVISIONS

No.	Description	Date
INO.	Description	Date
018	ISSUED FOR COFA	03/14/2024
016	ISSUED FOR COFA	02/14/2024
015	REISSUED FOR BUILDING PERMIT	02/14/2024
013	ISSUED FOR BUILDING PERMIT	12/01/2023
06	ISSUED FOR BUILDING PERMIT	06/22/2023
04	ISSUED FOR ZONING REVIEW	02/17/2023

Discrepancies must be reported immediately to the Architect before proceeding. Only figured dimensons are to be used. Contractors must check all dimensions on site. This drawing is protected by copyright.

ALL DIMENSIONS ARE SHOWN IN IMPERIAL & METRIC

CONSULTANTS



TORONTO - CANADA 416.546.2040 info@qbsarchitects.cc

SURVEY

DRAWN
PP
SA

SCALE @ ARCH D
DATE
10/20/22

GRAPHIC SCALE


200155


PROJECT NO.

STAGE DRAWING NO.


COFA A0-05

LOCATION HILLS

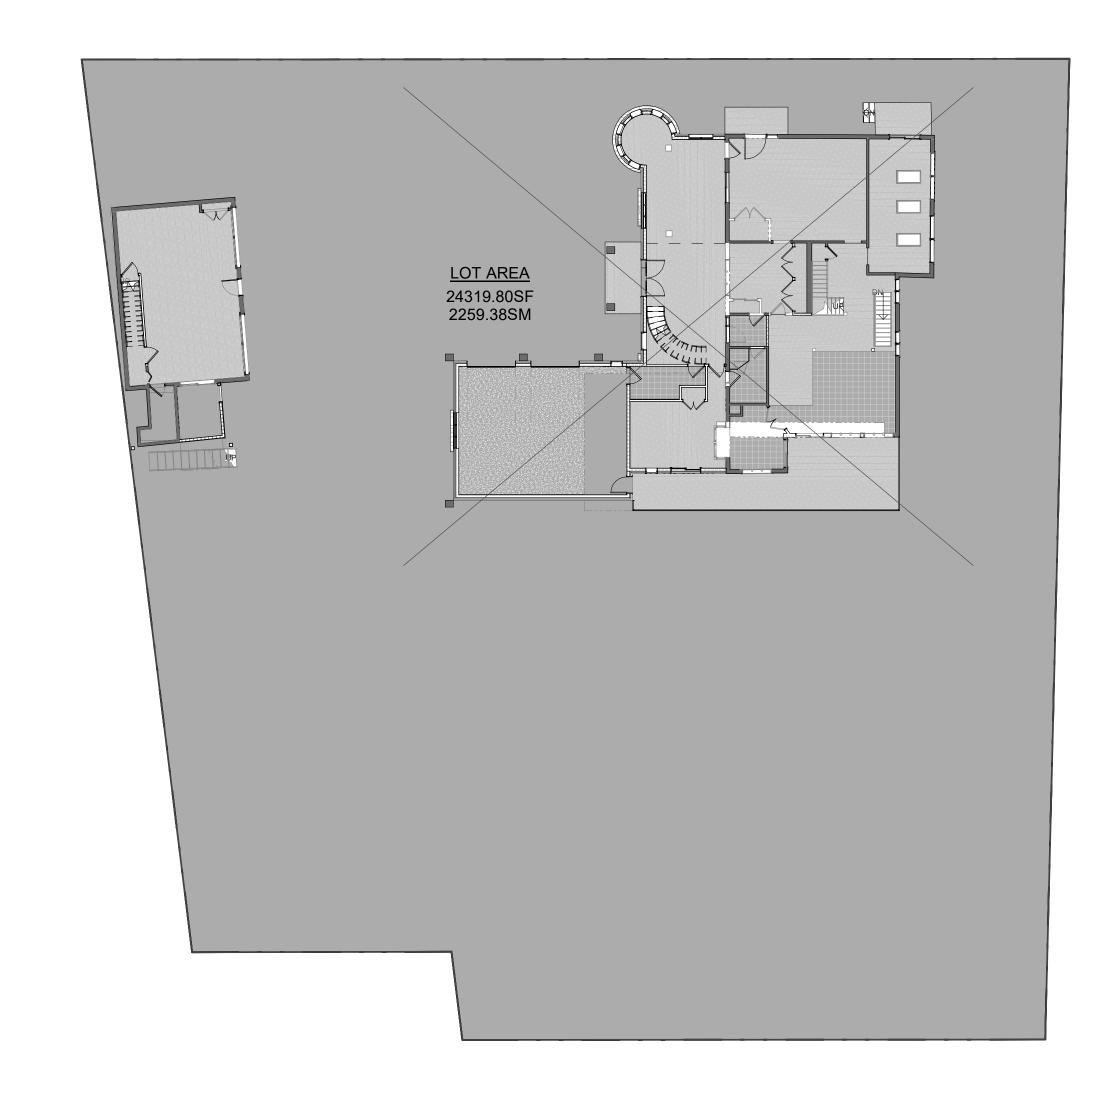

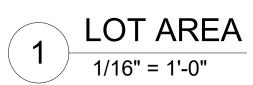

LOT AREA		
LOT AREA	2259.38 m ²	24320 SF

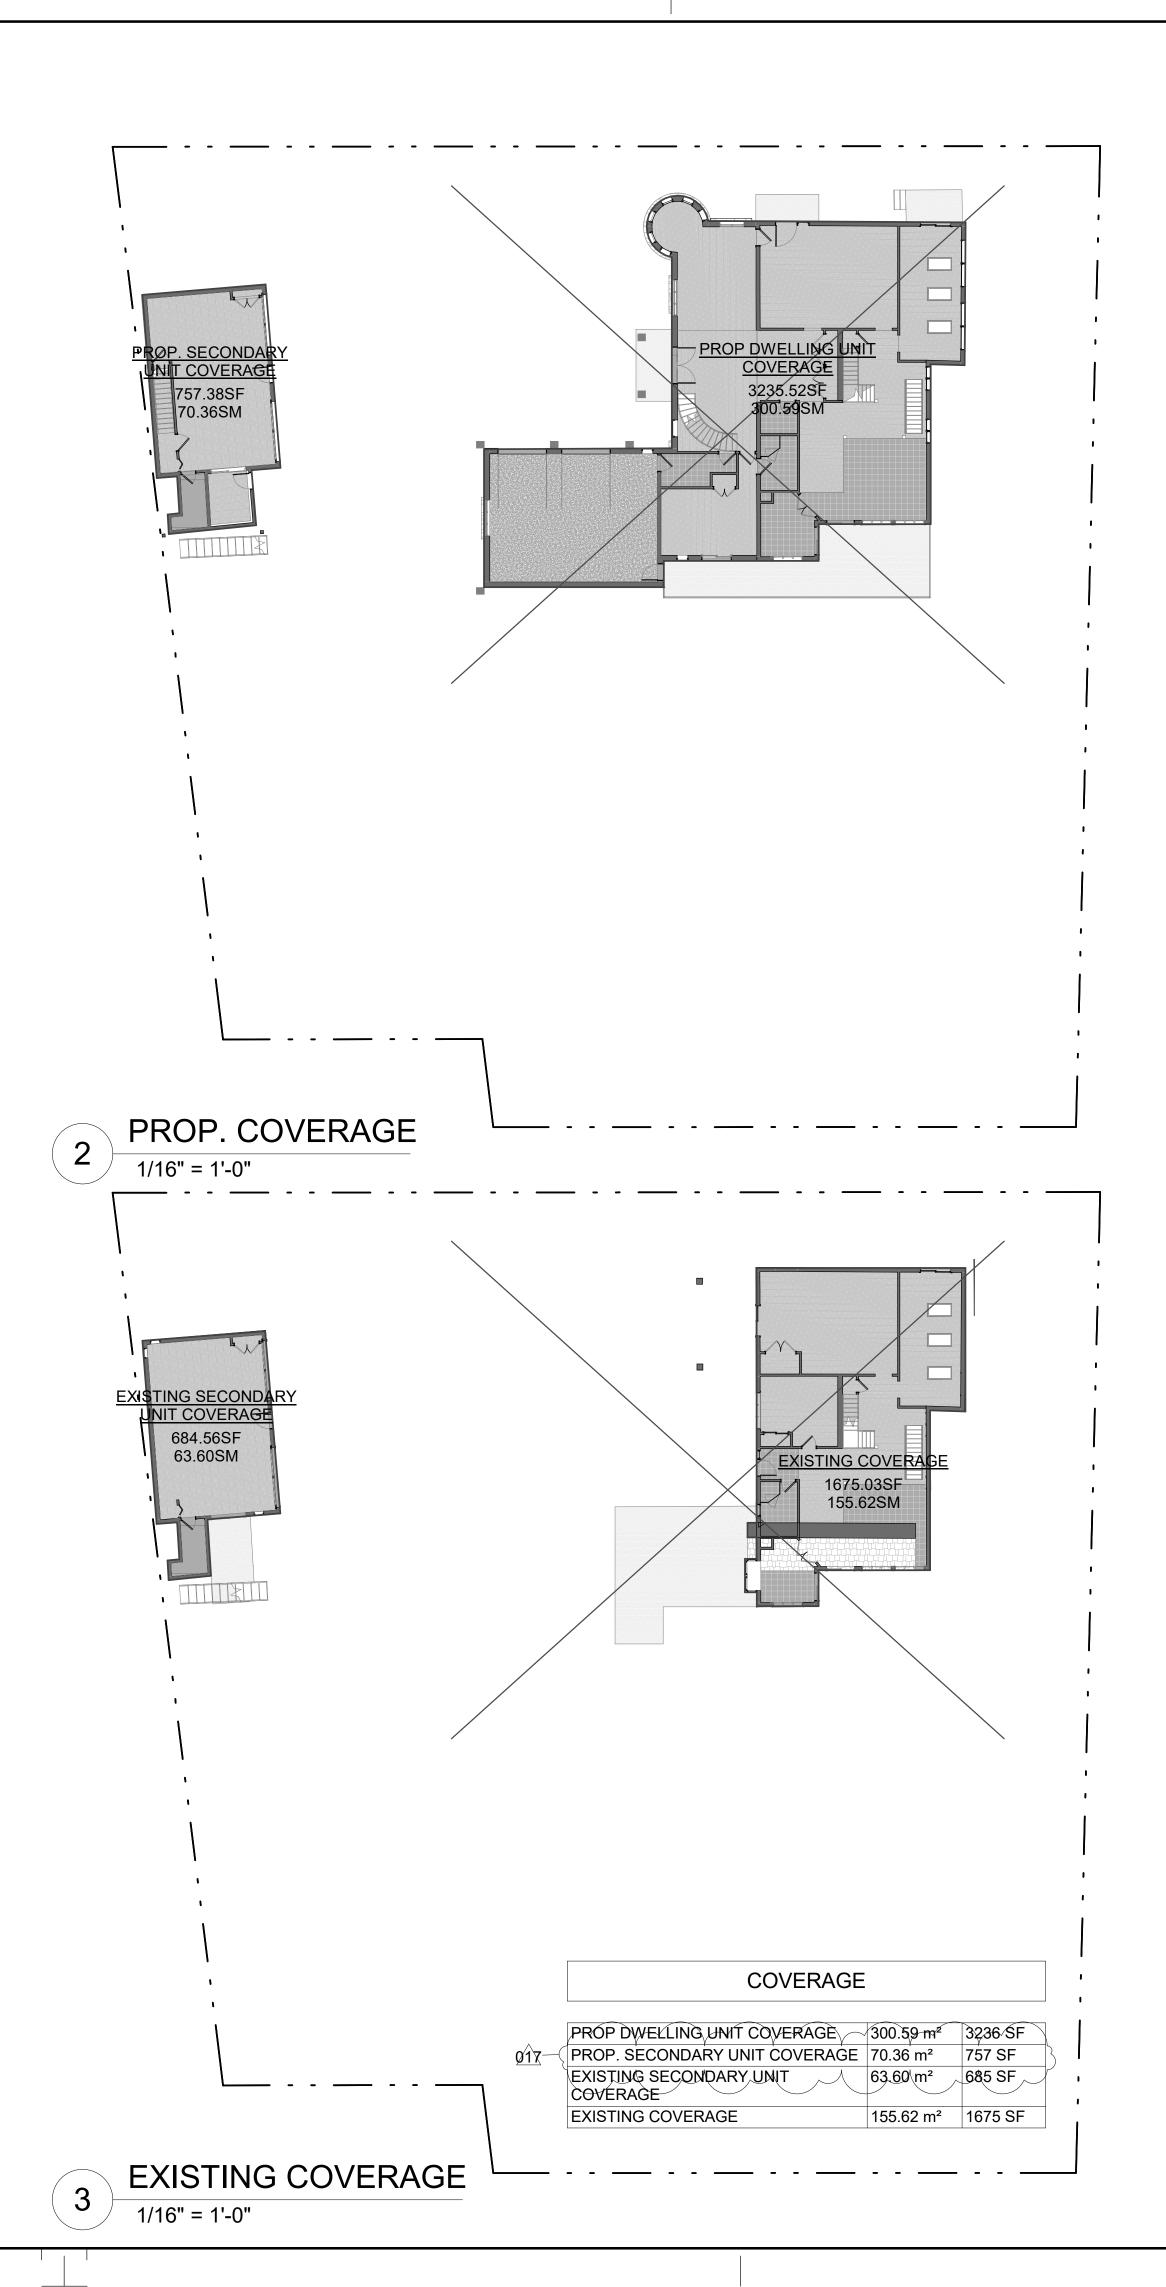

14 RIVER ROAD

BRAMPTON, ON L6X 0A6

Owner



REVISIONS

No.	Description	Date
INO.	Description	Date
018	ISSUED FOR COFA	03/14/2024
017	REISSUED FOR BUILDING PERMIT	03/07/2024
016	ISSUED FOR COFA	02/14/2024
015	REISSUED FOR BUILDING PERMIT	02/14/2024
013	ISSUED FOR BUILDING PERMIT	12/01/2023
06	ISSUED FOR BUILDING PERMIT	06/22/2023
04	ISSUED FOR ZONING REVIEW	02/17/2023

Discrepancies must be reported immediately to the Architect before proceeding. Only figured dimensons are to be used. Contractors must check all dimensions on site. This drawing is protected by copyright.

ALL DIMENSIONS ARE SHOWN IN IMPERIAL & METRIC

CONSULTANTS





TORONTO - CANADA 416.546.2040 info@qbsarchitects.co DRAWING TITLE

LOT AREA AND COVERAGE

CHECKED SCALE @ ARCH D 1/16" = 1'-0"

GRAPHIC SCALE


PROJECT NO. 200155


DRAWING NO.

COFA A0-06


018

HALTON HILLS

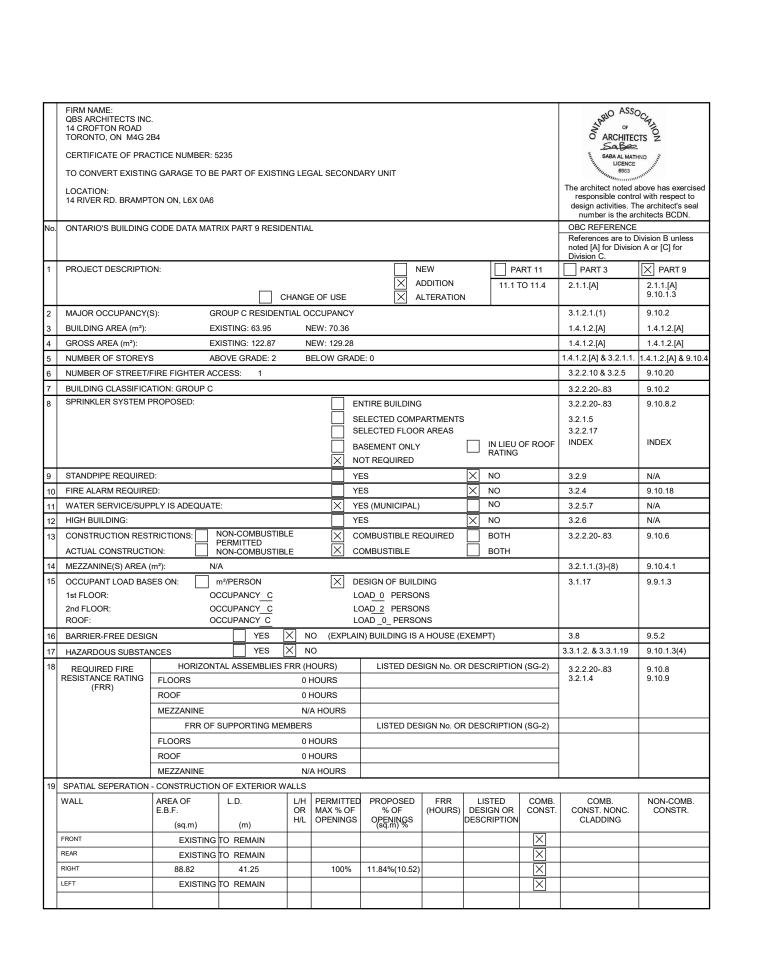


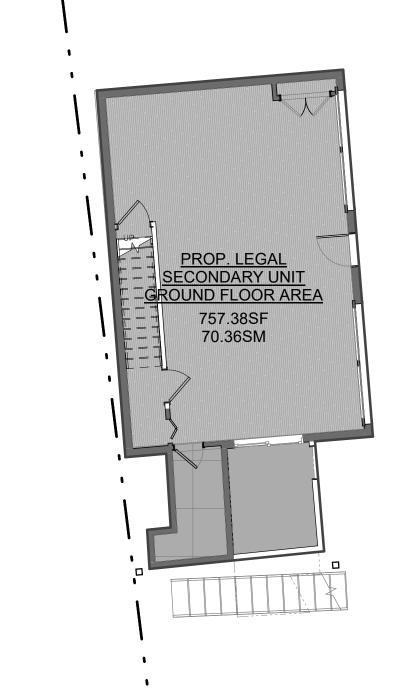

PROPOSED SECONDARY UNIT GROUND FLOOR - EXISTING GARAGE

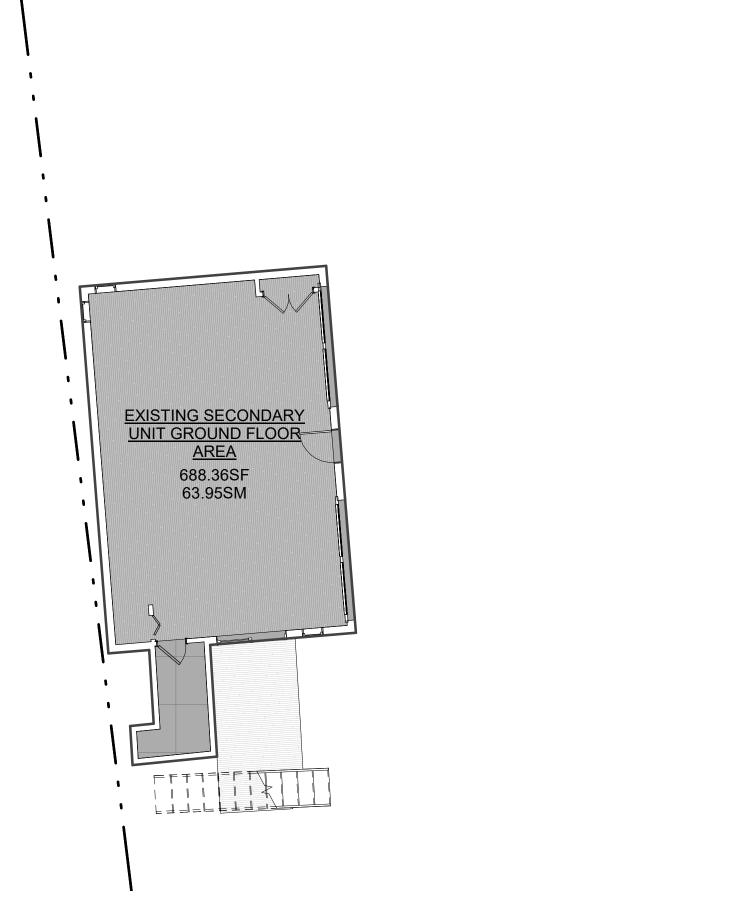

EX SECONDARY UNIT GROUND FLOOR LEVEL

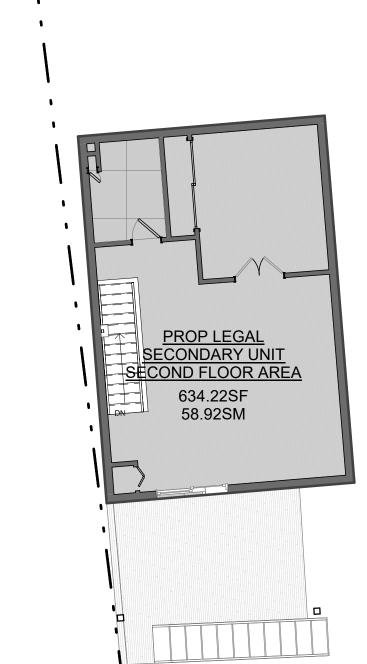

PROPOSED SECONDARY UNIT SECOND FLOOR 1/8" = 1'-0"



PROJECT

PROPOSED SECONDARY UNIT FLOOR AREAS

PROP. LEGAL SECONDARY UNIT GROUND FLOOR 757.38 SF 70.36 m² | AREA | | PROP LEGAL SECONDARY UNIT SECOND FLOOR | 634.22 SF | 58.92 m² |

14 RIVER ROAD

BRAMPTON, ON L6X 0A6

Owner



REVISIONS

No.	Description	Date
)18	ISSUED FOR COFA	03/14/2024
)17	REISSUED FOR BUILDING PERMIT	03/07/2024
)13	ISSUED FOR BUILDING PERMIT	12/01/2023
)6	ISSUED FOR BUILDING PERMIT	06/22/2023

Discrepancies must be reported immediately to the Architect before proceeding. Only figured dimensons are to be used. Contractors must check all dimensions on site. This drawing is protected by copyright.

ALL DIMENSIONS ARE SHOWN IN IMPERIAL & METRIC





TORONTO - CANADA 416.546.2040 info@gbsarchitects.ce DRAWING TITLE

SECONDARY UNIT FLOOR AREA **PLAN**

DRAWN		CHECKE	D
PP			SA
SCALE @ ARCH E As indi		DATE	06/21/23
DM	GRAPHIC	C SCALE	

PROJECT NO.

200155

STAGE DRAWING NO.

COFA A0-09

HALTON HILLS

CONSTRUCTION NOTES

1 EXCAVATION EVERY EXCAVATION SHALL BE UNDERTAKEN IN SUCH A MANNER AS TO PREVENT MOVEMENT WHICH WOULD CAUSE DAMAGE TO ADJACENT PROPERTY EXISTING STRUCTURES, UTILIITIES, ROADS, AND SIDEWALKS, AT ALL STAGES OF CONSTRUCTION.

WHERE THE DEPTH OF EXCAVATION EXCEEDS 4'-0" EXCAVATE AT A 45 deg ANGLE OR IN ACORDANCE WITH APPROVED SHORING DETAIL. STRUCTURE IS NOT TO BE LOCATED ON GROUNDS HAVING A SLOPE STEEPER THAN ONE VERTICAL TO TWO HORIZONTAL.

- 5" MIN. PROJECTION X 8" DEEP POURED CONCRETE
- 2 - 15M HORIZONTAL BARS CONTINUOUS KEY FOOTING TO FOUNDATION WALL W / 10 M
REBAR DOWELS @ 32" O.C.
- FOOTINGS (MINIMUM 2200 PSI @ 28 DAYS CONCRETE) MUST BEAR ON UNDISTURBED
SOIL CAPABLE OF 3,000 PSF LOADING BOTTOM OF FOOTING TO BE MIN. 4' - 0" BELOW
LOWEST GRADE ON UNDISTURBED SOIL
- NOTE: CONTRACTOR RESPONSIBLE FOR DETERMINING SHORING METHOD AND / ORTHE EXTENT OF UNDERPINNING (IF REQUIRED) AT NEIGHBOURING PROPERTIES STRUCTURES. NOTE ANGLE OF REPOSE BETWEEN FOOTINGS NOT TO EXCEED 7:11 (VERT.: HORIZ.) ALL FOOTINGS TO BE HAND CLEANED AND CONCRETED IMMEDIATELY AFTER EXCAVATION. POUR A SKIM COAT OF CONCRETE ON THE BEARING SURFACES OF ALL FOOTING EXCAVATIONS IMMEDIATELY AFTER THE FOOTINGS HAVE BEEN CLEANED, INSPECTED AND APPROVED BY A GEOTECHNICAL ENGINEER

- IF VARIABLE SUBSOIL CONDITIONS OCCUR, A GEOTECHNICAL ENGINEER SHOULD INSPECT ALL FOOTING FOUNDING LEVELS IMMEDIATELY PRIOR TO PLACING OF EITHER REINFORCING BARS OR CONCRETE TO ENSURE COMPLIANCE WITH THE ALLOWABLE SOIL

3 FOUNDATION BACKFILLING - APPLY 12" CLEAR STONE COVER OVER WEEPING TILES - BACKFILL WITH GRANULAR B MATERIAL APPLIED IN 24" LIFTS - PROVIDE 12" LAYER OF COMPACTED TOP SOIL SLOPED AWAY FROM FOUNDATION WALL.

4 FOUNDATION WALL MIN. 4" OF FREE DRAINAGE GRANULAR MATERIAL, AND A B.M.E.C. APPROVED DRAINAGE - 2 COATS ASPHALT EMULSION - 1/2 " CEMENT PARGING COVED OVER FOOTING AND TO 8" ABOVE GRADE EXCEPT AS OTHERWISE NOTED
- POURED CONCRETE (SPECS AS NOTED ON DRAWINGS)

5 FOUNDATION FOOTINGS TO BE FOUNDED ON NATIVE, INORGANIC, UNDISTURBED SOIL CAPABLE OF SUSTAINING MINIMUM 3000 psf OF ALLOWABLE BEARING PRESSURE SLOPE BETWEEN STEPPED OR ADJACENT FOOTINGS SHALL HAVE A MAXIMUM OF 7 VERTICAL AND 10 HORIZONTAL AND STEPS SHALL NOT EXCEED 2'-0" VERTICALLY EXTERIOR FOOTINGS WILL BE FOUNDED AT A LEVEL AT LEAST 4'-0" BELOW FINISHED

6 CONCRETE SLAB ON GRADE - MACHINE TROWELLED 4" POURED CONCRETE WITH A MINIMUM COMPRESSIVE STRENGTH OF 32 MPA AND 5 - 8% AIR ENTRAINMENT
- 6 MIL. VAPOR / MOISTURE BARRIER "SUPER SIX" TURNED AT INSIDE FACE OF FOUNDATION WALL
-5" MIN. COMPACTED CRUSHED CLEAR LIMESTONE ON UNDISTURBED SOIL - NOTE: USE 32MPA AND 5-8% AIR ENTRAINMENT MIN. COMPRESSIVE STRENGHT CONCRETE IN ALLGARAGE (INCLUDING INTERIOR GARAGES) AND EXTERIOR SLABS - SLOPE TO DRAIN @ MINIMUM 1 % SLOPE AS APPLICABLE.

7 WEEPING TILES

- -4" DIA. CORRUGATED PLASTIC WEEPING TILE W/ FILTER "SOCK" (TERRAFIX 270R OR SIMILAR POROUS FIBRE GEOTEXTILE) SET AT BOTTOM OF FOOTING - SURROUND WEEPING TILE WITH 12" MIN. LAYER OF 3/4" SIZE CLEAR LIMESTONE AND SUBSEQUENTLY WRAPPED IN A SECOND LAYER OF NON CLOGGING GEOTEXTILE FILTER

- SLOPE WEEPING TILE TO FROST FREE SUMP PIT & PUMP OR TO DRAIN. NOTE: PROVIDE ACCESS FOR WEEPING TILE CLEAN OUT AT NUMEROUS LOCATIONS. 8 CONCRETE SLAB ON GRADE - PATIO

- "CREDIT VALLEY" FLAGSTONE OR APPROVED EQUAL. RANDOM SQUARE CUT PATTERN OR AS PER PLANS.

- MACHINE TROWELLED 4" POURED CONCRETE WITH A MINIMUM COMPRESSIVE STRENGTH OF 32 MPA AND 5 - 8% AIR ENTRAINMENT - 6 X 6 X 6/6 W.W.M. REINFORCEMENT - 6" MIL. VAPOUR BARRIER "SUPER SIX"
- 5" MIN. COMPACTED CRUSHED CLEAR LIMESTONE ON UNDISTURBED SOIL FOUNDATION AS PER PLAN

- NOTE: CONTRACTOR TO SUPPORT LARGE SLAB AREAS WITH 8" DIA. SONO TUBE FOUNDATIONS C/W REBAR TYING SLAB TO SONO TUBE.
- SLOPE TO DRAIN @ MINIMUM 1 % SLOPE AS APPLICABLE.

9 EXPOSED FOUNDATION WALL - 4" STONE VENEER BONDED SOLID TO 6" CONCRETE BLOCK (MORTAR FILL SPACE BETWEEN STONE AND FOUNDATION WALL)
- 3/16" DIA. CORROSION RESISTANT WIRE TIES, WITH 2" HOOK AT EACH END @ 8"
VERTICALLY, 36" HORIZONTALLY
- 3/16" BLOCK-LOCK @ 16" O.C. VERTICALLY, ALLOW FOR FULL CONTACT WITH STONE

10 INSULATED FOUNDATION WALL - MIN 4" OF EREF DRAINAGE GRANLII AR MATERIAL AND A B M F C APPROVED DRAINAGE LAYER SUCH AS "DELTA MS"

- 2 COATS ASPHALT EMULSION

- 1/2 "CEMENT PARGING COVED OVER FOOTING AND TO 8" ABOVE GRADE EXCEPT AS

OTHERWISE NOTED
- CONCRETE BLOCK (THICKNESS AND REINFORCEMENT AS NOTED IN PLANS) C/W HEAVY
GAUGE BLOCK LOCK (HORIZONTAL) EVERY SECOND COURSE
- 2 X 6 STUDS AT 16"O.C. DAMPPROOFING LAYER (POLY) BELOW STUD PLATE TO GROUND - 5 1/2" (R24) HIGH DENSITY BATT INSULATION - 3 II.2 (R24) HIGH DENSITY BATTINGSCATION - 6 MIL. VAPOUR / AIR BARRIER "SUPER SIX", LAP ALL JOINTS MIN. 3" AND SEAL W/ ACOUSTIC TYPE SEALANT

(11) EXTERIOR WALL HORIZONAL WOOD SIDING - 1" X 6" SOLID WOOD SIDING BY "MAIBEC" RABBITED BEVEL PROFILE, STAINED (COLOUR TO 'TYPAR' HOUSEWRAP BY REEMAY, INSTALL AS PER MANUFACTURER SPECIFICATIONS; LAP & TAPE ALL JOINTS
- 1/2" ORIENTED STRAND BOARD (OSB)

- 1/2 ORIENTED STRAND BOARD (USB)
- 2 X 6 STUDS AT 16" O.C.
- 5.5" HIGH DENSITY BATT INSULATION (R-24)
- 6 MIL. VAPOUR / AIR BARRIER "SUPER SIX". LAP ALL JOINTS MIN. 3" AND SEAL W/
ACOUSTIC TYPE SEALANT
- 1/2" DRYWALL. 5/8" "TYPEX" DRYWALL, WHERE SETBACK IS LESS THAN 4' AWAY FROM 12 PREFAB STONE EXTERIOR WALL

- 1" /2" PREFAB STONE (CONTRACTOR TO
CONFIRM STONE SELECTION W/ ARCHITECT PRIOR TO ORDERING)
- NON-CORROSIVE METAL TIES AT 32" O.C. HORIZONTAL, 16" O.C. VERTICAL
- MASONRY VENTS AT 24" O.C. TOP & BOTTOM OF CAVITY WALL C/W INSECT SCREENS;
COLOUR TO MATCH STONE ROVIDE THROUGH-WALL FLASHING AT BOTTOM OF CAVITY TO MINIMUM 6" UP BEHIND

- 1" AIR SPACE - "TYPAR" HOUSEWRAP BY REEMAY, INSTALL AS PER MANUFACTURER SPECIFICATIONS; LAP & TAPE ALL JOINTS - 1/2" ORIENTED STRAND BOARD (OSB) - "IZ GINERALD STRAIND BOARD (COSD)
- 2" X 6" STUDS AT 16" O.C., DOUBLE PLATE AT TOP
- 6" BATT INSULATION (R-19+5a)
- 6 MIL. VAPOUR / AIR BARRIER "SUPER SIX". LAP ALL JOINTS MIN. 3" AND SEAL W/
ACOUSTIC TYPE SEALANT - 1/2" DRYWALL. - 5/8" "TYPEX" DRYWALL, WHERE SETBACK IS LESS THAN 4' AWAY FROM PROPERTY LINE.

13 STUCCO EXTERIOR WALL - JOINTS AS PER INDUSTRY STANDARD AND AS PER ELEVATIONS (SEE ELEVATIONS / DETAILS FOR STANDARD DECORATIVE WINDOW AND DOOR CASINGS, SILLS, CROWN MOULDING AND BANDING - POURED CONCRETE THRESHOLD OR 6" CUT LIMESTONE SILL AT ALL DOORS)-SEE ELEVATIONS - CGC FINISH COAT ACRYLIC STUCCO, COLOUR AND FINISH TO BE SELECTED BY NOTE: MAINTAIN 8" MIN. BETWEEN STUCCO AND GRADE - NOTE: MAINTAIN 6 MIN. DETWEEN STOCCO AND GRADE - 3 UNDERCOATS OF CGC CEMENT BASED STUCCO - 2" FORMULAR CODEBOARD CONTINUOS INSULATION (R-10); LAP & TAPE ALL JOINTS

- 1/2 EXTERIOR GRADE FIR FLITTOGO -2" X 6" STUDS AT 16" O.C. -6" BATT INSULATION (R-19+5ci) -6 MIL. VAPOUR / AIR BARRIER "SUPER SIX". LAP ALL JOINTS MIN. 3" AND SEAL W/ ACOUSTIC TYPE SEALANT 1/2" DRYWALL. 5/8" "TYPEX" DRYWALL, WHERE SETBACK IS LESS THAN 4' AWAY FROM PROPERTY LINE

- 5/8" TYPEX UNTWALL, WHERE SEIDAGES LESS HEAVE AWATHOUT OF LAND.

- NOTE: CONTRACTOR RESPONSIBLE FOR LAYING MINIMUM 12" WIDE

WASHED RIVERSTONE STRIP OVER FILTER CLOTH AROUND ENTIRE PERIMETER TO PREVENT BACKSPLASH DURING RAINSTORMS (14) FLASHING - PROVIDE PREFINISHED ALUMINUM / COPPER FLASHING IN ALL THE FOLLOWING LOCATIONS
- BENEATH JOINTED MASONRY SILLS

OVER BACKS AND TOPS OF PARAPET WALLS - OVER HEADS OF GLASS BLOCK PANELS
- OVER HEADS OF WINDOWS AND DOORS SET FURTHER THAN 1/4 THE EAVES OVERHANG BELOW THE SOFFIT
- AROUND CHIMNEYS, OR ANY ELEMENTS CROSSING ROOF SURFACES THAT ARE NOT SUPPLIED WITH MANUFACTURERS FLASHING
- AT INTERSECTION OF ROOF SURFACES WITH EXTERIOR WALLS
- AT ALL ROOF VALLEYS

(15) CURVED CORNER BEAD - FLEXIBLE CORNER BEAD AT RADIUSED DRYWALL EDGES MUST BE USED.

/2" EXTERIOR GRADE FIR PLYWOOD

16 HARDWOOD FLOORING - 3/4" X 2 1/4" SELECT RED OAK T & G STRIP FLOORING - BLIND NAIL TO EXISTING / NEW SUBFLOOR. INSTALL WAXED BUILDING PAPER OVER SUBFLOOR PRIOR (USE PREFINISHED HARDWOOD FLOORING - CONFIRM W/ OWNER - SAND STRIP FLOORING TO EXPOSE NATURAL WOOD USING THREE (3) STAGE SANDING - FINISH WITH 100 GRIT PAPER. - STAIN COLOUR TO BE DETERMINED (IF APPLICABLE)

APPLY THREE (3) COATS HIGH QUALITY URETHANE, SANDING LIGHTLY BETWEEN COATS. - NOTE: NO SEALÉR TO BE USED!

(17) EXISTING HARDWOOD FLOORING (RENOVATION) - SAND EXISTING STRIP FLOORING AND IN FILL TO EXPOSE NATURAL WOOD USING THREE (3) STAGE PROCESS.
- FINISH WITH 100 GRIT PAPER (MINIMUM). - FINISH WITH 100 GNIT PAPER (WINNIMOW).
- APPLY THREE (3) COATS HIGH QUALITY URETHANE, SANDING LIGHTLY BETWEEN COATS.
- NOTE: NO SEALER TO BE USED!

18 FLOOR TILING

EMBEDMENT IN EXISTING SOLID MASONRY WALL

(19) LEDGER BOARD

- LAY ASPHALT SHEATHING PAPER, FELT OR POLYETHYLENE FILM GALVANIZED WIRE MESH (2" X 2"), SCRATCH CEMENT COAT (1 1/4" MIN. THICK) TILING / GROUTING (COLOUR TO BE DETERMINED) - NOTE: APPLY 2 COATS OF SEALER FOR STONE FLOORING (AS PER SUPPLIER'S / MANUFACTURER'S SPECIFICATIONS).

- CONTINUOUS 2 - 2 X 10 OR AS PER PLANS GLUED LEDGER BOLTED WITH STAGGERED 3/4" DIA. RAM SET RED HEAD DYNA BOLTS @ 18" O.C. - MIN. 2 1/2"

20) <u>ENGINEERED HARDWOOD FLOORING</u>
- CONCRETE SUBFLOORS: MUST BE DRY, SMOOTH (LEVEL WITHIN 3/16" IN A 10' RADIUS - CONCRETE SUBFLOORS: MUST BE DRY, SMIDOTH (LEVEL WITHIN 3/10 IN A 10 RADIOS 1/8" IN 6') AND FREE OF STRUCTURAL DEFECTS. HAND SCRAPE OR SAND WITH A 20-GRIT -#3-1/2" OPEN FACE PAPER TO REMOVE LOOSE, FLAKY CONCRETE. GRIND HIGH SPOTS IN CONCRETE AND FILL LOW SPOTS WITH A PORTLAND BASED LEVELING COMPOUND (MIN. 3,000 PS)). CONCRETE MUST BE FREE OF PAINT, OIL, EXISTING ADHESIVES, WAX, GREASE, DIRT AND CURING COMPOUNDS. THESE MAY BE REMOVED MECHANICALLY BUT DO NOT USE SOLVENT-BASED STRIPPERS UNDER ANY CIRCUMSTANCES. THE USE OF RESIDUAL SOLVENTS CAN PROHIBIT THE SATISFACTORY BOND OF FLOORING ADHESIVES.

- IT IS IMPORTANT TO ENSURE A PROPER BOND BETWEEN THE ADHESIVE AND THE CONCRETE, AND PLANKS OR STRIPS, ENGINEERED HARDWOOD FLOORING MAY BE NSTALLED ON-GRADE, AS WELL AS BELOW GRADE WHERE MOISTURE CONDITIONS

- LIGHTWEIGHT CONCRETE: LIGHTWEIGHT CONCRETE WITH A DRY DENSITY OF 100 POUNDS OR LESS PER CUBIC FOOT IS ONLY SUITABLE FOR ENGINEERED WOOD FLOORS WHEN USING THE FLOATING INSTALLATION METHOD. MANY PRODUCTS HAVE BEEN DEVELOPED AS SELF-LEVELING TOPPINGS OR FLOOR UNDERLAYMENTS. THESE INCLUDE CELLULAR CONCRETE, RESIN-REINFORCED CEMENTATIONS UNDERLAYMENTS, AND GYPSUM-BASED MATERIALS. ALTHOUGH SOME OF THESE PRODUCTS MAY HAVE THE NECESSARY QUALIFICATIONS FOR UNDERLAYMENT FOR WOOD FLOORING NSTALLATIONS, OTHERS DO NOT. TO TEST FOR LIGHTWEIGHT CONCRETE, SCRAPE A COIN OR KEY ACROSS THE SURFACE TO TEST FOR LIGHTWEIGHT CONCRETE, SCRAPE A COIN OR KEY ACROSS THE SURFACE
OF THE SUBFLOOR.
 IF THE SURFACE POWDERS EASILY OR HAS A DRY DENSITY OF 100 POUNDS OR LESS
PER CUBIC FOOT, USE ONLY THE FLOATING INSTALLATION METHOD.
 TO ENSURE A LONG LASTING BOND, MAKE SURE THAT THE PERIMETER OF THE
FOUNDATION HAS ADEQUATE DRAINAGE AND VAPOR BARRIER.

WOOD SUBFLOORS: WOOD SUBFLOORS NEED TO BE WELL NAILED OR SECURED WITH - WOOD SUBFLOORS: WOOD SUBFLOORS NEED TO BE WELL NAILED OR SECORED WITH SCREWS, NAILS SHOULD BE RING SHANKS AND SCREWS NEED TO BE COUNTER SUNK.

- THE WOOD SUBFLOOR NEEDS TO BE STRUCTURALLY SOUND AND DRY. IT SHOULD NOT EXCEED 13% MOISTURE PRIOR TO INSTALLATION.

- IF THE SUBFLOOR IS SINGLE LAYER, LESS THAN 3/4" THICK, ADD A SINGLE CROSS LAYER FOR STRENGTH AND STABILITY (MINIMUM 5/16" THICK FOR A TOTAL 1" THICKNESS).

- THIS IS TO REDUCE THE POSSIBILITY OF SQUEAKING.

- WOOD SUBFLOORS MUST BE FREE OF PAINT, OIL, EXISTING ADHESIVES, WAX, GREASE, DIRT LIREFTHANE VARRISH FTC. DIRT, URETHANE, VARNISH, ETC. · UNDERLAYMENT GRADE OSB (NOT THE WAX SIDE) IS ALSO A SUITABLE SUBFLOOR. PARTICLEBOARD IS NOT AN ACCEPTABLE SUBFLOOR FOR STAPLE OR NAIL DOWN INSTALLATIONS BUT CAN BE USED AS A SUBFLOOR IN

GLUE-DOWN INSTALLATIONS.
WHEN INSTALLING OVER EXISTING WOOD FLOORING, INSTALL AT RIGHT ANGLES TO THE - SUBFLOOR MOISTURE CHECK: ENGINEERED HARDWOOD FLOORING MAY BE USED FOR ABOVE-, ON-, AND BELOW-GRADE APPLICATIONS. ON ALL COMMON SUBSTRATES, ON-AND BELOW-GRADE APPLICATIONS ARE SUSCEPTIBLE TO MOISTURE AND SHOULD BE ON-AND BELOW-GRADE APPLICATIONS ARE SUSCEPTIBLE TO MOISTORE AND SHOULD BE TESTED FOR MOISTURE PRIOR TO INSTALLATION IN SEVERAL LOCATIONS WITHIN THE INSTALLATION AREA. - ACCEPTABLE CONDITIONS FOR ABOVE-, ON-, AND BELOW-GRADE APPLICATIONS ARE: LESS THAN 3 1BS. /1000 SF / 24 HRS. ON A CALCIUM CHLORIDE TEST
OR AN ACCEPTABLE READING ON AN ELECTRONIC CONCRETE MOISTURE METER
WOOD SUBSTRATES MUST HAVE A MOISTURE READING OF LESS THAN 13% WHEN USING AN ELECTRONIC WOOD MOISTURE METER

IIMPORTANT NOTE:THE ABOVE IS A GUIDE LINE. INSTALLER MUST FOLLOW MANUFACTURES INSTALLATION INSTRUCTIONS ASSOCIATED WITH THE PRODUCT

21 GUARD DESIGN LOADS MINIMUM SPECIFIED HORIZONTAL LOAD APPLIED INWARD OR OUTWARD AT THE TOP OF EVERY REQUIRED GUARD SHALL BE:

1) A UNIFORM LOAD OF 50 LB/FT OR A CONCENTRATED LOAD OF 225 LBS

2) A VERTICAL LOAD OF 100 LB/FT, WHICH NEED NOT ACT SIMULTANEOUSLY WITH THE HORIZONTAL LOAD 3) INDIVIDUAL ELEMENTS ARE TO BE DESIGNED FOR A CONCENTRATED LOAD OF 113 LBS 3) INDIVIDUAL ELEMENTS ARE TO BE DESIGNED FOR A CONCENTRATED LOAD OF 113 LBS AT ANY POINT OPENING THROUGH ANY GUARD SHALL BE OF SIZE, WHICH WILL PREVENT THE PASSAGE OF A SPHERICAL OBJECT HAVING A DIAMETER OF MORE THAN 4 IN. GUARDS SHALL BE DESIGNED/INSTALLED SO THAT NO MEMBER ATTACHED OR WALKING SURFACE WILL FACILITATE CLIMBING.
OR OPENING LOCATED BETWEEN 4 IN. AND 35 IN. ABOVE THE FLOOR

22 ROOF CONSTRUCTION - ASPHALT SHINGLES (25 YEARS) - COLOUR TO MATCH EXIST.
- 1/2" PLYWOOD SHEATHING (WITH "H"CLIPS IF USING TRUSSES)
- ROOF STRUCTURE AS SPECIFIED IN PLAN
- PROVIDE ICE AND WATER SHIELD EAVES PROTECTION TO EXTEND 36" MIN. BEYOND INTERIOR FACE OF EXTERIOR WALL. MIN. 3" LAP AND 6" END LAP (AS PER 9.26.5 OBC)
- PREFINISHED ALUMINUM DRIPEDGE BELOW SHINGLES
- PREFIN. ALUMINUM EAVESTROUGH ON WOOD FASCIA AND VENTED
SOCIETY WITH INSECT SCREEN TO MATCH EXISTING SOFFIT WITH INSECT SCREEN TO MATCH EXISTING - 2" X 6" CELING JOISTS @ 16" O.C. (OR AS NOTED IN PLANS)
- 11" (R-32) BATT INSULATION - BAFFLE AS REQUIRED FOR VENTILATION
- 6 MIL. VAPOUR / AIR BARRIER "SUPER SIX". LAP ALL JOINTS MIN. 3" AND SEAL W/ ACOUSTIC TYPE SEALANT

PREFINISHED ALUMINUM SOFFIT WITH INSECT SCREENING - LAY ALUMINUM PANELS WITH CORRUGATIONS PERPENDICULAR TO FASCIA - SEE PLANS FOR OVERHANG DIMENSION.

24 EAVESTHROUGH/DOWNPIPES - 5" -6" MAX WIDE PREFINISHED ALUMINUM EAVESTROUGH (COLOUR TO BE DETERMINED)
- 3" X 4" PREFINISHED ALUMINUM DOWNPIPES (COLOUR TO BE DETERMINED) C/W
CONCRETE SPILL PAD (SLOPE AWAY FROM BUILDING) NOTE: DOWNPIPES ROUTING TO BE DISCUSSED W/ ARCHITECT PRIOR TO INSTALLATION. 25 DESIGN LOADS

- DEAD LOAD AT TOP CHORD 9 LB / SQFT - LIVE LOAD STANDARD AS PER LOCAL MUNICIPAL REQUIREMENTS (UNLESS NOTED - 1/2" EXTERIOR GRADE PLYWOOD SHEATHING W/ "H" CLIPS. (26) CEILING VENTILATION

- CONTRACTOR TO PROVIDE ADEQUATE VENTILATION - MIN. VENT AREA: 1/150 FOR FLAT - CONTRACTOR TO PROVIDE ADEQUATE VENTILATION - MIN. VENT AREA. 17150 FOR FLAT ROOFS) OF INSULATED CEILING AREA; ENSURE INSECT SCREEN. - INSTALL "LEXSUCO" ROOF STACK VENTS TO BE UNIFORMLY DISTRIBUTED AND INSTALLED AS PER MANUFACTURER'S SPECS. (SIZE AND NUMBER TO BE DECIDED ON SITE) - SOFFIT VENTS TO BE INSECT SCREENED - COLOUR OF ROOF VENTS TO BE DECIDED

- CONTRACTOR TO PROVIDE ADEQUATE VENTILATION AT BOTH NEW AND EXISTING STRUCTURE - MIN. VENT AREA: 1/300 (1/150 FOR FLAT ROOFS) OF INSULATED CEILING AREA; ENSURE INSECT SCREEN. VENTS TO BE UNIFORMLY DISTRIBUTED - NOTE: ROOF / ATTIC VENTS MUST NOT BE PLACED AT FRONT ELEVATION / ROOF LINE. - CHECK ELEVATION DRAWINGS FOR ANY SPECIFIC ROOF VENT SOFFIT VENTS TO BE INSECT SCREENED
COLOUR OF ROOF VENTS TO MATCH SHINGLES. 28 INSULATED INTERIOR WALL

27 ROOF/ATTIC VENTILATION

1/2" DRYWALL - 2" X 6" STUDS - 6" (R22) BATT INSULATION - 6MIL VAPOUR / AIR BARRIER "SUPER SIX" WITH ALL JOINTS SEALED W/ ACOUSTIC TYPE 1/2" DRYWALL

29 INSULATION ON EXISTING WALL - NO. 15 ASPHALT FELT TO GRADE - 2" X 4" STUDS AT 16" O.C. AMPPROOFING LAYER (BLACK POLY) BELOW STUD PLATE DAMPPROUPING LATER (BLACK POLT) BELOW STOU PLATE

3 1/2" (R 14) BATT INSULATION

6 MIL. VAPOUR / AIR BARRIER "SUPER SIX" WITH ALL JOINTS SEALED W/ ACOUSTIC - 1/2" DRYWALL.

30 ACOUSTICAL TREATMENT 4" SOUND ATTENUATION BLANKET INSTALLED BETWEEN STUDS TYPICAL BETWEEN BEDROOMS AND BATHS

31 BEARING STUD WALL - 2 X 4 STUDS AT 16" O.C. (W/ DOUBLE PLATES)

32 DRYWALL INSTALLATION - ALL DRYWALL TO BE INSTALLED WITH BEVELLED EDGE JOINTS FACING EACH OTHER
- ONLY ONE HORIZONTAL JOINT WILL BE ALLOWED. IF AN ADDITIONAL HORIZONTAL JOINT IS REQUIRED DUE TO WALL HEIGHTS, THE JOINTS MUST BE PLACED AT THE BOTTOM OF THE WALL IN THE BASEBOARD AREA. USE 4'-6" WIDE BOARDS FOR 9'-0" HIGH CEILINGS.

33 DRYWALL ON EXISTING WALL (RENOVATION) - 1/2" DRYWALL GLUED DIRECTLY ON EXIST. MASONRY WALL / OR USE STRAPPING AS - (USE 2 X 2 STRAPPING, 1 1/2" DOW "SM" RIGID INSULATION AND "SUPER SIX" VAPOUR / AIR BARRIER ON EXTERIOR MASONRY WALLS.)

34 MASONRY INFILL - 4" BRICK FACE TO MATCH EXISTING. NOTE: MASONRY MUST BE TOOTHED IN AT PERIMETER OF OPENING (TINT MORTAR TO MATCH EXISTING - NON CORROSIVE METAL TIES @ 24" O/C VERTICAL - 4" BRICK / CONCRETE BLOCK BACKUP OR 2/ 6 STUDS AND 5/8" EXTERIOR GRADE FIR PLYWOOD IF VENEER TYPE CONSTRUCTION.

35 SILL PLATE - 2 X 6 PRESSURE TREATED SILL PLATE SET ON CONTINUOUS MORTAR BED W/1/2" DIA., 12" LONG (MIN. 4" IN CONCRETE.) ANCHOR BOLTS AT 7'-10" MAX. O.C. INTO CONCRETE FILLED TOP COURSE
- ROLL TYPE FOAM GASKET BETWEEN PLATE AND BEDDING & 6 MIL POLY VAPOUR / AIR

(36) TYPICAL INTERIOR PARTITION - 1/2" DRYWALL BOTH SIDES

37 PAINTING - ALL INTERIOR WOOD TRIM: ONE COAT OIL BASED PRIMER, TWO (2) COATS SEMI- GLOSS · ALL DRYWALL SURFACES: ONE COAT LATEX SEALER. TWO (2) COATS SATIN / EGGSHELL - ALL EXTERIOR WOOD TRIM: ONE COAT OIL BASED PRIMER, 2 COATS OIL FINISH - ENAMEL GLOSS - ALL COLOURS TO BE SELECTED BY ARCHITECT / CLIENT. - NOTE: REPAINT ALL WOOD DOORS AND WINDOWS PRIME PLUS ONE FINISH COAT PRIOR TO INSTALLATION.

38 EXTERIOR WINDOWS / DOORS - ALL WINDOWS ARE TO BE WOOD FRAMED CASEMENTS SEALED CLEAR WOOD INTERIOR AND "FLEXACRON" FACTORY PREFINISHED EXTERIOR SURFACES c/w FOLDING TYPE CHANK HANDLE
- ALL GLAZING TO BE CLEAR LOW "E" SEALED THERMOPANE UNITS, ARGON GAS FILLED,
7/8" OVERALL THICKNESS
- CONTRACTOR TO SUBMIT NAME AND TYPICAL DETAILS OF PROPOSED MANUFACTURER
TO THE ARCHITECT FOR APPROVAL.
- NOTE: CONTRACTOR TO SUPPLY AND INSTALL 6" SMOOTH CUT LIMESTONE THRESHOLD AT ALL EXTERIOR DOORS AND 5" AT ALL WINDOWS (UNLESS OTHERWISE NOTED). WINDOW/DOOR HEADER TO BE AT U/S OF JOISTS DIRECTLY ABOVE SWIMMING POOLS: WHERE A WALL OF A BUILDING FORMS PART OF THE SWIMMING POOL ENCLOSURE, ANY GROUND FLOOR WINDOWS IN THE SAID WALLS ARE TO HAVE A SILL HEIGHT OF 4'-11"(1, SM)min. OR A GUARD TO BE PERMANENTLY INSTALLED ON THE WINDOW TO PREVENT THE PASSAGE OF A 4" DIA. SPHERICAL OBJECT

 TO COMPLY WITH OBC 9.7 - 6" HEIGHT SMOOTH CUT PUFF INDIANA LIMESTONE SILL

- 6" GRANULAR "A" GRAVEL COMPACTED
- "LEGACY" RETAINING WALL BY "DECRA-LOC" OR SIMILAR C/W CAPS AND CORNER UNITS
INSTALLED AS PER MANUFACTURER'S SPECIFICATION
- FILL AREA DRAIN WITH GRAVEL AND TERMINATE AT WEEPING TILE
- NOTE: ENSURE 8" CLEARANCE FROM WINDOW SILL TO TOP OF GRAVEL FILL.
- INSTALL CLOSED CELL EXPANSION JOINT BETWEEN WINDOW WELL AND FOUNDATION

- SOLID WOOD (UNLESS NOTED OTHERWISE) 1 3/4" THICK WITH TWO RECESSED RAISED OR RECESSED FLAT WOOD PANELS AS PER DETAIL SKETCH PROVIDED BY THE

DOOR HEIGHTS: GROUND FLOOR = 96" DOORS NOTE: BUILDER/ OWNER TO CONTACT ARCHITECT FOR FINAL DECISION REGARDING NOTE: STRUCTURAL FRAMING AT DOORS/ WINDOWS/ FLAT ARCHES TO BE KEPT AS HIGH AS POSSIBLE TO ALLOW FOR FUTURE DISCUSSION/ HEIGHT ADJUSTMENT

42 POCKET DOOR ENCLOSURE WALL - MINIMUM WIDTH REQUIRED - 1/2" DRYWALL ON 1/2" PLYWOOD BOTH SIDES MINIMUM REQUIRED METAL STUDS - BOTH SIDES (UNLESS OTHERWISE NOTED) - MINIMOM REQUIRED MICH STUDY - BOTH SIDES (UNLESS OTHERWISE NOTED)
- REFER TO DRAWINGS FOR EASING
- INSTALL "N.C. CROWDER" (C-500 SINGLE POCKET DOOR TRACK, NYLON WHEELS W/ BEARING FOR 100 LB DOOR.

43 SHOWER DOOR - 2' - 0" X 6' - 0" (OR AS PER PLAN) TEMPERED GLASS DOOR - PROVIDE MIN. 6" CLEAR ABOVE DOOR - HARDWARE FINISH TO BE POLISHED CHROME UNLESS NOTED OTHERWISE - INSTALL GRANITE / MARBLE SURROUND AROUND SHOWER OPENING.

44 SHOWER / LAUNDRY MACHINE FLOOR PAN - SHOWER LINER BY "AQUAPROOF AQ 530 (OR EQUAL) RETURN UP PAN CURB AND ALL SURROUNDING WALLS
- ADHERE LINER TO DRAIN SLOPE CEMENT BASE TO DRAIN - USE BRAIDED HOSES FOR WASHING MACHINE

45 BATHTUB AND SHOWER WALL - USE TILE-BACKER WATER-RESISTANT - 1/2" "DENS-SHIELD" TILE BACKER BY GEORGIA-PACIFIC AT ALL SURROUNDING WALLS. TAPE WITH 2' WIDE 10 X 10 GLASS MESH SELF ADHESIVE TAPE USE BLUEBOARD AT REMAINING BATHROOM WALLS.

46 HANG ROD & SHELF - 1 1/4" DIA. HANG ROD W/ BRACKETS - ALL CHROME FINISH INSTALL @ 5'-6" O.C. A.F.F. - 3/4" MELAMINE BOARD (WHITE), FINISHED EDGES, 1'-3" DEPTH, ON LEDGER BOARDS @ 2" OVER HANG ROD.

47 MILLWORK CASING # 106 / # 110 BACKBAND # 83 / # 24 STOOL # 80 / # 79 APRON # 106 / # 110 (CUT DOWN TO 3") BASEBOARD # 206 / # 54 /# 51 (ALL 1 X 8)
BASEBOARD # 206 / # 54 /# 53 (ALL 1 X 6 AT BASEMENT)
QUARTER ROUND # 65 / # 14
CROWN MOULDING # 4 (AT CEILINGS) 3 3/4" X 3 3/4" # 3 (AT COFFERS) 3" X 3" #77/#82 # 23 / # 64 / # 46 SHINGLE COVE #7/#9 DOOR STOP DOOR STOP #52 / #52B - NOTE: REFER TO REFLECTED CEILING PLANS FOR EXTENT OF ALL WINDOW OPENINGS TO BE TRIMMED WITH CASING, BACKBAND, STOOL AND APRON (NO PICTURE FRAMING UNLESS NOTED).

- MIN. 4' - 0" LENGTHS OF ALL WOOD TRIM SAMPLES TO BE MOUNTED ON SITE FOR FINAL APPROVAL. - ALL WOOD TO BE WHITE WOOD FOR PAINTING UNLESS OTHERWISE NOTED. PAINT ALL WOOD TRIM, PRIME PLUS ONE FINISH COAT PRIOR T

48 SHELVING PROVIDE (6) 1'-6" DEEP ADJUSTABLE SHELVES.

49 WOOD STRUCTURE INSTALLATION ALL DESIGN DETAILS, HANDLING AND INSTALLATION OF PROPRIETARY WOOD PRODUCTS SHALL BE IN STRICT COMPLIANCE WITH MANUFACTURERS SPECIFICATIONS AND PROVIDE POSTS UNDER ALL BEAMS/GIRDER TRUSSES ETC. POSTS ARE TO RUN CONTINUOUS TO THE FOUNDATION OR EQUIVALENT SUPPORT

MIN. RUN: 8 1/4' MIN. TREAD: 9 1/4"
MIN. NOSING: 1" WHEN RUN LESS THAN 9 7/8" MIN. WIDTH: 2'-10" BETWEEN WALL FACES MIN. HEADROOM: 6'-8" MIN. HANDRAIL HEIGHT: 2'-8" MAX. HANDRAIL HEIGHT: 3'-2"

FACUTATE CLIMBING AS PER 9.8.8.6. (2)

EXTERIOR WALL FACE AND CAULKED.

- SLATE TILES (CONFIRM WITH OWNER)
- 2" LIGHT CONCRETE BEDDING W/ GALVANIZED WIRE MESH (2"X2") - 2 LIGHT COUNCETE BEDDING W. GALVANIZED WIRE MESH (2 A2)
- ISOLATION MEMBRANE
- SLOPE TO SCUPPER DRAIN
- TILING / GROUTING (COLOUR TO BE DETERMINED)
- NOTE: APPLY 2 COATS OF SEALER FOR STONE FLOORING (AS PER SUPPLIER'S / MANUFACTURER'S SPECIFICATIONS).
- REFER TO SPEC. # FOR ROOF CONSTRUCTION.

\$\langle 52 \rangle \text{WOOD DECK AND STEPS} USE PRESSURE TREATED WOOD - USE PRESSURE TREATED WOOD -2" X 4" / 2" X 6"DECKING AS PER PLANS (1/8" SPACING BETWEEN BOARDS) -2" X 8" @ 16" O.C. JOISTS - PROVIDE SOLID CROSS BRIDGING AT MAX. 6' - 0" O.C.

(53) RESIDENTIAL - GUARD DESIGN LOADS - MINIMUM SPECIFIED HORIZONTAL LOAD APPLIED INWARD OR OUTWARD AT THE TOP OF EVERY REQUIRED GAURD SHALL BE:

1) A UNIFORM LOAD OF 50 LB/FT OR A CONCENTRATED OAD OF 225 LBS

2) A VERTICAL LOAD OF 100 LB/FT, WHICH NEED NOT ACT SIMULTANEOUSLY WITH THE HORIZUNI AL LUAD.

3) INDIVIDUAL ELEMENTS ARE TO BE DESIGNED FOR A CONCENTRATED LOAD OF 113 LBS AT ANY POINT. OPENING THROUGH ANY GUARD SHALL BE OF SIZE WHICH WILL PREVENT THE PASSAGE OF A SPHERICAL OBJECT HAVING A DIAMETER OF MORE THAN 4 IN. GUARDS SHALL BE DESIGNED/ INSTALLED SO THAT NO MEMBER ATTACHED OR OPENING LOCATED BETWEEN 5.5" AND 35,5 ABOVE THE FLOOR OR WALKING SURFACE WILL

-4" RIGID METAL DRYER EXHAUST DUCT - PLASTIC EXHAUST GRILLE COMPLETE WITH INSECT SCREEN SECURELY FASTENED TO

55 EXHAUST GRILL - METAL GRILLE WITH INSECT SCREEN
- DIMENSION TO SUIT EXHAUST REQUIREMENTS
- NOTE: CONTRACTOR TO COORDINATE DUCT RUN WITH OTHER MECHANICAL RUNS, PLUMBING RUNS AND STRUCTURE TO ELIMINATE NEED FOR BULKHEADS.

(56) GAS & EXHAUST FUMES PROTECTION - 1/2" PLYWOOD BEHIND - 5/8" "TYPE X" DRYWALL FOR FIRE PROTECTION. TAPED AND SPACKLED. - PROVIDE HIGH DENSITY POLYETHYLENE LAP, TAPE AND SEAL ALL JOINTS TO INTERIOR WALLS AND CEILING

ALL MECHANICAL EXHAUST VENTS, EXHAUST AND INTAKES, TO BE INSTALLED AS PER PERTINENT CODE REQUIREMENTS AND MANUFACTURERS INSTR 58 VENT GRILL

- METAL GRILLE WITH INSECT SCREEN
- DIMENSION TO SUIT EXHAUST REQUIREMENTS
- NOTE: CONTRACTOR TO COORDINATE DUCT RUN WITH OTHER MECHANICAL RUNS. PLUMBING RUNS AND STRUCTURE TO ELIMINATE NEED FOR BULKHEADS

(59) CARBON MONOXIDE DETECTOR - INSTALL CARBON MONOXIDE DETECTOR CONFORMING TO CAN/CGA-6.19 OR ULC 2034 - MUST COMPLY TO $\underline{\rm OBC}~9.33.4$

60 SMOKE ALARM - INSTALL SMOKE ALARM, HARDWIRED WITH BATTERY BACKUP IN EACH FLOOR AND IN EACH SLEEPING ROOM
- ALL SMOKE ALARMS TO CONFORM TO CAN/ULC-S531 AND S553 - MUST COMPLY TO OBC 9.10.19
- SHALL HAVE A SIGNALLING COMPONENT CONFORMING TO THE REQUIREMENTS IN 18.5.3 T, COLOUR, AND PULSE CHARACTERISTICS OF NFPA 72 (NATIONAL FIRE ALARM &

61 ZERO-CLEARANCE GAS FIREPLACE PROVIDE GAS OUTLET AND TYPE "B" VENT TO ROOF OR DIRECT VENT TO OUTSIDE WALL AS PER MANUFACTURER'S SPECIFICATION.
- DIAMETER OF FLUE AND VENT AS PER OBC 9.21.2.5

CONTRACTOR TO INSTALL ARCHITECT'S SIGN AND MAINTAINED THROUGHOUT DURATION
OF CONSTRUCTION AT AGREED UPON LOCATION ON SITE - VERTICAL STEP 23 5/8" MAX. FOR FIRM SOIL, 15 3/4" MAX. FOR SAND OR GRAVEL 23 5/8" MIN. HORIZONTAL RUN.

- 2 PLY TORCHED ON ROOFING MEMBRANE - 5/8" PLYWOOD SHEATHING WITH H-CLIPS ON 2 X 4 OR AS REQUIRED SLEEPERS TO MAINTAIN POSITIVE SLOPE TO GUTTER / DRAIN - ROOF JOISTS AS NOTED ON PLANS, CROSS BRIDGING @ 6'-0" MAX.

PROJECT

14 RIVER ROAD

BRAMPTON, ON L6X 0A6

CLIENT

Owner



REVISIONS

No.	Description	Date
)18	ISSUED FOR COFA	03/14/2024
16	ISSUED FOR COFA	02/14/2024
)15	REISSUED FOR BUILDING PERMIT	02/14/2024
)13	ISSUED FOR BUILDING PERMIT	12/01/2023
)7	ISSUED FOR CLIENT	07/20/2023

Discrepancies must be reported immediately to the Architect before proceeding. Only figured dimensons are to be used. Contractors must check all dimensions on site. This drawing is protected by copyright.

ALL DIMENSIONS ARE SHOWN IN IMPERIAL & METRIC

CONSULTANTS





ORONTO - CANADA 416.546.2040 info@ghsarchitects.co DRAWING TITLE

CONSTRUCTION NOTES

DRAWN	CHECKED
PP	SA
SCALE @ ARCH D	DATE
	07/19/23
CDADUI	CSCALE


GRAPHIC SCALE

PROJECT NO.

200155

STAGE DRAWING NO.

REVISION HALTON HILLS

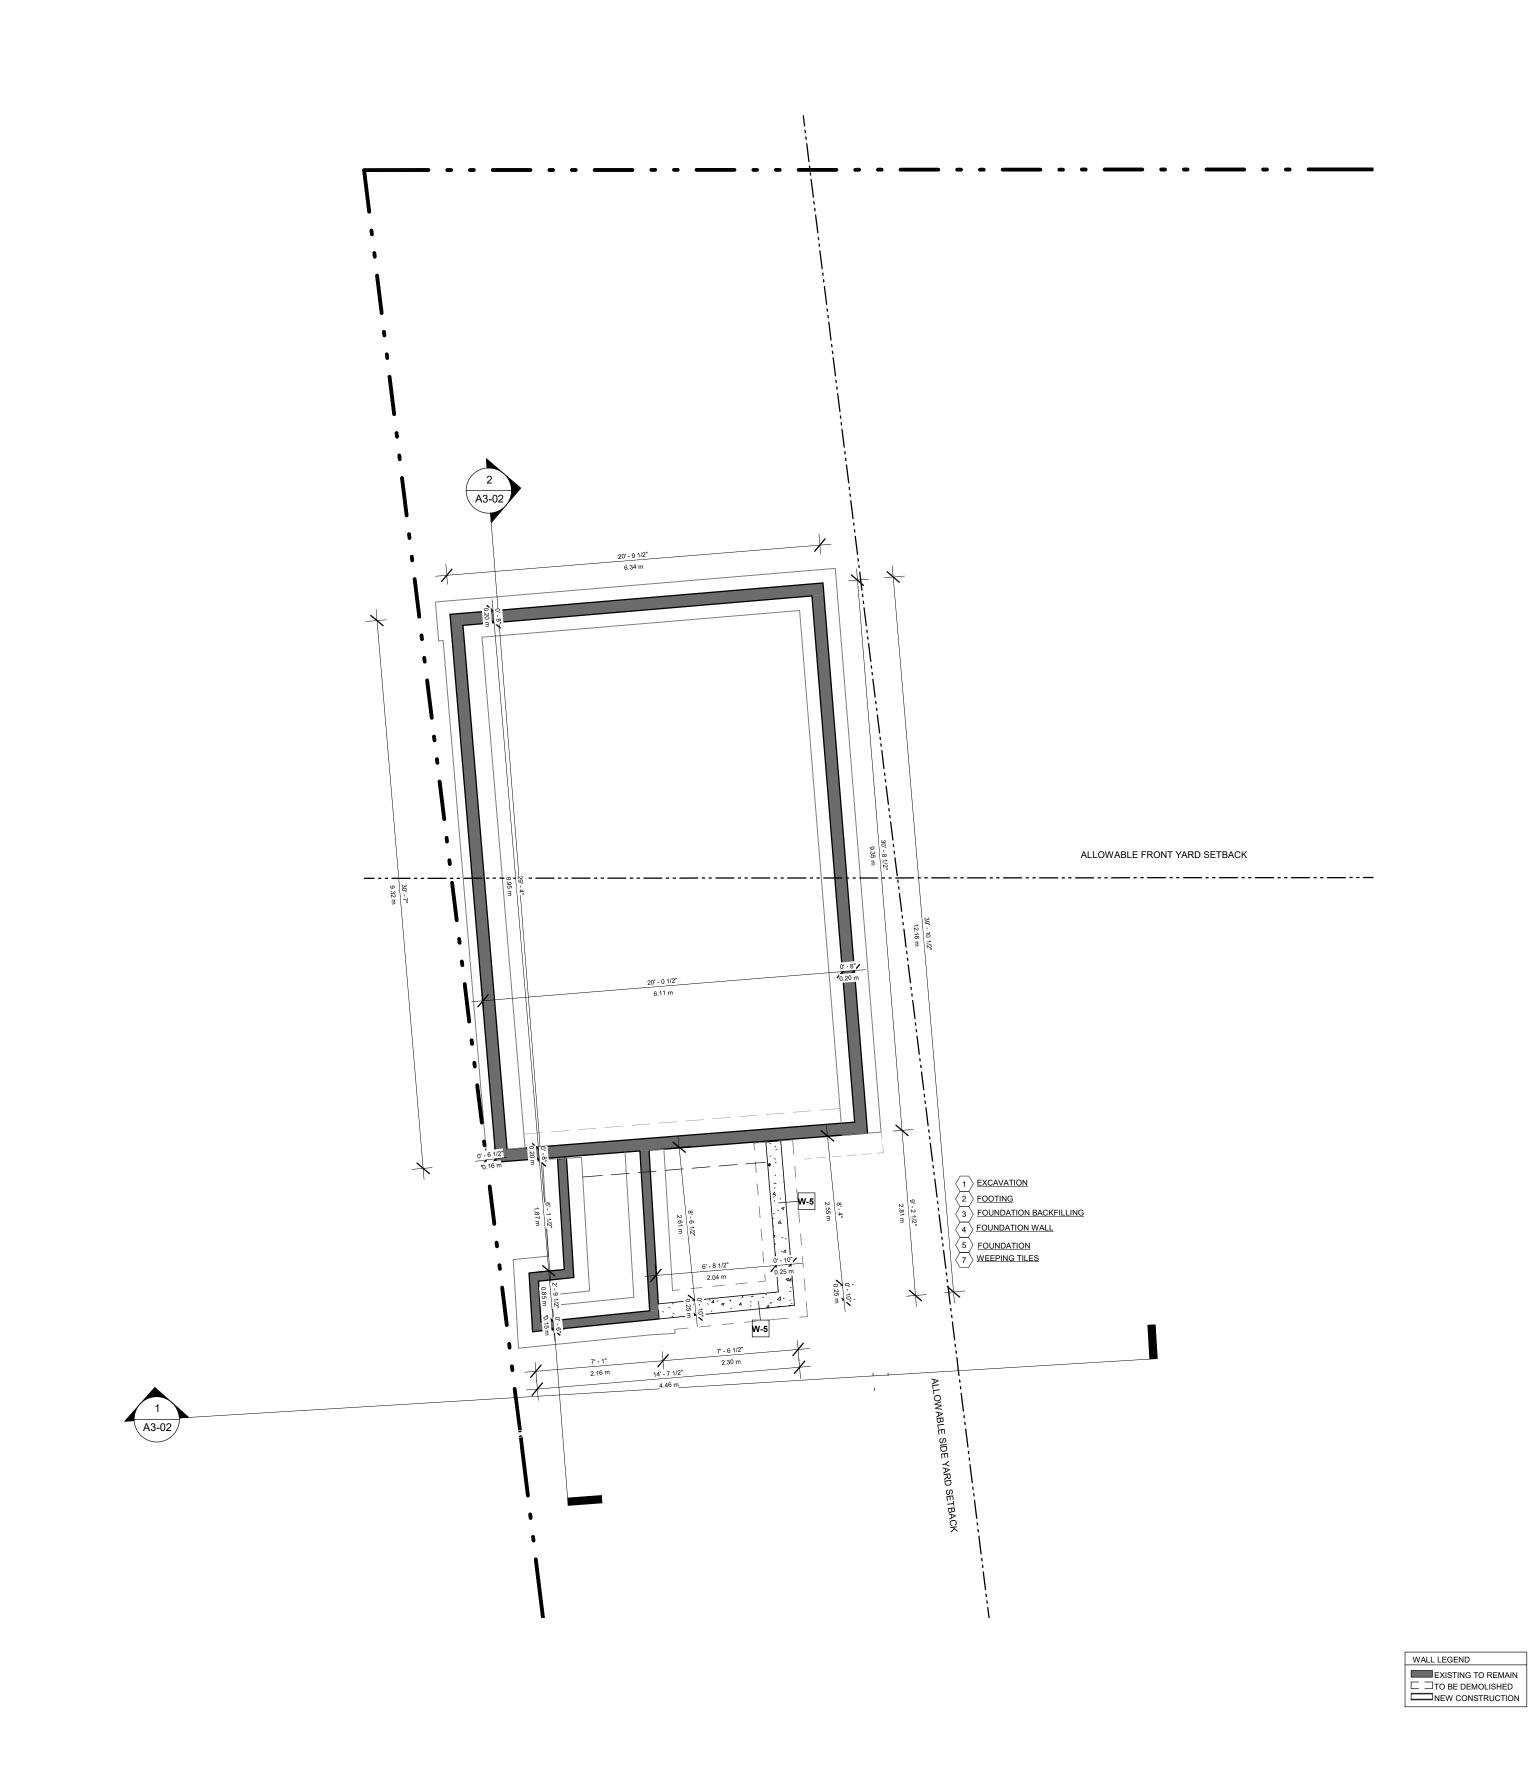

14 RIVER ROAD

BRAMPTON, ON L6X 0A6

CLIENT

Owner



REVISIONS

No.	Description	Date
)18	ISSUED FOR COFA	03/14/2024
)17	REISSUED FOR BUILDING PERMIT	03/07/2024
)14	ISSUED FOR CONSULTANT	12/07/2023
)13	ISSUED FOR BUILDING PERMIT	12/01/2023

Discrepancies must be reported immediately to the Architect before proceeding. Only figured dimensons are to be used. Contractors must check all dimensions on site. This drawing is protected by copyright.

ALL DIMENSIONS ARE SHOWN IN IMPERIAL & METRIC.

CONSULTANTS





TORONTO - CANADA 416.546.2040 info@qbsarchitects.co

DRAWING TITLE

PROP. SECONDARY UNIT FOUNDATION PLAN

DRAWN	CHECKED
PP	SA
SCALE @ ARCH D	DATE
3/16" = 1'-0"	11/28/23

N PN

GIVALTILO GOALL

200155

PROJECT NO.

DRAWING N

DRAWING NO.

COFA A1-05

LOCATION
HALTON HILLS

REVISION 018



14 RIVER ROAD

BRAMPTON, ON L6X 0A6

Owner



REVISIONS

No.	Description	Date
)18	ISSUED FOR COFA	03/14/2024
)17	REISSUED FOR BUILDING PERMIT	03/07/2024
)14	ISSUED FOR CONSULTANT	12/07/2023
)13	ISSUED FOR BUILDING PERMIT	12/01/2023
)12	ISSUED FOR LPG CONSULTANT	11/22/2023
)7	ISSUED FOR CLIENT	07/20/2023
)6	ISSUED FOR BUILDING PERMIT	06/22/2023

Discrepancies must be reported immediately to the Architect before proceeding. Only figured dimensons are to be used. Contractors must check all dimensions on site. This drawing is protected by copyright.

ALL DIMENSIONS ARE SHOWN IN IMPERIAL & METRIC.





TORONTO - CANADA 416.546.2040 info@qbsarchitects.co

PROP. SECONDARY UNIT

GROUND FLOOR PLAN

ı	DRAWN		CHECK	ΞD	
	PP			JB	
l	SCALE @ ARCH D		DATE		
	3/16" = 1'	'-0"		06/02/23	
1					




PROJECT NO.

200155

COFA A1-06

HALTON HILLS

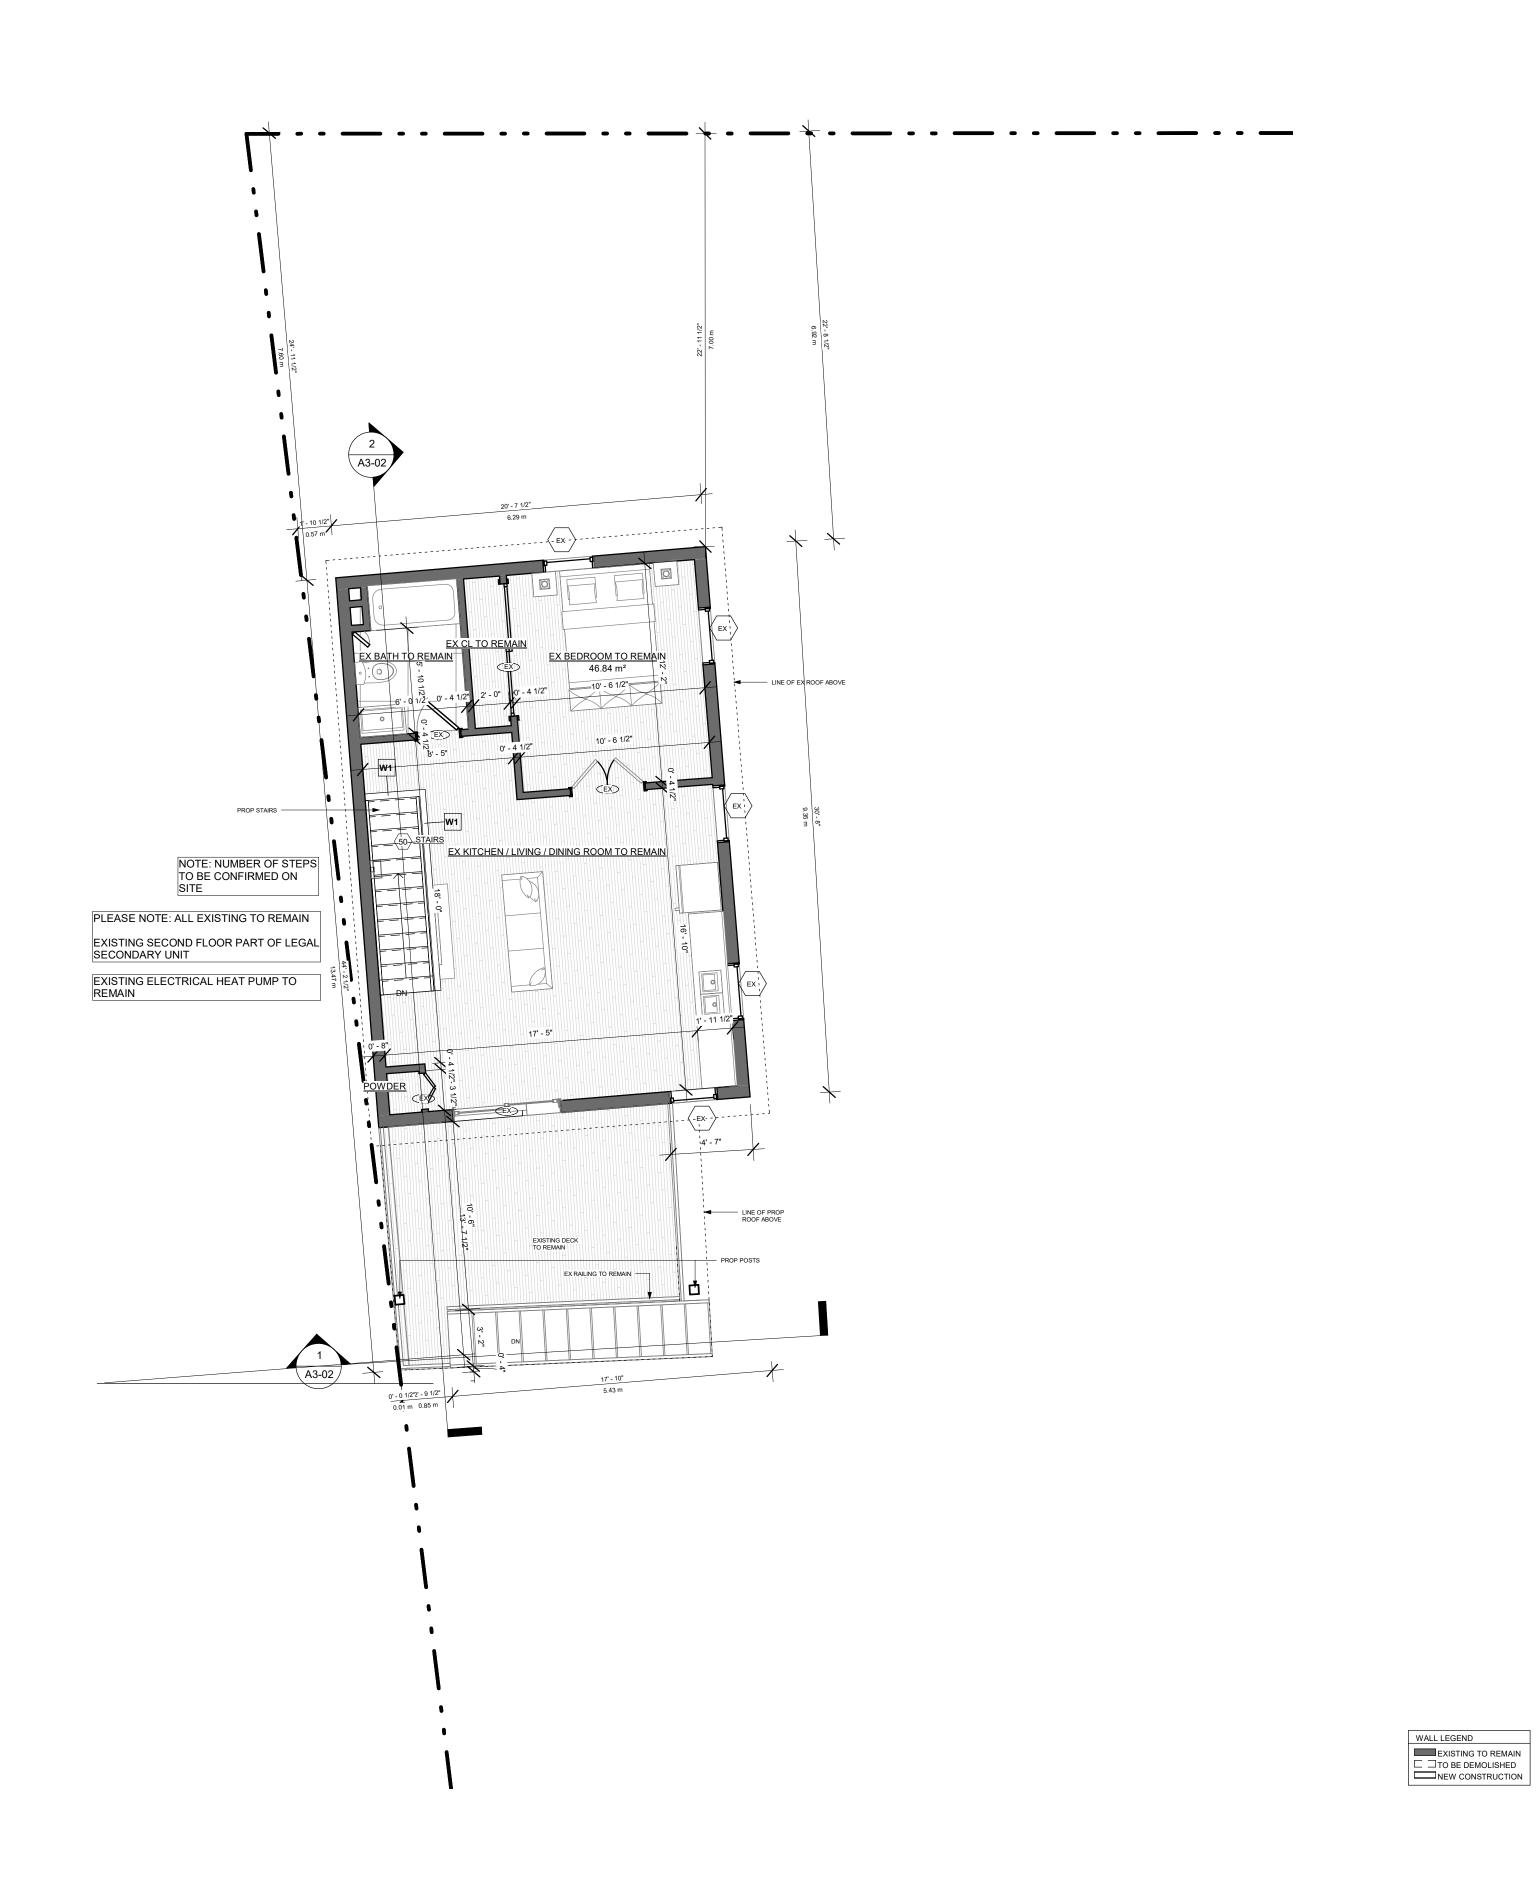

14 RIVER ROAD

BRAMPTON, ON L6X 0A6

CLIENT

Owner



REVISIONS

No.	Description	Date
)18	ISSUED FOR COFA	03/14/2024
)17	REISSUED FOR BUILDING PERMIT	03/07/2024
)14	ISSUED FOR CONSULTANT	12/07/2023
)13	ISSUED FOR BUILDING PERMIT	12/01/2023
)12	ISSUED FOR LPG CONSULTANT	11/22/2023
)7	ISSUED FOR CLIENT	07/20/2023
)6	ISSUED FOR BUILDING PERMIT	06/22/2023

Discrepancies must be reported immediately to the Architect before proceeding. Only figured dimensons are to be used. Contractors must check all dimensions on site. This drawing is protected by copyright.

ALL DIMENSIONS ARE SHOWN IN IMPERIAL & METRIC.

CONSULTANTS





TORONTO - CANADA 416.546.2040 info@qbsarchitects.cc

DRAWING TITLE

PROP. SECONDARY UNIT SECOND FLOOR

DRAWN		CHECKE	D
	PP		JB
SCALE @	ARCH D	DATE	
	3/16" = 1'-0"		06/02/23



GRAPHIC SCALE


PROJECT NO. 200155

STAGE DRAWING

COFA A1-07

LOCATION
HALTON HILLS

^N 018

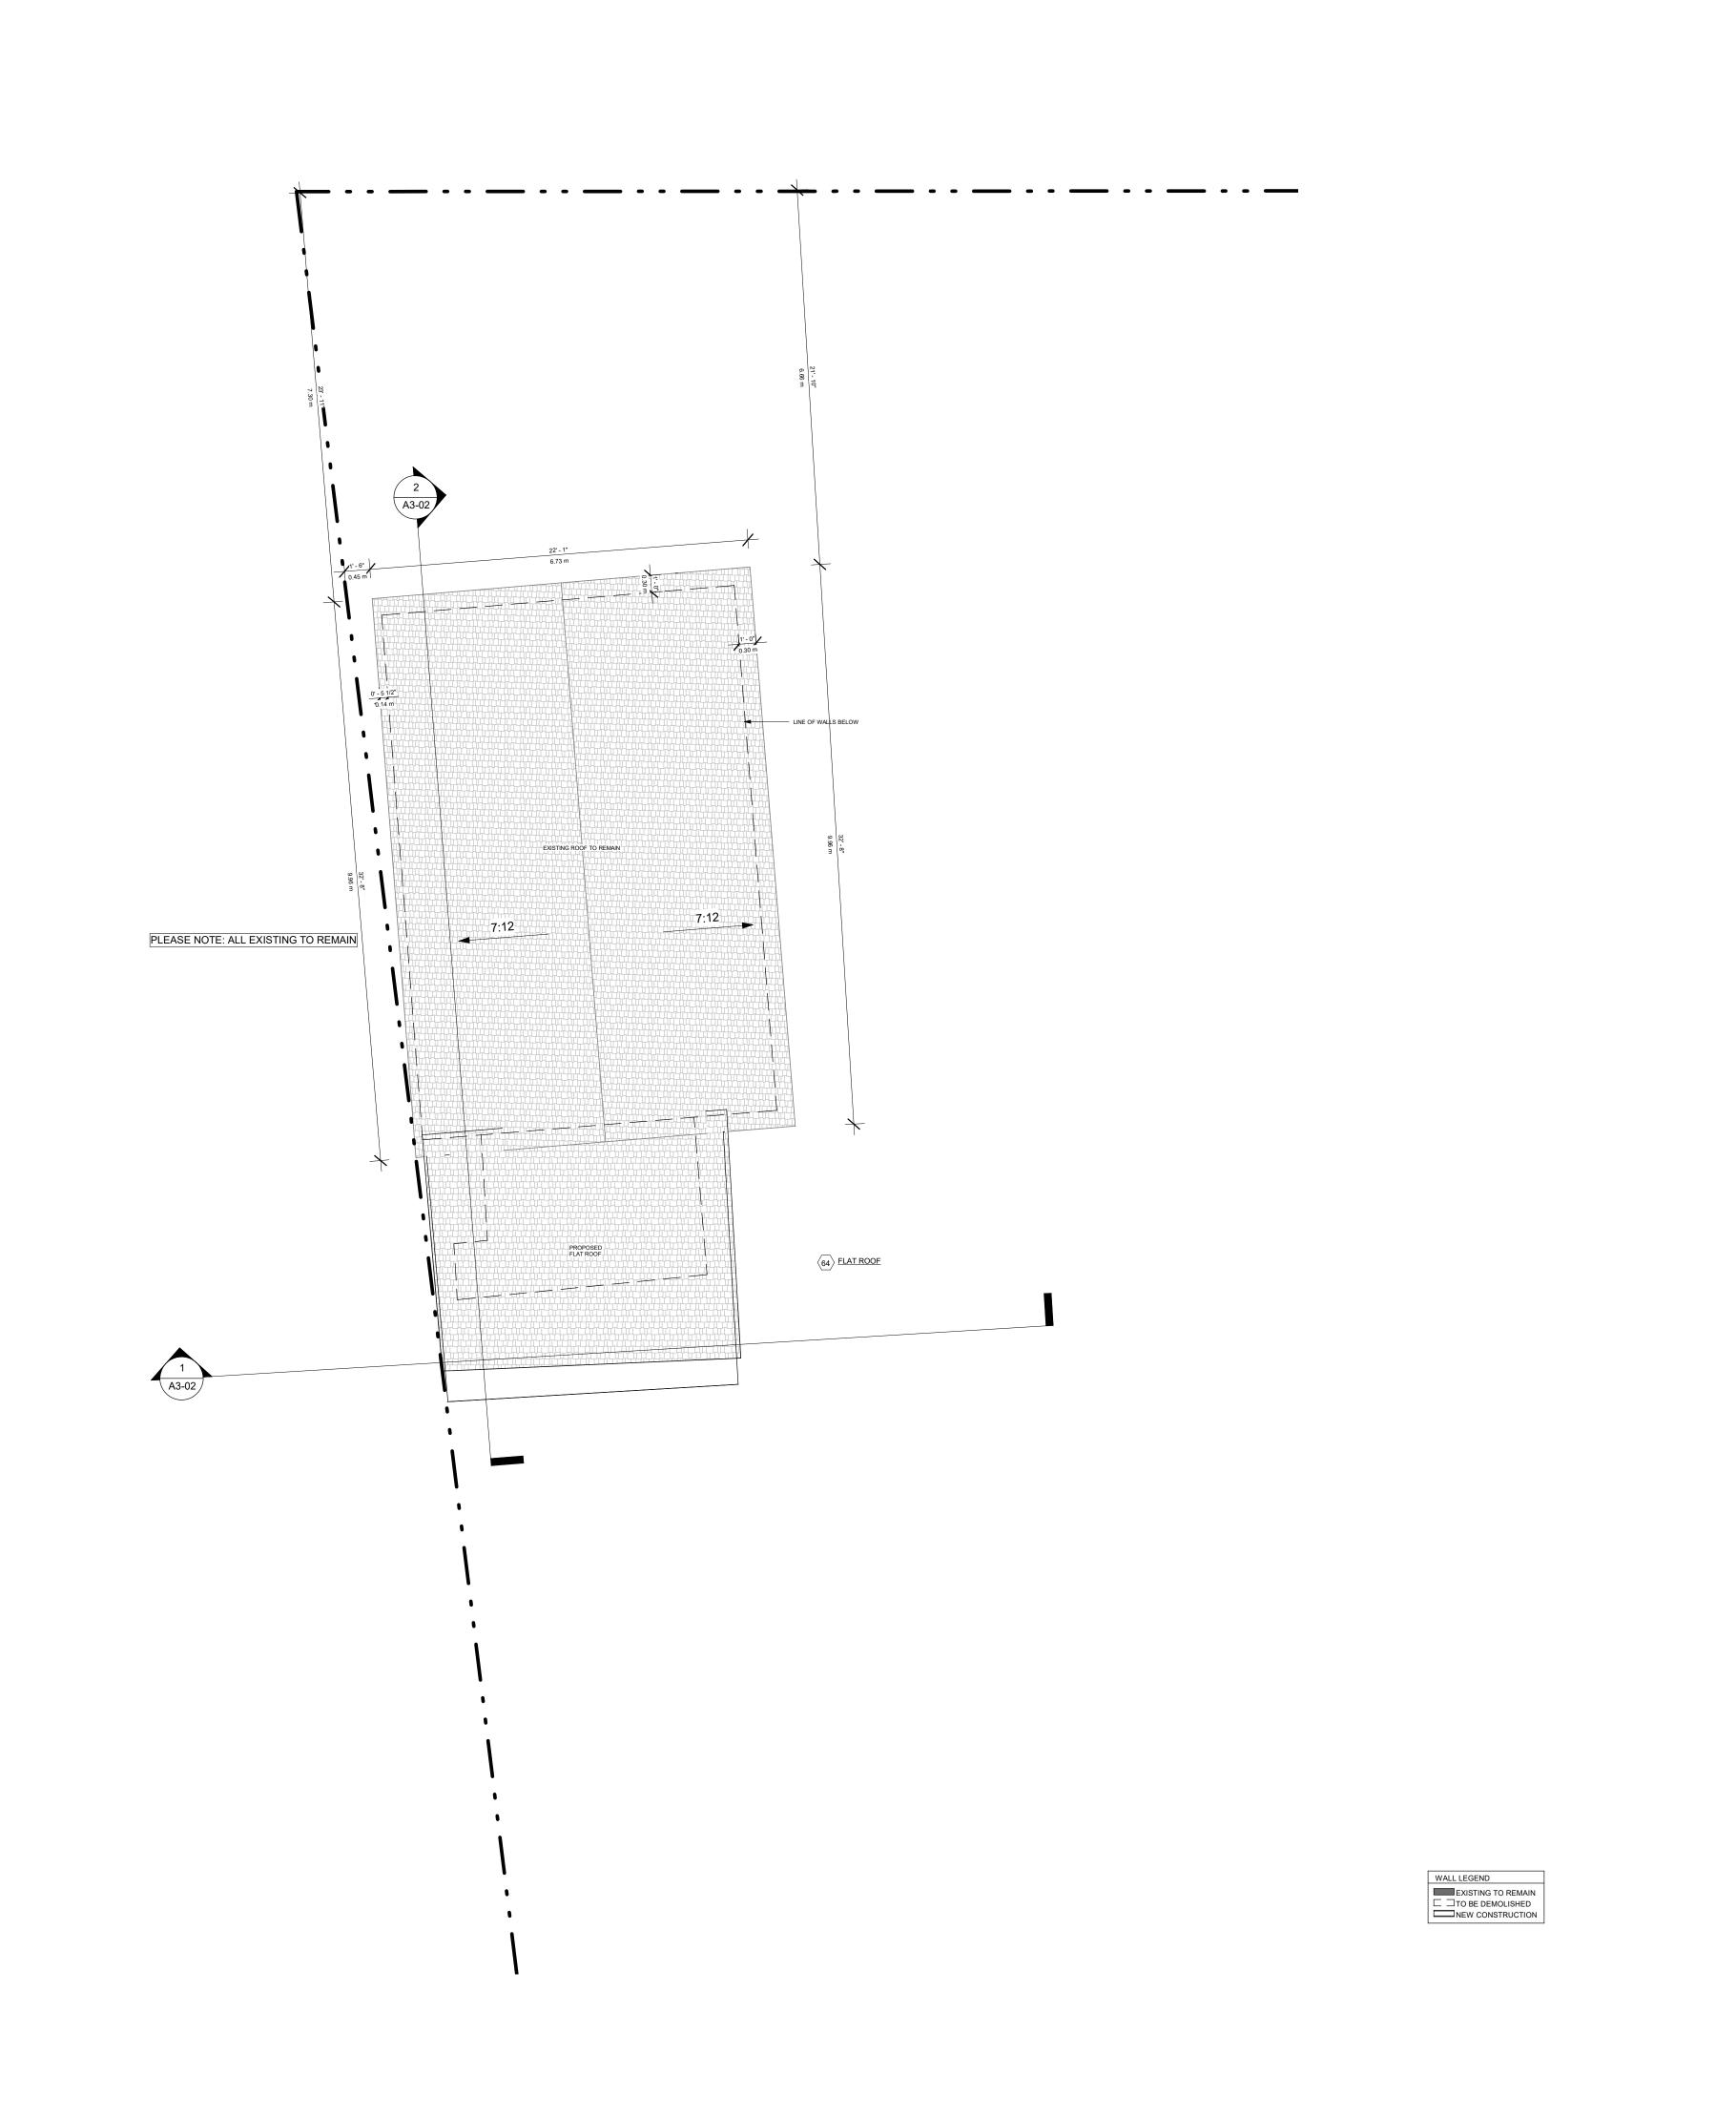

14 RIVER ROAD

BRAMPTON, ON L6X 0A6

Owner



REVISIONS

No.	Description	Date
018	ISSUED FOR COFA	03/14/2024
017	REISSUED FOR BUILDING PERMIT	03/07/2024
014	ISSUED FOR CONSULTANT	12/07/2023
013	ISSUED FOR BUILDING PERMIT	12/01/2023
012	ISSUED FOR LPG CONSULTANT	11/22/2023
07	ISSUED FOR CLIENT	07/20/2023
06	ISSUED FOR BUILDING PERMIT	06/22/2023

Discrepancies must be reported immediately to the Architect before proceeding. Only figured dimensons are to be used. Contractors must check all dimensions on site. This drawing is protected by copyright.

ALL DIMENSIONS ARE SHOWN IN IMPERIAL & METRIC.

CONSULTANTS

PROPOSED FLAT ROOF





TORONTO - CANADA 416.546.2040 info@qbsarchitects.co


PROP. SECONDARY UNIT ROOF PLAN

DRAW	N		CHECK	ED	
	PP			JB	
SCALE	@ ARCH D		DATE		
	3/16" = 1'-	0"		06/05/23	


PROJECT NO. 200155

COFA A1-08

HALTON HILLS

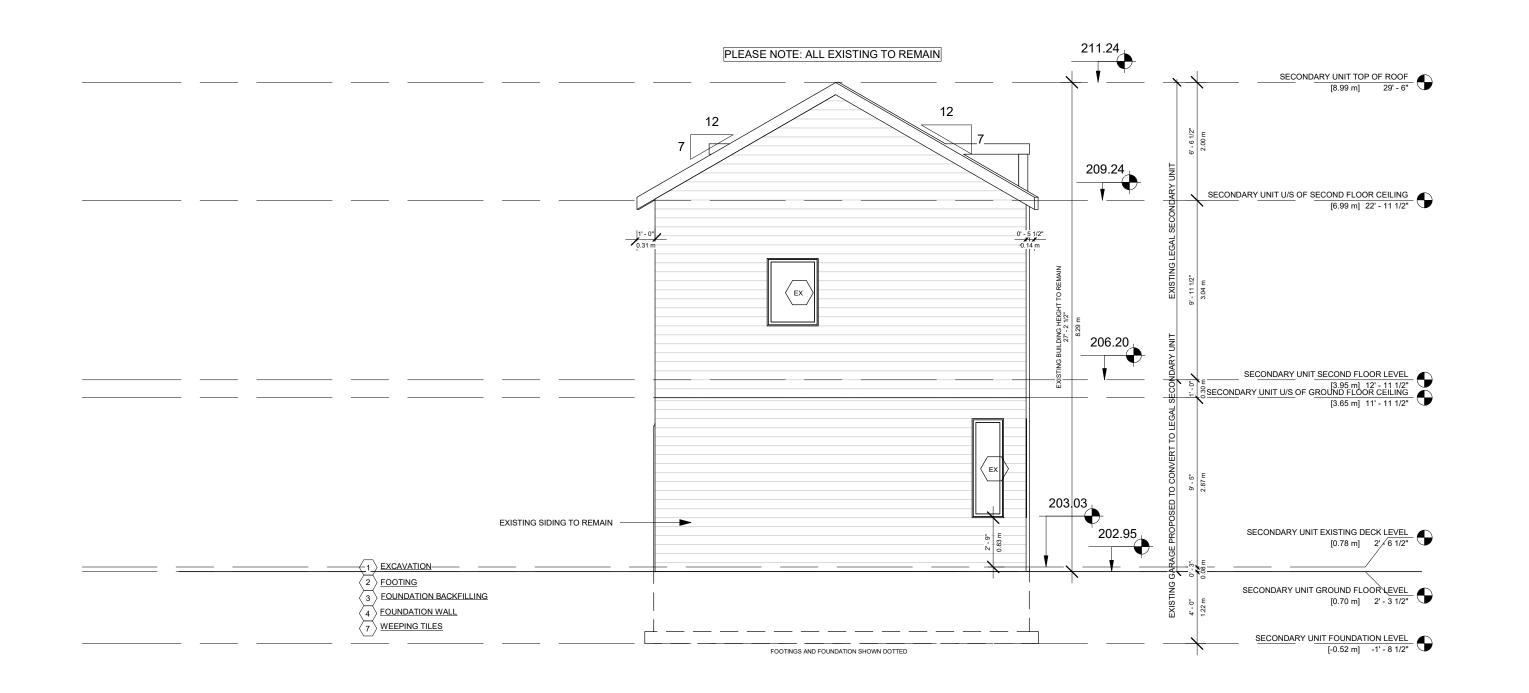

SECONDARY UNIT - FRONT ELEVATION 3/16" = 1'-0"

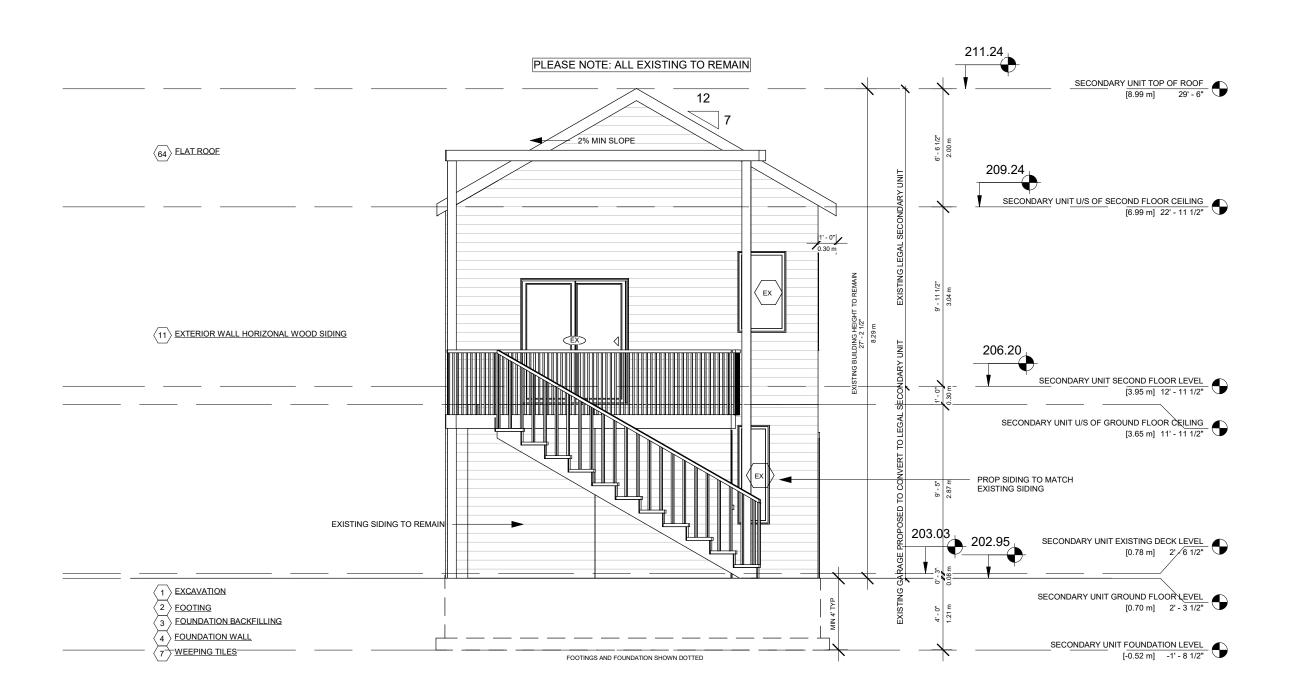

PROJECT

14 RIVER ROAD

BRAMPTON, ON L6X 0A6

CLIENT

Owner



REVISIONS

No.	Description	Date
018	ISSUED FOR COFA	03/14/2024
017	REISSUED FOR BUILDING PERMIT	03/07/2024
013	ISSUED FOR BUILDING PERMIT	12/01/2023
012	ISSUED FOR LPG CONSULTANT	11/22/2023
07	ISSUED FOR CLIENT	07/20/2023
06	ISSUED FOR BUILDING PERMIT	06/22/2023

Discrepancies must be reported immediately to the Architect before proceeding. Only figured dimensons are to be used. Contractors must check all dimensions on site. This drawing is protected by copyright.

ALL DIMENSIONS ARE SHOWN IN IMPERIAL & METRIC

CONSULTANTS





TORONTO - CANADA 416.546.2040 info@qbsarchitects.com

DRAWING TITLE

PROP SECONDARY UNIT FRONT AND REAR ELEVATION

DRAWN	CHECKED
PP	JB
SCALE @ ARCH D	DATE
3/16" = 1'-0"	06/21/23

GRAPHIC SCALE

PROJECT NO. 200155

STAGE DRAWING NO.

COFA A2-03


LOCATION
HALTON HILLS

018

SECONDARY UNIT - REAR ELEVATION

3/16" = 1'-0"



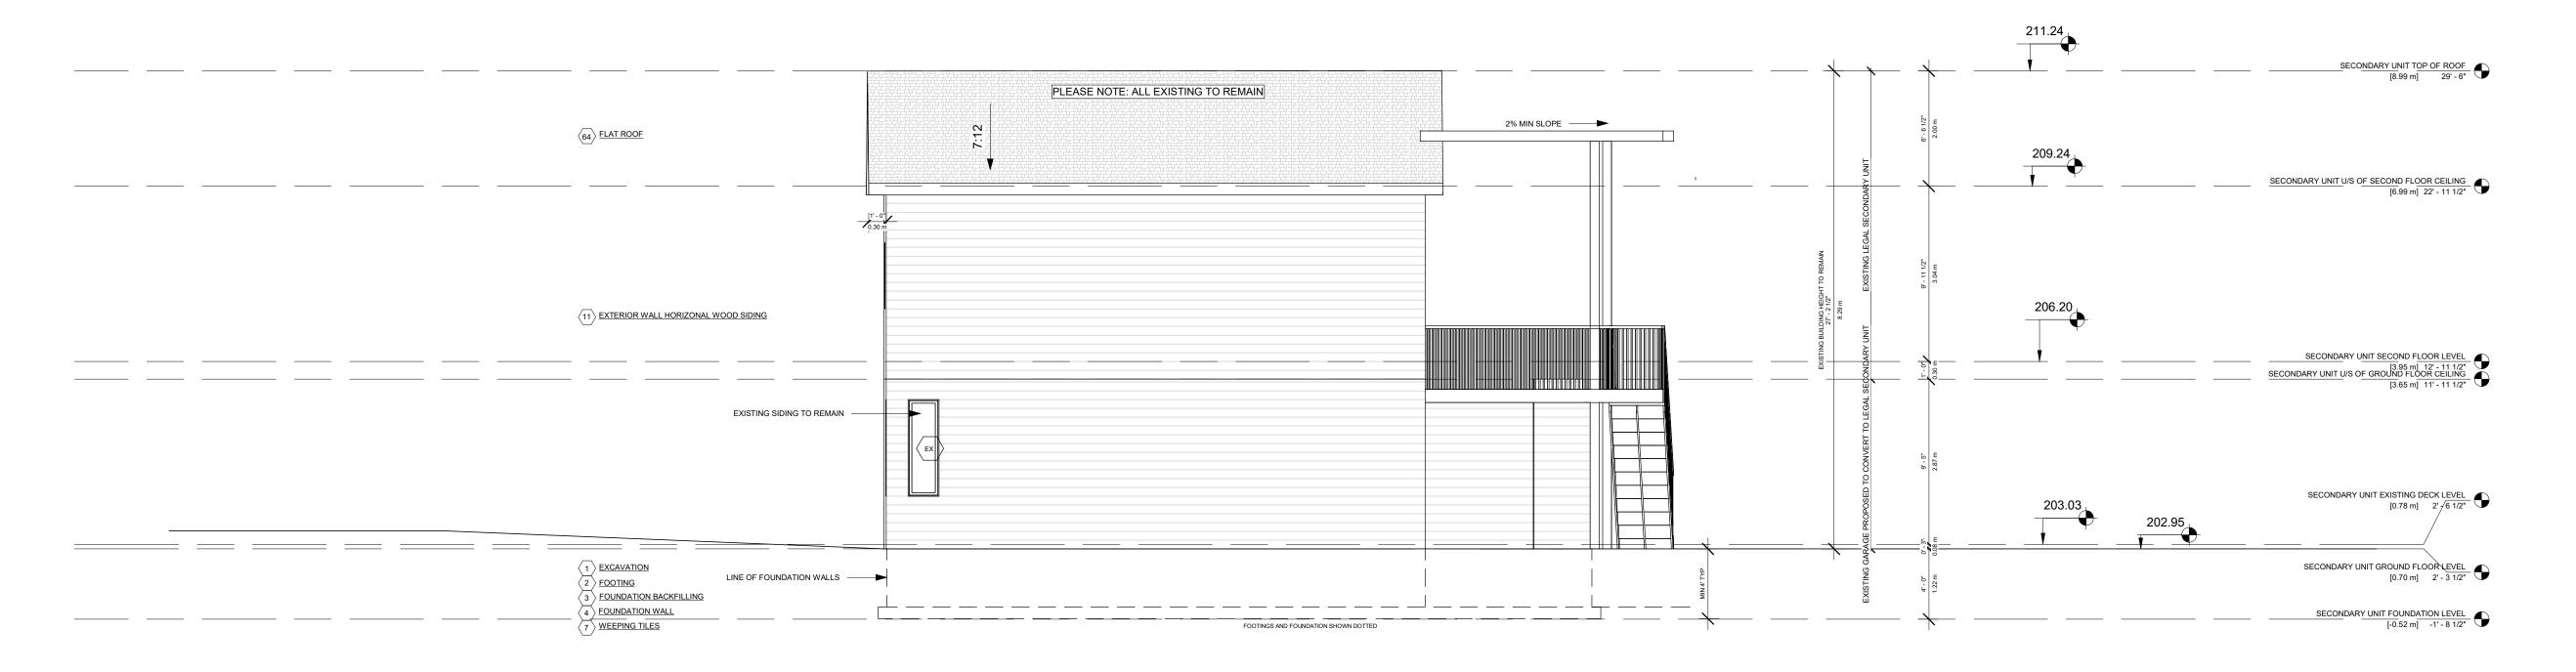

14 RIVER ROAD

BRAMPTON, ON L6X 0A6

CLIENT

Owner



REVISIONS

No.	Description	Date
018	ISSUED FOR COFA	03/14/2024
017	REISSUED FOR BUILDING PERMIT	03/07/2024
013	ISSUED FOR BUILDING PERMIT	12/01/2023
012	ISSUED FOR LPG CONSULTANT	11/22/2023
07	ISSUED FOR CLIENT	07/20/2023
06	ISSUED FOR BUILDING PERMIT	06/22/2023

Discrepancies must be reported immediately to the Architect before proceeding. Only figured dimensons are to be used. Contractors must check all dimensions on site. This drawing is protected by copyright.

ALL DIMENSIONS ARE SHOWN IN IMPERIAL & METRIC

CONSULTANTS





TORONTO - CANADA 416.546.2040 info@qbsarchitects.com

DRAWING TITLE

PROP. SECONDARY UNIT RIGHT AND LEFT ELEVATION

DRAWN		CHECKED	
PP	PP		JB
SCALE @ ARCH D 3/16" = 1'-0"		DATE	06/21/23
	CSCALE		

31V W 1113 337 WEE

PROJECT NO. **200155**


STAGE DRAW

COFA A2-04

LOCATION
HALTON HILLS

018

2 SECONDARY UNIT - LEFT SIDE ELEVATION
3/16" = 1'-0"

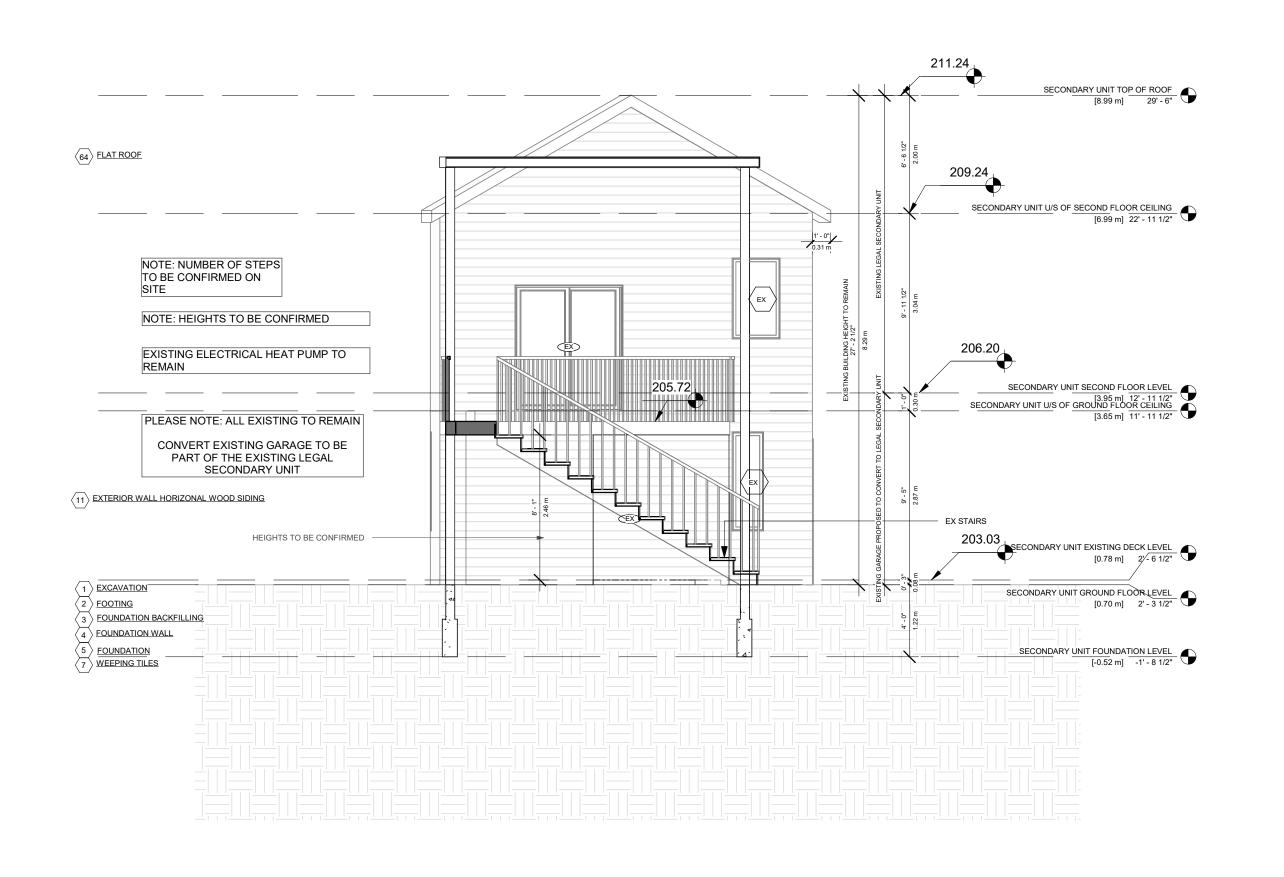



14 RIVER ROAD

BRAMPTON, ON L6X 0A6

CLIENT

Owner



REVISIONS

No.	Description	Date
)18	ISSUED FOR COFA	03/14/2024
)17	REISSUED FOR BUILDING PERMIT	03/07/2024
)13	ISSUED FOR BUILDING PERMIT	12/01/2023
)12	ISSUED FOR LPG CONSULTANT	11/22/2023
)7	ISSUED FOR CLIENT	07/20/2023

Discrepancies must be reported immediately to the Architect before proceeding. Only figured dimensons are to be used. Contractors must check all dimensions on site. This drawing is protected by copyright.

ALL DIMENSIONS ARE SHOWN IN IMPERIAL & METRIC.

CONSULTANTS





TORONTO - CANADA 416.546.2040 info@qbsarchitects.co
DRAWING TITLE

PROP. SECONDARY UNIT SECTION

DRAWN
PP
JB

SCALE @ ARCH D
3/16" = 1'-0"
DATE
07/19/23

GRAPHIC SCALE

PROJECT NO. **200155**


TAGE DRAWING NO.

OEA 42 04

LOCATION RE HALTON HILLS

DOOR SCHEDULE						
Mark	Level	Width	Height	From Room	To Room	Operation
D-001	BASEMENT	5' - 0"	7' - 0"		PROP. REC ROOM	DOUBLE DOOR
D-002	BASEMENT	2' - 6"	6' - 8"	PROP. BATH	EXISTING GYM	SINGLE SWING
D-003	BASEMENT	4' - 8"	7' - 0"	11101.57111	EXISTING GYM	SLIDING DOOR
D-004	BASEMENT	2' - 8"	6' - 8"	COLD ROOM	PROP. REC ROOM	SINGLE SWING
D-005	BASEMENT	2' - 8"	6' - 8"	PROP. REC ROOM	GUEST BEDROOM	SINGLE SWING
D-006	BASEMENT	3' - 4"	7' - 0"	PROP CL	GUEST BEDROOM	DOUBLE DOOR
D-007	BASEMENT	3' - 4"	7' - 0"	PROP CL	GUEST BEDROOM	DOUBLE DOOR
D-008	BASEMENT	3' - 0"	6' - 8"	PROP. REC ROOM	EXISTING GYM	OPENING
D-101	GROUND FLOOR - EXISTING	6' - 0"	8' - 0"	PROP FOYER	2,1311110 01111	DOUBLE DOOR
D-102	GROUND FLOOR - EXISTING	2' - 8"	6' - 8"	PROP FOYER	PROP MUDROOM	SINGLE SWING
D-103	GROUND FLOOR - EXISTING	2' - 6"	6' - 8"	PROP FOYER	PROP BEDROOM	SINGLE SWING
D-104	GROUND FLOOR - EXISTING	2' - 8"	6' - 8"	PROP 2 CAR GARAGE	PROP MUDROOM	SINGLE SWING
D-105	GROUND FLOOR - EXISTING	2' - 6"	6' - 8"	PROP BEDROOM	EX BATH TO REMAIN	SINGLE SWING
D-106	GROUND FLOOR - EXISTING	1' - 9"	6' - 8"	PROP CL	PROP BEDROOM	DOUBLE DOOR
)-107	GROUND FLOOR - EXISTING	5' - 0"	7' - 6"		PROP BEDROOM	SLIDING DOOR
D-108	GROUND FLOOR - EXISTING	2' - 8"	8' - 0"		PROP 2 CAR GARAGE	SINGLE SWING
D-109	GROUND FLOOR - EXISTING	2' - 6"	6' - 8"	PROP FOYER	PROP POWDER	SINGLE SWING
D-110	GROUND FLOOR - EXISTING	2' - 6"	6' - 8"	PROP CL	PROP FOYER	DOUBLE DOOR
D-111	GROUND FLOOR - EXISTING	2' - 6"	6' - 8"	PROP CL	PROP FOYER	DOUBLE DOOR
D-112	GROUND FLOOR - EXISTING	3' - 0"	6' - 8"	PROP FOYER	PROP KITCHEN	OPENING
D-113	GROUND FLOOR - EXISTING	2' - 8"	6' - 8"	PROP LIVING AND DINING	PROP KITCHEN	SINGLE SWING
D-114	GROUND FLOOR - EXISTING	3' - 6"	8' - 0"	THE ENTRY WE BITTING	PROP KITCHEN	SINGLE SWING
D-115	PROPOSED GARAGE	8' - 0"	8' - 0"		PROP 2 CAR GARAGE	ROLL UP
D-116	PROPOSED GARAGE	8' - 0"	8' - 0"		PROP 2 CAR GARAGE	ROLL UP
0-201	SECONDARY UNIT GROUND FLOOR LEVEL	2' - 8"	8' - 0"		PROP LAUNDRY	
D-202	SECOND FLOOR - EXISTING	2' - 10"	6' - 8"	PROP CL	EX BEDROOM TO BE ENLARGED	DOUBLE DOOR
D-203	SECOND FLOOR - EXISTING	2' - 6"	6' - 8"	PROP CORRIDOR	EX BEDROOM TO BE ENLARGED	SINGLE SWING
0-204	SECOND FLOOR - EXISTING	2' - 8"	6' - 8"	PROP CORRIDOR	PROPOSED BEDROOM #3	SINGLE SWING
D-205	SECOND FLOOR - EXISTING	2' - 6"	6' - 8"	PROPOSED BEDROOM #3	W.I.C #3	SINGLE SWING
0-206	SECOND FLOOR - EXISTING	2' - 6"	6' - 8"		PROPOSED BEDROOM #3	SINGLE SWING
0-207	SECOND FLOOR - EXISTING	2' - 8"	6' - 8"	PROP CORRIDOR	LAUNDRY	SINGLE SWING
D-208	SECOND FLOOR - EXISTING	2' - 8"	6' - 8"	PROP CORRIDOR	PROPOSED BEDROOM #2	SINGLE SWING
D-209	SECOND FLOOR - EXISTING	2' - 6"	6' - 8"	PROPOSED BEDROOM #2	W.I.C #2	POCKET
D-210	SECOND FLOOR - EXISTING	2' - 6"	6' - 8"	BATH #2	PROPOSED BEDROOM #2	POCKET
D-211	SECOND FLOOR - EXISTING	2' - 8"	7' - 6"			SINGLE SWING
D-212	SECOND FLOOR - EXISTING	5' - 0"	7' - 6"		PROPOSED BEDROOM #3	SLIDING DOOR

Mark	Level	Sill Height	Height	Width	From Room: Name
		<u> </u>	<u> </u>		
W-001	BASEMENT	2' - 0"	5' - 0"	4' - 0"	PROP. REC ROOM
W-002	BASEMENT	5' - 6"	2' - 0"	4' - 0"	GUEST BEDROOM
W-101	GROUND FLOOR - EXISTING	2' - 0"	5' - 0"	4' - 0"	PROP LIVING AND DINING
W-102	GROUND FLOOR - EXISTING	2' - 0"	5' - 0"	2' - 0"	PROP LIVING AND DINING
W-103	GROUND FLOOR - EXISTING	2' - 0"	5' - 0"	2' - 0"	PROP LIVING AND DINING
W-104	GROUND FLOOR - EXISTING	2' - 0"	5' - 0"	2' - 0"	PROP LIVING AND DINING
W-105	GROUND FLOOR - EXISTING	2' - 0"	5' - 0"	2' - 0"	PROP LIVING AND DINING
W-106	GROUND FLOOR - EXISTING	2' - 0"	5' - 0"	2' - 0"	PROP LIVING AND DINING
W-107	GROUND FLOOR - EXISTING	2' - 0"	5' - 0"	2' - 0"	PROP LIVING AND DINING
W-108	GROUND FLOOR - EXISTING	2' - 0"	5' - 0"	6' - 0"	PROP LIVING AND DINING
W-109	GROUND FLOOR - EXISTING	7' - 5 1/2"	5' - 0"	3' - 0"	PROP FOYER
W-110	GROUND FLOOR - EXISTING	2' - 0"	5' - 0"	2' - 0"	PROP 2 CAR GARAGE
W-111	GROUND FLOOR - EXISTING	2' - 6"	5' - 0"	2' - 0"	PROP BEDROOM
W-112	GROUND FLOOR - EXISTING	0' - 0"	8' - 0"	2' - 0"	PROP KITCHEN
W-113	GROUND FLOOR - EXISTING	2' - 0"	5' - 0"	6' - 0"	PROP 2 CAR GARAGE
W-114	GROUND FLOOR - EXISTING	7' - 0"	1' - 6"	10' - 0"	PROP LIVING AND DINING
W-115	GROUND FLOOR - EXISTING	2' - 4 1/2"	5' - 0"	3' - 0"	PROP FOYER
W-116	GROUND FLOOR - EXISTING	7' - 0"	1' - 6"	10' - 0"	PROP 2 CAR GARAGE
W-117	GROUND FLOOR - EXISTING	7' - 0"	1' - 6"	2' - 0"	PROP LIVING AND DINING
W-118	GROUND FLOOR - EXISTING	7' - 0"	1' - 6"	2' - 0"	PROP LIVING AND DINING
W-119	GROUND FLOOR - EXISTING	7' - 0"	1' - 6"	2' - 0"	PROP LIVING AND DINING
W-120	GROUND FLOOR - EXISTING	7' - 0"	1' - 6"	2' - 0"	PROP LIVING AND DINING
W-121	GROUND FLOOR - EXISTING	7' - 0"	1' - 6"	2' - 0"	PROP LIVING AND DINING
W-122	GROUND FLOOR - EXISTING	7' - 0"	1' - 6"	2' - 0"	PROP LIVING AND DINING
W-123	GROUND FLOOR - EXISTING	7' - 0"	1' - 6"	4' - 0"	EX BEDROOM TO BE ENLARGE
W-124	GROUND FLOOR - EXISTING	7' - 0"	1' - 6"	2' - 0"	PROP 2 CAR GARAGE
W-125	GROUND FLOOR - EXISTING	0' - 8"	5' - 0"	3' - 11"	EX DINING
W-126	GROUND FLOOR - EXISTING	0' - 8"	5' - 0"	3' - 11"	EX DINING
W-201	SECOND FLOOR - EXISTING	2' - 6"	5' - 0"	4' - 0"	EX BEDROOM TO BE ENLARGE
W-202	SECOND FLOOR - EXISTING	2' - 6"	5' - 0"	2' - 0"	EX BEDROOM TO BE ENLARGE
W-203	SECOND FLOOR - EXISTING	2' - 6"	5' - 0"	2' - 0"	EX BEDROOM TO BE ENLARGE
W-204	SECOND FLOOR - EXISTING	2' - 6"	5' - 0"	2' - 0"	EX BEDROOM TO BE ENLARGE
W-205	SECOND FLOOR - EXISTING	2' - 6"	5' - 0"	2' - 0"	EX BEDROOM TO BE ENLARGE
W-206	SECOND FLOOR - EXISTING	2' - 6"	5' - 0"	2' - 0"	EX BEDROOM TO BE ENLARGE
W-207	SECOND FLOOR - EXISTING	2' - 6"	5' - 0"	2' - 0"	EX BEDROOM TO BE ENLARGE
W-208	SECOND FLOOR - EXISTING	2' - 6"	5' - 0"	6' - 0"	EX BEDROOM TO BE ENLARGE
W-209	SECOND FLOOR - EXISTING	2' - 6"	5' - 0"	3' - 0"	PROP HALL
W-210	SECOND FLOOR - EXISTING	2' - 6"	5' - 0"	2' - 0"	OPEN TO BELOW -PROP FOYE
W-211	SECOND FLOOR - EXISTING	2' - 6"	5' - 0"	2' - 0"	PROPOSED BEDROOM #2
W-212	SECOND FLOOR - EXISTING	2' - 6"	5' - 0"	6' - 0"	PROPOSED BEDROOM #2
W-213	SECOND FLOOR - EXISTING	2' - 6"	5' - 0"	2' - 0"	W.I.C #2
W-214	SECOND FLOOR - EXISTING	2' - 6"	5' - 0"	2' - 0"	BATH #2
	SECOND FLOOR - EXISTING	2' - 6"	5' - 0"	2' - 0"	BATH #2
	SECOND FLOOR - EXISTING	2' - 6"	5' - 0"	6' - 0"	PROPOSED BEDROOM #2
	SECOND FLOOR - EXISTING	2' - 6"	5' - 0"	2' - 0"	PROPOSED BEDROOM #2
	SECOND FLOOR - EXISTING	2' - 6"	5' - 0"	2' - 0"	PROPOSED BEDROOM #2
	SECOND FLOOR - EXISTING	2' - 6"	5' - 0"	2' - 0"	
	SECOND FLOOR - EXISTING	2' - 6"	5' - 0"	2' - 0"	
	SECOND FLOOR - EXISTING	2' - 6"	5' - 0"	2' - 0"	PROPOSED BEDROOM #3
	SECOND FLOOR - EXISTING	2' - 6"	5' - 0"	2' - 0"	PROPOSED BEDROOM #3
	SECONDARY UNIT GROUND FLOOR LEVEL	4' - 0"	4' - 0"	3' - 0"	PROP LAUNDRY

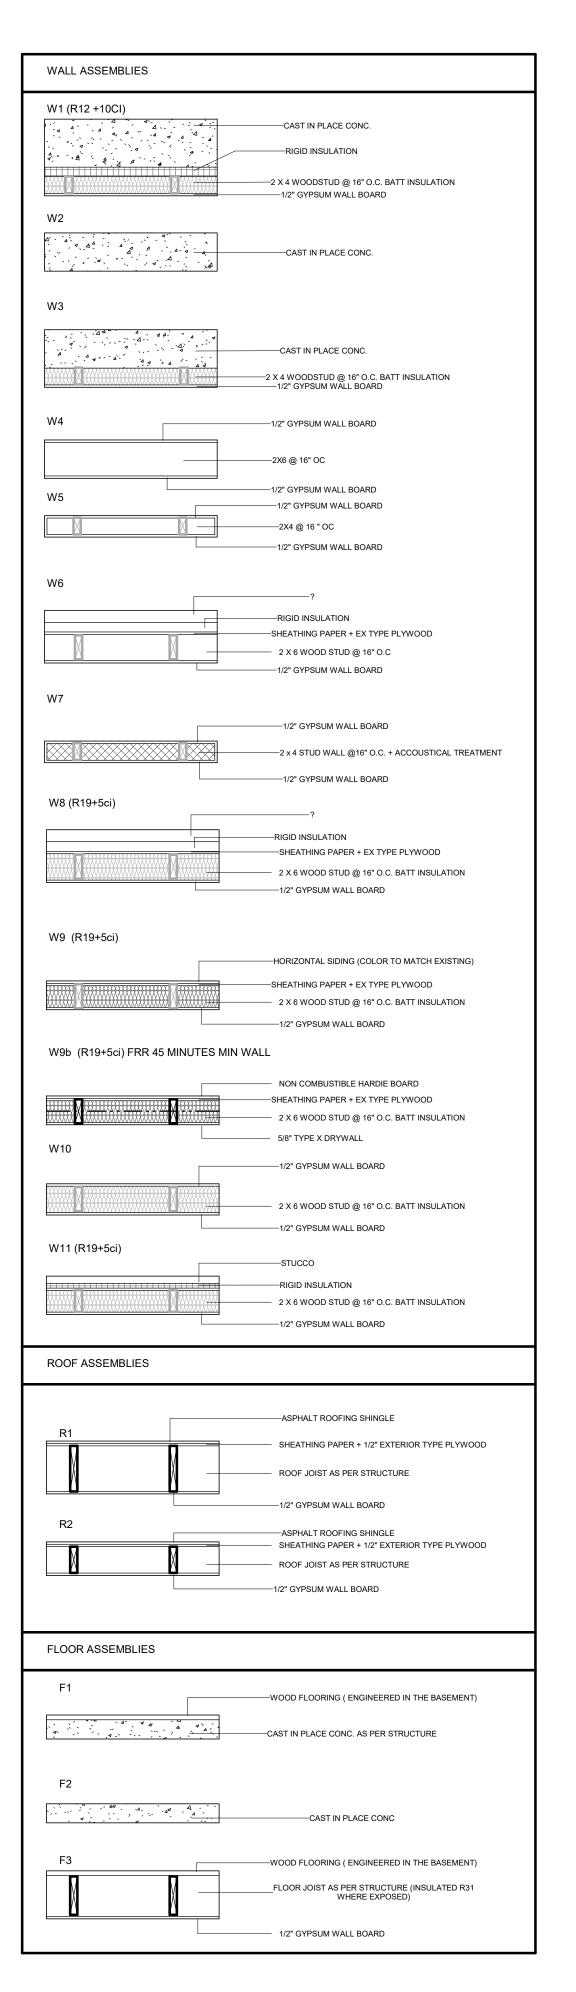

ASSEMBLIES

1:20

PROJECT

14 RIVER ROAD

BRAMPTON, ON L6X 0A6

CLIENT

Owner



REVISIONS

No.	Description	Date
018	ISSUED FOR COFA	03/14/2024
017	REISSUED FOR BUILDING PERMIT	03/07/2024
016	ISSUED FOR COFA	02/14/2024
015	REISSUED FOR BUILDING PERMIT	02/14/2024
013	ISSUED FOR BUILDING PERMIT	12/01/2023

Discrepancies must be reported immediately to the Architect before proceeding. Only figured dimensons are to be used. Contractors must check all dimensions on site. This drawing is protected by copyright.

ALL DIMENSIONS ARE SHOWN IN IMPERIAL & METRIC.

CONSULTANTS





TORONTO - CANADA 416.546.2040 info@qbsarchitects.com

DRAWING TITLE

DOOR WINDOW SCHEDULE & WALL ASSEMBLIES

DRAWN	CHECKED	
PP	SA	
SCALE @ ARCH D	DATE	
1 : 20	11/23/23	
GRAPHIC SCALE		

31V W 1113 337 WEE

PROJECT NO.

200155

STAGE DRAWING NO.

COFA A4-01

HALTON HILLS