# HERITAGE IMPACT ASSESSMENT













LORNE SCOTS REGIMENTAL MUSEUM (FORMER CARNEGIE LIBRARY) 55 QUEEN STREET EAST, BRAMPTON

ACCESSIBILITY UPGRADES\_11 SEP 2024

MEGAN HOBSON CAHP M.A. DIPL. HERITAGE CONSERVATION Built Heritage Consultant mhobson@bell.net

### TABLE OF CONTENTS

### **EXECUTIVE SUMMARY**

1.0	INTRODUCTION	2
2.0	LOCATION & SITE DESCRIPTION	2
3.0	HERITAGE PLANNING CONTEXT	3
4.0	CULTURAL HERITAGE VALUE	3
5.0	PROPOSED ALTERATIONS	5
6.0	HERITAGE IMPACT ASSESSMENT	7
7.0	RECOMMENDATIONS	9
8.0	SOURCES	11
9.0	QUALIFICATIONS OF THE AUTHOR	11
10.0	APPENDICES	ATTACHED

APPENDIX A: PHOTO DOCUMENTATION
APPENDIX B: HISTORIC DOCUMENTATION
APPENDIX C: DESIGNATION BY-LAW NO. 9-82

APPENDIX D: ARCHITECTURAL DRAWINGS (LEBEL & BOULIANE)

### **EXECUTIVE SUMMARY**

Hobson Heritage Consulting was retained by the City of Brampton to provide a *Heritage Impact Assessment* (HIA) for proposed accessibility upgrades to the former Brampton Carnegie Library at 55 Queen Street East. The subject property is a City-owned Designated heritage building that is currently occupied by the Lorne Scots Regimental Museum.

The proposed accessibility upgrades include the following:

- construction of an exterior wheelchair ramp at the front entrance on Queen Street
- interior alterations to the stairs inside the front entrance to accommodate a wheelchair lift
- interior alterations to an existing washroom on the lower level to create a barrier free washroom

Accessibility upgrades are beneficial because they support continued use of the heritage building as a public building. The building was constructed in 1907 and has a raised foundation. Existing access to the building through the main entrance on Queen Street therefore presents accessibility challenges including exterior steps up to the front door and interior stairs inside the entrance vestibule up to the main floor where the exhibition space is and down to the lower level where the washrooms are.

The impacts are identified as:

- impacts to the roots of existing trees on the Queen Street frontage from the foundations of the wheelchair ramp
- impacts to the left side of the entry steps where the proposed wheelchair ramp will connect with the existing stairs and landing
- impacts to the stairs inside the entrance vestibule and glazed partition wall at the top of the stairs

Appropriate mitigation strategies have been proposed to minimize adverse impacts including:

- a tree protection zone has been determined and below-grade disturbances in this area will be limited by using helical piles for the wheelchair ramp foundation
- the oak railings and newel posts that must be removed to accommodate the passenger lift will be salvaged and reused on the rebuilt stairs
- the glazed partition wall that must be removed to accommodate the passenger lift will be partially replicated to match the existing

Therefore, it is recommended that the Heritage Permit Application be approved, subject to the following conditions:

- that the architect provides detailed drawings & specifications for the replicated glazed partition wall and wheelchair ramp railings to heritage staff for final review, prior to the issue of building permits
- 2. that the architect and/or heritage consultant monitors demolition and construction work to ensure that original features are preserved wherever possible and that all new work is compatible and completed to the same high standard as the existing
- 3. that the arborist monitors tree protection during construction of the wheelchair ramp

### 1.0 INTRODUCTION

Preparation of this report included site investigation carried out by Lebel & Boulaine, a review of relevant heritage policies and applicable legislation, historical research, and consultation with heritage staff at the City of Brampton. Research assistance was provided by Nick Moreau, Archivist at the Region of Peel Archives.

### 2.0 LOCATION & SITE DESCRIPTION



FRONT ENTRANCE ON QUEEN STREET - accessibility upgrades are proposed for the main entrance to the building

The subject property is situated in Downtown Brampton at the corner of Queen Street East and Chapel Street. The subject building is the former Brampton Carnegie Library that has been adaptively reused as a City-owned facility. The main floor of the building has recently opened to the public as the new location of the Lorne Scots Regimental Museum.





LORNE SCOTS REGIMENTAL MUSEUM – relocated to the Old Library in May 2024

### 3.0 HERITAGE PLANNING CONTEXT

The subject property was Designated under Part IV of the *Ontario Heritage Act* in 1982 for its architectural and historical significance as the former Brampton Carnegie Library. It was designed by Wickson & Gregg Architects in 1906 and constructed in 1907.

The Designation By-law is attached as an appendix to this report. Typical of some older by-laws enacted prior to the 2005 changes to the Ontario Heritage Act, it has a very brief Statement of Significance and does not have a list of heritage attributes. For the purposes of this Heritage Impact Assessment, potential heritage attributes are understood to be original exterior and interior features.

In 2013, Steven Burgess Architects prepared a *Conservation Plan* for the building. The report recommended minor repairs be carried out over the next five years. A *Heritage Permit* was issued in 2017 and the recommended conservation work appears to have been undertaken. The building appears to be in very good condition.

The subject building is adjacent to the Old Brampton Fire Hall and Armouries. This cluster of built heritage resources occupies a prominent corner and is adjacent to the Brampton Public Library.





CORNER OF QUEEN STREET & CHAPEL STREET – Old Carnegie Library, Fire Hall & Armouries

### 4.0 CULTURAL HERITAGE VALUE

The subject property is the former Brampton Carnegie Library constructed in 1906-07 in a Beaux-Arts style. It was designed by prominent Toronto architects Wickson & Gregg and funded by the Carnegie Foundation. The Carnegie foundation was established by the American businessman and philanthropist Andrew Carnegie and provided funds for construction of 111 public libraries across Ontario in the early 20<sup>th</sup> century. Wickson & Gregg designed three Carnegie Libraries in Ontario in Paris, Brampton, and Toronto (with Alfred Chapman).<sup>1</sup>

In the 1930s an addition was built on the east side of the library in a similar style. In 1974 a new public library was built next door and the Old Library was closed and the building re-purposed for municipal uses. Since 1974 it has housed several different non-profit organizations. The interior, except for the front entrance vestibule, has been extensively altered. The exterior is well preserved.

<sup>&</sup>lt;sup>1</sup> Robert Hill, entry for Alfred Frank Wickson in the Biographical Dictionary of Architects in Canada 1800-1950.





HISTORIC PHOTOS SHOWING THE ORIGINAL EXTERIOR AND INTERIOR – exterior features remain intact but the interior has been extensively altered. The glazed partition wall visible in the 1911 photo of the interior remains and will be impacted by the proposed changes. [Region of Peel Archives]

The reasons for Designation statement included in the Designation By-law is provided below:

### REASONS FOR DESIGNATION

Built in 1906, this building was constructed in the Beaux Arts style, similar to its sibling in Toronto. This style exhibits classical features such as a rusticated basement level, constructed of large stone. A main living storey which is constructed of bricks is divided above by a running frieze, creating the appearance of a third level, or attic. These three divisions are traditional and it is intriguing to see the practice carried out on a small scale. The most interesting feature is the main entrance which illustrates the

architectural plasticity of the Beaux Arts style. Brick simulated pilasters create a porch-like entrance area. It is topped with a circular arch, than branches from the running frieze. But ironically it recedes back instead of projecting forward as most pediments do. Large windows framed with "basket-handle" arches adequately light the reading areas. The slanting Mansard roof is of a French origin. The Old Carnegie Library is a rare example of the short lived Beaux Art Style in Brampton.

### Heritage Attributes referenced in the 1982 Designation By-law:

- Beaux-Arts Classical details
- brick exterior walls including the running frieze and attic
- rusticated stone foundation
- main entrance including the brick pilasters, portico, circular arch, running freize, recessed pediment
- large windows framed with "basket handle" arches
- mansard roof

It should be noted that no interior elements are mentioned in the Reasons for Designation. Most likely because interior alterations were anticipated so that the building could be rehabilitated for other uses.

### 5.0 PROPOSED ALTERATIONS

The proposed accessibility upgrades include changes to the main entrance so that the exhibition gallery on the main floor and the washrooms on the lower level will be fully accessible.


The proposed changes include the following:

- construction of a wheelchair ramp at the front entrance on Queen Street
- modifications to the stairs inside the front vestibule to accommodate a wheelchair lift to serve the main floor, vestibule, and lower level
- renovation of an existing washroom on the lower level to create an accessible washroom.

Drawings and renderings for the proposed changes have been prepared by Lebel & Boulaine and are included in the appendix of this report.

### Exterior Wheelchair Ramp


A new concrete wheelchair ramp will be installed to provide access to the front entrance. The top of the ramp will match the level the vestibule floor level, eliminating the step at the exterior door threshold. The foundation for the ramp has been designed so that it will not impact any of the existing trees in front of the building. A simple black steel railing is proposed.

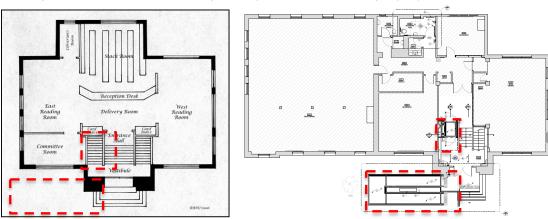

PROPOSED EXTERIOR WHEELCHAIR RAMP & INTERIOR LIFT

Left: Sketch of the original interior 1st floor layout by Hulley – annotated to show the impacted areas

Right: Proposed alterations by Lebel & Boulaine – annotated to show the proposed exterior ramp and interior lift

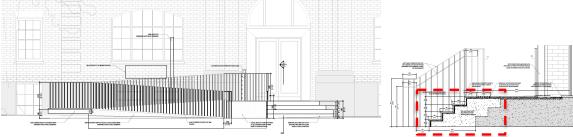

PROPOSED EXTERIOR WHEELCHAIR RAMP ON THE QUEEN STREET ELEVATION


Left: a simple black steel railing is proposed to match existing railings

the top of the existing landing will be raised to meet the floor level at the interior

the door opener will be installed on a bollard (not affixed to the building)

the existing sign and lamppost will be relocated


Right: detail showing the new concrete extension on the left side of the landing to accommodate the new ramp

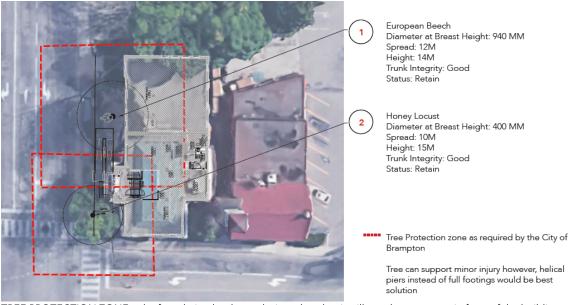

TREE PROTECTION ZONE – the foundation has been designed so that it will not damage trees in front of the building

### Interior Wheelchair Lift

A new wheelchair lift will be installed in the entrance vestibule to provide access to the main floor, vestibule, and the lower level. The existing stairs consist of a central stair up to the main floor and two flanking stairs down to the lower level. The new lift will be installed in the stairwell on the left side of the central stair. Unfortunately, the stairwell is too narrow to accommodate the smallest lift available, so this opening will have to be enlarged. To accommodate the enlarged opening for the lift, the central stair will be removed and rebuilt to fit the reduced central opening. The glazed partition wall at the top of the stairs will be removed where the lift is installed and the portion above the central entrance will be removed and replicated to fit the smaller opening.

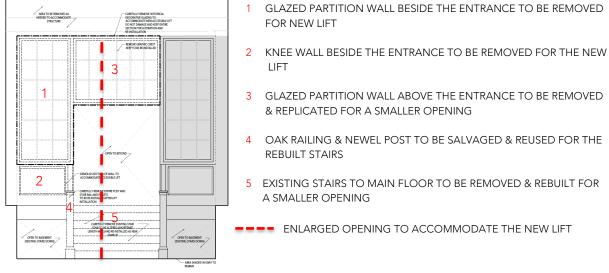

PROPOSED ALTERATIONS TO THE STAIRS INSIDE THE VESTIBULE to accommodate the proposed chair lift





PROPOSED PASSENGER LIFT – existing stairwell to the left to be enlarged to accommodate a passenger lift

Left: vestibule and stairs up to the main floor where the new exhibition gallery is located – existing oak railings


and newel post impacted by the renovations will be salvaged and relocated

Right: stairs to the lower level where the barrier free washroom is located - existing oak railings

and newel post impacted by the renovations will be salvaged and relocated

### Proposed Barrier Free Washroom

An existing washroom on the lower level will be renovated so that it can provide barrier free access. It is a modern 2-piece washroom that does have any heritage features. The door casing at the entrance to the washroom appears to be an original wood casing and there is original wood baseboard in the corridor outside the washroom.

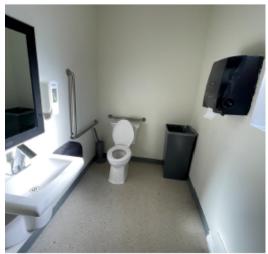



PROPSED BARRIER FREE WASHROOM – no heritage features in this area – the original door casing and baseboards in the corridor outside the washroom will not be impacted

### 6.0 HERITAGE IMPACT ASSESSMENT

Accessibility upgrades are beneficial because they support continued use of the heritage building as a public building. The building was constructed in 1907 and has a raised foundation. Existing access to the building through the main entrance on Queen Street therefore presents accessibility challenges including exterior steps up to the front door and interior stairs inside the entrance vestibule up to the main floor where the exhibition space is and down to the lower level where the washrooms are.

The impacts are identified as:

- impacts to the roots of existing trees on the Queen Street frontage from the foundations of the wheelchair ramp
- impacts to the left side of the entry steps where the proposed wheelchair ramp will connect with the existing stairs and landing
- impacts to the stairs inside the entrance vestibule and glazed partition wall at the top of the stairs

Appropriate mitigation strategies have been proposed to minimize adverse impacts including:

- a tree protection zone has been determined and below-grade disturbances in this area will be limited by using helical piles for the wheelchair ramp foundation
- the oak railings and newel posts that must be removed to accommodate the passenger lift will be salvaged and reused on the rebuilt stairs
- the glazed partition wall that must be removed to accommodate the passenger lift will be partially replicated to match the existing





PROPOSED WHEELCHAIR LIFT

Left: Example showing the type of wheelchair lift that has been proposed

Right: 1. central stair to be removed and rebuilt to provide space for the wheelchair lift

- 2. side stair to be removed and the opening widened to accommodate the wheelchair lift
- 3. portions of the glazed partition wall that will be replicated to fit the new dimensions
- 4. salvaged newel post and railings reinstated on the new stairs

### 7.0 RECOMMENDATIONS

Accessibility upgrades are beneficial because they support continued use of the heritage building as a public building. The building was constructed in 1907 and has a raised foundation. Existing access to the main floor of the building includes stone steps up to the front door and an interior vestibule with stairs up to the main floor and down to the basement level.

The impacts are identified as:

- impacts to the roots of existing trees on the Queen Street frontage from the foundations of the wheelchair ramp
- impacts to the left side of the entry steps where the proposed wheelchair ramp will connect with the existing stairs and landing
- impacts to the stairs inside the entrance vestibule and glazed partition wall at the top of the stairs

Appropriate mitigation strategies have been proposed to minimize adverse impacts including:

- a tree protection zone has been determined and below-grade disturbances in this area will be limited by using helical piles for the wheelchair ramp foundation
- the oak railings and newel posts that must be removed to accommodate the passenger lift will be salvaged and reused on the rebuilt stairs
- the glazed partition wall that must be removed to accommodate the passenger lift will be partially replicated to match the existing

The proposed changes represent an approach that will have the least impact on heritage features, is compatible with the architectural character of the building, and will improve access to all levels of the building through its primary entrance. The approach is generally consistent with guidance for rehabilitation projects in the *Standard & Guidelines for the Conservation of Historic Places in Canada*.

Therefore, it is recommended that the Heritage Permit Application be approved, subject to the following conditions:

- 1. that the architect provides detailed drawings & specifications for the replicated glazed partition wall and wheelchair ramp railings to heritage staff for final review, prior to the issue of building permits
- 2. that the architect and/or heritage consultant monitors demolition and construction work to ensure that original features are preserved wherever possible and that all new work is compatible and completed to the same high standard as the existing
- 3. that the arborist monitors tree protection during construction of the wheelchair ramp

### Accessibility

Providing people of all ages, interests and abilities with access to historic places is highly desirable and a frequently mandated social goal. Generally, the solutions that best balance accessibility needs with heritage value are those that enhance the use and appreciation of an historic place for everyone. Work should be carefully planned and undertaken so that impact on an historic place's heritage value and character-defining elements is minimized: the objective is to provide the highest level of access with the lowest level of impact. To determine the most appropriate solutions, accessibility and conservation specialists, and users, should be consulted early in the planning process.

Standards & Guidelines for the Conservation of Historic Places in Canada (2010) – general guidelines for rehabilitation projects.

### 8.0 SOURCES

Beckman, Margaret et al. The Best Gift; a Record of the Carnegie Libraries in Ontario (1984)

Hulley, Robert B. "Brampton Carnegie Library," Nov 30, 2007. Accessed online (originally published in the Brampton Heritage Times)

Ministry of Tourism, Culture & Sport (MTCS), Ontario Heritage Toolkit (2006)

Parks Canada, Standards & Guidelines for the Conservation of Historic Places in Canada (2010)

Stevens Burgess Architects, Five Year Conservation Plan; Brampton Library, 55 Queen Street, Brampton (2013)

### 9.0 QUALIFICATIONS OF THE AUTHOR

The author of this report is a professional member of the Canadian Association of Heritage Professionals. Formal education includes a Master of Arts in Architectural History from the University of Toronto and a Diploma in Heritage Conservation from the Willowbank School of Restoration Arts. Professional experience includes an internship at the Ontario Heritage Trust, three years as Architectural Historian & Conservation Specialist at Taylor Hazell Architects in Toronto, and 12 years in private practice in Ontario as a heritage consultant. Other relevant experience includes teaching art history at the University of Toronto and McMaster University and teaching Research Methods and Conservation Planning at the Willowbank School for Restoration Arts in Queenston. In addition to numerous heritage reports, the author has published work in academic journals such as the Journal of the Society for the Study of Architecture in Canada and the Canadian Historical Review.

### APPENDIX A: PHOTO DOCUMENTATION

\*photos provided by Lebel & Bouliane unless otherwise noted



FRONT ELEVATION ON QUEEN STREET EAST (Google Streetview)



MAIN ENTRANCE ON QUEEN STREET EAST (Google Streetview)




EXTERIOR – MAIN ENTRANCE: raised entrance with additional stairs inside to the main floor




EXTERIOR – MAIN ENTRANCE: stone steps, paved path & sidewalk, landscaped area enclosed by a wrought iron fence



INTERIOR – VESTIBULE: stairs up and entrance to the Regimental Museum main gallery located on the main floor

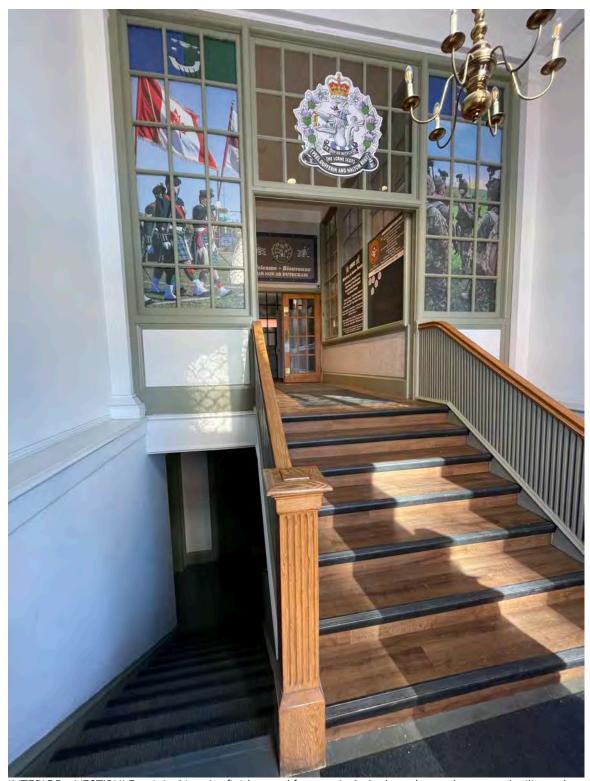

INTERIOR – VESTIBULE: original interior finishes and features include the oak newel posts and railings, the plaster & lathe walls, wood & plaster trim and the glazed partition wall at the top of the stairs – new vinyl flooring and carpeting has been installed on top of the original stair treads and risers

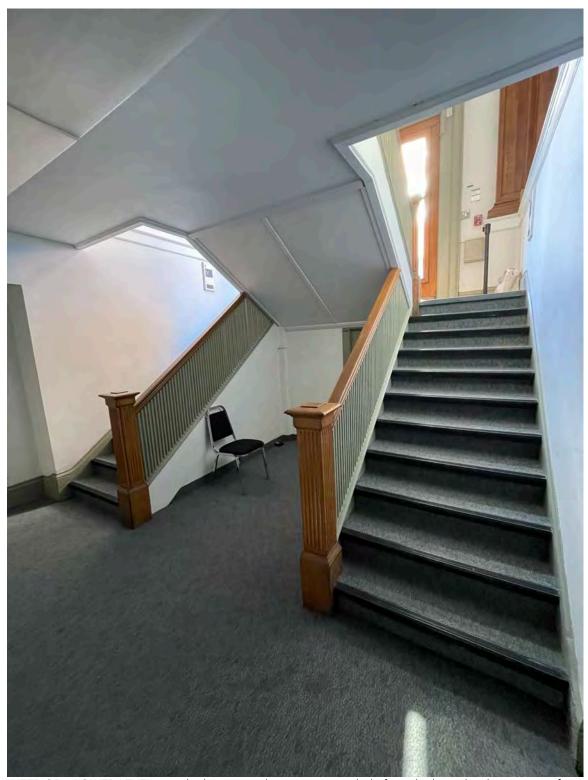

INTERIOR – LOWER LEVEL: view looking up to the entrance vestibule from the lower level – two sets of stairs down to the lower level and one set of stairs to the main floor – original features and finishes include the oak newel posts and railings – plaster & lathe walls and wood baseboards – wall to wall carpet has been installed on the original stair treads and risers



INTERIOR – LOWER LEVEL – underside of the stairs has plater and lathe with a wood or plaster moulding – there are steps down to the janitor's closet under the staircase



WASHROOM – existing two-piece washroom on the lower level – no original finishes or features - modern fixtures, drywall, vinyl flooring & acoustic tile ceiling – door casing on outer side may be original



WASHROOM – existing two-piece washroom on the lower level – nor original features or finishes - modern fixtures, drywall, vinyl flooring & acoustic tile ceiling – door casing on interior side is not original

### APPENDIX B: HISTORIC DOCUMENTATION



HISTORIC PHOTO – EXTERIOR (c.1907): the original exterior

[Region of Peel Archives]



HISTORIC PHOTO – INTERIOR (1911): the original interior of the Carnegie Library – the glazed partition wall remains [Region of Peel Archives]



HISTORIC PHOTO – EXTERIOR (1930s?): before the addition was built [Region of Peel Archives]



HISTORIC PHOTO – INTERIOR (1940s): - the interior when it still housed the public library [Region of Peel Archives]



HISTORIC PHOTO – EXTERIOR (1952): before the handrails was installed

[Region of Peel Archives]



### THE CORPORATION OF THE CITY OF BRAMPTON

# **BY-LAW**

Number	, , ,		
To designat	e the	Carne	gie
Library as	a prop	perty	of
historical	and ar	chite	ctural
i bas oulsy	nteres	+	

0\_82

WHEREAS section 29 of The Ontario Heritage Act, 1974 (R.S.O. 1980, c. 337, as amended) authorizes the council of a municipality to pass by-laws designating properties within the municipality to be of historic or architectural value or interest;

AND WHEREAS the council of The Corporation of the City of Brampton has given notice of its intention to so designate the property known as the Carnegie Library, located at 55 Queen Street East in the City of Brampton, in accordance with the requirements of section 29(3) of the said Act;

AND WHEREAS no notice of objection has been served upon the Clerk of The Corporation of the City of Brampton within the time limited for so doing, as set out in section 29(5) of the said Act;

NOW THEREFORE the Council of The Corporation of the City of Brampton ENACTS as follows:

1. The property known as the Carnegie Library and described in Schedule A to this by-law is hereby designated to be a property of historic and architectural value and interest.

READ a FIRST, SECOND and THIRD TIME and PASSED in Open Council this  ${
m 25th}$  day of  ${
m January}$  , 1982.

James E. Archdekin, Mayor

Ralph A. Everett, Clerk

### SCHEDULE A TO BY-LAW 9-82

ALL AND SINGULAR that certain parcel or tract of land and premises situate, lying and being in the City of Brampton, in the Regional Municipality of Peel; containing an area of 0.17 acres more or less and being composed of those parts of Lots 7 and 8, Registered Plan BR-2 (being a subdivision of part of the West half of Lot 5, Concession 1, East of Hurontario Street) in the said City described as follows:

Premising that the bearings herein are astronomic, referred to the Southeasterly limit of Queen Street East as being North 37 degrees 46' East in accordance with a Plan of Survey deposited in the Registry Office for the Registry Division of Peel (No. 43) as Instrument Number 260728V.S.;

COMMENCING at the intersection of the Northeasterly limit of Chapel Street with the Southeasterly limit of Queen Street East, being also the westerly angle of said Lot 7;

THENCE North 37 degrees 46' East along the said Southeasterly limit of Queen Street East, a distance of 120.12 feet;

THENCE South 51 degrees 30' East parallel to the said Northeasterly limit of Chapel Street, a distance of 62.5 feet;

THENCE South 37 degrees 46' West parallel to the said Southeasterly limit of Queen Street East, a distance of 120.12 feet to the aforesaid Northeasterly limit of Chapel Street;

THENCE North 51 degrees 30' West along the last mentioned limit, a distance of 62.5 feet to the point of commencement.

The hereinbefore described parcel of land being the lands described in Registered Instrument Number 200040V.S. and shown on a Plan of Survey dated April 9, 1951 signed by Frank Kitts, O.L.S. and attached to Registered Instrument Number 25421.

### NUMBER OF DESIGNATION

8

6, "

### NAME OF PROPERTY

The Carnegie Library

### MUNICIPAL ADDRESS OR LOCATION

55 Queen Street East

### LEGAL DESCRIPTION

ALL AND SINGULAR that certain parcel or tract of land and premises situate, lying and being in the City of Brampton, in the Regional Municipality of Peel; containing an area of 0.17 acres more or less and being composed of those parts of Lots 7 and 8, Plan BR-2 (being a subdivision of part of the West Half of Lot 5, Concession 1, East of Hurontario Street) in the said City described as follows:

Premising that the bearings herein are astronomic, referred to the Southeasterly limit of Queen Street East as being North 37 degrees 46' East in accordance with a Plan of Survey deposited in the Registry Office for the Registry Division of Peel (No. 43) as Instrument Number 260728VS;

COMMENCING at the intersection of the Northeasterly limit of Chapel Street with the Southeasterly limit of Queen Street East, being also the westerly angle of said Lot 7;

THENCE North 37 degrees 46' East along the said Southeasterly limit of Queen Street East, a distance of 120.12 feet;

THENCE South 51 degrees 30' East parallel to the said Northeasterly limit of Chapel Street, a distance of 62.5 feet;

THENCE South 37 degrees 46' West parallel to the said Southeasterly limit of Queen Street East, a distance of 120.12 feet to the aforesaid Northeasterly limit of Chapel Street;

THENCE North 51 degrees 30' West along the last mentioned limit, a distance of 62.5 feet to the point of commencement.

The hereinbefore described parcel of land being the lands described in Registered Instrument Number 200040V.S. and shown on a Plan of Survey dated April 9, 1951 signed by Frank Kitts, O.L.S. and attached to Registered Instrument Number 25421.

### NAME AND ADDRESS OF OWNER

The Corporation of the City of Brampton 150 Central Park Drive Brampton, Ontario L6T 2T9

### REASONS FOR DESIGNATION

Built in 1906, this building was constructed in the Beaux Arts style, similar to its sibling in Toronto. This style exhibits classical features such as a rusticated basement level, constructed of large stone. A main living storey which is constructed of bricks is divided above by a running frieze, creating the appearance of a third level, or attic. These three divisions are traditional and it is intriguing to see the practice carried out on a small scale. The most interesting feature is the main entrance which illustrates the

architectural plasticity of the Beaux Arts style. Brick simulated pilasters create a porch-like entrance area. It is topped with a circular arch, than branches from the running frieze. But ironically it recedes back instead of projecting forward as most pediments do. Large windows framed with "basket-handle" arches adequately light the reading areas. The slanting Mansard roof is of a French origin. The Old Carnegie Library is a rare example of the short lived Beaux Art Style in Brampton.

# NUMBER AND DATE OF PASSAGE OF BY-LAW DESIGNATING PROPERTY

By-law Number:

9-82

Date of Passage: January 25th, 1982

## REGISTRATION NUMBER AND REGISTRATION DATE OF DESIGNATING BY-LAW

Registration Number: 601500

Registration Date: February 3rd, 1982

# Lorne Scots Regimental Museum 55 Queen Street East, Brampton ON, L6W 2A8

ISSUED FOR PERMIT & TENDER
JULY 24, 2024



All drawings, specifications, related documents and design are the copyright property of the architect and must be returned upon request. Reproduction of the drawings, specifications, related documents and design in whole or in part is strictly forbidden without the architect's written permission.

This drawing, as an instrument of service, is provided by and is the property of LEBEL & BOULIANE Inc. and shall be used only for the project named on this drawing and solely for reference purposes only. The contractor is responsible for the coordination and verification of all dimensions contained herein and all measurements and conditions on site as they pertain to these documents. The contractor shall report any discrepancies to the consultant in writing prior to the commencement of any affected work.

Do not scale this drawing

This drawing shall not be used for construction purposes unle

This drawing shall not be used for construction purposes unless countersigned

Seals

PAF	RT 11 - RENOVATION OF	EXISTING	BUILDING	,	1		0	Revised: 2016 10 04  BC REFERENCE [1]
	Name of Practice Lebel & Bouliane							
	Address 1 1249 Dundas St. V	V.			_			
	Address 2 Toronto, ON				_			
					_			
	Contact Luc Bouliane				_			
	Name of Project Lorne Scots Regin	nental Museum - A	ccessibility Upgr	ades	_			
	Location/Address 55 Queen St E, Br	ampton ON L6W 2	A8		_			
	Date 18-Jul-24				Seal & Signa	iture		
1.00	BUILDING CODE VERSION	O.Reg. 332/12	L	AST AMENDMENT	O.Reg. 191/	14		
1.01	PROJECT TYPE	Renovation						[A] 1.1.2.
		No change to occ		upgrades to the Lo	orne Scots Reg	gimental N	Museum	
1.02	MAJOR OCCUPANCY CLASSIFICATION	OCCUPANCY			USE			3.1.2.1.(1)
		A2	Other assemb	ly occupancies	Museum (Ex	isting)		_
								_
1.03	SUPERIMPOSED MAJOR	NO			í			3.2.2.7.
1.03	OCCUPANCIES							U.L.L.I .
1.04	BUILDING AREA (m²)	DESCRIPTION		EXISTING	3	NEW	TOTAL	[A] 1.4.1.2.
		Museum		765.00	)	0.00	765.0	_
								_
		TOTAL		765.0		-	765.0	_
1.05	BUILDING HEIGHT	1	STOREYS AB		7,8		(m) ABOVE GRADE	
	NUMBER OF STREETS/		STOREYS BE	LOW GRADE			;	3.2.1.1.
1.06	FIRE FIGHTER ACCESS		2 STREETS(S)					3.2.2.10. & 3.2.5.
	BUILDING SIZE EXISTING BUILDING	CHANGE IN MAJ	OD OCCUDANCE	DV.	NO			T.11.2.1.1.BN.
1.08	CLASSIFICATION	CONSTRUCTION		<u> </u>	-			11.2.1.1. T.11.2.1.1.A.
		HAZARD INDEX			NOT APPLIC	CABLE		T.11.2.1.1.BN.
		IMPORTANCE C	ATEGORY		-			
1.09	RENOVATION TYPE	BASIC RENOVA	ΓΙΟΝ					11.3.3.1. & 11.3.3.2.
1.10	OCCUPANT LOAD	FLOOR LEVEL/AREA		OCCUPANCY TYPE	BASED ON		OCCUPANT LOAD (PERSONS)	3.1.17.
		No Change in Oc	cupancy or load					_
		TOTAL			<u> </u>		-	_
1.11	PLUMBING FIXTURE REQUIREMENTS	RATIO:	MALE:FEMAL	E = 50:50 EXCEPT	AS NOTED C	THERWI	SE	3.7.4.
		FLOOR LEVEL/AREA	OCCUPANT LOAD	OBC REFERENCE	FIXTURES REQUIRED		FIXTURES PROVIDED	_
		No Change in Oc		NEI ENLINCE	L'EMOILED		TOVIDED	-
1 10	RADDIED EDEE DECICAL		- spandy or load					11 2 2 2 70
1.12 1.13	BARRIER-FREE DESIGN REDUCTION IN PERFORMANCE	Yes STRUCTURAL			NO			11.3.3.2.(2)
0	LEVEL	INCREASE IN O	CCUPANT LOAF	)	NO			11.4.2.1.
		CHANGE OF MA		-	NO			11.4.2.3.
		PLUMBING			NO			11.4.2.4.
		SEWAGE SYSTE	EM .		NO			 11.4.2.5.
1.14	COMPENSATING CONSTRUCTION	STRUCTURAL			NO			11.4.3.2.
		INCREASE IN O	CCUPANT LOAD	)	NO			11.4.3.3.
		CHANGE OF MA	JOR OCCUPAN	CY	NO			 11.4.3.4. _
		PLUMBING			NO			11.4.3.5.
		SEWAGE SYSTE	M		NO			11.4.3.6.
1.15	COMPLIANCE ALTERNATIVES PROPOSED	NO						11.5.1.1.
1.16	NOTES							
								_
				:				_
		1	ALL REFERENCE	CES ARE TO DIVISIO	N B OF THE OF	C UNI FS	S PRECEDED BY IAI	

ISSUED FOR PERM TENDER	ISSUE FOR CLIEN REVIEW		
X	x	A0.0	COVER PAGE
			ARCHITECTURAL
x	Х	A0.1	SITE SURVEY
X	Х	A0.2	SITE PLAN
X	Х	A0.3	ASSEMBLIES
X	Х	A1.0	BASEMENT FLOOR DEMOLITION PLAN
X	Х	A1.1	GROUND FLOOR DEMOLITION PLAN
X	Х	A1.5	BASEMENT FLOOR DEMOLITION RCP
X	Х	A1.6	GROUND FLOOR DEMOLITION RCP
X	Х	A2.0	BASEMENT FLOOR PLAN
X	Х	A2.1	GROUND FLOOR PLAN
X	Х	A3.0	BASEMENT FLOOR RCP
X	Х	A3.1	GROUND FLOOR RCP
X	Х	A5.0	INTERIOR ELEVATIONS
X	Х	A5.1	INTERIOR ELEVATIONS
X		A6.0	DOOR HARDWARE
X	Х	A8.0	RAMP PLAN
X	Х	A8.1	RAMP ELEVATIONS
X	Х	A8.2	DETAILS
Х	X	A8.3	INTERIOR SECTIONS
			STRUCTURAL
	Х	S1.01	FOUNDATION PLAN
	Х	\$1.02	BASEMENT PLAN SHOWING GROUND FLOOR FRAMING
	X	S1.03	GROUND FLOOR PLANS SHOWING ROOF FRAMING
			MECHANICAL
	Х	M1	MECHANICAL LEGENDS, NOTES & SCHEMATICS
	Х	M2	KEY PLANS
		М3	EXISTING & NEW MECHANICAL PLANS
			ELECTRICAL
	Х	E1	ELECTRICAL LEGEND AND NOTES
	Х	E2	KEY PLANS
	Х	E-3	EXISTING & ELECTRICAL PLANS
			DDO IECT DIDECTO

# PROJECT DIRECTORY

CLIENT: CITY OF BRAMPTON Joel Rasiah 647 203 7645 joel.rasiah@brampton.ca

ARCHITECT: LEBEL & BOULIANE INC. Luc Bouliane, OAA +1 416 500 5927 Luc @ Arch-LB.com

MECHANICAL & ELECTRICAL ENGINEER:
SURI & ASSOCIATES LTD.
Rohin Suri
647 981 7621
rsuri@suriassoc.com

STRUCTURAL ENGINEER: CONTACT ENGINEERING Tim Joyce 647 708 3960 tim@contactengineering.ca 01 Permit & Tender 2024.07.24

No. Issued for Date


# Lorne Scots Regimental Museum

Project Address: 55 Queen Street East, Brampton L6W 2A8

Project No. 24-002
Drawn by TT
Reviewed by MS
Scale NTS
Plot Date 2024.07.24

**COVER PAGE** 

Drawing No:

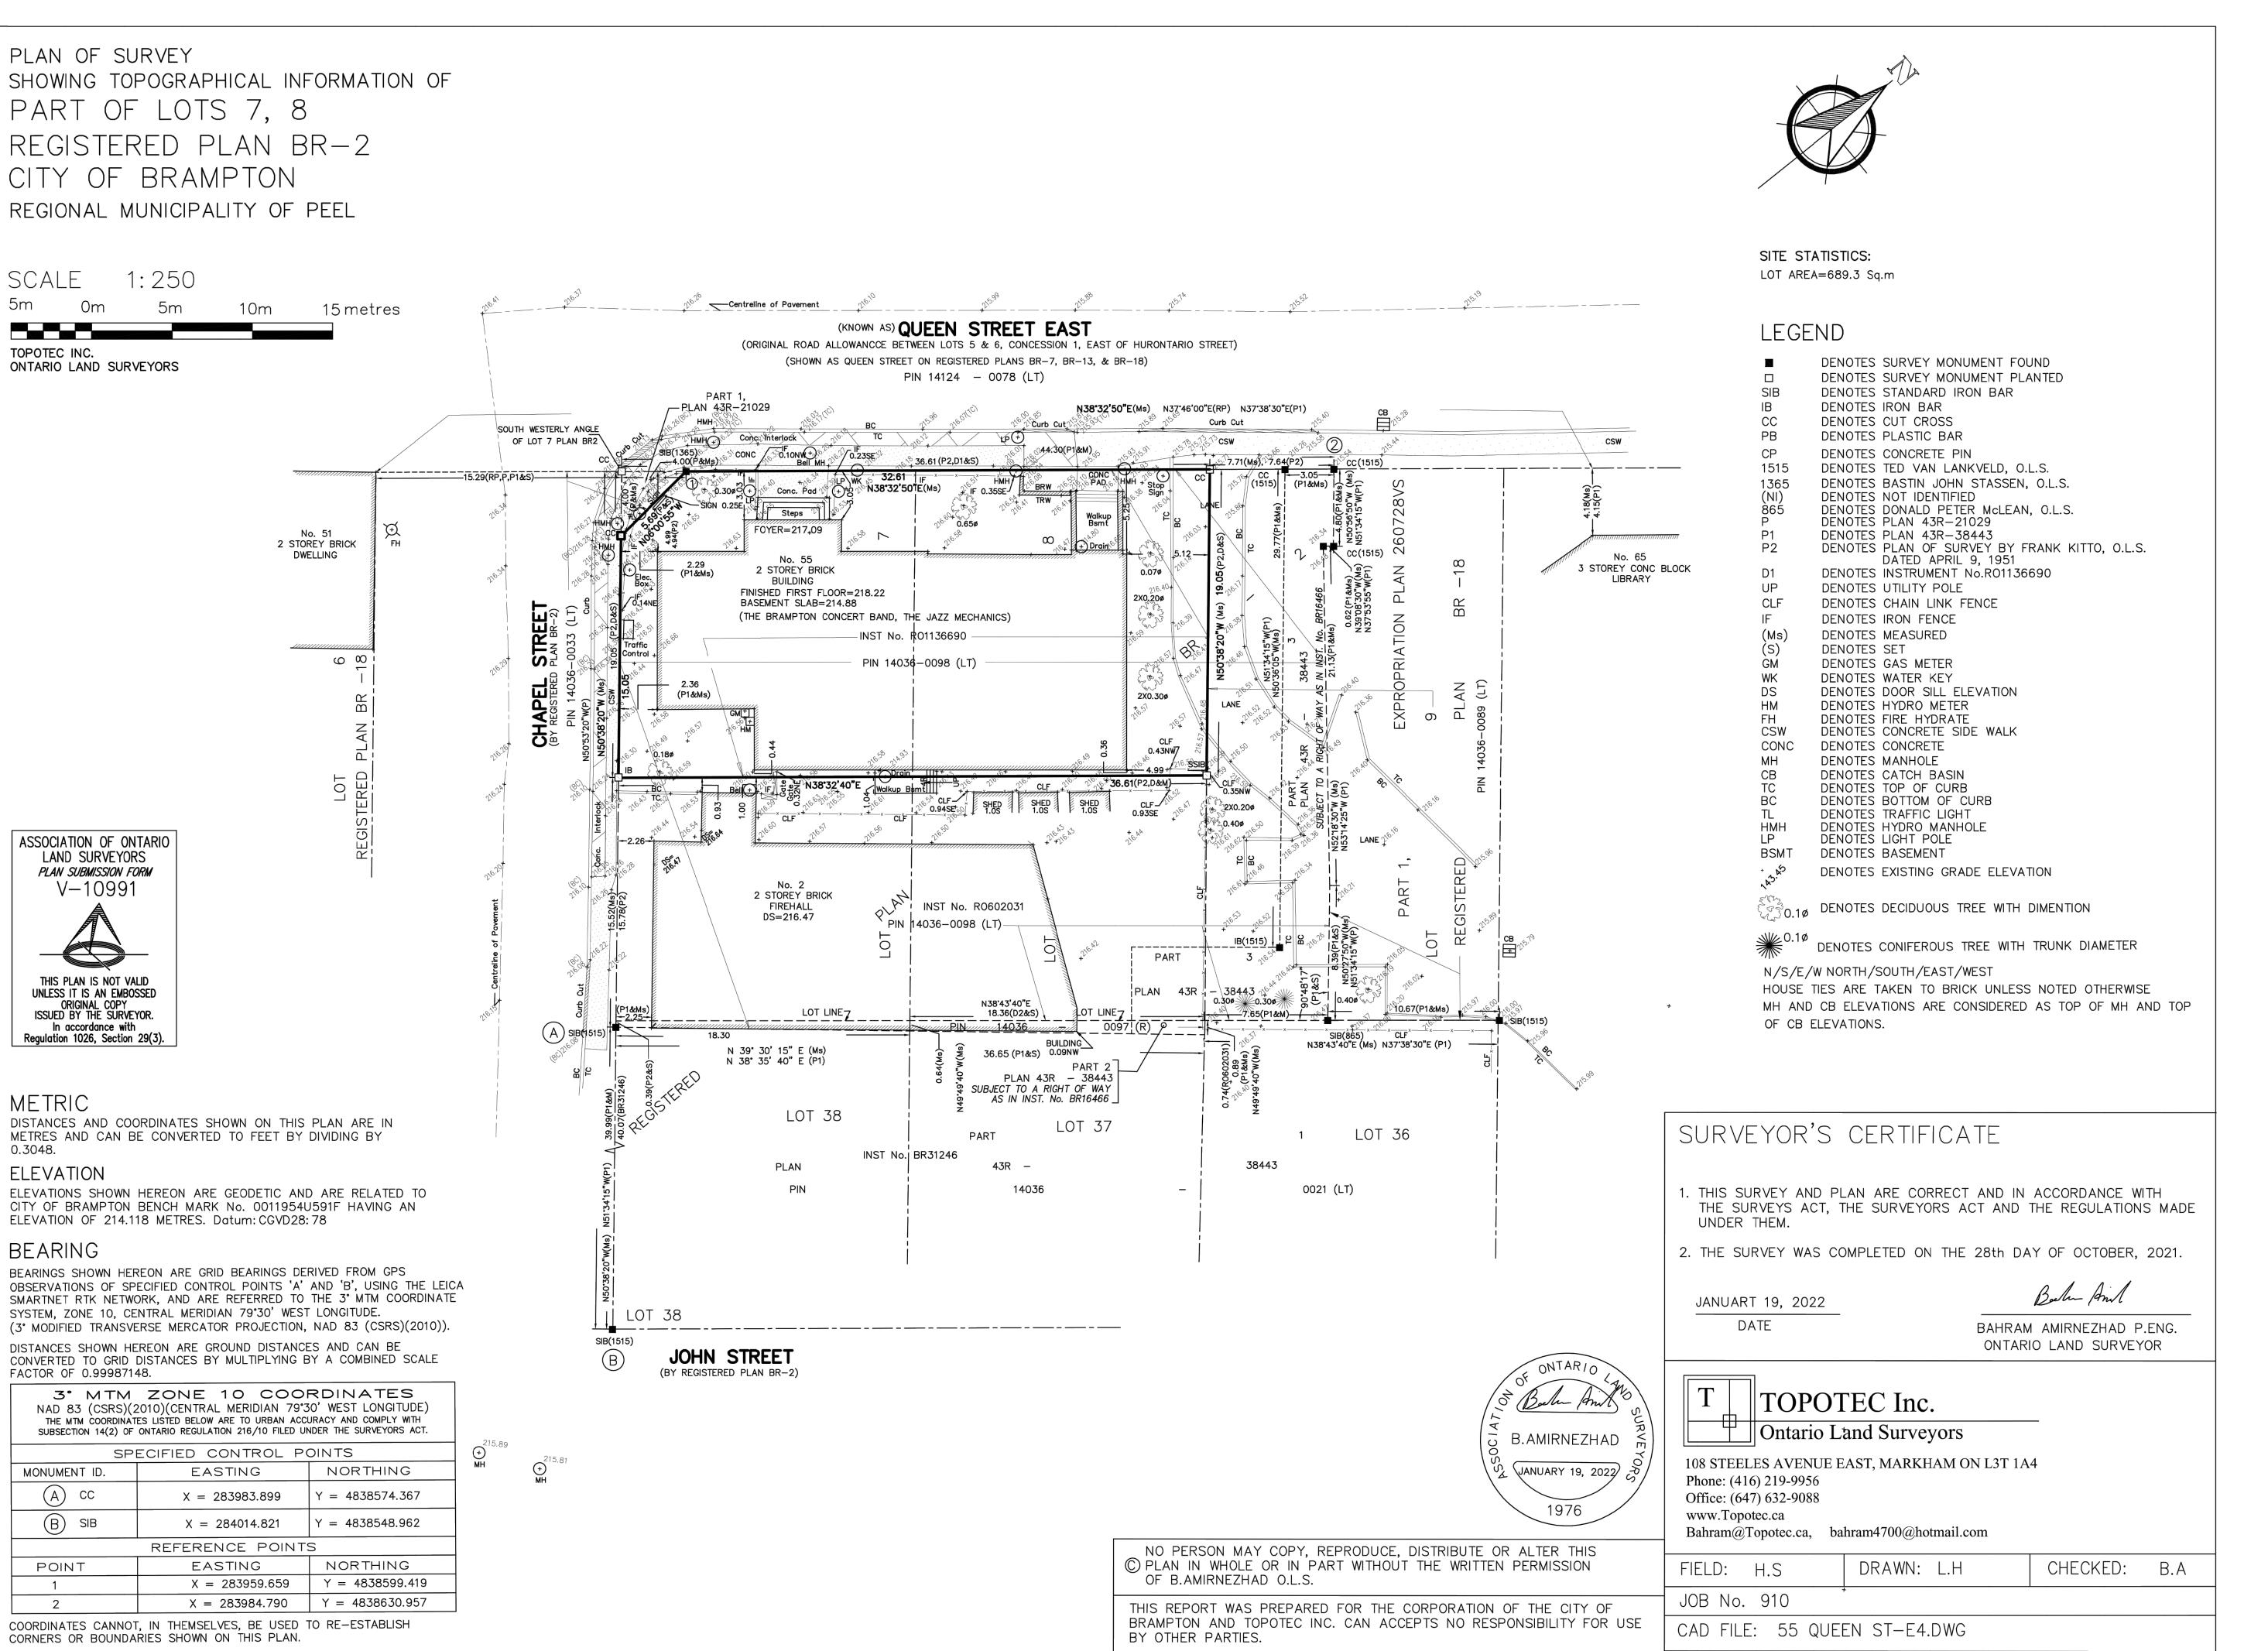



must be returned upon request. Reproduction of the drawings, specifications, related documents and in whole or in part is strictly forbidden without the architect's written permission

shall be used only for the project named on this drawing and solely for reference purposes only. The contractor is responsible for the coordination and verification of all dimensions contained herein and all measurements and conditions on site as they pertain to these documents. The contractor shall report any

Issued for

2024.07.24 Permit & Tender

**Lorne Scots** Regimental Museum

> Project Address: 55 Queen Street East, Brampton L6W 2A8

> > 24-002

NTS

2024.07.15

Project No.

Drawn by Reviewed by Scale Plot Date

**SITE SURVEY** 




All drawings, specifications, related documents and design are the copyright property of the architect and must be returned upon request. Reproduction of the drawings, specifications, related documents and design in whole or in part is strictly forbidden without the architect's written permission.

This drawing, as an instrument of service, is provided by and is the property of LEBEL & BOULIANE Inc. and shall be used only for the project named on this drawing and solely for reference purposes only. The contractor is responsible for the coordination and verification of all dimensions contained herein and all measurements and conditions on site as they pertain to these documents. The contractor shall report any discrepancies to the consultant in writing prior to the commencement of any affected work.

Do not scale this drawing

This drawing shall not be used for construction purposes unless countersigned

Seals:

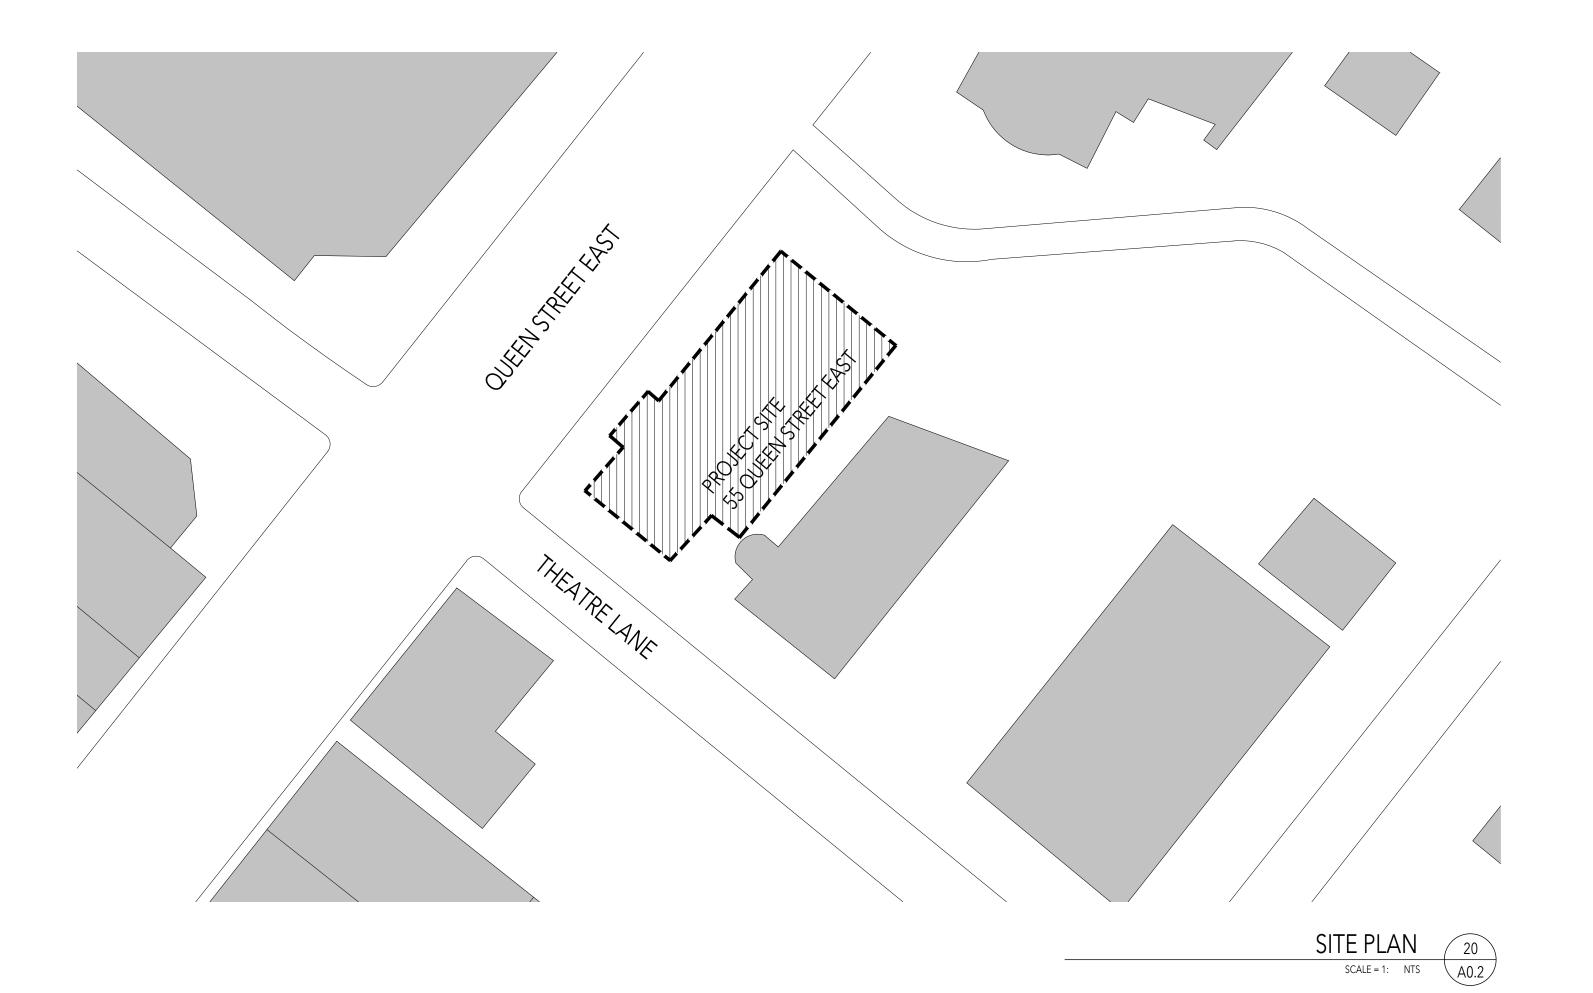

01 Permit & TenderNo. Issued for

for Date

2024.07.24


Lorne Scots Regimental Museum

> Project Address: 55 Queen Street East, Brampton L6W 2A8

> > 23-022

NTS

2024.07.15

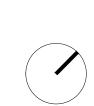

Project No.
Drawn by
Reviewed by
Scale
Plot Date

SITE PLAN

Drawing No:

### PARTITION TYPES: **ASSEMBLIES** 15.9mm [5/8"] 89mm [3-1/2"] 15.9mm [5/8"] GYPSUM WALLBOARD (REFER TO NOTES 3 & 4) 1. ALL NEW PARTITIONS ARE P1 TYPE, UNLESS OTHERWISE NOTED. 2x4 SPF STUDS @ 400 O.C. WITH BATT GYPSUM WALLBOARD (REFER TO NOTES 3 & 4) . UNLESS NOTED OTHERWISE, EXTEND ALL GYPSUM BOARD AND METAL FINISH WHERE OCCURS, REFER TO FINISH PLAN STUDS TO U/S OF STRUCTURE COMPLETE WITH DEFLECTION TRACK AND CONT. ACOUSTIC SEAL UNLESS OTHERWISE NOTED. CONTINUOUS ACOUSTIC SEALANT AT PERIMETER. SUPPORTS ANCHORED TO FLOOR AS REQ. USE WATER RESISTANT GWB IN LIEU OF STANDARD GWB, IN ALL WET AREAS, INCLUDING AREAS ADJACENT TO KITCHEN SINKS, JANITOR SINKS, 4. USE TILE BACKER BOARD/CEMENT BOARD IN LIEU OF STANDARD GWB WHERE TILE FINISH IS LOCATED (SEE SPECIFICATIONS AND ROOM FINISH ALL PARTITIONS/FURRING ARE TO BE CONTINUOUSLY REINFORCED TO ACCOMMODATE WALL CABINETS/A.V. WHERE INDICATED. PROVIDE ELEVATOR PARTITION BRACING AND BLOCKING WHERE REQUIRED. 15.9mm [5/8"] 89mm [3 1/2"] 15.9mm [5/8"] TYPE X GYPSUM WALLBOARD SUBSTRATE SHOWN MAY NOT BE PRESENT OR MAY VARY - REFER TO 2x4 SPF STUDS @ 400 O.C. TYPE X GYPSUM WALLBOARD PLANS AND ELEVATIONS. FINISH WHERE OCCURS, REFER TO FINISH PLAN MIN. 89mm ACOUSTIC BATT INSULATION CONTINUOUS ACOUSTIC SEALANT AT PERIMETER. SUPPORTS ANCHORED TO FLOOR AS REQ.


FURRING TYI	FURRING TYPE F1		
38 ***	EXISTING PARTITION FURRING CHANNEL GYPSUM WALLBOARD	22mm 15.9mm	[7/8 [5/8


121+mm


\*ENSURE MINIMUM WALL THICKNESS IS PROVDED FOR INSTALLATION OF ELEVATOR

REFERENCE STRUCTURAL DRAWINGS

_				
	CEILING TYPES:			
	<b>(C1)</b>	SUSPENDED GWB CEILING		
	VARIES	EXISTING STRUCTURE SUSPENDED METAL STUDS FRAMING, GAUGE AS REQ. @ 610 O.C FURRING CHANNELS 610 O.C GYPSUM WALLBOARD	42mm 22mm 15.9mm	[1-5/8 [7/8" ] [5/8"n

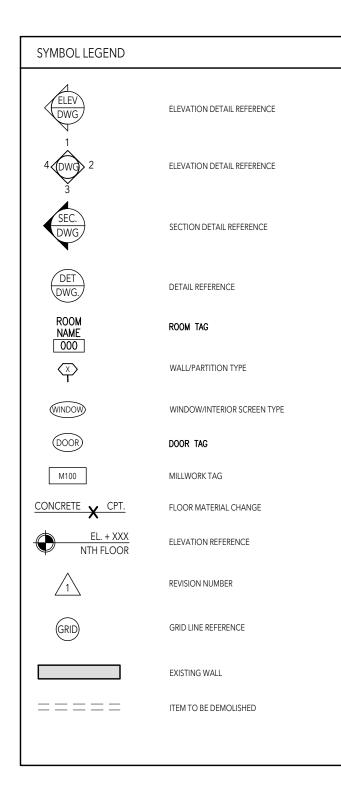

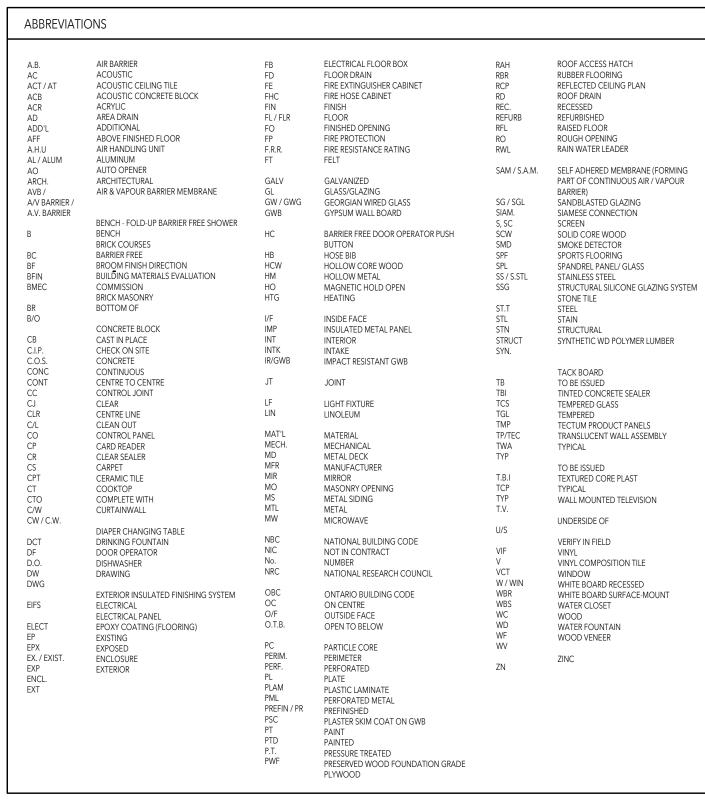

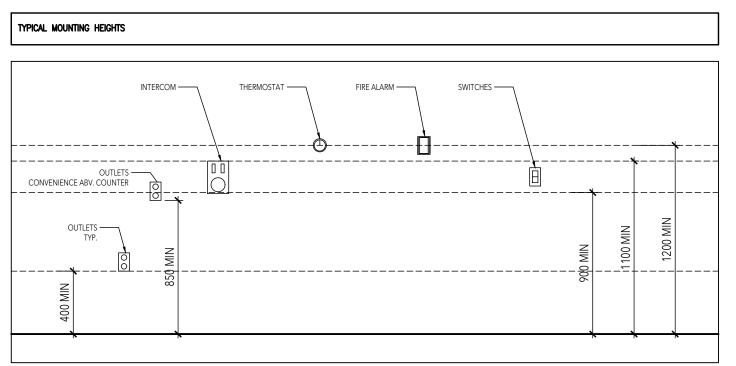

1249 Dundas Street West Toronto M6J 1X6 . Arch-LB.com

All drawings, specifications, related documents and design are the copyright property of the architect and must be returned upon request. Reproduction of the drawings, specifications, related documents and design

in whole or in part is strictly forbidden without the architect's written permission.

shall be used only for the project named on this drawing and solely for reference purposes only. The contractor is responsible for the coordination and verification of all dimensions contained herein and all measurements and conditions on site as they pertain to these documents. The contractor shall report any

This drawing shall not be used for construction purposes unless countersigned

Permit & Tender

**Lorne Scots Regimental Museum** 

> Project Address: 55 Queen Street East, Brampton L6W 2A8

2024.07.24

Project No. 24-002 TT Drawn by Reviewed by NTS Scale 2024.07.15 Plot Date

**ASSEMBLIES** 

### GENERAL DEMOLITION NOTES

- 1. PRIOR TO DEMOLITION NOTIFY CONSULTANTS OF ANY DISCREPANCIES WITH THE DRAWINGS
  2. PRIOR TO DEMOLITION COORDINATE WITH MUSEUM HOURS OF OPERATION, MATERIAL AND WASTE HANDLING REQUIREMENTS AND MATERIAL TO BE REUSED.
  3. COORDINATE WITH MUSEUM AND OBTAIN APPROVAL FOR SPECIAL DEMOLITION ACTIVITIES CAUSING DISTURBANCE TO OTHER OCCUPANTS AND SPACES OUTSIDE OF DEMOLITION AREAS.
  4. PROTECT AREA OF WORK, EXISTING CONSTRUCTION TO REMAIN AND ADJACENT AREAS FROM DAMAGE, PROVIDE DUST BARRIER TO ALL AREAS AFFECTED BY THE DEMOLITION. PROTECT AND MAINTAIN ADJACENT TENANT AREAS.
  5. REFER TO OWNERS DESIGNATED SUBSTANCES REPORT FOR PRE-EXISTING DESIGNATED SUBSTANCES OBSERVED. REPORT ANY FINDING OF DESIGNATED SUBSTANCES DISCOVERED DURING DEMOLITION.

- DEMOLITION.

  6. REMOVE ALL UNUSED HANGERS, FASTENERS, LOOSE PAINT, DEBRIS ETC FROM EXISTING WALLS AND CEILINGS TO REMAIN. PATCH AND REPAIR TO PREP FOR PAINTING OR FUTURE WORK.

  7. REMOVE ALL EXISTING LIGHTING FIXTURES AND ANY ASSOCIATED SENSORS, HANGERS, HARDWARE, CONDUIT AND WIRING NOT REQUIRED FOR INSTALLATION OF NEW FIXTURES. RETAIN POWER SUPPLY FOR FUTURE LIGHTING. REF RCPS AND ELECTRICAL DRAWINGS FOR ADDITIONAL INFORMATION

  8. ALL BUILDING-WIDE LIFE SAFETY SYSTEMS INCLUDING FIRE ALARMS, EXIT SIGNS, AND EMERGENCY LIGHT SYSTEMS TO REMAIN INTACT AND FUNCTIONAL DURING DEMOLITION

  9. MECHANICAL AND ELECTRICAL SYSTEMS WITHIN ADJACENT OCCUPIED AREAS ARE TO REMAIN INTACT AND FUNCTIONAL DURING DEMOLITION

- OCCUPIED AREAS ARE TO REMAIN INTACT AND FUNCTIONAL DURING DEMOLITION

  10. REF MECHANICAL AND ELECTRICAL DRAWINGS FOR SCOPE OF MECHANICAL / ELECTRICAL DEMOLITION

  11. REMOVE AND RETURN TO OWNER OR TENANT WASTE & DISPOSAL SYSTEMS, SANITIZERS, FIRE EXTINGUISHERS & OTHER MISC. ACCESSORIES AND EQUIPMENT. DEMOLISH OR REMOVE FROM SITE IF NOT USED. OWNER/TENANT APPROVAL REQUIRED.

  12. MAKE GOOD ALL EXISTING WALLS TO REMAIN. PATCH ALL DAMAGES TO WALLS/CEILINGS TO ENSURE CONSISTENT SURFACE AND CONTINUITY OF FIRE RATING WHERE OCCURS.

  13. WHERE EXISTING FLOORING IS REMOVED. CONTRACTOR TO


- WHERE EXISTING FLOORING IS REMOVED, CONTRACTOR TO COORDINATE WITH FINAL FINISH MATERIAL TO PROVIDE CLEAN AND LEVEL SURFACE TO ACCOMMODATE NEW FLOORING.

PLAN DEMOLITION KEY NOTES:

- DENOTES EXISTING TO REMAIN
- DENOTES AREA NOT IN SCOPE OF WORK

DENOTES EXISTING TO BE DEMOLISHED

- REMOVE EXISTING INTERIOR PARTITION OR FURRED OUT WALL TO U/S CEILING OR SLAB, INCLUDING DOOR, FRAMES, DATA AND POWER.
  PATCH & REPAIR ANY DRYWALL FLOOR AND CEILING DAMAGED BY
- REMOVE EXISTING FLOORING AND ADHESIVES TO EXTENT REQUIRED TO ACCOMMODATE NEW FLOORING AND NEW PARTITIONS. REFER TO NEW ARCHITECTURAL PLANS.
- REMOVE EXISTING STAIR AND AND HAND RAIL CAREFULLY REMOVE ITEMS AND SALVAGE FOR USE IN NEW STAIR CONSTRUCTION
- REMOVE EXISTING DOOR AND FRAME
- REMOVE PORTION OF EXISTING DECORATIVE GLAZING, SALVGE AND
- RE-INSTALL, MAY REQUIRE ALTERATION REMOVE EXISTING M&E, REFERENCE M&E DRAWINGS
- REMOVE EXISTING PLUMBING, ACCESSORIES AND EQUIPMENT KEEP FOR RE-INSTALLATION TO ACCESSIBILITY STANDARD CODE
- EXISTING LAMP POST TO BE REMOVED
- 9 EXISTING CITY OF BRAMPTON SIGN TO BE REMOVED AND RELOCATED
- REMOVE EXISTING BASEBOARDS (EXTENT THAT IS PART OF NEW BARRIER FREE WASHROOM)

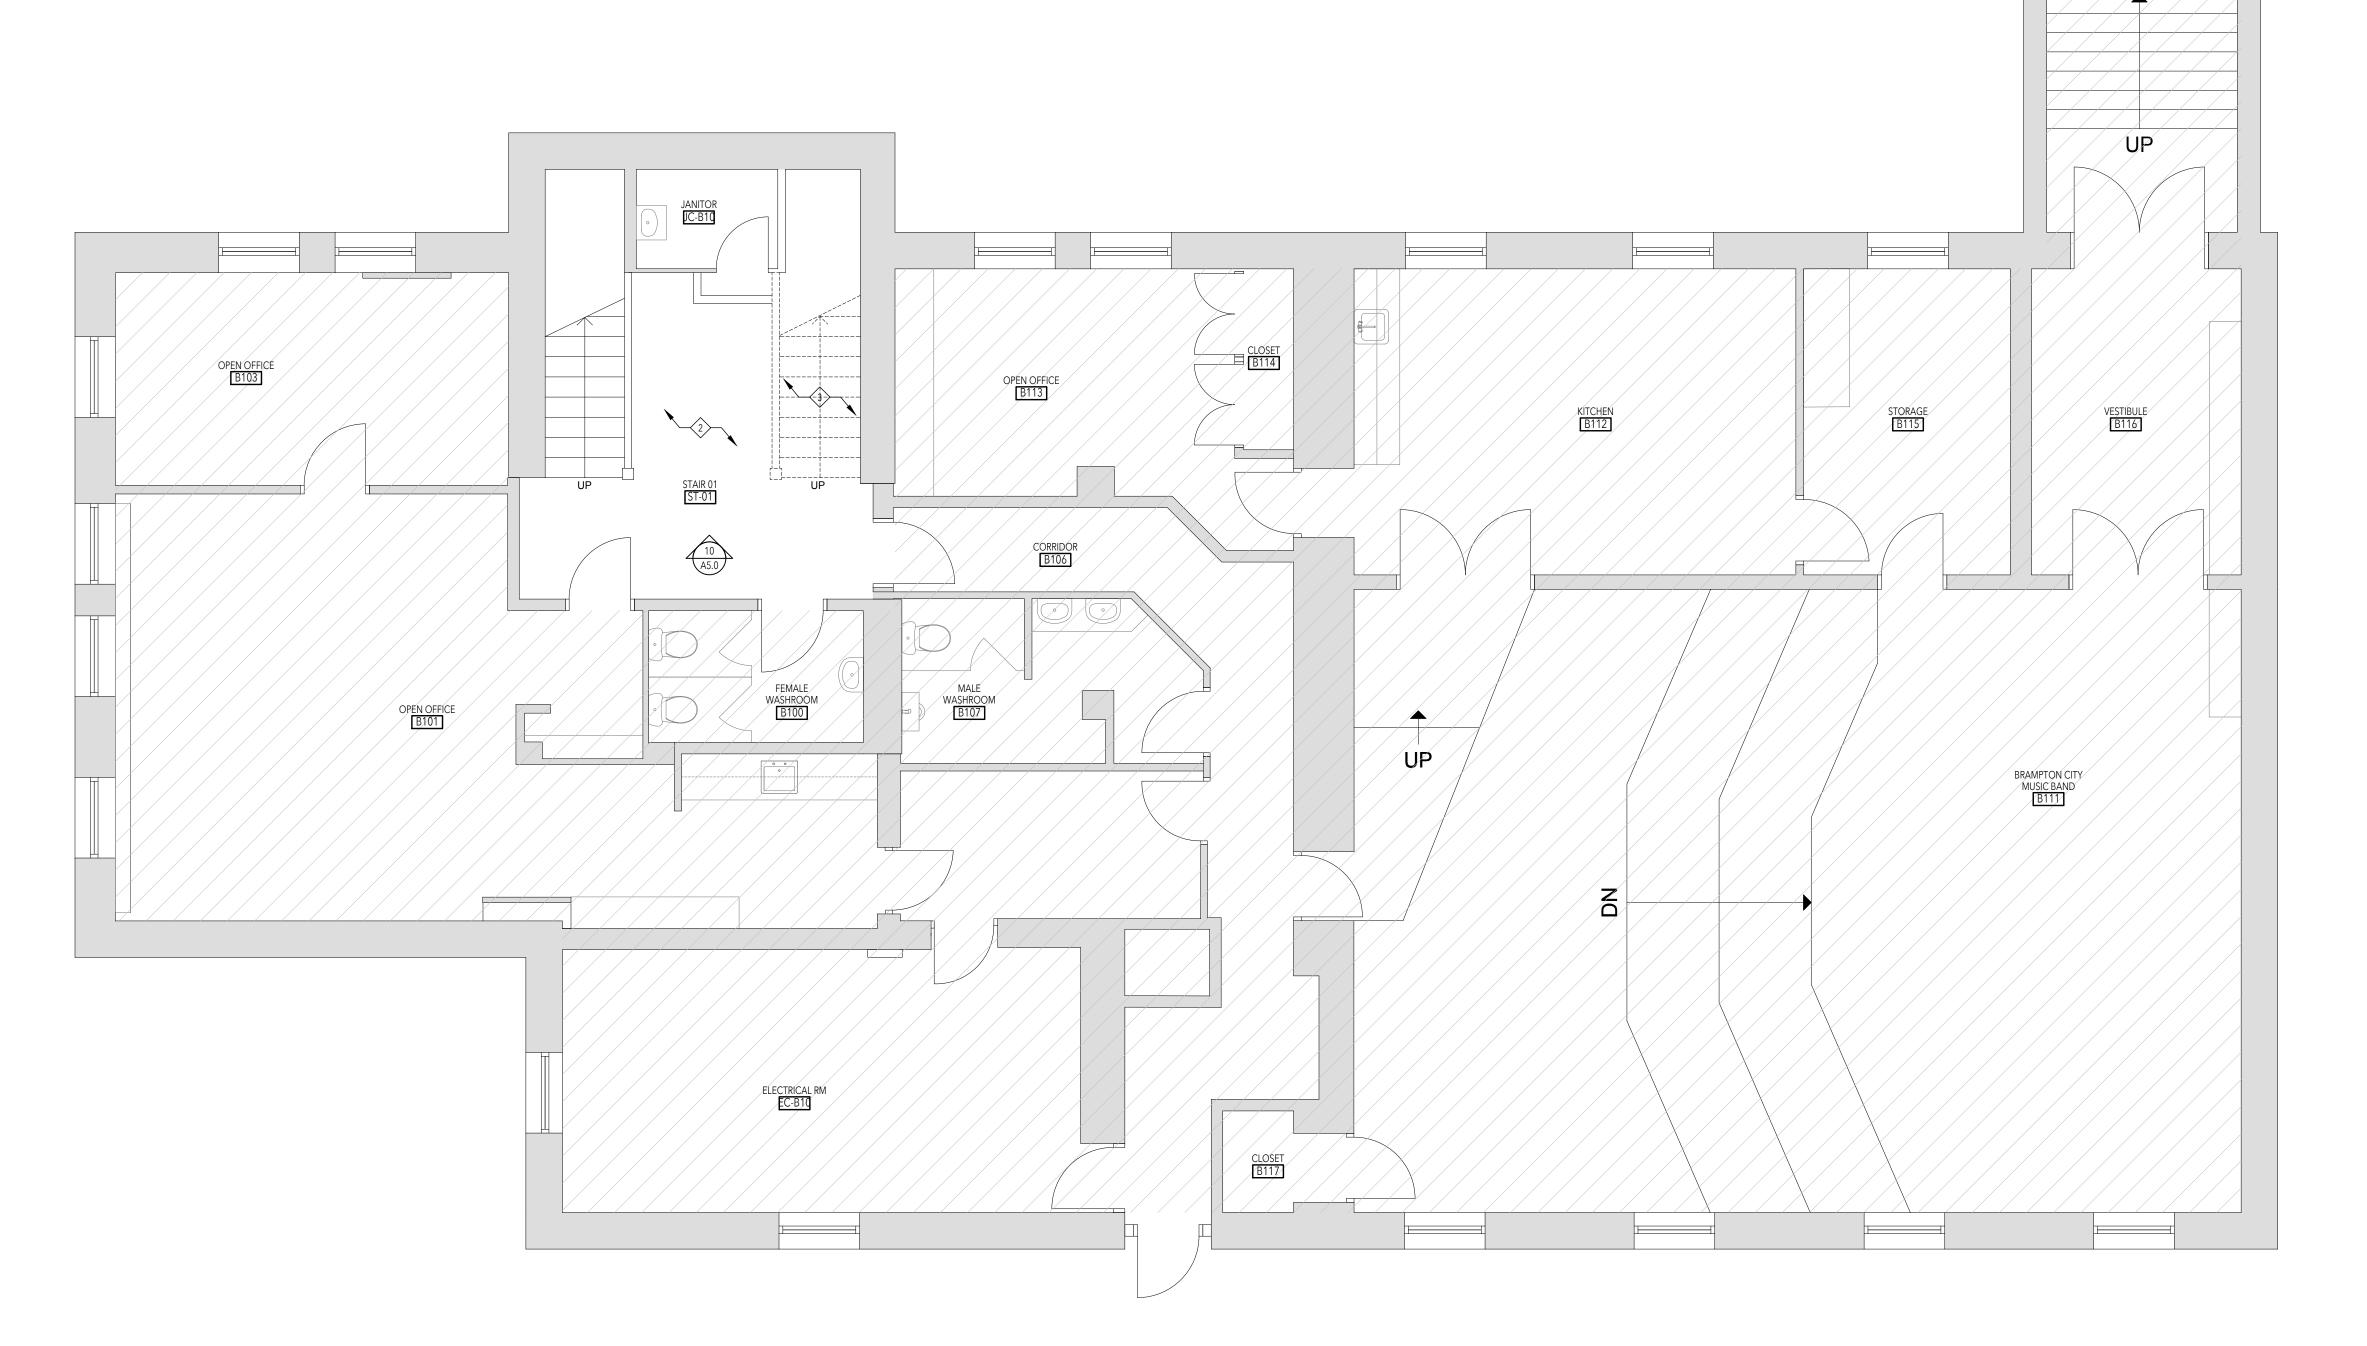





All drawings, specifications, related documents and design are the copyright property of the architect and must be returned upon request. Reproduction of the drawings, specifications, related documents and design in whole or in part is strictly forbidden without the architect's written permission.

This drawing, as an instrument of service, is provided by and is the property of LEBEL & BOULIANE Inc. and shall be used only for the project named on this drawing and solely for reference purposes only. The contractor is responsible for the coordination and verification of all dimensions contained herein and all measurements and conditions on site as they pertain to these documents. The contractor shall report any

This drawing shall not be used for construction purposes unless countersigned LEBEL & BOULIANE.

Seals:

Permit & Tender

**Lorne Scots** Regimental Museum

> Project Address: 55 Queen Street East, Brampton L6W 2A8

> > 24-002

TT

MS

1:50

2024.07.03

2024.07.24

Project No.

Drawn by Reviewed by Scale Plot Date

**BASEMENT DEMOLITION PLAN** 

### GENERAL DEMOLITION NOTES

- PRIOR TO DEMOLITION NOTIFY CONSULTANTS OF ANY
  DISCREPANCIES WITH THE DRAWINGS

  PRIOR TO DEMOLITION COORDINATE WITH MUSEUM HOURS OF
  OPERATION, MATERIAL AND WASTE HANDLING REQUIREMENTS AND
  MATERIAL TO REPLICED.
- OPERATION, MATERIAL AND WASTE HANDLING REQUIREMENTS AND MATERIAL TO BE REUSED.

  3. COORDINATE WITH MUSEUM AND OBTAIN APPROVAL FOR SPECIAL DEMOLITION ACTIVITIES CAUSING DISTURBANCE TO OTHER OCCUPANTS AND SPACES OUTSIDE OF DEMOLITION AREAS.

  4. PROTECT AREA OF WORK, EXISTING CONSTRUCTION TO REMAIN AND ADJACENT AREAS FROM DAMAGE, PROVIDE DUST BARRIER TO ALL AREAS ASSECTED BY THE DEMOLITION PROTECT AND MAINTAIN
- AND ADJACENT TAREAS FROM DAMAGE, PROVIDE DUST BARRIER TO ALL AREAS AFFECTED BY THE DEMOLITION. PROTECT AND MAINTAIN ADJACENT TENANT AREAS.

  5. REFER TO OWNERS DESIGNATED SUBSTANCES REPORT FOR PRE-EXISTING DESIGNATED SUBSTANCES OBSERVED. REPORT ANY FINDING OF DESIGNATED SUBSTANCES DISCOVERED DURING DEMOLITION.
- FINDING OF DESIGNATED SUBSTANCES DISCOVERED DURING DEMOLITION.

  6. REMOVE ALL UNUSED HANGERS, FASTENERS, LOOSE PAINT, DEBRIS ETC FROM EXISTING WALLS AND CEILINGS TO REMAIN. PATCH AND REPAIR TO PREP FOR PAINTING OR FUTURE WORK.

  7. REMOVE ALL EXISTING LIGHTING FIXTURES AND ANY ASSOCIATED SENSORS, HANGERS, HARDWARE, CONDUIT AND WIRING NOT REQUIRED FOR INSTALLATION OF NEW FIXTURES. RETAIN POWER SUPPLY FOR FUTURE LIGHTING. REF RCPS AND ELECTRICAL DRAWINGS FOR ADDITIONAL INFORMATION

  8. ALL BUILDING-WIDE LIFE SAFETY SYSTEMS INCLUDING FIRE ALARMS, EXIT SIGNS, AND EMERGENCY LIGHT SYSTEMS TO REMAIN INTACT AND FUNCTIONAL DURING DEMOLITION

  9. MECHANICAL AND ELECTRICAL SYSTEMS WITHIN ADJACENT OCCUPIED AREAS ARE TO REMAIN INTACT AND FUNCTIONAL DURING

- OCCUPIED AREAS ARE TO REMAIN INTACT AND FUNCTIONAL DURING DEMOLITION

  10. REF MECHANICAL AND ELECTRICAL DRAWINGS FOR SCOPE OF

- 10. REF MECHANICAL AND ELECTRICAL DRAWINGS FOR SCOPE OF MECHANICAL / ELECTRICAL DEMOLITION

  11. REMOVE AND RETURN TO OWNER OR TENANT WASTE & DISPOSAL SYSTEMS, SANITIZERS, FIRE EXTINGUISHERS & OTHER MISC. ACCESSORIES AND EQUIPMENT. DEMOLISH OR REMOVE FROM SITE IF NOT USED. OWNER/TENANT APPROVAL REQUIRED.

  12. MAKE GOOD ALL EXISTING WALLS TO REMAIN. PATCH ALL DAMAGES TO WALLS/CEILINGS TO ENSURE CONSISTENT SURFACE AND CONTINUITY OF FIRE RATING WHERE OCCURS.

  13. WHERE EXISTING FLOORING IS REMOVED, CONTRACTOR TO COORDINATE WITH FINAL FINISH MATERIAL TO PROVIDE CLEAN AND LEVEL SURFACE TO ACCOMMODATE NEW FLOORING.


### PLAN DEMOLITION KEY NOTES:

DENOTES EXISTING TO REMAIN

DENOTES AREA NOT IN SCOPE OF WORK

DENOTES EXISTING TO BE DEMOLISHED

- REMOVE EXISTING INTERIOR PARTITION OR FURRED OUT WALL TO U/S CEILING OR SLAB. INCLUDING DOOR, FRAMES, DATA AND POWER. PATCH & REPAIR ANY DRYWALL FLOOR AND CEILING DAMAGED BY DEMO AND PREP FOR NEW.
- REMOVE EXISTING FLOORING AND ADHESIVES TO EXTENT REQUIRED TO ACCOMMODATE NEW FLOORING AND NEW PARTITIONS. REFER TO NEW ARCHITECTURAL PLANS.
- REMOVE EXISTING STAIR AND AND HAND RAIL CAREFULLY REMOVE ITEMS AND SALVAGE FOR USE IN NEW STAIR CONSTRUCTION
- REMOVE EXISTING DOOR AND FRAME
- REMOVE PORTION OF EXISTING DECORATIVE GLAZING, SALVGE AND RE-INSTALL, MAY REQUIRE ALTERATION
- REMOVE EXISTING M&E, REFERENCE M&E DRAWINGS
- REMOVE EXISTING PLUMBING, ACCESSORIES AND EQUIPMENT KEEP FOR RE-INSTALLATION TO ACCESSIBILITY STANDARD CODE
- EXISTING LAMP POST TO BE REMOVED
- EXISTING CITY OF BRAMPTON SIGN TO BE REMOVED AND RELOCATED
- REMOVE EXISTING BASEBOARDS (EXTENT THAT IS PART OF NEW BARRIER FREE WASHROOM)

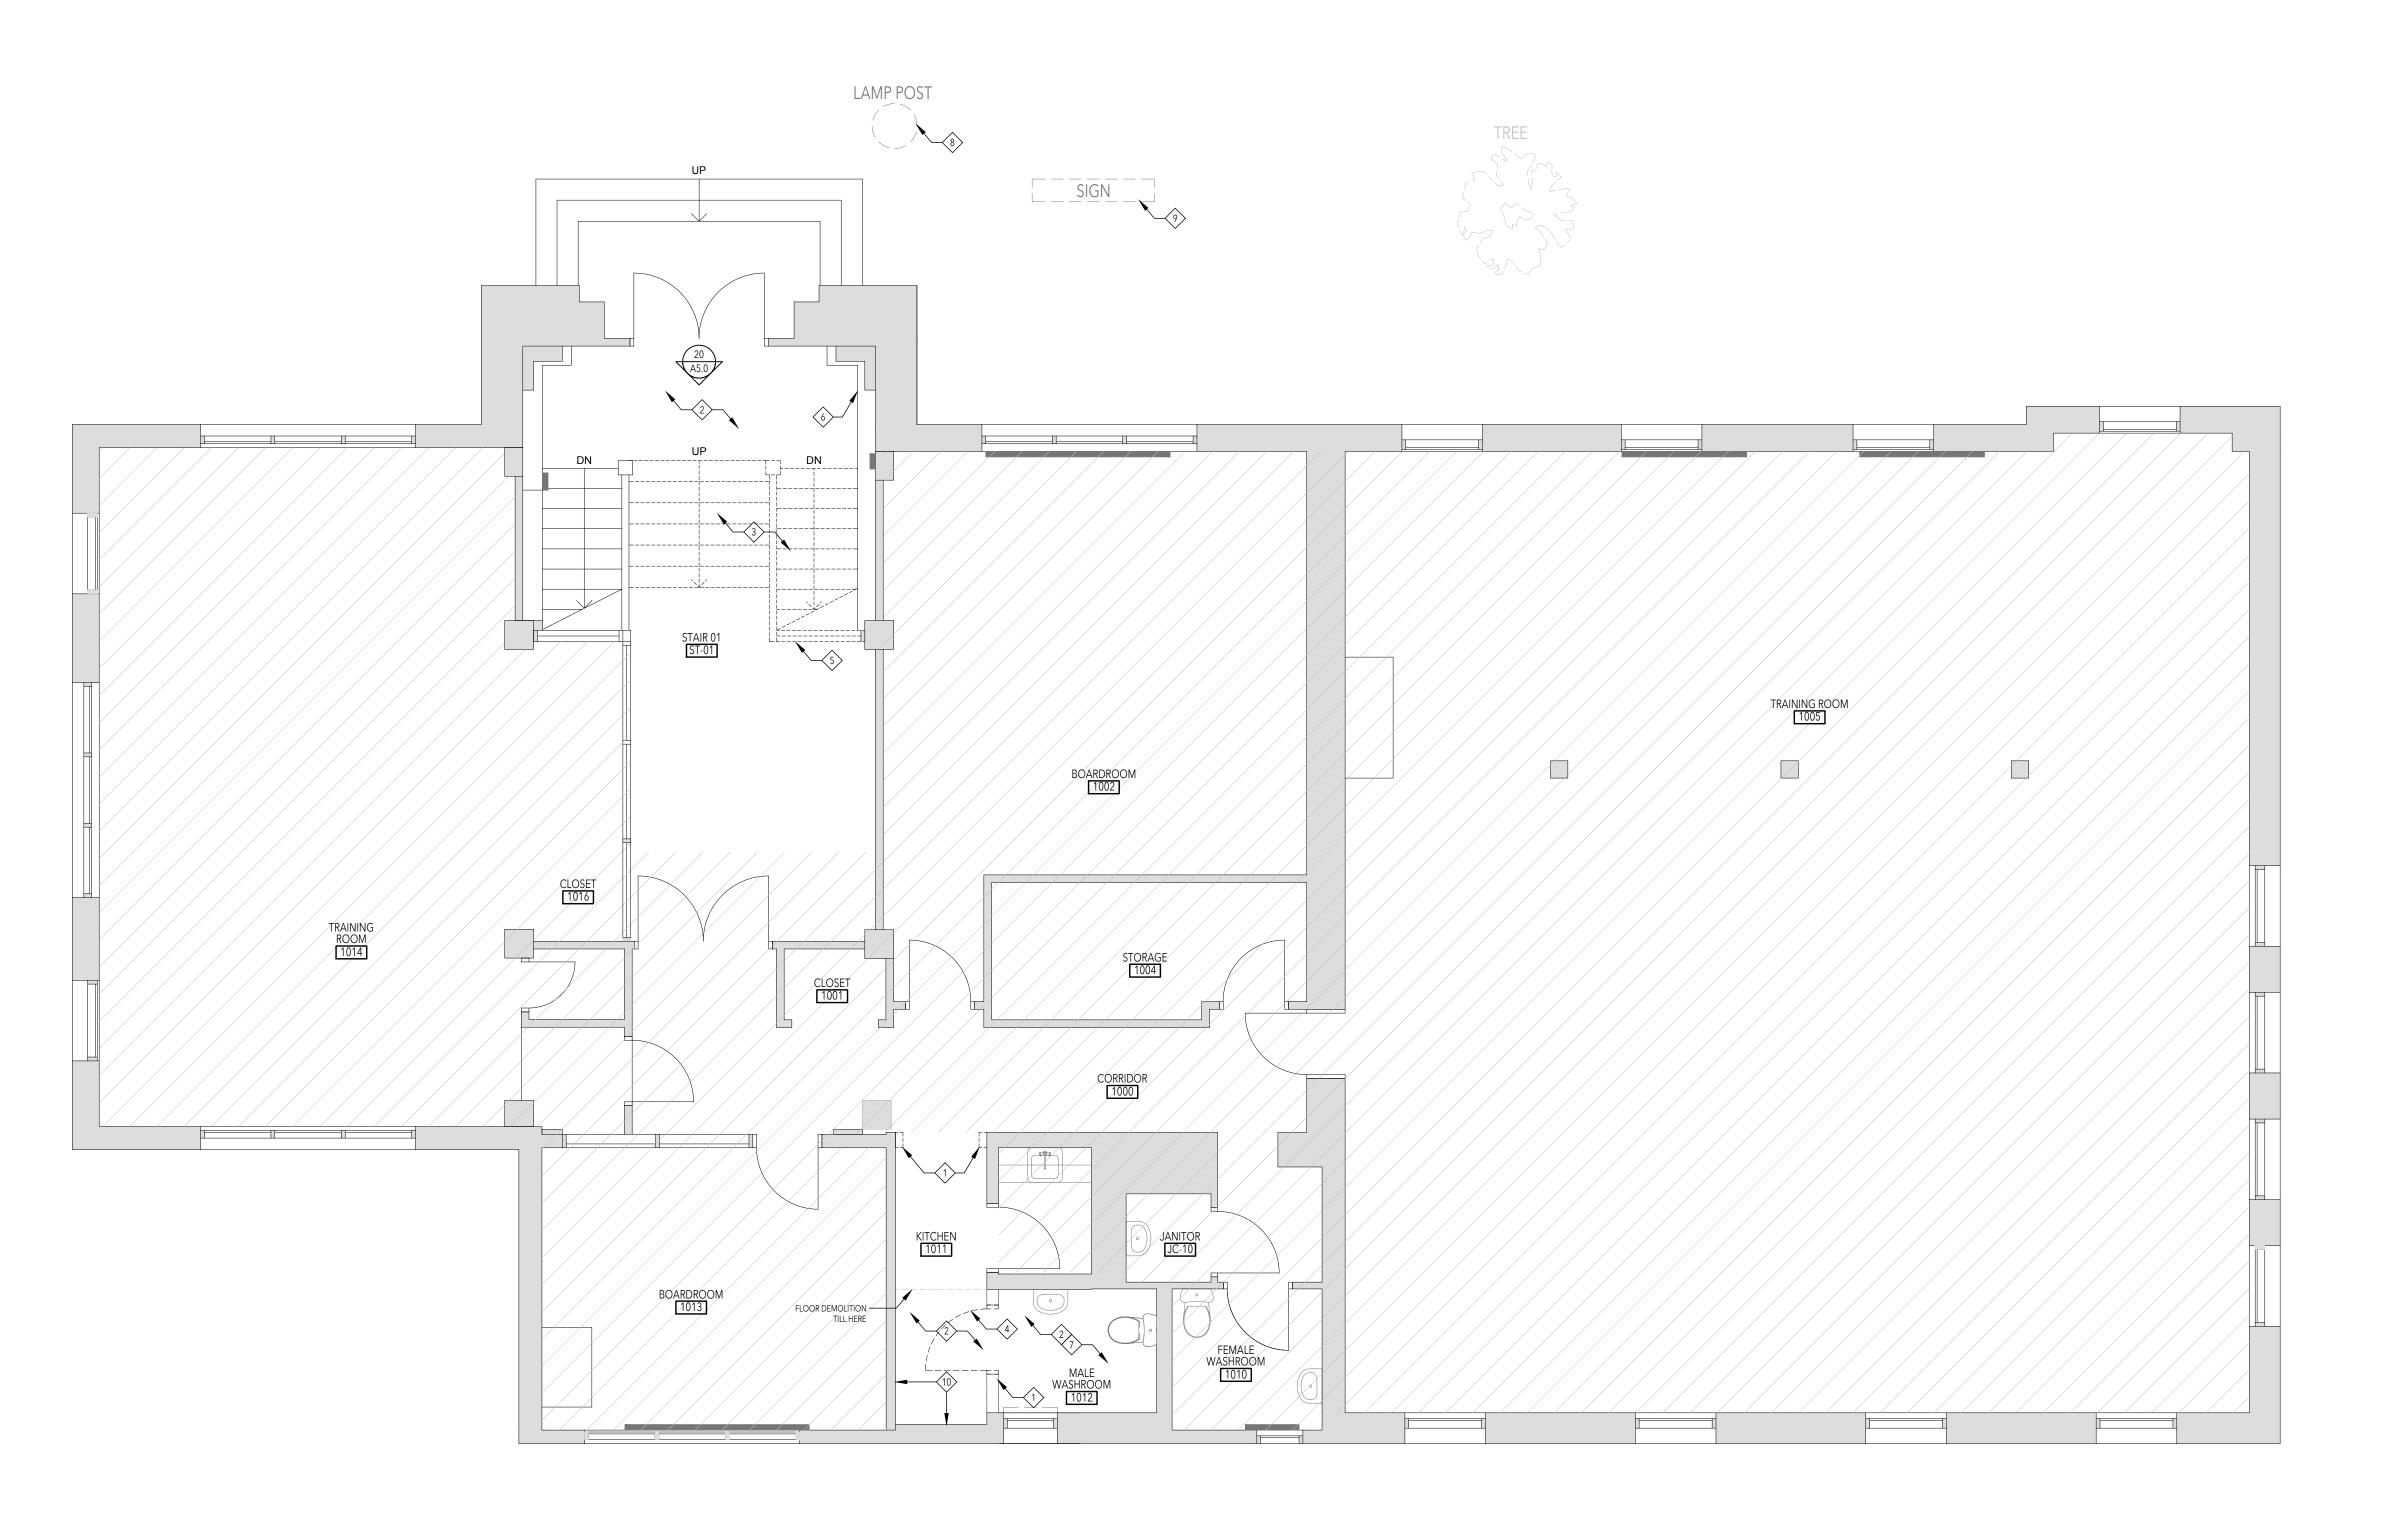





All drawings, specifications, related documents and design are the copyright property of the architect and must be returned upon request. Reproduction of the drawings, specifications, related documents and design in whole or in part is strictly forbidden without the architect's written permission.

This drawing, as an instrument of service, is provided by and is the property of LEBEL & BOULIANE Inc. and shall be used only for the project named on this drawing and solely for reference purposes only. The contractor is responsible for the coordination and verification of all dimensions contained herein and al measurements and conditions on site as they pertain to these documents. The contractor shall report any

Do not scale this drawing

This drawing shall not be used for construction purposes unless countersigned

Seals:

Permit & Tender

**Lorne Scots Regimental Museum** 

2024.07.24

Project Address 55 Queen Street East Brampton L6W 2A8

1:50

2024.07.24

Drawn by

Plot Date

**GROUND FLOOR DEMOLITION PLAN** 

### GENERAL DEMOLITION NOTES - REFLECTED CEILING PLAN

- 1. PRIOR TO DEMOLITION NOTIFY CONSULTANTS OF ANY DISCREPANCIES WITH THE DRAWINGS
  2. PRIOR TO DEMOLITION COORDINATE WITH MUSEUM HOURS OF
- PRIOR TO DEMOLITION COORDINATE WITH MUSEUM HOURS OF OPERATION, MATERIAL AND WASTE HANDLING REQUIREMENTS AND MATERIAL TO BE REUSED.
   COORDINATE WITH MUSEUM AND CITY AND OBTAIN APPROVAL FOR SPECIAL DEMOLITION ACTIVITIES CAUSING DISTURBANCE TO OTHER OCCUPANTS AND SPACES OUTSIDE OF DEMOLITION AREAS.
   PROTECT AREA OF WORK, EXISTING CONSTRUCTION TO REMAIN AND ADJACENT AREAS FROM DAMAGE, INCLUDING BUT NOT LIMITED TO EXISTING MASONRY WALLS IN CORRIDOR, HISTORIC WOOD DOORS, DOOR FRAMES AND TRIM, AND HISTORIC WOOD MILLWORK TO REMAIN AS NOTED IN DRAWINGS.
- DOOR FRAMES AND TRIM, AND HISTORIC WOOD MILLWORK TO REMAIN AS NOTED IN DRAWINGS.

  5. PROVIDE DUST BARRIER TO ALL AREAS AFFECTED BY THE DEMOLITION. PROTECT AND MAINTAIN ADJACENT TENANT AREAS.

  6. REFER TO OWNERS DESIGNATED SUBSTANCES REPORT FOR PRE-EXISTING DESIGNATED SUBSTANCES OBSERVED. REPORT ANY FINDING OF DESIGNATED SUBSTANCES DISCOVERED DURING DEMOLITION.

  7. REMOVE ALL UNUSED HANGERS, FASTENERS, LOOSE PAINT, DEBRIS ETC EPOME EXISTING WALLS AND CEILINGS TO DEMAIN PATCH AND REPAIR
- DEMOLITION.

  7. REMOVE ALL UNUSED HANGERS, FASTENERS, LOOSE PAINT, DEBRIS ETC FROM EXISTING WALLS AND CEILINGS TO REMAIN. PATCH AND REPAIR TO PREP FOR PAINTING OR FUTURE WORK.

  8. REMOVE ALL EXISTING LIGHTING FIXTURES AND ANY ASSOCIATED SENSORS, HANGERS, HARDWARE, CONDUIT AND WIRING NOT REQUIRED FOR INSTALLATION OF NEW FIXTURES. RETAIN POWER SUPPLY FOR FUTURE LIGHTING. REF RCPS AND ELECTRICAL DRAWINGS FOR ADDITIONAL INFORMATION

  9. REMOVE ALL EXISTING EXIT SIGNS. CAP ELECTRICAL WHERE NEW SIGNS ARE NOT REQUIRED.

  10. FIRE ALARM DEVICES TO BE RELOCATED IF REQUIRED

  11. ALL BUILDING-WIDE LIFE SAFETY SYSTEMS INCLUDING FIRE ALARMS, EXIT SIGNS, AND EMERGENCY LIGHT SYSTEMS TO REMAIN INTACT AND FUNCTIONAL DURING DEMOLITION

  12. MECHANICAL AND ELECTRICAL SYSTEMS WITHIN ADJACENT OCCUPIED AREAS ARE TO REMAIN INTACT AND FUNCTIONAL DURING DEMOLITION

  13. REF MECHANICAL AND ELECTRICAL DEMOLITION

  14. REMOVE AND RETURN TO OWNER OR TENANT WASTE & DISPOSAL SYSTEMS, SANITIZERS, FIRE EXTINGUISHERS & OTHER MISC. ACCESSORIES AND EQUIPMENT. DEMOLISH OR REMOVE FROM SITE IF NOT USED. OWNER/TENANT APPROVAL REQUIRED.

  15. MAKE GOOD ALL EXISTING CEILINGS TO REMAIN. PATCH ALL DAMAGES TO CEILINGS TO REMAIN.

### ABBREVIATION & ADDTIONAL NOTES:

- E EXISTING TO REMAIN
  R DENOTES EXISTING TO BE REMOVED
  R/R DENOTES EXISTING TO BE REMOVED AND REPLACED
  R/L DENOTES EXISTING TO BE REMOVED AND RELOCATED

PLAN DEMOLITION KEY NOTES:

DENOTES EXISTING TO REMAIN

DENOTES AREA NOT IN SCOPE OF WORK

REMOVE EXISTING T-BAR GRID, TILES, ASSOCIATED LIGHTING AND REMOVE EXISTING T-BAR GRID, TILES, ASSOCIATED LIGHTING AND MECHANICAL TRIMS-REF MECHANICAL AND ELECTRICAL DRAWINGS FOR RELATED DEMOLITION SCOPE.

WHERE CEILING IS TO BE EXPOSED, CLEAN UP, CUTBACK TO SOURCE, AND BUNCH LOOSE WIRING TO SUIT NEW CEILING LAYOUT. MAINTAIN CONCEALED ROUTING WHERE REQUIRED. CUT BACK MECHANICAL AND DUCTING AS REQUIRED. REMOVE UNWANTED ADHESIVES, FASTENERS AND ANY UNWANTED BUILDING MATERIALS. CLEAN UP CEILING AND PREP ALL EXPOSED AREAS FOR PAINTING. REMOVE EXISTING DRYWALL CEILING AND ASSOCIATED LIGHTING TO

THE EXTENTS REQUIRED TO ACCOMMODATE NEW ACCESSIBLE LIFT PATCH AND REPAIR EDGES TO MEET NEW DRYWALL LIFT SURROUND  $\langle 3 \rangle$ EXISTING LIGHTING TO BE REMOVED AND RELOCATED

REMOVE EXISTING MOULDING, PATCH AND REPAIR WALL








All drawings, specifications, related documents and design are the copyright property of the architect and must be returned upon request. Reproduction of the drawings, specifications, related documents and design in whole or in part is strictly forbidden without the architect's written permission.

This drawing, as an instrument of service, is provided by and is the property of LEBEL & BOULIANE Inc. and shall be used only for the project named on this drawing and solely for reference purposes only. The contractor is responsible for the coordination and verification of all dimensions contained herein and al measurements and conditions on site as they pertain to these documents. The contractor shall report any

This drawing shall not be used for construction purposes unless countersigned

Seals:

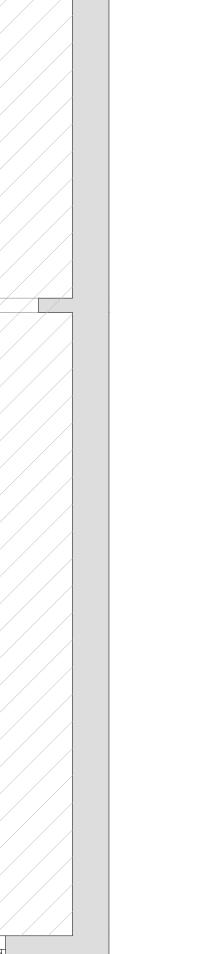

Plot Date

Drawn by

Permit & Tender

**BASEMENT FLOOR DEMOLITION RCP** 

2024.07.24

**Lorne Scots** 

Project Address

1:50

2024.07.04

55 Queen Street East Brampton L6W 2A8

**Regimental Museum** 

#### GENERAL DEMOLITION NOTES - REFLECTED CEILING PLAN

- 1. PRIOR TO DEMOLITION NOTIFY CONSULTANTS OF ANY DISCREPANCIES WITH THE DRAWINGS
  2. PRIOR TO DEMOLITION COORDINATE WITH MUSEUM HOURS OF OPERATION, MATERIAL AND WASTE HANDLING REQUIREMENTS AND MATERIAL TO BE REUSED.
  3. COORDINATE WITH MUSEUM AND CITY AND OBTAIN APPROVAL FOR SPECIAL DEMOLITION ACTIVITIES CAUSING DISTURBANCE TO OTHER OCCUPANTS AND SPACES OUTSIDE OF DEMOLITION AREAS.
  4. PROTECT AREA OF WORK, EXISTING CONSTRUCTION TO REMAIN AND ADJACENT AREAS FROM DAMAGE, INCLUDING BUT NOT LIMITED TO EXISTING MASONRY WALLS IN CORRIDOR, HISTORIC WOOD DOORS, DOOR FRAMES AND TRIM, AND HISTORIC WOOD MILLWORK TO REMAIN AS NOTED IN DRAWNINGS. AS NOTED IN DRAWINGS.

  5. PROVIDE DUST BARRIER TO ALL AREAS AFFECTED BY THE DEMOLITION.
- PROVIDE DUST BARRIER TO ALL AREAS AFFECTED BY THE DEMOCTIC
  PROTECT AND MAINTAIN ADJACENT TENANT AREAS.
   REFER TO OWNERS DESIGNATED SUBSTANCES REPORT FOR
  PRE-EXISTING DESIGNATED SUBSTANCES OBSERVED. REPORT ANY
  FINDING OF DESIGNATED SUBSTANCES DISCOVERED DURING

  OUT OF THE PROPERTY OF THE PROPER

- FINDING OF DESIGNATED SUBSTANCES DISCOVERED DURING DEMOLITION.

  7. REMOVE ALL UNUSED HANGERS, FASTENERS, LOOSE PAINT, DEBRIS ETC FROM EXISTING WALLS AND CEILINGS TO REMAIN. PATCH AND REPAIR TO PREP FOR PAINTING OR FUTURE WORK.

  8. REMOVE ALL EXISTING LIGHTING FIXTURES AND ANY ASSOCIATED SENSORS, HANGERS, HARDWARE, CONDUIT AND WIRING NOT REQUIRED FOR INSTALLATION OF NEW FIXTURES. RETAIN POWER SUPPLY FOR FUTURE LIGHTING. REF RCPS AND ELECTRICAL DRAWINGS FOR ADDITIONAL INFORMATION

  9. REMOVE ALL EXISTING EXIT SIGNS. CAP ELECTRICAL WHERE NEW SIGNS ARE NOT REQUIRED.

  10. FIRE ALARM DEVICES TO BE RELOCATED IF REQUIRED

  11. ALL BUILDING-WIDE LIFE SAFETY SYSTEMS INCLUDING FIRE ALARMS, EXIT SIGNS, AND EMERGENCY LIGHT SYSTEMS TO REMAIN INTACT AND FUNCTIONAL DURING DEMOLITION

  12. MECHANICAL AND ELECTRICAL SYSTEMS WITHIN ADJACENT OCCUPIED AREAS ARE TO REMAIN INTACT AND FUNCTIONAL DURING DEMOLITION

- AREAS ARE TO REMAIN INTACT AND FUNCTIONAL DURING DEMOLITION

  13. REF MECHANICAL AND ELECTRICAL DRAWINGS FOR SCOPE OF
- REF MECHANICAL AND ELECTRICAL DRAWINGS FOR SCOPE OF MECHANICAL / ELECTRICAL DEMOLITION
   REMOVE AND RETURN TO OWNER OR TENANT WASTE & DISPOSAL SYSTEMS, SANITIZERS, FIRE EXTINGUISHERS & OTHER MISC. ACCESSORIES AND EQUIPMENT. DEMOLISH OR REMOVE FROM SITE IF NOT USED. OWNER/TENANT APPROVAL REQUIRED.
   MAKE GOOD ALL EXISTING CEILINGS TO REMAIN. PATCH ALL DAMAGES TO CEILINGS TO ENSURE CONSISTENT SURFACE AND CONTINUITY OF FIRE RATING WHERE OCCURS.
   REMOVE EXISTING TRIMS MOUNTED ON WALLS, UNLESS NOTED OTHERWISE TO REMAIN.

#### ABBREVIATION & ADDTIONAL NOTES:

- E EXISTING TO REMAIN
  R DENOTES EXISTING TO BE REMOVED
  R/R DENOTES EXISTING TO BE REMOVED AND REPLACED
  R/L DENOTES EXISTING TO BE REMOVED AND RELOCATED

PLAN DEMOLITION KEY NOTES:

DENOTES EXISTING TO REMAIN DENOTES AREA NOT IN SCOPE OF WORK

REMOVE EXISTING T-BAR GRID, TILES, ASSOCIATED LIGHTING AND MECHANICAL TRIMS- REF MECHANICAL AND ELECTRICAL DRAWINGS FOR RELATED DEMOLITION SCOPE.

WHERE CEILING IS TO BE EXPOSED, CLEAN UP, CUTBACK TO SOURCE, AND BUNCH LOOSE WIRING TO SUIT NEW CEILING LAYOUT. MAINTAIN CONCEALED ROUTING WHERE REQUIRED. CUT BACK MECHANICAL AND DUCTING AS REQUIRED. REMOVE UNWANTED ADHESIVES, FASTENERS AND ANY UNWANTED BUILDING MATERIALS. CLEAN UP CEILING AND PREP ALL EXPOSED AREAS FOR PAINTING. REMOVE EXISTING DRYWALL CEILING AND ASSOCIATED LIGHTING TO

THE EXTENTS REQUIRED TO ACCOMMODATE NEW ACCESSIBLE LIFT PATCH AND REPAIR EDGES TO MEET NEW DRYWALL LIFT SURROUND EXISTING LIGHTING TO BE REMOVED AND RELOCATED

REMOVE EXISTING MOULDING, PATCH AND REPAIR WALL




All drawings, specifications, related documents and design are the copyright property of the architect and must be returned upon request. Reproduction of the drawings, specifications, related documents and design in whole or in part is strictly forbidden without the architect's written permission.

This drawing, as an instrument of service, is provided by and is the property of LEBEL & BOULIANE Inc. and shall be used only for the project named on this drawing and solely for reference purposes only. The contractor is responsible for the coordination and verification of all dimensions contained herein and al measurements and conditions on site as they pertain to these documents. The contractor shall report any

Do not scale this drawing

This drawing shall not be used for construction purposes unless countersigned

Seals:

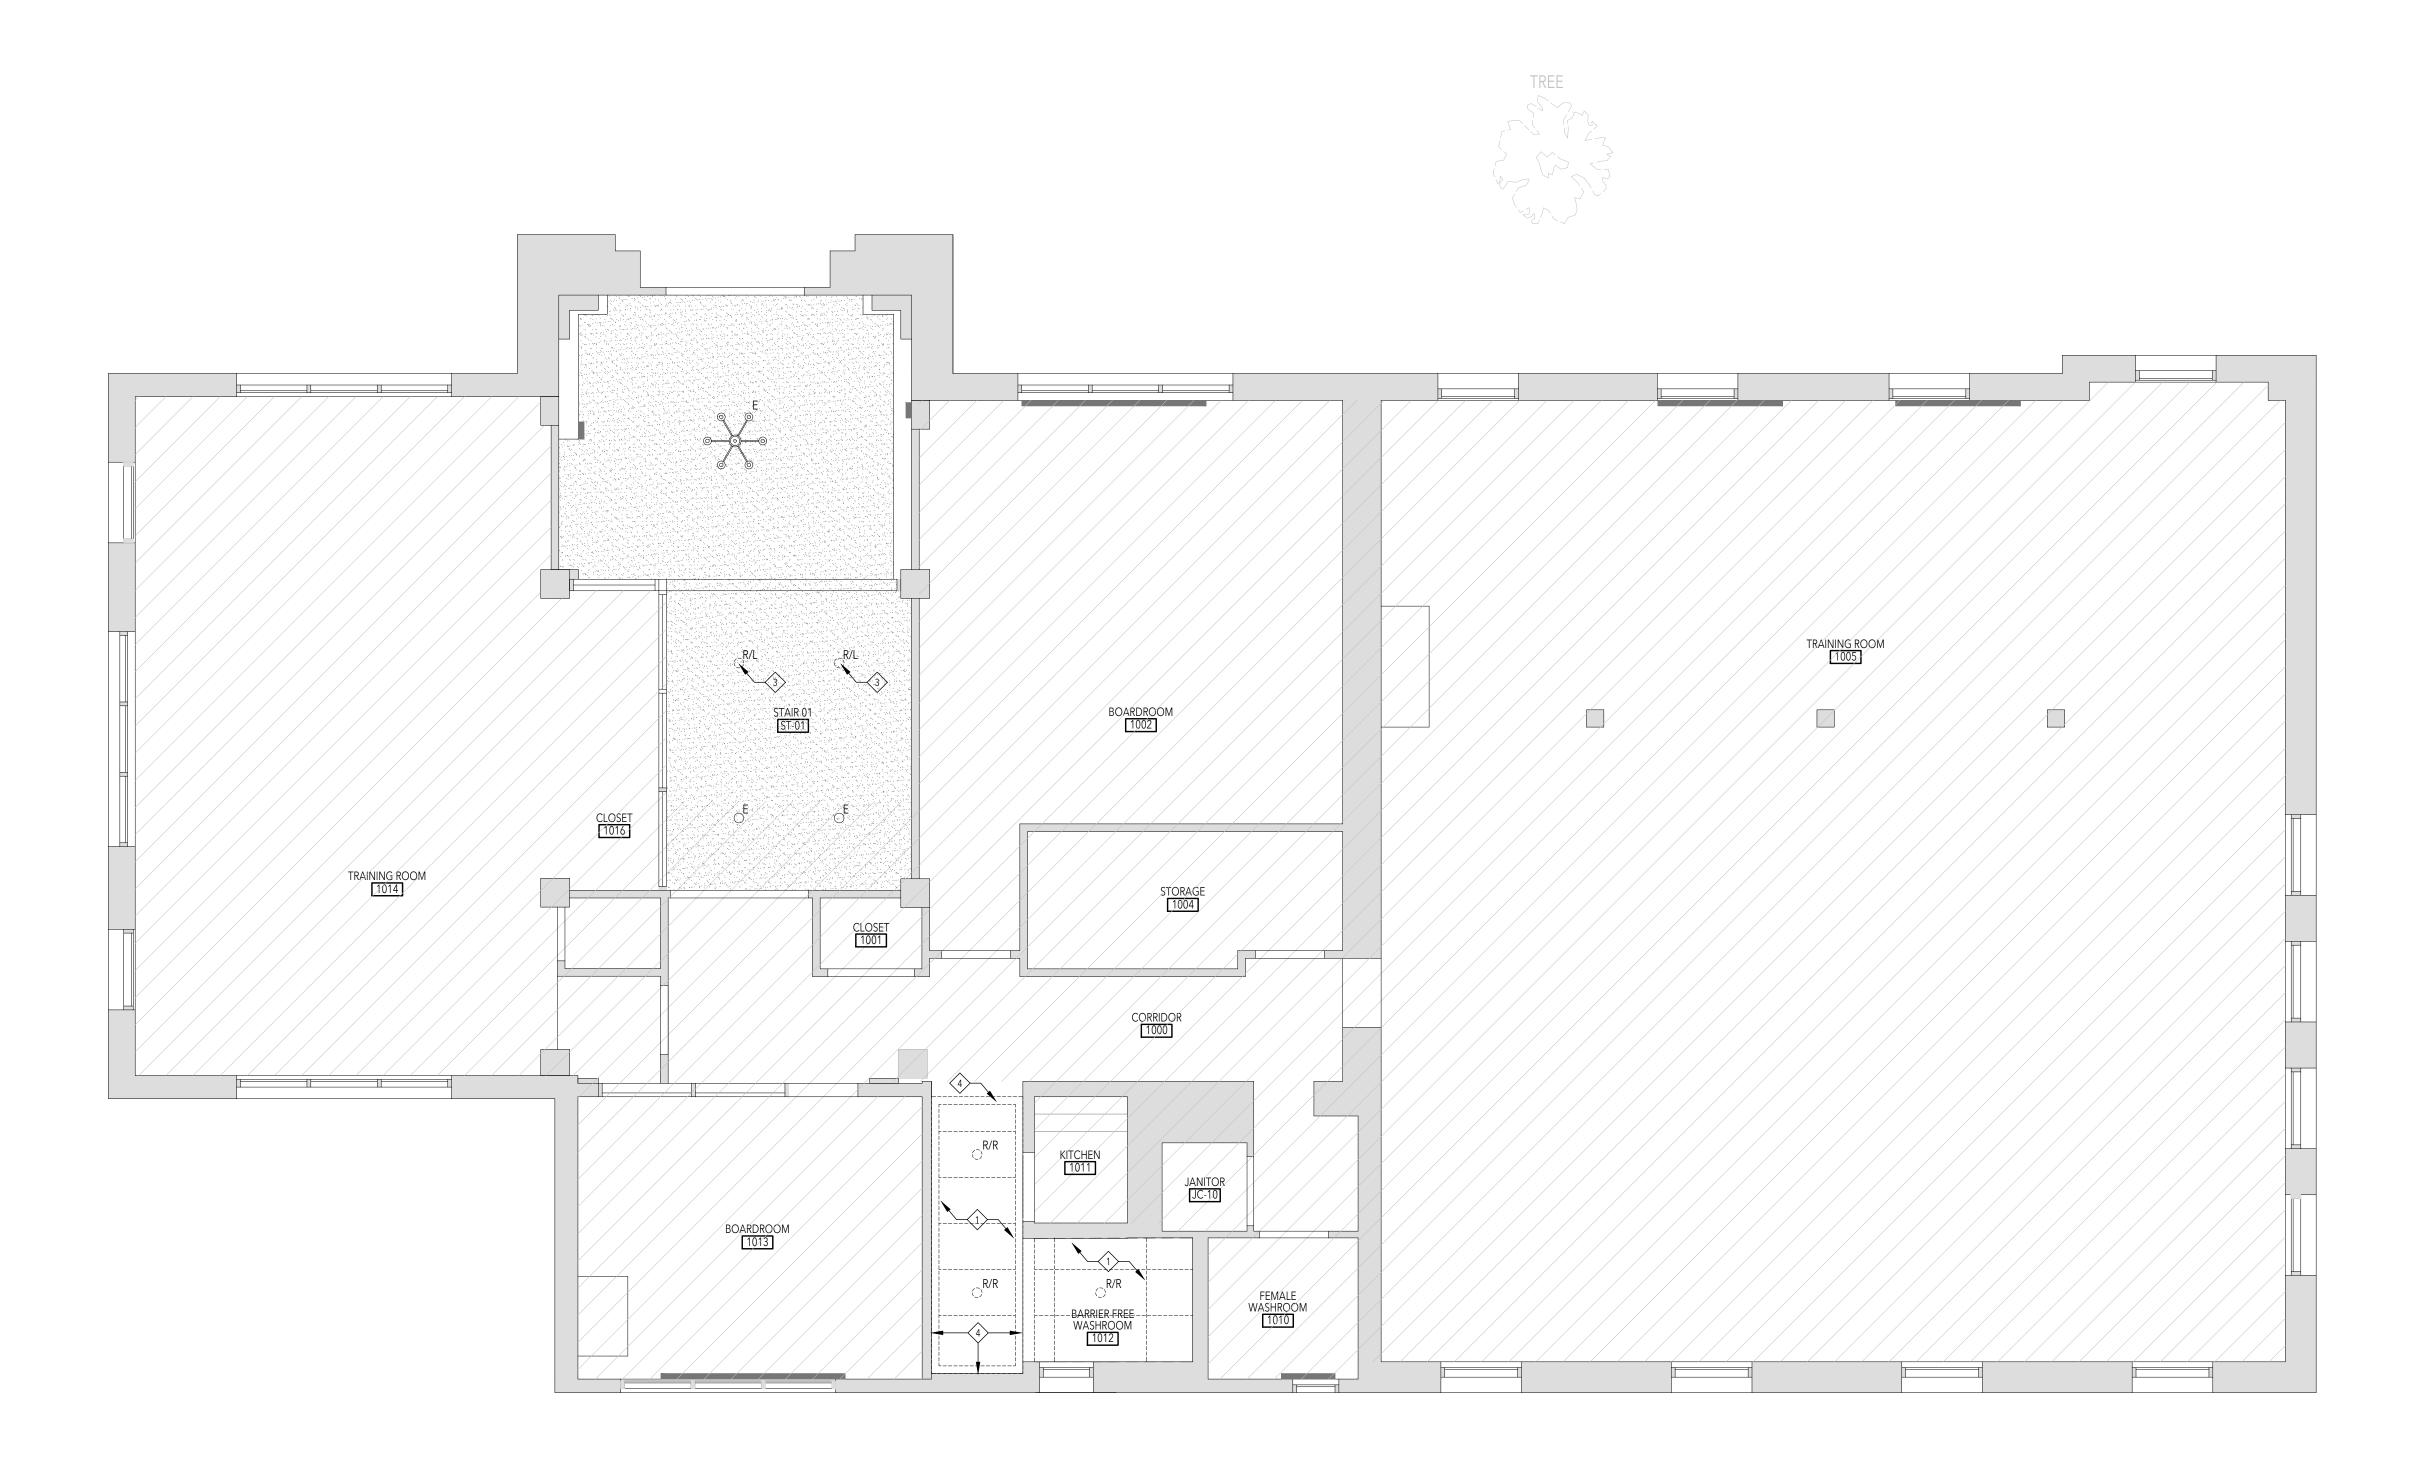



**Lorne Scots Regimental Museum** 

Permit & Tender

Project Address 55 Queen Street East Brampton L6W 2A8

1:50

2024.07.04

2024.07.24

Drawn by Reviewed by Plot Date

**GROUND FLOOR DEMOLITION RCP** 

- WALLS SHOULD EXTEND FROM FLOOR TO UNDERSIDE OF SLAB ABOVE.
   ANY PENETRATIONS THROUGH WALL SHOULD BE OVERSIZED, FILLED WITH BATT INSULATION AND SEALED WITH NON-HARDENING ACOUSTIC CAULK WITH A MINIMUM MOVEMENT CAPABILITY OF +/-25%. REFER TO INTERIOR DETAILS.
- DETAILS.
  2. REFER TO STRUCTURAL, MECHANICAL AND ELECTRICAL DRAWINGS FOR
- ADDITIONAL REQUIREMENTS.

  3. AT LOCATIONS WHERE MECHANICAL DUCTS INTERFERE WITH FULL HEIGHT CONSTRUCTION OF INTERIOR PARTITIONS, OFFSET PARTITION ABOVE CEILING AND BRACE AS REQUIRED. MAINTAIN FIRE SEPARATION/SOUND RATING OF PARTITION. OFFSETTING OF PARTITIONS WILL ONLY BE PERMITTED WHERE DUCTWORK CAN NOT BE POSITIONED.
- 4. ALL DIMENSIONS ARE TAKEN TO FACE OF MASONRY OR CONCRETE AT MASONRY AND CONCRETE WALLS AND PARTITIONS. AT STEEL STUD PARTITIONS, DIMENSIONS ARE TAKEN TO FINISHED FACE OF PARTITION, UNLESS OTHERWISE NOTED.
- MAKE GOOD ALL EXISTING DRYWALL TO REMAIN.
   ALL EXISTING FIRE RATED ASSEMBLIES TO MAINTAIN EXISTING RATING.
- 7. PROVIDE BLOCKING AS REQUIRED AT ALL WALL MOUNTED EQUIPMENT
  AND ACCESSORIES

  8. UNLESS OTHERWISE NOTED, DOOR OPENINGS ARE 101mm FROM
- ADJACENT RETURN WALL.

  9. WHERE LOCATED AGAINST WALL PAINTED TO PT1, WALL PLATES,

RECEPTACLES, DATA OUTLETS ETC TO BE PROVIDED IN WHITE. .

# LEGEND

DENOTES EXISTING TO REMAIN

GENERAL: INDICATES AREA NOT IN SCOPE

NEW CONSTRUCTION

DOOR TAG

PARTITION TAG

DO DOOR OPERATOR (COORDINATE WITH ELECTRICAL)

#### PLAN KEY NOTI

- PROVIDE BLOCKING AS NECESSARY FOR WALL MOUNTED EQUIPMENT/ACCESSORIES/PLUMBING FIXTURES
- MAKE GOOD EXISTING WALL, PREPARE FOR PAINT FINISH BENJAMIN MOORE CC-30 OXFORD WHITE
- NEW GWB AND WALL BASE TO MATCH BENJAMIN MOORE CC-30 OXFORD WHITE
- NEW ACCESSIBLE LIFT WITH GWB SURROUND, REFERENCE ELECTRICAL / MECHANICAL AND STRUCTURAL DRAWINGS FOR FURTHER DETAILS
- NEW RECONSTRUCTED STAIR AND HANDRAIL, MADE FROM REMOVED EXISTING STAIR AND TO MATCH DESIGN OF EXISTING STAIR
- NEW AUTO DOOR OPERATOR, REFERENCE ELECTRICAL DRAWINGS FOR ADDITIONAL INFORMATION
- 7 NEW ACCESSIBLE RAMP, REFERENCE STRUCTURAL DRAWINGS FOR ADDITIONAL INFORMATION
- NEW EXTERIOR LIGHT POST, REFERENCE ELECTRICAL DRAWINGS FOR
- 9 NEW VINYL FLOORING: TARKETT ACCZENT CONCRETE COOL GREY
- EXISTING PLUMBING / ACCESSORIES AND EQUIPMENT TO BE RE-INSTALLED IN ACCORDANCE WITH ACCESSIBILITY GUIDELINES
- EXISTING STAIRS TO BE WIDENED THROUGH NEW INFILL, REFERENCE STRUCTURAL DRAWINGS FOR ADDITIONAL INFORMATION
- 2) EXISTING DOOR AND FRAME TO BE RELOCATED

ADDITIONAL INFORMATION

- EXISTING CITY SIGNAGE TO BE RELOCATED TO ACCOMMODATE RAMP
- 14 RELOCATED EXISTING RADIATOR
- NEW WALKOFF CARPET FLOORING: BURMATEX GRIMEBUSTER NEWMARKET GREY




All drawings, specifications, related documents and design are the copyright property of the architect and must be returned upon request. Reproduction of the drawings, specifications, related documents and design in whole or in part is strictly forbidden without the architect's written permission.

This drawing, as an instrument of service, is provided by and is the property of LEBEL & BOULIANE Inc. and shall be used only for the project named on this drawing and solely for reference purposes only. The contractor is responsible for the coordination and verification of all dimensions contained herein and all measurements and conditions on site as they pertain to these documents. The contractor shall report any discrepancies to the consultant in writing prior to the commencement of any affected work.

This drawing shall not be used for construction purposes unless countersigned

\_\_\_\_

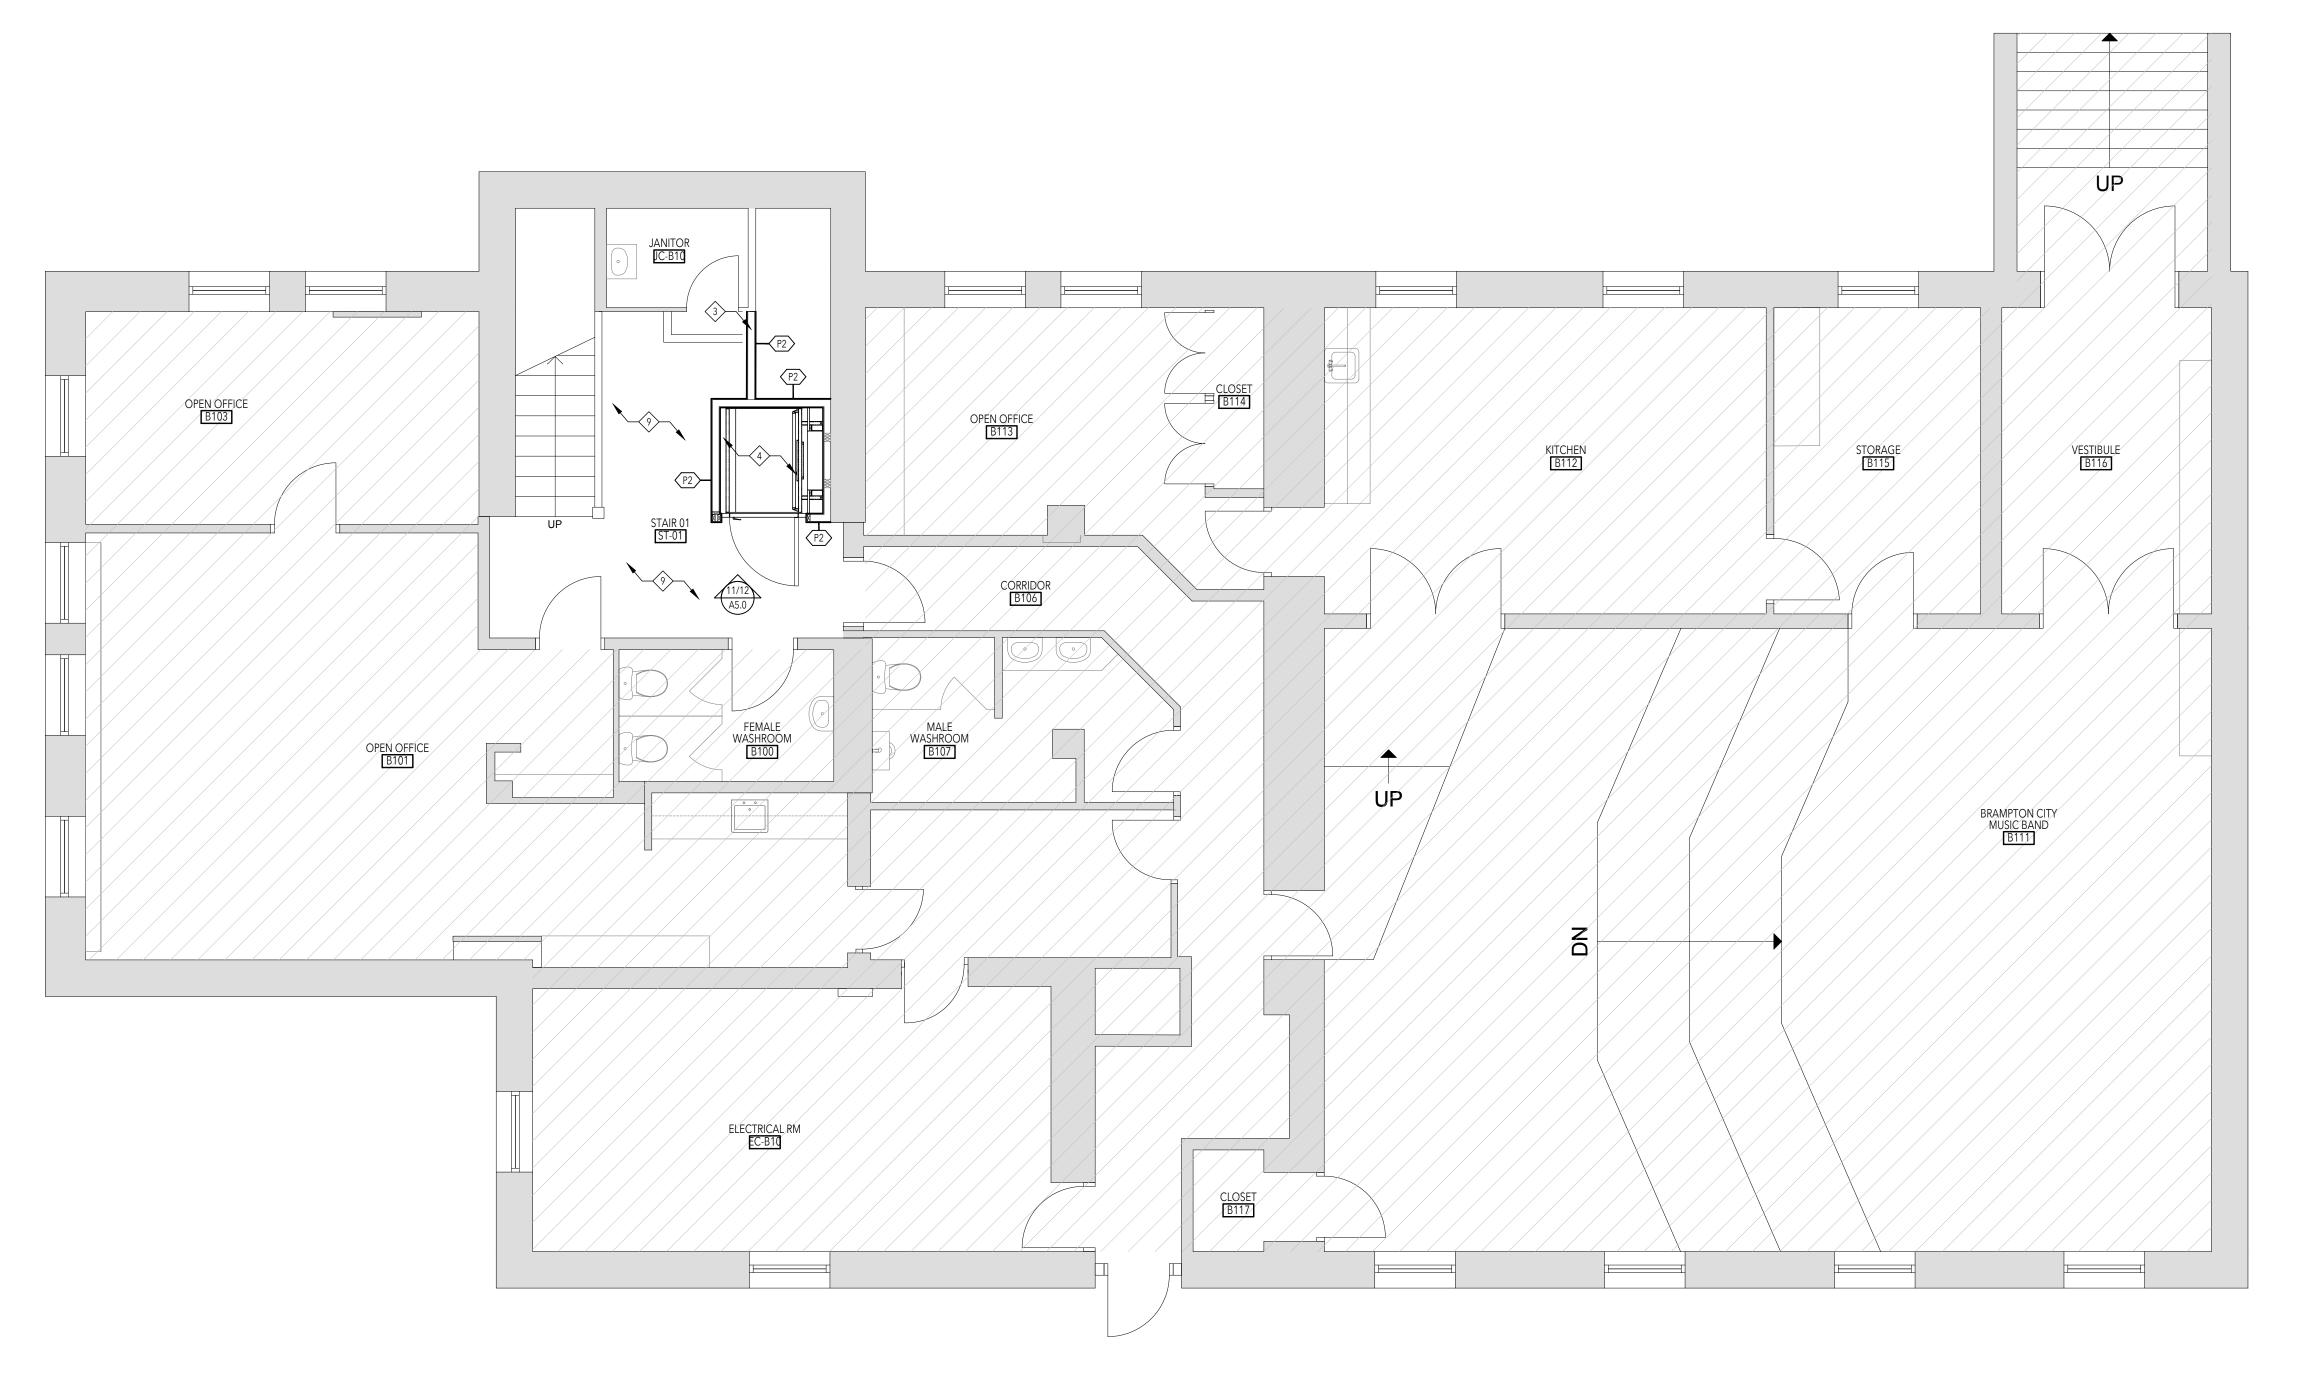



01 Permit & TenderNo. Issued for

Lorne Scots Regimental Museum

2024.07.24

Project Address: 55 Queen Street East, Brampton L6W 2A8

24-002

2024.07.23



Project No.
Drawn by
Reviewed by
Scale
Plot Date

BASEMENT FLOOR PLAN

Drawing No:

- WALLS SHOULD EXTEND FROM FLOOR TO UNDERSIDE OF SLAB ABOVE.
   ANY PENETRATIONS THROUGH WALL SHOULD BE OVERSIZED, FILLED WITH
   BATT INSULATION AND SEALED WITH NON-HARDENING ACOUSTIC CAULK
   WITH A MINIMUM MOVEMENT CAPABILITY OF +/-25%. REFER TO INTERIOR
- DETAILS.

  2. REFER TO STRUCTURAL, MECHANICAL AND ELECTRICAL DRAWINGS FOR
- ADDITIONAL REQUIREMENTS.

  3. AT LOCATIONS WHERE MECHANICAL DUCTS INTERFERE WITH FULL HEIGHT CONSTRUCTION OF INTERIOR PARTITIONS, OFFSET PARTITION ABOVE CEILING AND BRACE AS REQUIRED. MAINTAIN FIRE SEPARATION/SOUND RATING OF PARTITION. OFFSETTING OF PARTITIONS WILL ONLY BE PERMITTED WHERE DUCTWORK CAN NOT BE POSITIONED.
- 4. ALL DIMENSIONS ARE TAKEN TO FACE OF MASONRY OR CONCRETE AT MASONRY AND CONCRETE WALLS AND PARTITIONS. AT STEEL STUD PARTITIONS, DIMENSIONS ARE TAKEN TO FINISHED FACE OF PARTITION, UNLESS OTHERWISE NOTED.
- 5. MAKE GOOD ALL EXISTING DRYWALL TO REMAIN.6. ALL EXISTING FIRE RATED ASSEMBLIES TO MAINTAIN EXISTING RATING.
- PROVIDE BLOCKING AS REQUIRED AT ALL WALL MOUNTED EQUIPMENT
   AND ACCESSORIES
- 8. UNLESS OTHERWISE NOTED, DOOR OPENINGS ARE 101mm FROM ADJACENT RETURN WALL.

  9. WHERE LOCATED AGAINST WALL PAINTED TO PT1, WALL PLATES, RECEPTACLES, DATA OUTLETS ETC TO BE PROVIDED IN WHITE. .

LEGEND

DENOTES EXISTING TO REMAIN

GENERAL: INDICATES AREA NOT IN SCOPE

NEW CONSTRUCTION

DOOR TAG

PARTITION TAG

DO DOOR OPERATOR (COORDINATE WITH ELECTRICAL)

PLAN KEY NOTES

PROVIDE BLOCKING AS NECESSARY FOR WALL MOUNTED EQUIPMENT/ACCESSORIES/PLUMBING FIXTURES

2 MAKE GOOD EXISTING WALL, PREPARE FOR PAINT FINISH BENJAMIN MOORE CC-30 OXFORD WHITE

NEW GWB AND WALL BASE TO MATCH
BENJAMIN MOORE CC-30 OXFORD WHIT

NEW ACCESSIBLE LIFT WITH GWB SURROUND, REFERENCE ELECTRICAL / MECHANICAL AND STRUCTURAL DRAWINGS FOR FURTHER DETAILS

NEW RECONSTRUCTED STAIR AND HANDRAIL, MADE FROM REMOVED EXISTING STAIR AND TO MATCH DESIGN OF EXISTING STAIR

6 NEW AUTO DOOR OPERATOR, REFERENCE ELECTRICAL DRAWINGS FOR ADDITIONAL INFORMATION

NEW ACCESSIBLE RAMP, REFERENCE STRUCTURAL DRAWINGS FOR ADDITIONAL INFORMATION

NEW EXTERIOR LIGHT POST, REFERENCE ELECTRICAL DRAWINGS FOR

9 NEW VINYL FLOORING: TARKETT ACCZENT CONCRETE COOL GREY

EXISTING PLUMBING / ACCESSORIES AND EQUIPMENT TO BE RE-INSTALLED IN ACCORDANCE WITH ACCESSIBILITY GUIDELINES

EXISTING STAIRS TO BE WIDENED THROUGH NEW INFILL, REFERENCE STRUCTURAL DRAWINGS FOR ADDITIONAL INFORMATION

EXISTING DOOR AND FRAME TO BE RELOCATED

213 EXISTING CITY SIGNAGE TO BE RELOCATED TO ACCOMMODATE RAMP

14 RELOCATED EXISTING RADIATOR

NEW WALKOFF CARPET FLOORING: BURMATEX GRIMEBUSTER NEWMARKET GREY



All drawings, specifications, related documents and design are the copyright property of the architect and must be returned upon request. Reproduction of the drawings, specifications, related documents and design in whole or in part is strictly forbidden without the architect's written permission.


This drawing, as an instrument of service, is provided by and is the property of LEBEL & BOULIANE Inc. and shall be used only for the project named on this drawing and solely for reference purposes only. The contractor is responsible for the coordination and verification of all dimensions contained herein and all measurements and conditions on site as they pertain to these documents. The contractor shall report any discrepancies to the consultant in writing prior to the commencement of any affected work.

Do not scale this drawing

This drawing shall not be used for construction purports.

This drawing shall not be used for construction purposes unless countersigned

Seals:

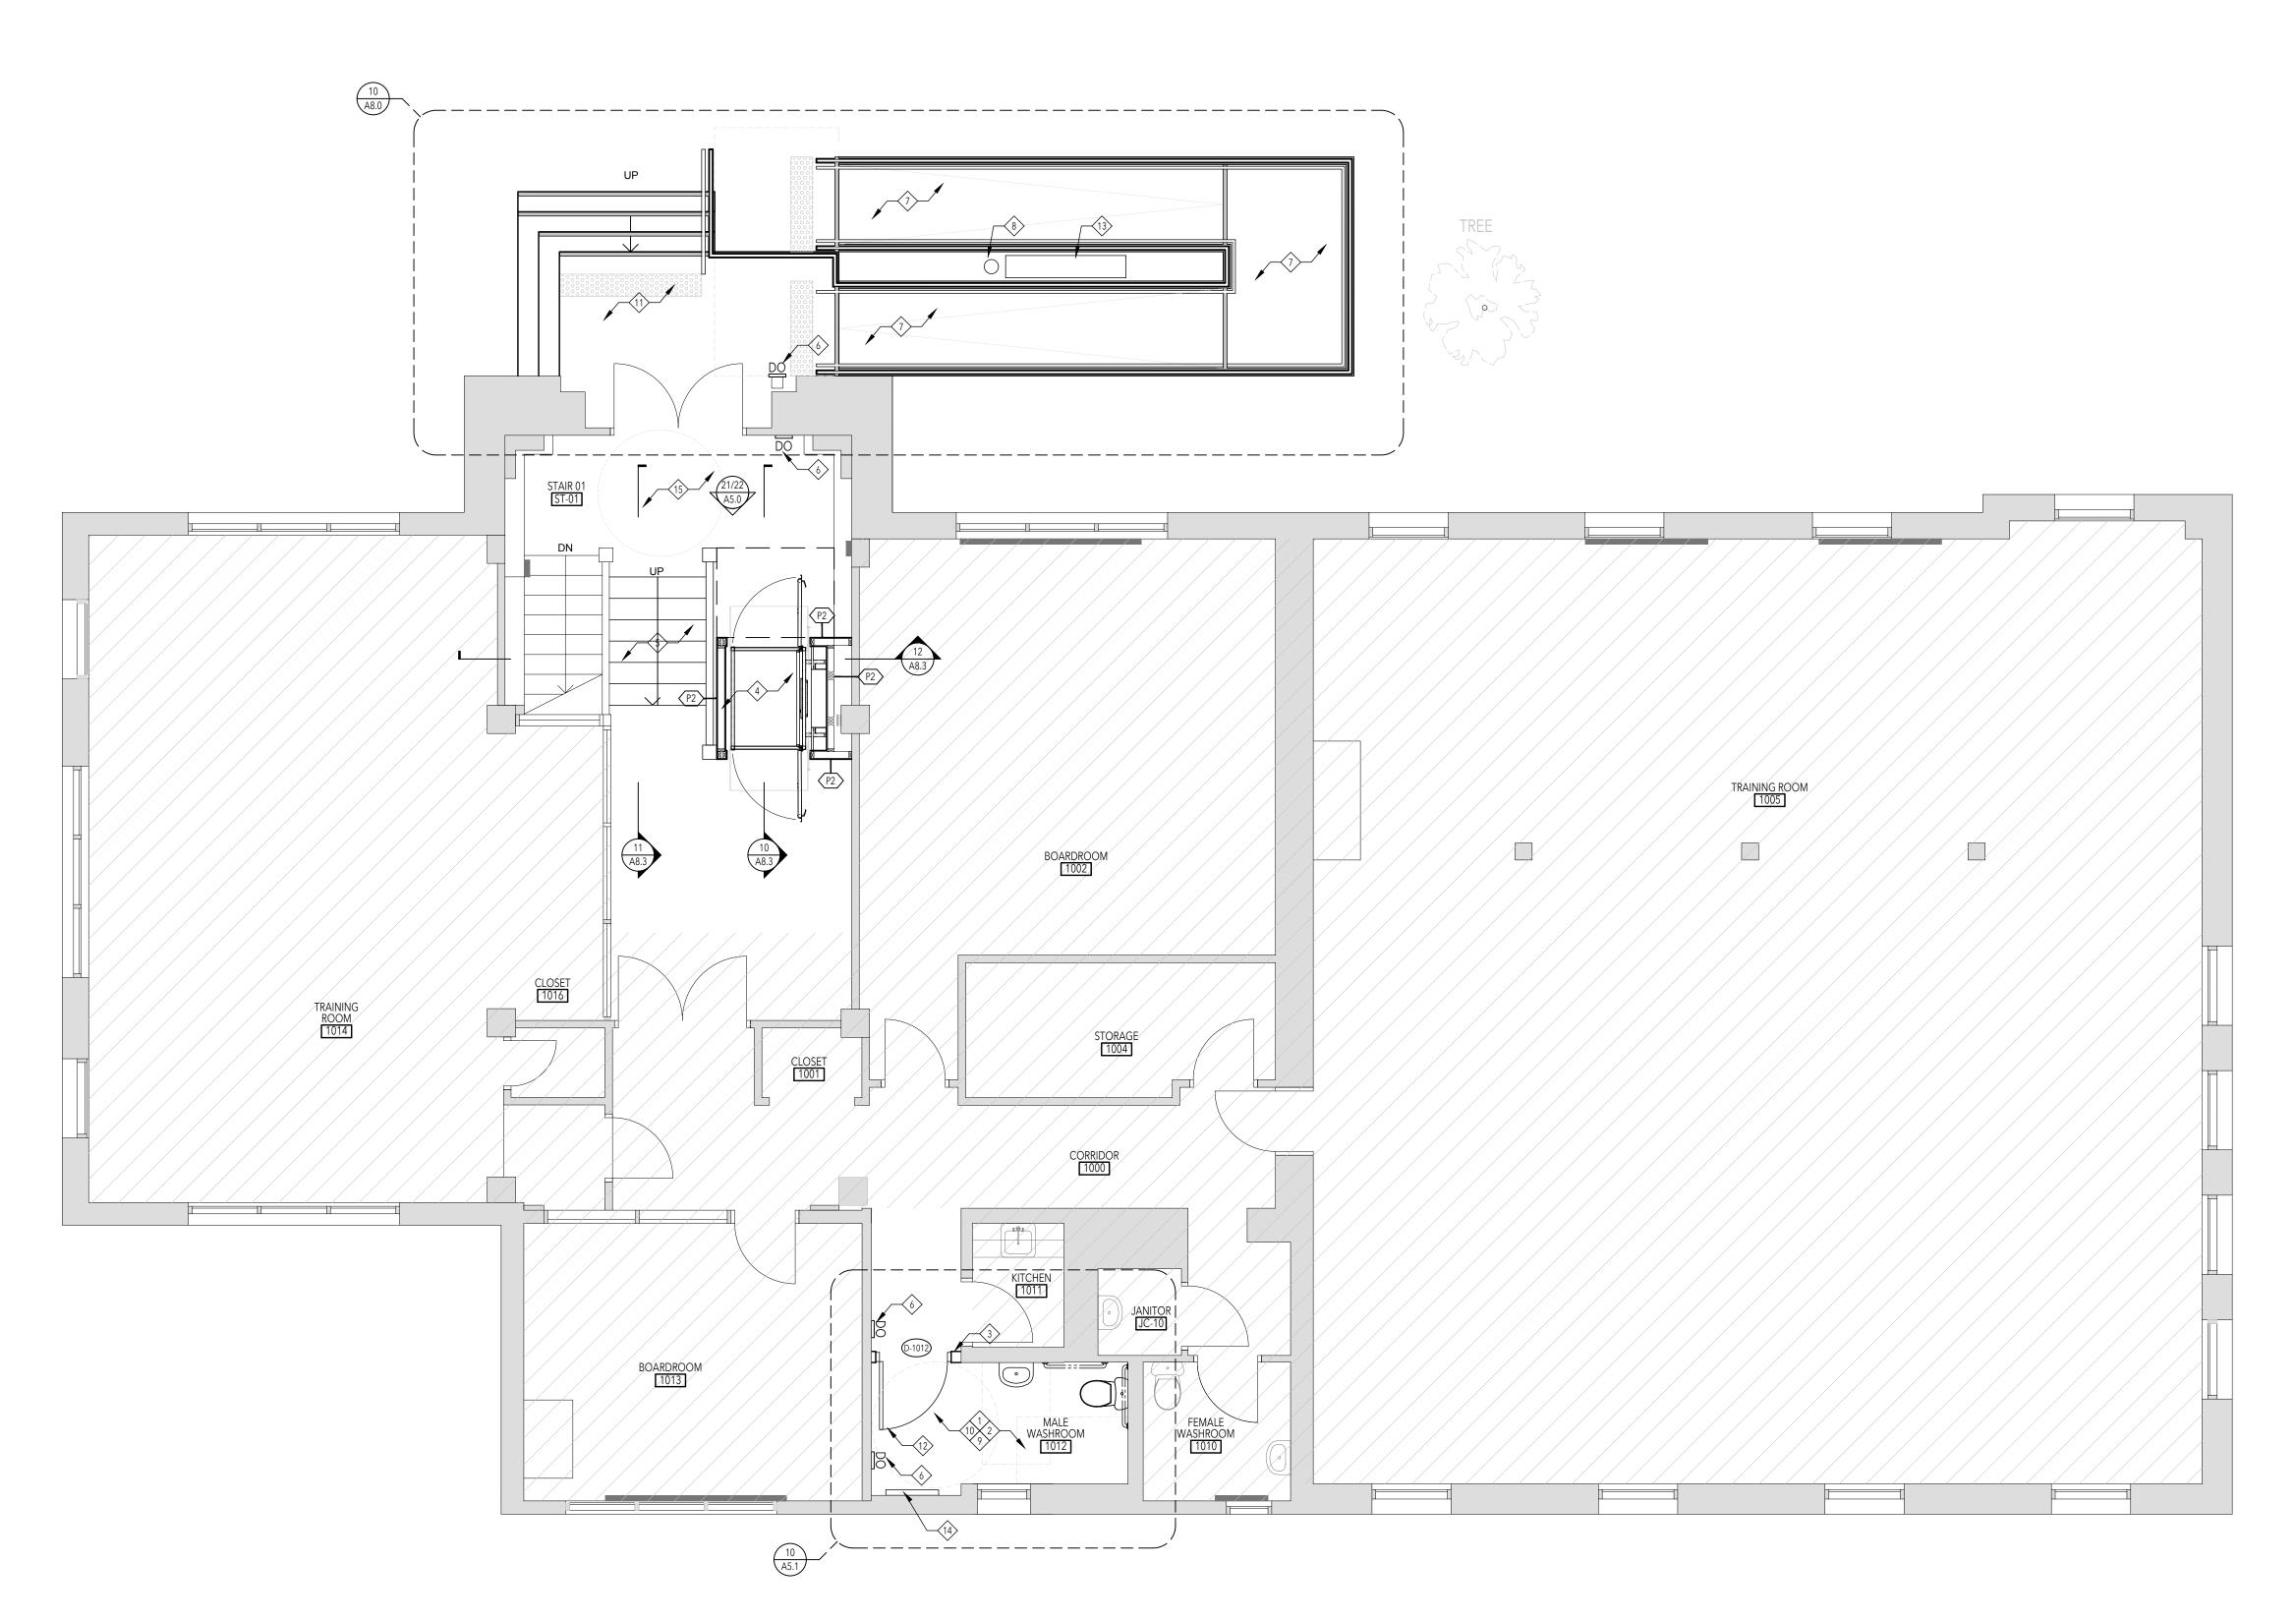



01 Permit & Tender

No. Issued for

Lorne Scots Regimental Museum

> Project Address: 55 Queen Street East, Brampton L6W 2A8

> > 24-002

2024.07.24



Project No.
Drawn by
Reviewed by
Scale
Plot Date

Plot Date 2024.07.23

**GROUND FLOOR PLAN** 

Drawing No.

 MAKE GOOD ALL EXISTING AREAS ADJACENT NEW. 2. ALL CEILING HEIGHT TO MATCH EXISTING CEILING 3. REFER TO MECHANICAL AND ELECTRICAL DRAWINGS FOR ADDITIONAL INFORMATION

ABBREVIATION & ADDTIONAL NOTES:

E EXISTING TO REMAIN
R DENOTES EXISTING TO BE REMOVED
R/R DENOTES EXISTING TO BE REMOVED AND REPLACED
R/L DENOTES EXISTING TO BE REMOVED AND RELOCATED

GENERAL: INDICATES EXISTING TO REMAIN

GENERAL: INDICATES AREA NOT IN SCOPE


# RCP KEYNOTES

EXISTING LIGHTS TO BE RELOCATED, MAKE GOOD DRYWALL CEILING AND PAINT

NEW GWB CEILING HEIGHT TO MATCH EXISTING CEILING HEIGHT PAINTED PT-1 BENJAMIN MOORE CC-30 OXFORD WHITE

EXISTING GWB CEILING TO BE MADE GOOD AND REPAINTED AFTER ACCOMMODATION OF NEW ACCESSIBLE LIFT NEW TRIM TO MATCH EXISTING CEILING

NEW L1 LIGHT : SIGMA 2 LITELINE, WHITE RECESSED 3000K

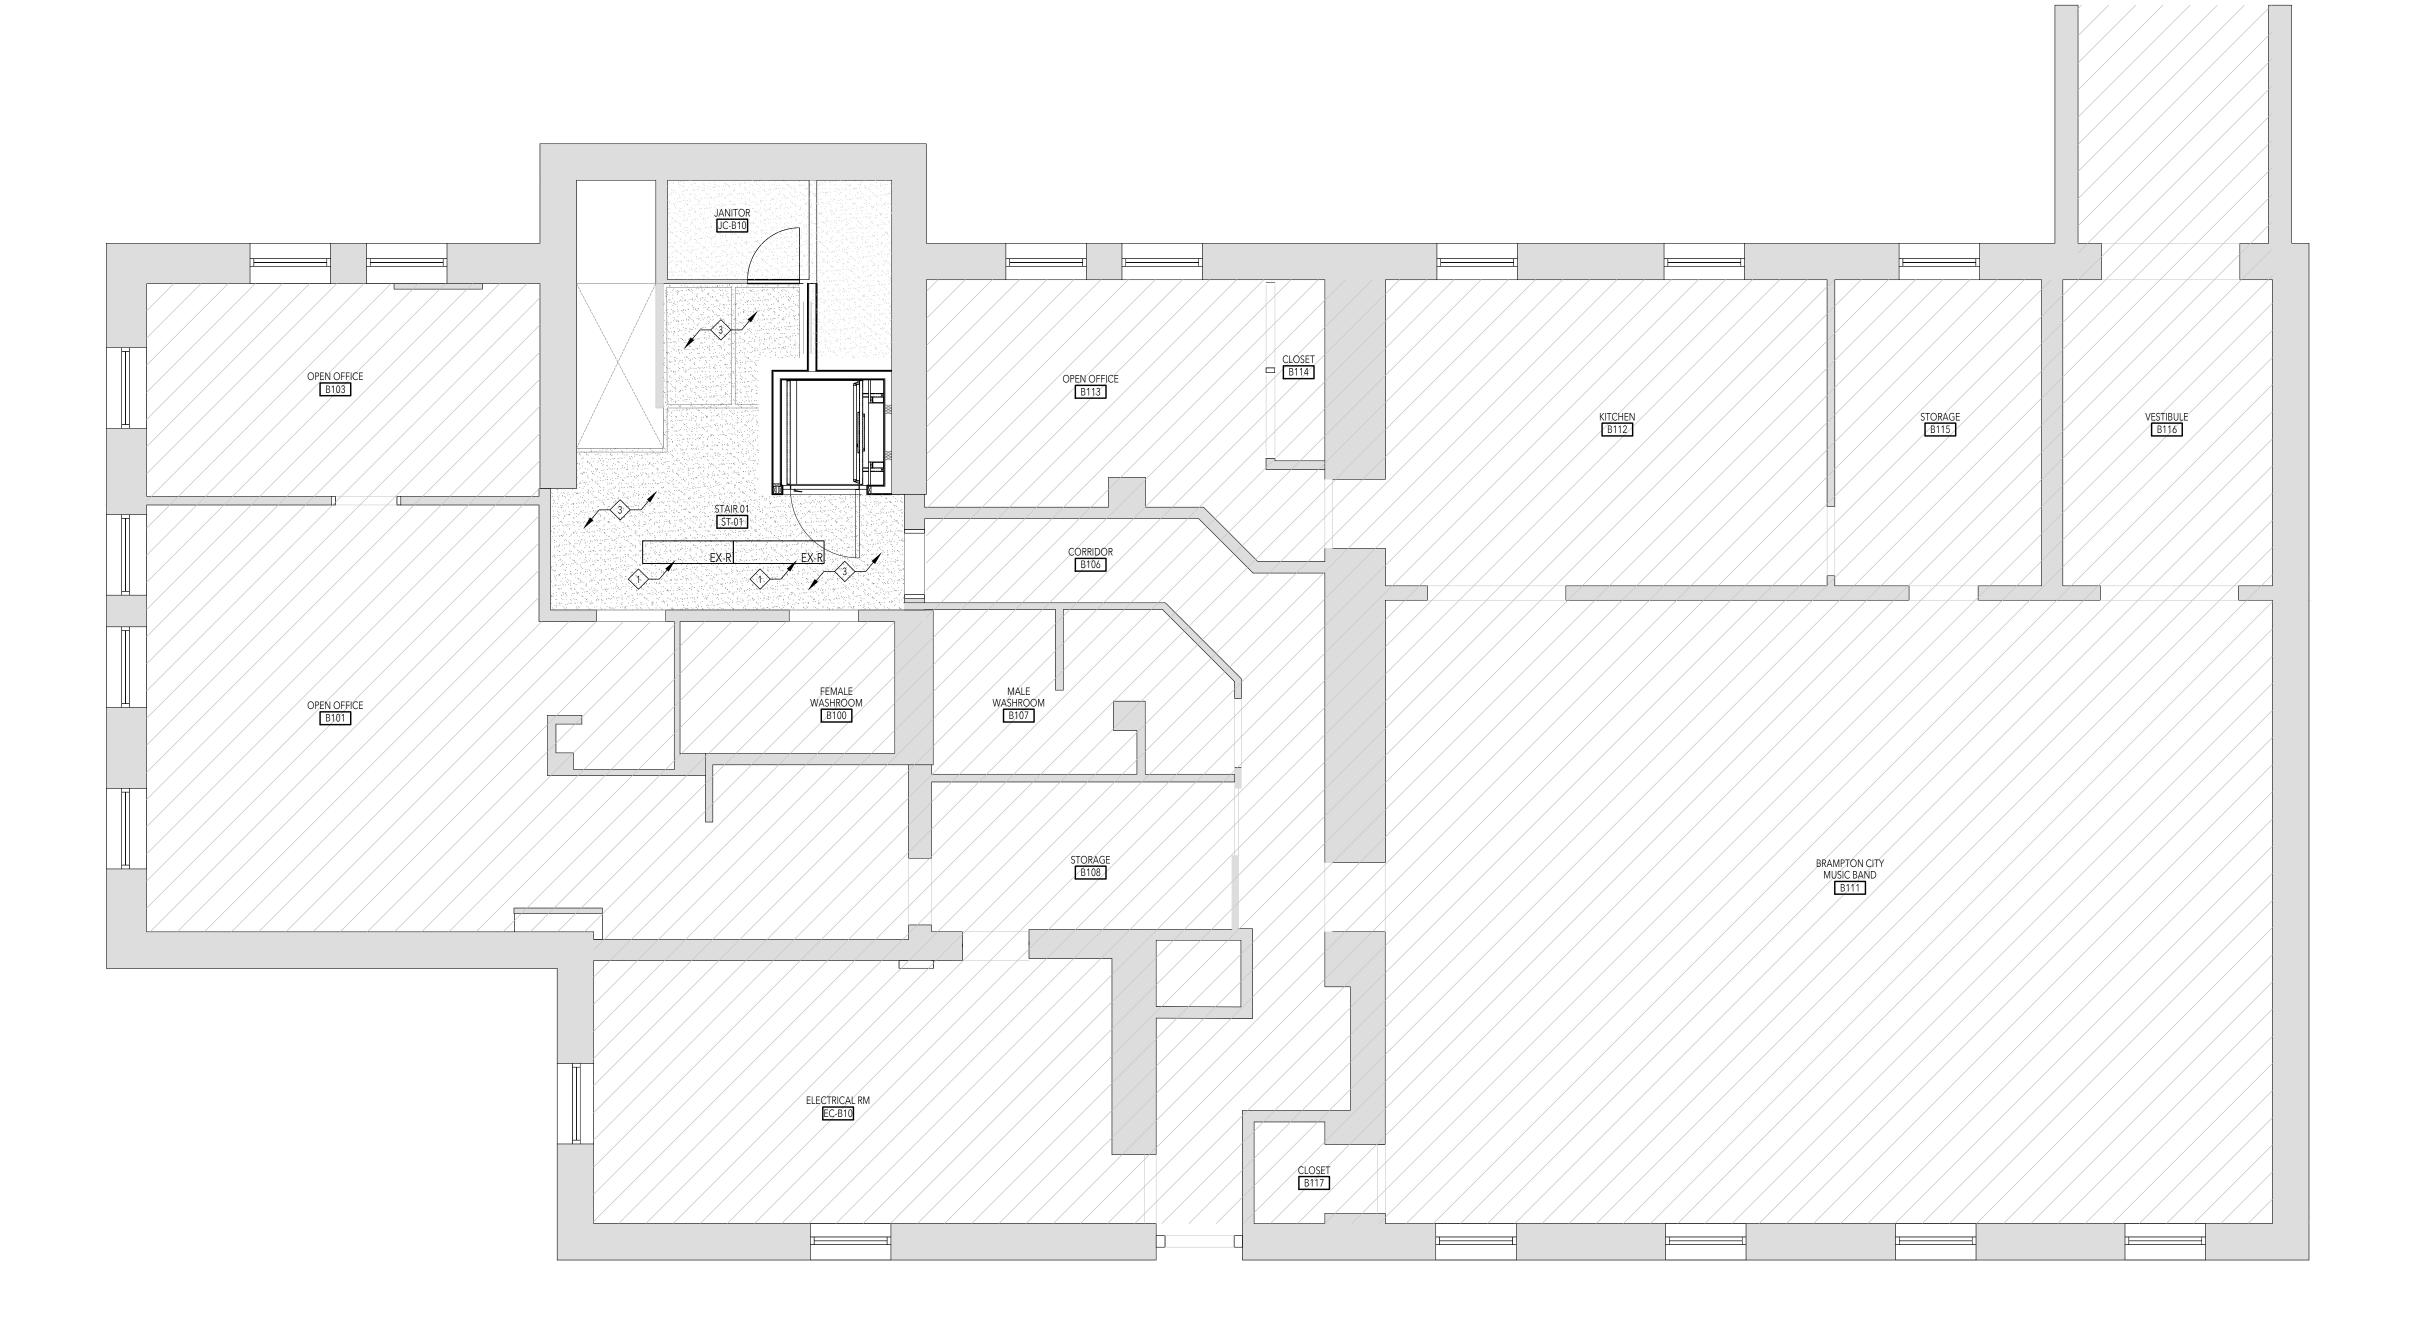



All drawings, specifications, related documents and design are the copyright property of the architect and must be returned upon request. Reproduction of the drawings, specifications, related documents and design in whole or in part is strictly forbidden without the architect's written permission.

This drawing, as an instrument of service, is provided by and is the property of LEBEL & BOULIANE Inc. and shall be used only for the project named on this drawing and solely for reference purposes only. The snain be used unity to the project named on inits drawing and solely of retrientie purposes only. The contractor is responsible for the coordination and verification of all dimensions contained herein and all measurements and conditions on site as they pertain to these documents. The contractor shall report any

This drawing shall not be used for construction purposes unless countersigned

Seals:

Permit & Tender

**Lorne Scots Regimental Museum** 

2024.07.24

Project Address: 55 Queen Street East, Brampton L6W 2A8

23-003



Project No. Drawn by Reviewed by Scale Plot Date

2024.06.17

**BASEMENT FLOOR RCP** 

- 1. MAKE GOOD ALL EXISTING AREAS ADJACENT NEW. 2. ALL CEILING HEIGHT TO MATCH EXISTING CEILING
- 3. REFER TO MECHANICAL AND ELECTRICAL DRAWINGS FOR ADDITIONAL INFORMATION
- ABBREVIATION & ADDTIONAL NOTES:
- E EXISTING TO REMAIN
  R DENOTES EXISTING TO BE REMOVED
  R/R DENOTES EXISTING TO BE REMOVED AND REPLACED
  R/L DENOTES EXISTING TO BE REMOVED AND RELOCATED

# RCP LEGEND:

GENERAL: INDICATES EXISTING TO REMAIN

GENERAL: INDICATES AREA NOT IN SCOPE

GWB CEILING

## RCP KEYNOTES

- EXISTING LIGHTS TO BE RELOCATED, MAKE GOOD DRYWALL CEILING AND PAINT
- NEW GWB CEILING HEIGHT TO MATCH EXISTING CEILING HEIGHT PAINTED PT-1 BENJAMIN MOORE CC-30 OXFORD WHITE
- EXISTING GWB CEILING TO BE MADE GOOD AND REPAINTED AFTER
- ACCOMMODATION OF NEW ACCESSIBLE LIFT NEW TRIM TO MATCH EXISTING CEILING
- NEW L1 LIGHT : SIGMA 2 LITELINE, WHITE RECESSED 3000K





All drawings, specifications, related documents and design are the copyright property of the architect and must be returned upon request. Reproduction of the drawings, specifications, related documents and design in whole or in part is strictly forbidden without the architect's written permission.

This drawing, as an instrument of service, is provided by and is the property of LEBEL & BOULIANE Inc. and shall be used only for the project named on this drawing and solely for reference purposes only. The snain be used unity to the project named on inits drawing and solely of retrientie purposes only. The contractor is responsible for the coordination and verification of all dimensions contained herein and all measurements and conditions on site as they pertain to these documents. The contractor shall report any

This drawing shall not be used for construction purposes unless countersigned

Seals:

Permit & Tender **Regimental Museum** 



Project No. Drawn by Scale Plot Date

**GROUND FLOOR RCP** 

2024.07.24

**Lorne Scots** 

Project Address:

23-003

NTS

2024.05.30

55 Queen Street East, Brampton L6W 2A8



must be returned upon request. Reproduction of the drawings, specifications, related documents and design in whole or in part is strictly forbidden without the architect's written permission.

shall be used only for the project named on this drawing and solely for reference purposes only. The contractor is responsible for the coordination and verification of all dimensions contained herein and all measurements and conditions on site as they pertain to these documents. The contractor shall report any

Do not scale this drawing This drawing shall not be used for construction purposes unless countersigned

CAREFULLY REMOVE HISTORICAL
DECORATIVE GLAZING TO
ACCOMMODATE NEW ACCESSIBLE LIFT AREA TO BE REMOVED AS - NEEDED TO ACCOMMODATE -STRUCTURE DO NOT DAMAGE AND KEEP ENTIRE SECTION FOR ALTERATION AND RE-INSTALLATION \_\_\_\_\_ REMOVE GRAPHIC CREST KEEP TO BE RE-INSTALLED OPEN TO BEYOND — DEMOLISH SECTION OF WALL TO ACCOMMODATÉ ACCESSIBLE LIFT CAREFULLY REMOVE ENTIRE POST AND
STAIR RAIL AND PICKETS
TO BE RE-INSTALLED AFTER LIFT INSTALLATION CAREFULLY REMOVE EXISTING STAIR ——— --- STAIR TO BE ALTERED (SHORTENED --LENGTH-WISE) AND RE-INSTALLED AS NEW \_\_\_\_ STAIR UP \_ \_ \_ OPEN TO BASEMENT —
(EXISTING STAIRS DOWN) OPEN TO BASEMENT — (EXISTING STAIRS DOWN) AREA SHADED IN GRAY TO

NEW DRYWALL ACCESSIBLE LIFT
ENCLOSURE PAINTED PT-1 BENJAMIN MOORE CC-30 OXFORD WHITE ∠OPEN TO BEYOND → LANDING GATE AT UPPER LEVEL (BEYOND) ∠LANDING GATE → OPEN TO BASEMENT (EXISTING STAIRS DOWN)

ENTRY ELEVATION - NEW (IN FRONT OF LIFT)

SCALE = 1: 50

A5.0

ENTRY ELEVATION - NEW (BEHIND LIFT)

SCALE = 1: 50

A5.0

OPEN TO BASEMENT

(EXISTING STAIRS DOWN)

— OPTION 1: ALTER EXISTING REMOVED DECORATIVE GLAZING TO ALIGN WITH

OPTION2: FABRICATE AND INSTALL NEW

GLAZING TO MATCH EXISTING GLAZING

NEW STAIR AND ACCESSIBLE LIFT

TO BE REINSTALLED AT CENTRE

ACCESSIBLE LIFT AND NEW STAIR PAINTED TO MATCH EXISTING DECORATIVE GLAZING MULLION

NEW ROST TO MATCH EXISTING AT

∠OPEN TO BEYOND →

EXISTING REMOVED POST AND

EXISTING ALTERED STAIR
RE-INSTALLED AS NEW STAIR UP

STAIR RAIL AND PICKETS RE-INSTALLED AT NEW LOCATION

BOTTOM OF RAIL

AREA TO BE REMADE TO


MATCH EXISTING TRIM


INSTALLATION


AFTER STRUCTURAL —


∠LOCATION OF ACCESSIBLE LIFT (NOT — SHOWN FOR CLARITY)

ENTRY ELEVATION - DEMO
SCALE = 1: 50
A5.0

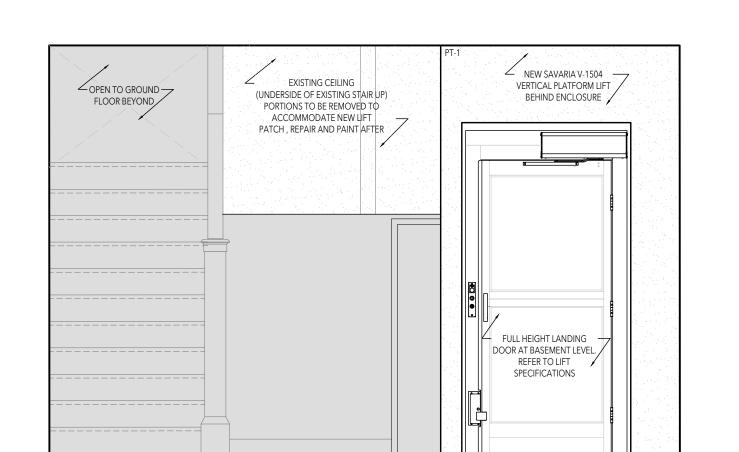

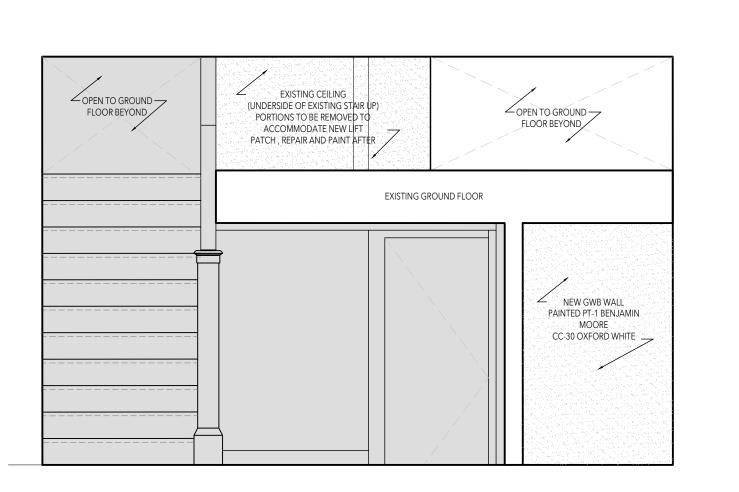

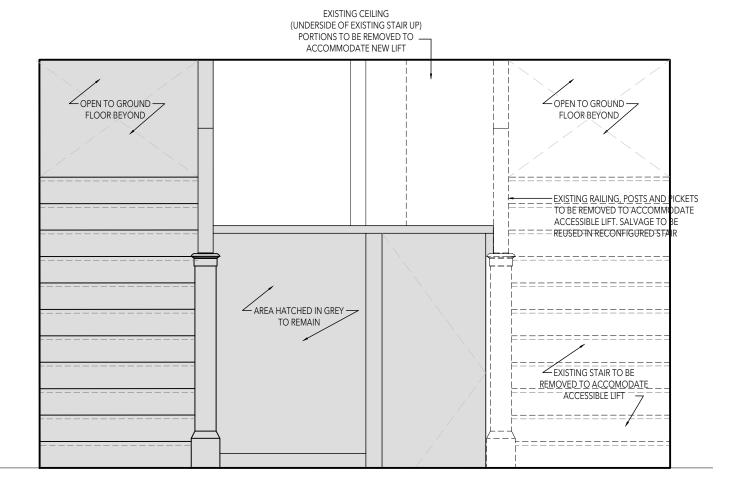

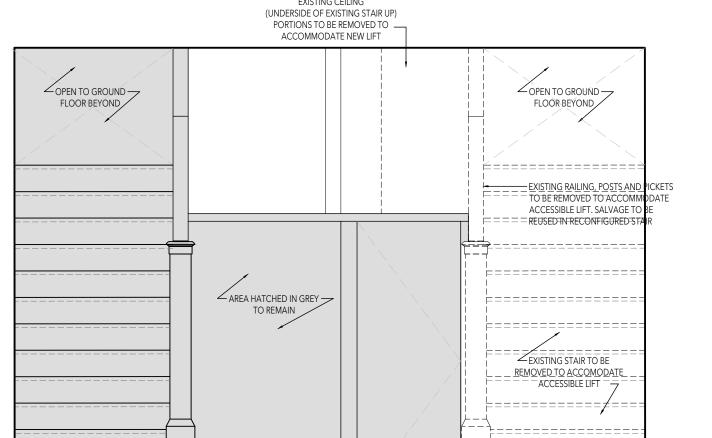

BASEMENT ELEVATION - DEMO
SCALE = 1: 50 A5.0

24-002 Project No. Drawn by Reviewed by NTS Scale

Regimental Museum

2024.07.24

**Lorne Scots** 

Project Address:

2024.07.24

55 Queen Street East,

Brampton L6W 2A8

**INTERIOR ELEVATIONS** 

Plot Date

Permit & Tender

BASEMENT ELEVATION - NEW (BEHIND LIFT)





All drawings, specifications, related documents and design are the copyright property of the architect and must be returned upon request. Reproduction of the drawings, specifications, related documents and design in whole or in part is strictly forbidden without the architect's written permission.


shall be used only for the project named on this drawing and solely for reference purposes only. The snain be used unity to the project named on inits drawing and solely of retrientie purposes only. The contractor is responsible for the coordination and verification of all dimensions contained herein and all measurements and conditions on site as they pertain to these documents. The contractor shall report any

Do not scale this drawing This drawing shall not be used for construction purposes unless countersigned

Seals:

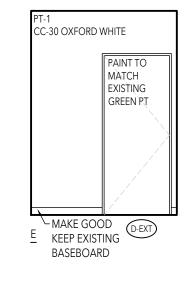


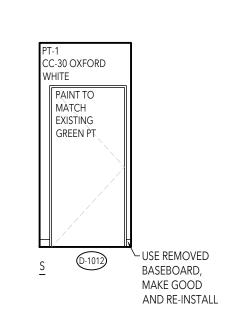


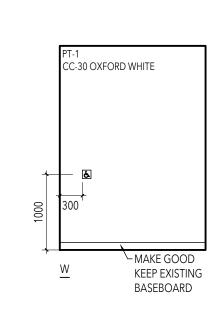







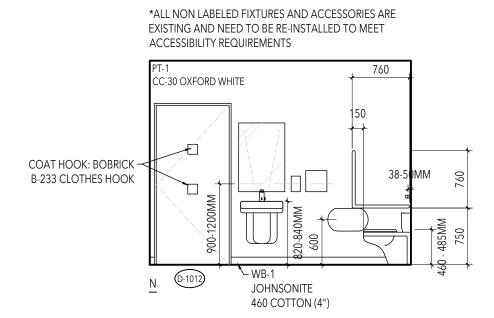


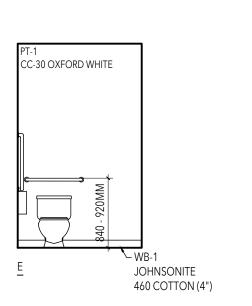

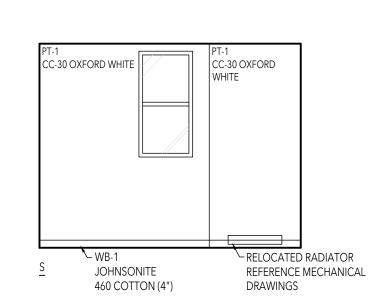

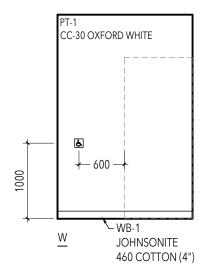



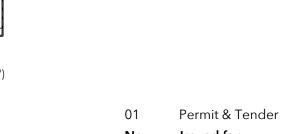

**Lorne Scots Regimental Museum** 


> Project Address: 55 Queen Street East, Brampton L6W 2A8

2024.07.24

Date

Proje	ect No.	24-00
Drav	wn by	-
Revi	ewed by	N
Scal	е	N <sup>-</sup>
Plot	Date	2024.07.

**ACCESSIBLE WASHROOM** 

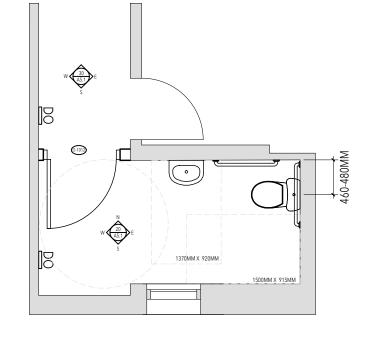







All drawings, specifications, related documents and design are the copyright property of the architect and must be returned upon request. Reproduction of the drawings, specifications, related documents and design in whole or in part is strictly forbidden without the architect's written permission.

This drawing, as an instrument of service, is provided by and is the property of LEBEL & BOULIANE Inc. and shall be used only for the project named on this drawing and solely for reference purposes only. The contractor is responsible for the coordination and verification of all dimensions contained herein and all measurements and conditions on site as they pertain to these documents. The contractor shall report any discrepancies to the consultant in writing prior to the commencement of any affected work.

Do not scale this drawing

This drawing shall not be used for construction purposes unless countersigned

Seals

01 Permit & Tender

No. Issued for


2024.07.24 **Date** 

Lorne Scots Regimental Museum

> Project Address: 55 Queen Street East, Brampton L6W 2A8

> > 24-002

1:50

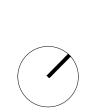

Project No.
Drawn by
Reviewed by
Scale

Plot Date 2024.07.18

**DOOR HARDWARE** 

A6.0




All drawings, specifications, related documents and design are the copyright property of the architect and must be returned upon request. Reproduction of the drawings, specifications, related documents and design in whole or in part is strictly forbidden without the architect's written permission.

This drawing, as an instrument of service, is provided by and is the property of LEBEL & BOULIANE Inc. and shall be used only for the project named on this drawing and solely for reference purposes only. The snain be used unity to the project named on inits drawing and solely of retrientie purposes only. The contractor is responsible for the coordination and verification of all dimensions contained herein and all measurements and conditions on site as they pertain to these documents. The contractor shall report any

This drawing shall not be used for construction purposes unless countersigned

Seals:

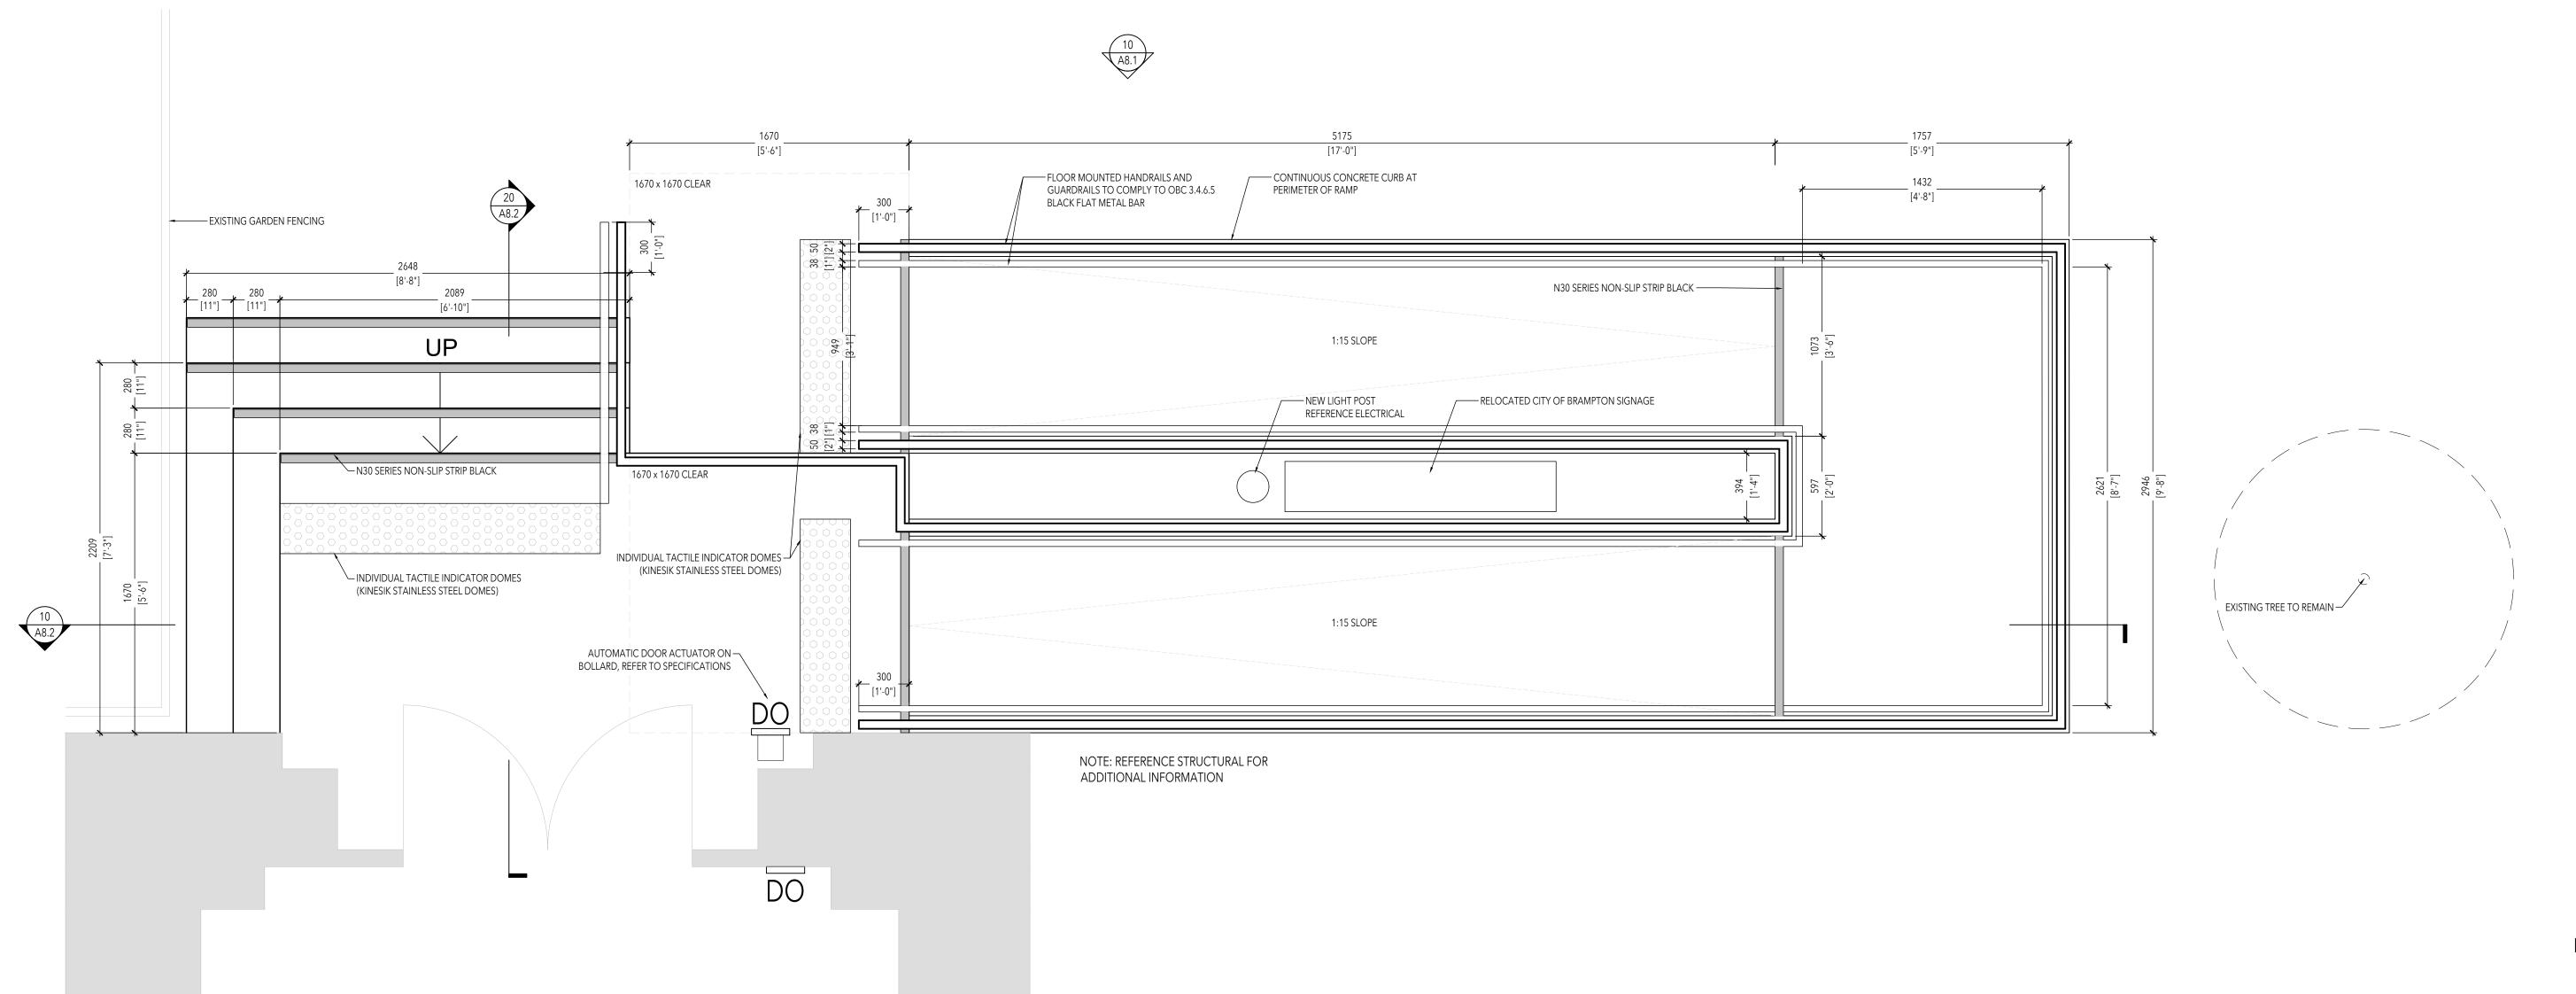

Permit & Tender

**Lorne Scots Regimental Museum** 

> Project Address: 55 Queen Street East, Brampton L6W 2A8

> > 24-002

2024.07.24

Project No. Drawn by Reviewed by Scale

2024.07.23 Plot Date

**RAMP PLAN** 






All drawings, specifications, related documents and design are the copyright property of the architect and must be returned upon request. Reproduction of the drawings, specifications, related documents and design in whole or in part is strictly forbidden without the architect's written permission.

This drawing, as an instrument of service, is provided by and is the property of LEBEL & BOULIANE Inc. and shall be used only for the project named on this drawing and solely for reference purposes only. The contractor is responsible for the coordination and verification of all dimensions contained herein and all measurements and conditions on site as they pertain to these documents. The contractor shall report any discrepancies to the consultant in writing prior to the commencement of any affected work.

Do not scale this drawing

This drawing shall not be used for construction purposes unless countersigned

Seals

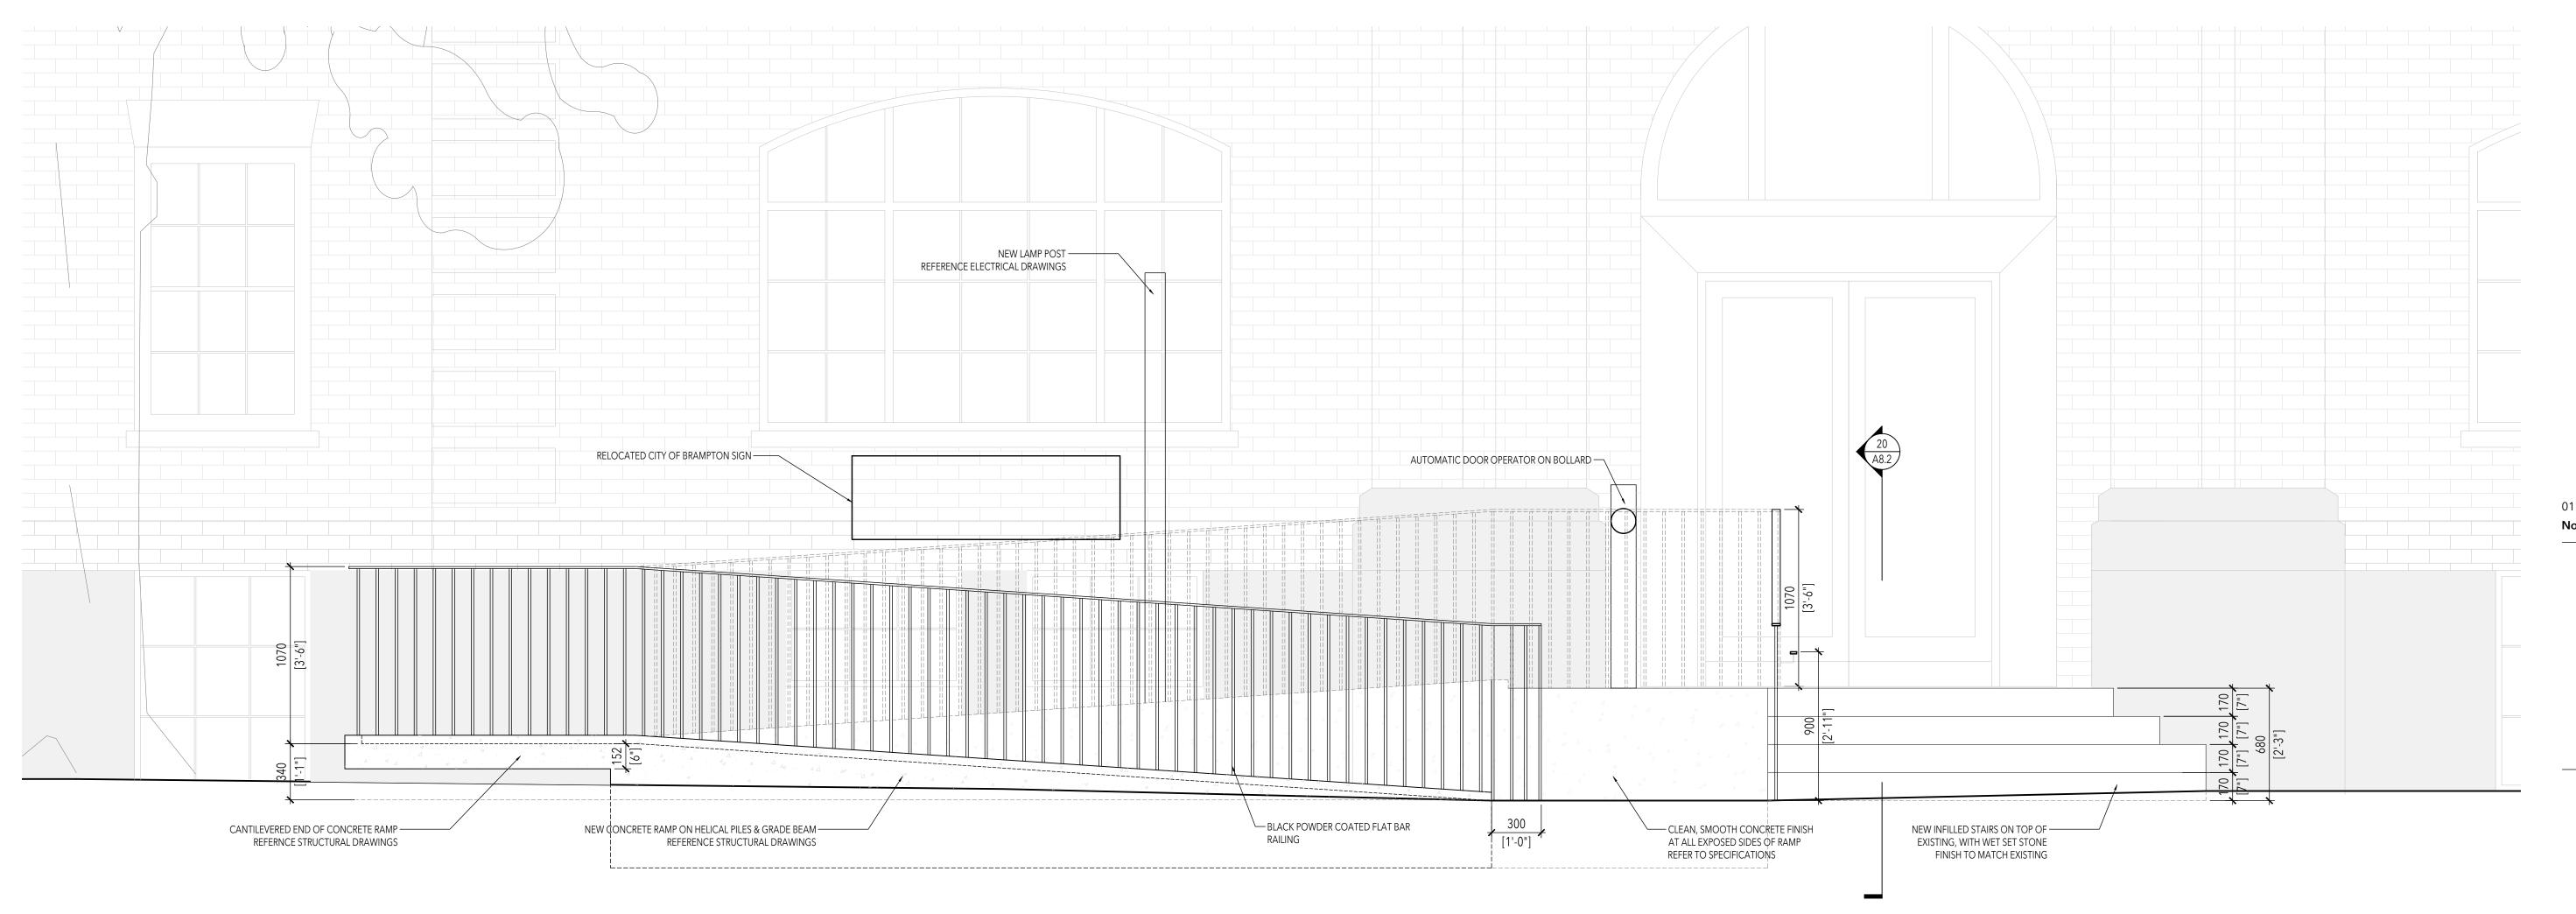

01 Permit & TenderNo. Issued for

Lorne Scots Regimental Museum

> Project Address: 55 Queen Street East, Brampton L6W 2A8

> > 23-003

2024.07.24

Project No.
Drawn by
Reviewed by
Scale

Plot Date 2024.07.23

RAMP ELEVATION






must be returned upon request. Reproduction of the drawings, specifications, related documents and design in whole or in part is strictly forbidden without the architect's written permission.

shall be used only for the project named on this drawing and solely for reference purposes only. The contractor is responsible for the coordination and verification of all dimensions contained herein and all measurements and conditions on site as they pertain to these documents. The contractor shall report any

This drawing shall not be used for construction purposes unless countersigned

Do not scale this drawing

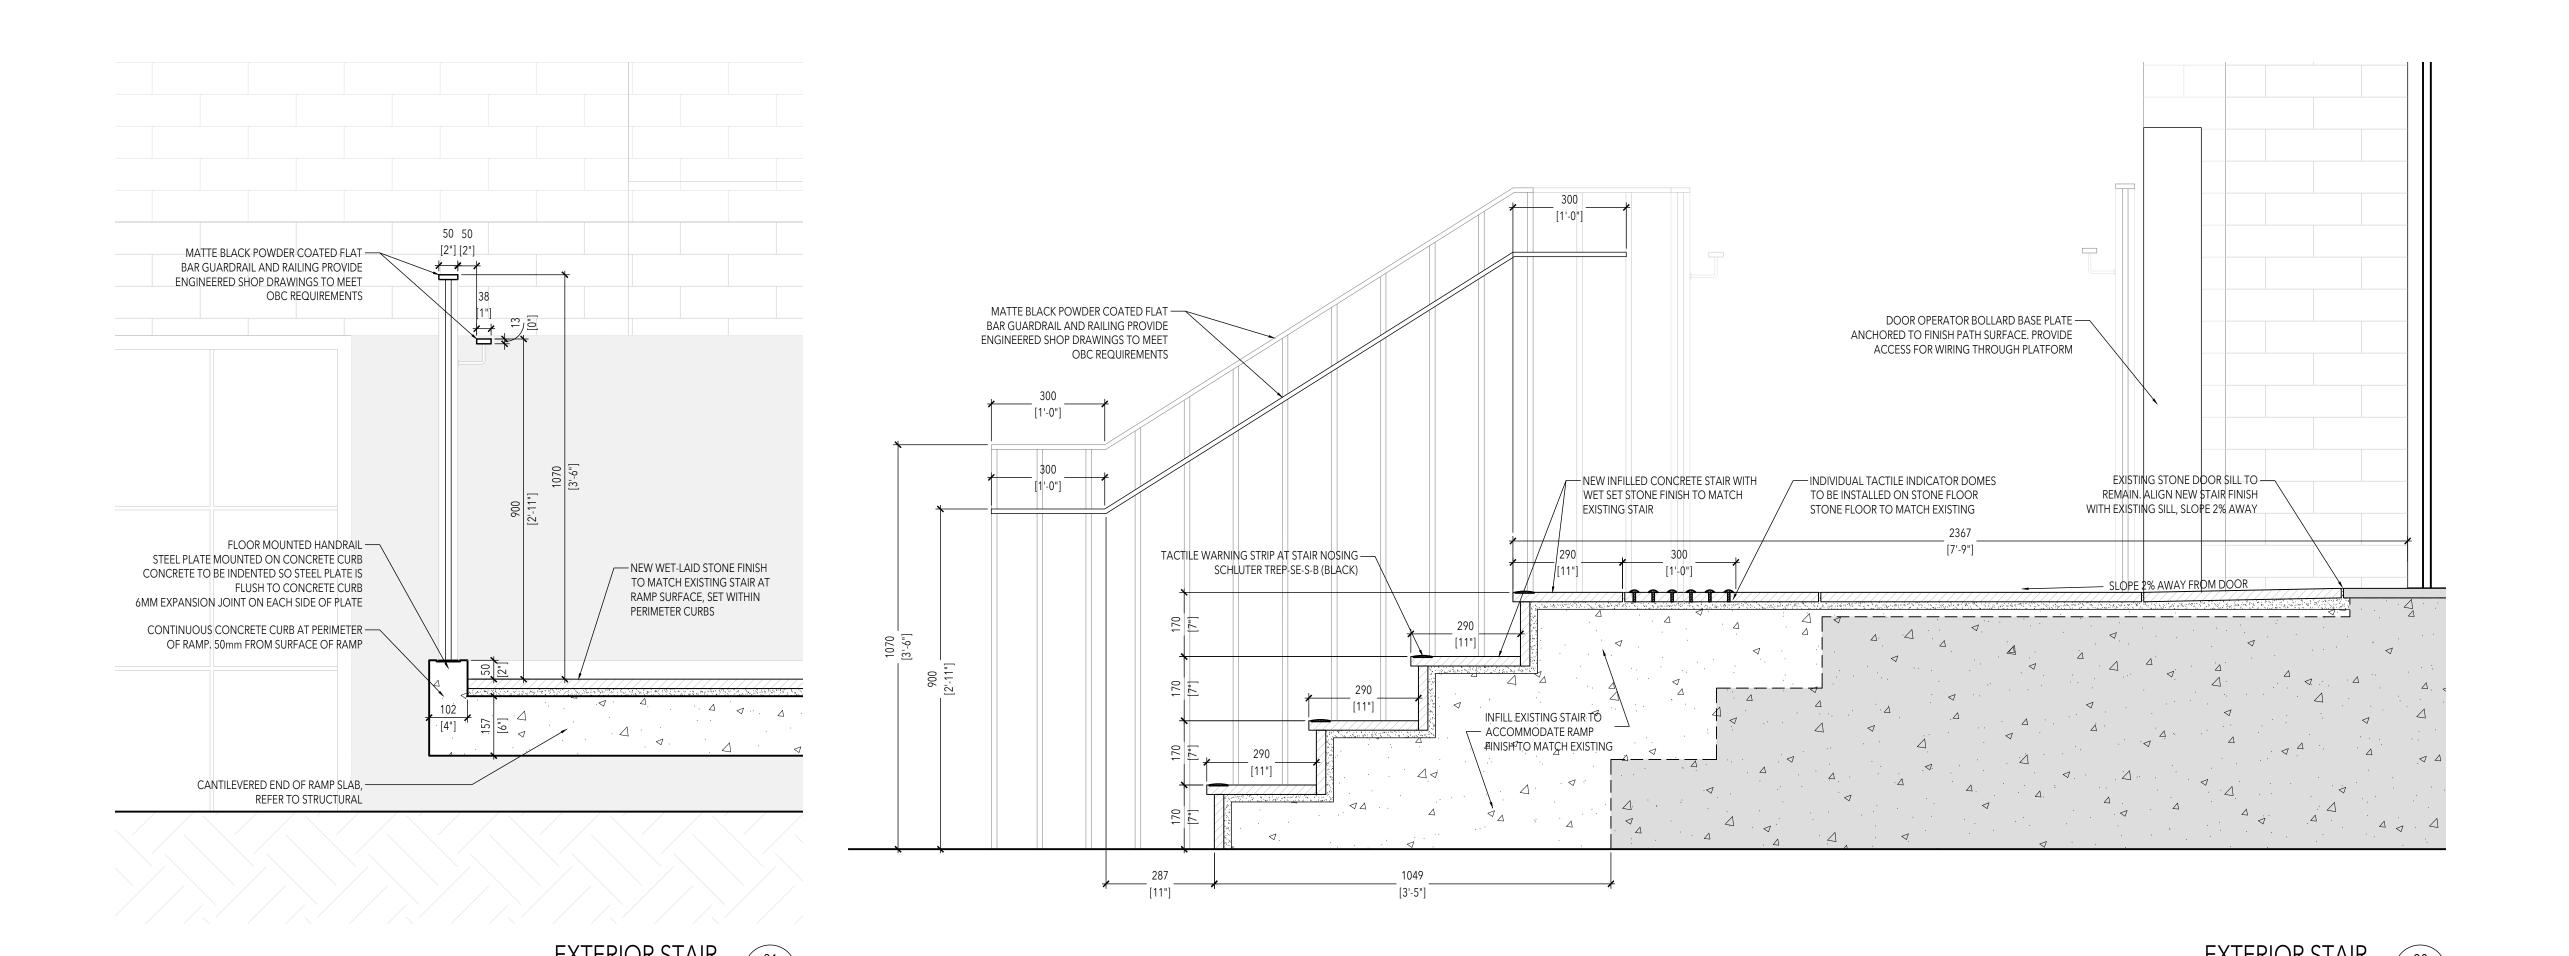

N30 SERIES NON-SLIP STRIP BLACK COLOUR CONTRAST STRIP NDIVIDUAL TACTILE INDICATOR DOMES (KINESIK STAINLESS STEEL DOMES) - N30 SERIES NON-SLIP STRIP BLACK WITHIN PERIMETER CURBS, CONTINUOUS
WITH FINISH AT TOP OF STAIRS COLOUR CONTRAST STRIP EXISTING STAIR COVERED AND

RE-CLAD WITH NEW STAIR

EXTENSION TO SUIT RAMP (REFER

TO GROSS SECTION & PLANS) INFILL EXISTING STAIR TO ACCOMMODATE RAMP FINISH TO MATCH EXISTING 4 4 4 4 4 RAMP SLAB AND FOUNDATION WALLS PER STRUCTURAL DRAWINGS CANTILEVERED END OF RAMP SLAB, REFER TO STRUCTURAL HELICAL PILES AND GRADE BEAM PER STRUCTURAL DRAWINGS HELICAL PILES AND GRADE BEAM PER STRUCTURAL DRAWINGS

EXTERIOR STAIR

SCALE = 1: 20

A8.2

2024.07.24 Permit & Tender

> **Lorne Scots Regimental Museum**

> > Project Address: 55 Queen Street East, Brampton L6W 2A8

> > > NTS

23-003 Project No. Drawn by Reviewed by Scale 2024.07.23 Plot Date


**DETAILS** 



All drawings, specifications, related documents and design are the copyright property of the architect and must be returned upon request. Reproduction of the drawings, specifications, related documents and design in whole or in part is strictly forbidden without the architect's written permission.

shall be used only for the project named on this drawing and solely for reference purposes only. The contractor is responsible for the coordination and verification of all dimensions contained herein and all measurements and conditions on site as they pertain to these documents. The contractor shall report any

This drawing shall not be used for construction purposes unless countersigned

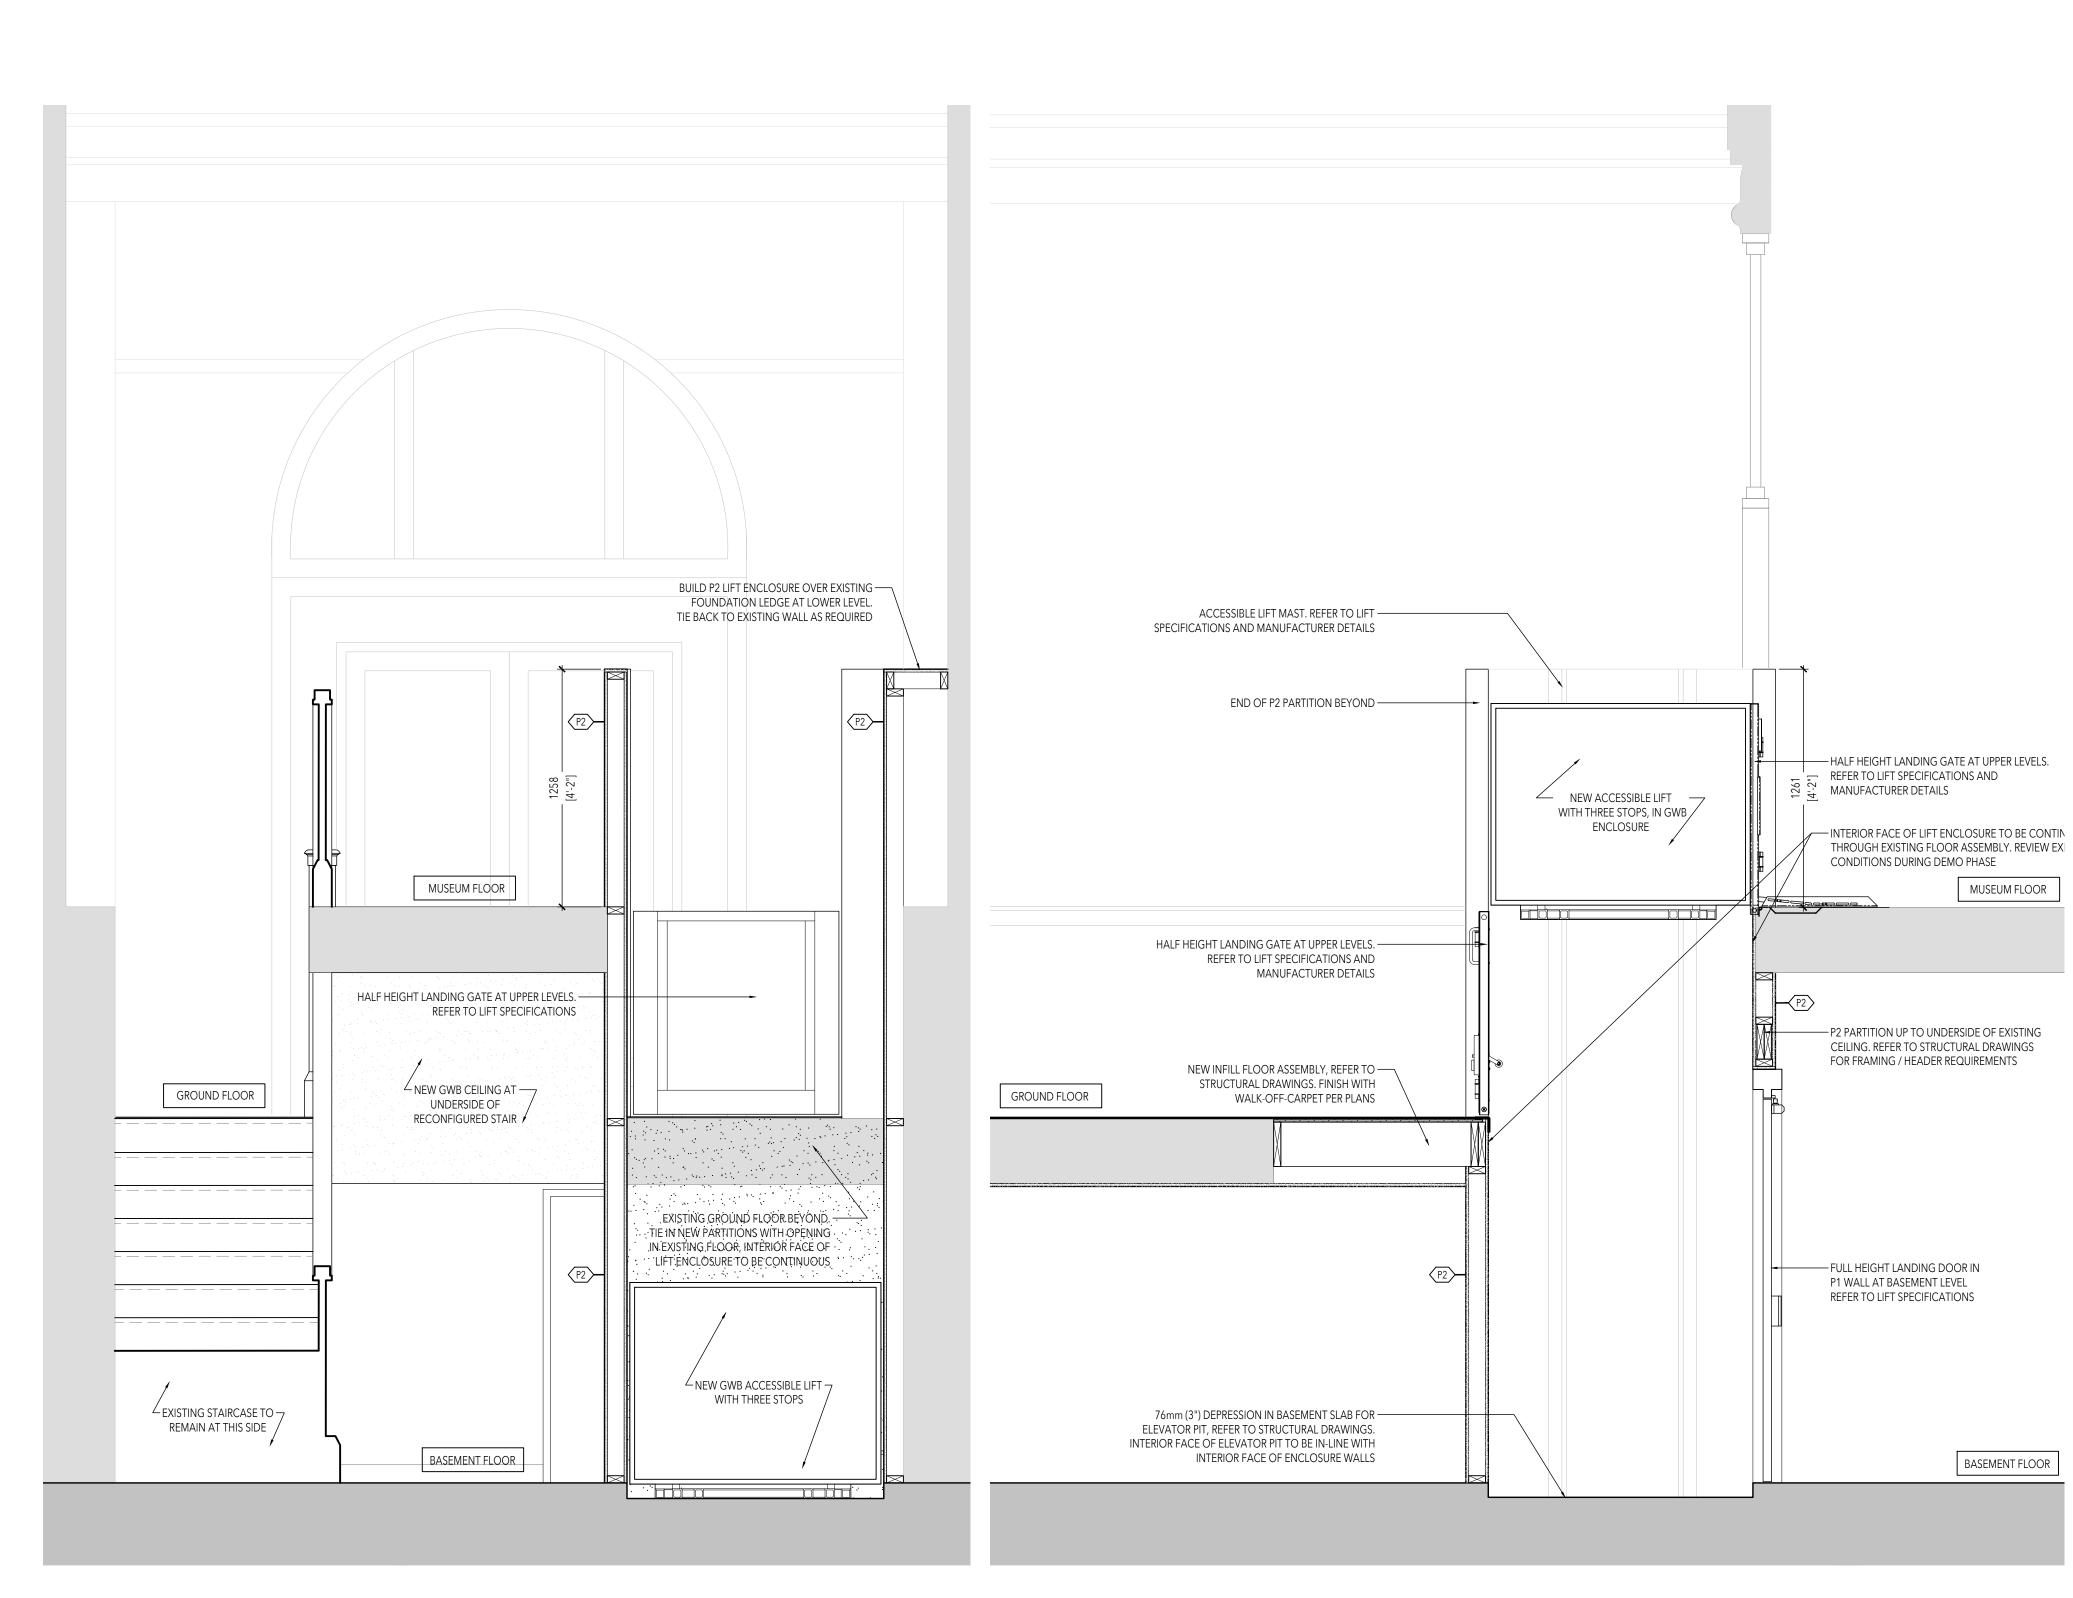

NEW POST AT END OF RAILING FOR — RAIL TO TERMINATE AT MATCH EXISTING POST DESIGN NEW GWB LIFT ENCLOSURE BEYOND ----REMOVED AND RELOCATED TO NEW LOCATION EXISTING ENTIRE RAILING CAREFULLY REMOVED AND RELOCATED TO NEW THE STREET STREET STREET STREET STREET EXISTING STAIR TO BE CAREFULLY REMOVED, ALTERED
/ SHORTENED TO NEW LENGTH
AND REINSTALLED IN NEW <sup>∠</sup> NEW GWB WALL PAINTED PT-1 CC-30 BENJAMIN MOORE OXFORD WHITE NEW ACCESSIBLE LIFT BEHIND -CC-30 BENJAMIN MOORE OXFORD WHITE NEW WALL BASE TO MATCH / NEW WALL BASE TO MATCH

Project Address:

Regimental Museum

Permit & Tender

55 Queen Street East, Brampton L6W 2A8

NTS

2024.07.24

**Lorne Scots** 

23-003 Project No. Drawn by Reviewed by Scale 2024.07.23 Plot Date

**INTERIOR SECTIONS** 

INTERIOR SECTION C

INTERIOR SECTION B
SCALE = 1: 20
A8.3



