

Private Right-of-Way

FILE NUMBER:

A-2024-0438

The Personal Information collected on this form is collected pursuant to section 45 of the Planning Act and will be used in the processing of this application. Applicants are advised that the Committee of Adjustment is a public process and the information contained in the Committee of Adjustment files is considered public information and is available to anyone upon request. Questions about the collection of personal information should be directed to the Freedom of Information and Privacy Coordinator, City of Brampton.

APPLICATION Minor Variance or Special Permission

(Please read Instructions)

NOTE: It is required that this application be filed with the Secretary-Treasurer of the Committee of Adjustment and be accompanied by the applicable fee.

KAMALJEET CHANA

The undersigned hereby applies to the Committee of Adjustment for the City of Brampton under section 45 of the Planning Act, 1990, for relief as described in this application from By-Law 270-2004.

. Name of		
Address	67 LAURAGLEN CRESCENT BRAMPTON ON,	L6Y 5A6
		
Phone #	416-399-0375	Fax #
Email	kamaljeet.chana062@hotmail.com	
Name of	Agent Pavlo Palagut	
Address	369 WILLOWBROOK DR Welland, ON L3C	; 0G4
Phone #	416-528-3834	Fax #
Email	palagut@gmail.com	
entrance. Th		he basement ARU through the single-car garage, instead of a separate exterionage corner, far from the roll-up door, maximizing separation for privacy and safe
between the	AKU and main dwelling.	
-		
Why is it	not possible to comply with the provis	ions of the by-law?
-		ions of the by-law? impose a significant financial strain, making the basement ARU less viable.
1. Financial Fe	asibility: Constructing a below-grade walkout would	
Financial Feature Ontario House	asibility: Constructing a below-grade walkout would	impose a significant financial strain, making the basement ARU less viable.
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Water

8. Particulars of all buildings and structures on or proposed for the subject land: (specify in metric units ground floor area, gross floor area, number of storeys, width, length, height, etc., where possible) **EXISTING BUILDINGS/STRUCTURES** on the subject land: BUILDING AREA = 937.37 SF (87.11 SM) EXISTING SECOND FLOOR AREA =735.01 SF (68.30 SM) EXISTING MAIN FLOOR AREA =611.01 SF (56.78 SM) PROPOSED BASEMENT AREA =588.51 SF (54.69 SM) PROPOSED BUILDINGS/STRUCTURES on the subject land: PROPOSED BASEMENT AREA =588.51 SF (54.69 SM) 9. Location of all buildings and structures on or proposed for the subject lands: (specify distance from side, rear and front lot lines in metric units) **EXISTING** Front yard setback 6.99 Rear yard setback 8.8 Side yard setback 2 11 Side yard setback ŅΑ **PROPOSED** Front yard setback Rear yard setback NA Side yard setback NA Side yard setback August 29, 1997 10. Date of Acquisition of subject land: 11. Existing uses of subject property: SINGLE FAMILY DWELLING / RESIDENTIAL TWO UNIT DWELLING / RESIDENTIAL 12. Proposed uses of subject property: 13. Existing uses of abutting properties: Residential 1997 14. Date of construction of all buildings & structures on subject land: 27 years 15. Length of time the existing uses of the subject property have been continued: 16. (a) What water supply is existing/proposed? Other (specify) Municipal What sewage disposal is/will be provided? (b) Other (specify) Municipal Septic (c) What storm drainage system is existing/proposed?

Other (specify) --

Sewers Ditches

Swales

17. Is the subject subdivision o		pplication under the Planning Act, for approval of a plan of
Yes	No X	
If answer is y	es, provide details: File	#Status
18. Has a pre-cor	nsultation application been fi	iled?
Yes	No X	
19. Has the subje		ever been the subject
of an application for		
Yes	No X	Unknown
If answer is y	es, provide details:	
File # File #		Relief Relief
File #—	Decision	Relief
		Kamaljeet Chama
		PAVLO PALAGUT, P. ENG.
	Bonne	Signature of Applicant(s) or Authorized Agent
DATED AT THE	WELLAND CHU OF	ONTARIO BOOM NEO
	NOVEMBER	- Jane pr
THIS THIS	DAY OF	, 20 _ <u>24</u> .
NATHE ABOVE ST	OF CANADA PER TATEMENTS ARE TRUE AN	OF THEOFBRANGE BRANGE CONSCIENTIOUSLY T IS OF THE SAME FORCE AND EFFECT AS IF MADE UNDER
AIII.		Valerie Low a Commissioner, etc.,
ECLARED BEFORE MI		Province of Ontario,
0F 5	BRAMPTON	for the Corporation of the
THE REG	ION OF	City of Brampton.
PEEL	77	Munanja OV
THIS	DAY OF	PAVLOPALAGUI, P. CAY.
NOV ,	20	Signature of Applicant or Authorized Agent
	,	
A Commission	oner etc	
A Countries	oner etc.	
	FOR O	FFICE USE ONLY
Present Office	cial Plan Designation:	R2B-2883
Present Zoni	ing By-law Classification:	
This applica	ation has been reviewed with re said review are out	espect to the variances required and the results of the lined on the attached checklist.
Ros	ss Campbell	November 9, 2024
	Zoning Officer	Date

DATE RECEIVED

Revised 2023/01/12

APPOINTMENT AND AUTHORIZATION OF AGENT

To: The Secretary-Treasurer
Committee of Adjustment
City of Brampton
2 Wellington Street West
Brampton, Ontario
L6Y 4R2

LOCATION	ON C	OF THI	E SUBJEC	T LAND:	67 LAURAGLE	N CRESCENT,	BRAMPTON	, ON L6Y 5	A6	
/We,	KAM	ALJEET	CHANA							
				please pi	rint/type the fu	ıll name of the	owner(s)			
the unde	ersig	ned, b	eing the re	egistered o	owner(s) of	the subject	lands, h	ereby auth	norize	
		P	AVLO PALAG	UT, P.ENG.						
				please p	orint/type the fo	ull name of the	e agent(s)			
	or va			•	subject land	nittee of A dd.	ljustme , 20 <u>²</u>		atter of an	application
				KAMo	'ALJCE	T CHAN	A			
(sigr	nature	of the	owner[s], or	where the o	wner is a firm	or corporation	n, the sigr	ature of an	officer of the	owner.)
	(wł	nere the	e owner is a f	irm or corpo	oration, please	e print or type t	the full na	me of the pe	erson signing.	.)

NOTE: If the owner is a firm or corporation, the corporate seal shall be affixed hereto.

PERMISSION TO ENTER

To: The Secretary-Treasurer
Committee of Adjustment
City of Brampton
2 Wellington Street West
Brampton, Ontario
L6Y 4R2

LOCATIO	N OF	THE	SUBJECT	LAND:	67 LAURA	GLEN CRI	ESCENT,	BRAMPT	ON, ON I	6Y 5A6		
I/We,	KAM	ALJEE	ET CHANA									
,				please p	orint/type the	e full nam	e of the	owner(s)			
the City of above no	of Bran oted p	mpto rope	eing the re n Committ erty for the or Variance	ee of Adj	justment a e of condu	and City	of Bra	mpton	staff me	mbers,	to enter	r upon the
Dated thi	s 3	RD	day of	NOV	EMBER			, 20 _	<u>24</u> .			
			KA	TMAL	900	CHA	NA					
(signa	ature o	f the o	owner[s], or v	where the	owner is a fi	irm or co	poration	n, the sig	nature of	an office	r of the o	wner.)
	(wher	e the	owner is a fi	rm or corp	oration, plea	ase print	or type 1	the full n	ame of th	e person	signing.)	

NOTE: If the owner is a firm or corporation, the corporate seal shall be affixed hereto.

NO DISCUSSION SHALL TAKE PLACE BETWEEN THE COMMITTEE MEMBERS AND THE APPLICANT DURING THE SITE INSPECTION

COVER SHEET

BUILDING PERMIT FOR BASEMENT ADDITIONAL RESIDENTIAL UNIT WITH EXISTING ABOVE GRADE PRINCIPAL ENTRANCE IN THE FRONT YARD THROUGH THE GARAGE

67 LAURAGLEN CRESCENT, BRAMPTON ONTARIO

A-0 = COVER SHEET

A-1 = SITE PLAN

A-2 = FXISTING BASEMENT FLOOR PLAN

A-3 = PROPOSED BASEMENT FLOOR PLAN

A-4 = EXISTING MAIN FLOOR PLAN

A-5 = EXISTING SECOND FLOOR PLAN

N-1 = CONSTRUCTION NOTES

GENERAL NOTES:

- ALL EXISTING SITE CONDITIONS AND ALL DIMENSIONS ON DRAWINGS MUST BE CHECKED AND VERIFIED ON SITE BY THE DESIGNER/ENGINEER PRIOR TO COMMENCEMENT OF THE WORK. ALL THE WORK SHALL BE CARRIED OUT N ACCORDANCE WITH THE LATEST VERSION OF ONTARIO BUILDING CODE AND REQUIREMENTS OF AUTHORITIES HAVING JURISDICTION.
- DURING AND AFTER CONSTRUCTION. - IF EXISTING CONSTRUCTION IS DAMAGED DURING THE WORK. CONTRACTOR TO MAKE GOOD TO MATCH EXISTING.
- DO NOT SCALE THE DRAWING.
- THE DESIGN AND CONTRACT DOCUMENTS ARE THE COPYRIGHT OF THE DESIGNER/ENGINEER AND MAY NOT BE REPRODUCED, REUSED OR ALTERED WITHOUT WRITTEN PERMISSION OF THE DESIGNER/ENGINEER.



		i
01	SCHEMATIC	06.11.202
	DESCRIPTION	DATE
DOOL	COT:	

67 LAURAGLEN CRESCENT BRAMPTON ONTARIO

TITLE:

COVER SHEET

CONSULTANT:


PAVLO PALAGUT

(416 528 3834) palagut@gmail.com

DRAWN BY: A.B.K	CHECKED BY:
DATE: 06.11.2024	DRAWING NO:
SCALE: N.T.S.	A-0

LOT AREA = 2870.57 SF (266.78 SM) BUILDING AREA = 937.37 SF (87.11 SM) EXISTING SECOND FLOOR AREA = 735.01 SF (68.30 SM) EXISTING MAIN FLOOR AREA =611.01 SF (56.78 SM) PROPOSED BASEMENT AREA =588.51 SF (54.69 SM)



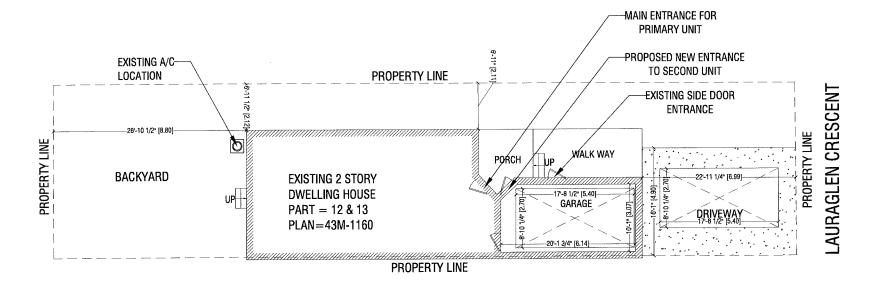

GENERAL NOTES:

- ALL EXISTING SITE CONDITIONS AND ALL DIMENSIONS ON DRAWINGS MUST BE CHECKED AND VERIFIED ON SITE BY CONTRACTOR. ANY VARIANCES OR DISCREPANCIES MUST BE REPORTED TO THE DESIGNER/ENGINEER PRIOR TO COMMENCEMENT OF THE WORK.
- ALL THE WORK SHALL BE CARRIED OUT IN ACCORDANCE WITH THE LATEST VERSION OF ONTARIO BUILDING CODE AND REQUIREMENTS OF AUTHORITIES HAVING JURISDICTION.
- ALL FIRE SAFETY SYSTEM TO BE ACTIVE DURING AND AFTER CONSTRUCTION. - IF EXISTING CONSTRUCTION IS DAMAGED DURING THE WORK, CONTRACTOR TO MAKE GOOD TO MATCH EXISTING.
- DO NOT SCALE THE DRAWING.
- THE DESIGN AND CONTRACT DOCUMENTS ARE THE COPYRIGHT OF THE DESIGNER/ENGINEER AND MAY NOT BE REPRODUCED, REUSED OR ALTERED WITHOUT WRITTEN PERMISSION OF THE DESIGNER/ENGINEER.



01	SCHEMATIC	06.11.20
No.	DESCRIPTION	DATE
DDO:	FOT.	

67 LAURAGLEN CRESCENT BRAMPTON ONTARIO


SITE PLAN

CONSULTANT

PAVLO PALAGUT

(416 528 3834) palagut@gmail.com

DRAWN E	A.B.K	CHECKED BY:
DATE:	06.11.2024	DRAWING NO:
SCALE:	³ / ₃₂ " = 1'	A-1

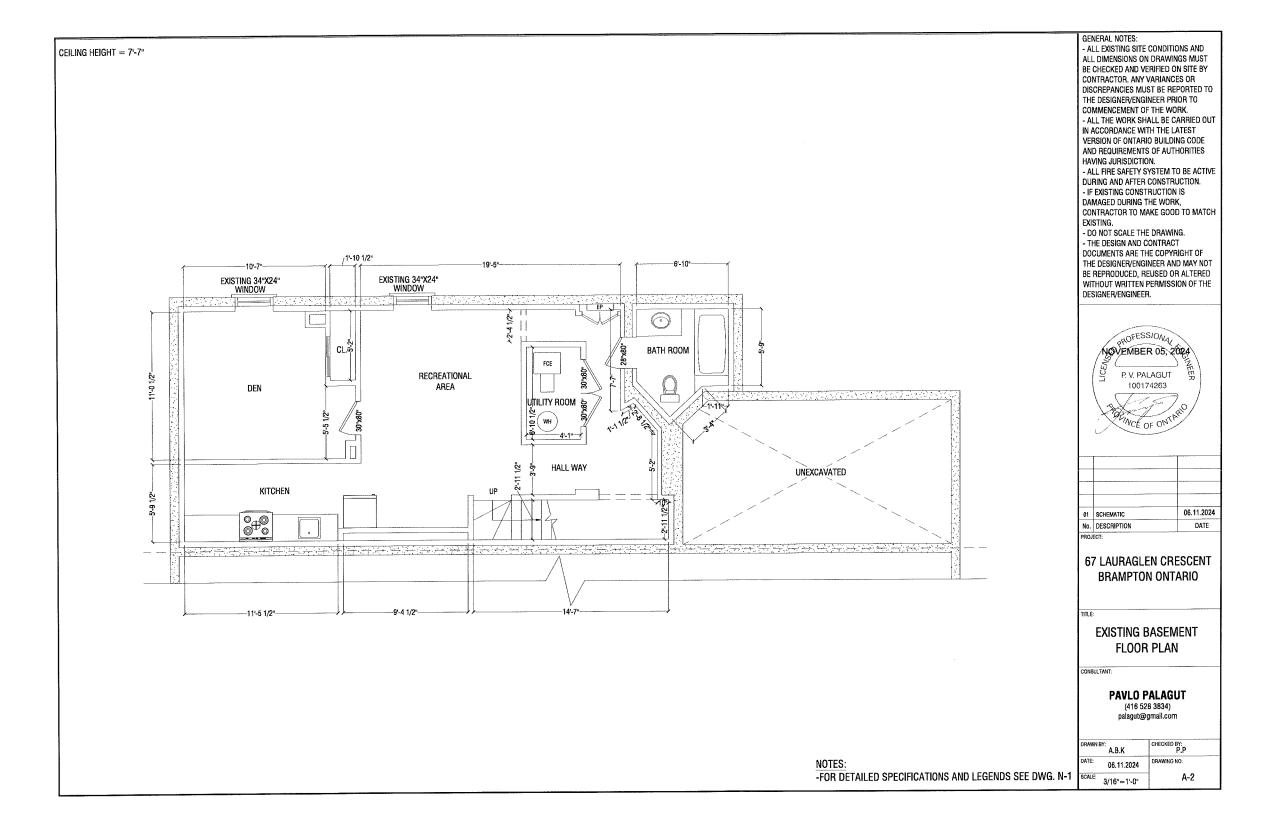


ROOMS	REQD. WINDOW AREA	AVAILABLE WINDOW AREA	CEILING HEIGHT = 7'-7"
BEDROOM	2.5% OF 126.13 SF=3.15 SF	5.10 SF	
LIVING/DINING	5% OF 184.65 SF= 9.23 SF	9.45 SF	

PROPOSED BASEMENT AREA =588.51 SF (54.69 SM) PROPOSED BASEMENT AREA (SECOND UNIT) =588.51 SF (54.69 SM)


WOOD LINTEL	OPENINGS	SIZE
WB1	UPTO 42" OPENINGS	2-2"x6"
WB2	UPTO 66" OPENINGS	2-2"x10"

STEEL LINTEL	OPENINGS	SIZE
L1	UPTO 54" OPENINGS	L3.5"x3.5"x0.3125"
L2	UPTO 66" OPENINGS	L4.0"x3.5"x0.3125"

~~ ~~~~~~~~~~~~~~~~~~~~~~~~~~~~~~~~~~~~		GENERAL NOTES:
OPENINGS	SIZE	- ALL EXISTING SIT
TO 54" OPENINGS	L3.5"x3.5"x0.3125"	ALL DIMENSIONS BE CHECKED AND
TO 66" OPENINGS	L4.0"x3.5"x0.3125"	CONTRACTOR. AN
		DISCREDANCIES M

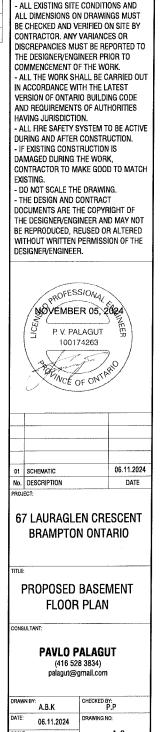

3/16"=1'-0"

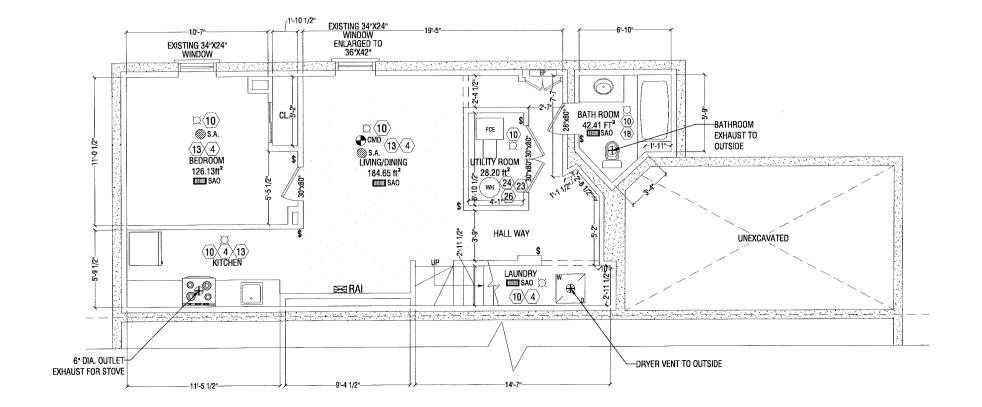

LEGEND:

EXISTING WALL TO BE DEMOLISHED EXISTING EXTERIOR WALLS PROPOSED INTERIOR WALLS


FIRE RATED WALLS REFER TO N-01 FOR DETAILS

NOTES:

-FOR DETAILED SPECIFICATIONS AND LEGENDS SEE DWG. N-1

SIZE CEILING HEIGHT = 7'-10" WOOD LINTEL **OPENINGS** UPTO 42" OPENINGS 2-2"x6" WB1 UPTO 66" OPENINGS 2-2"x10" WB2

STEEL LINTEL	OPENINGS	SIZE
L1	UPTO 54" OPENINGS	L3.5"x3.5"x0.3125"
L2	UPTO 66" OPENINGS	L4.0"x3.5"x0.3125"

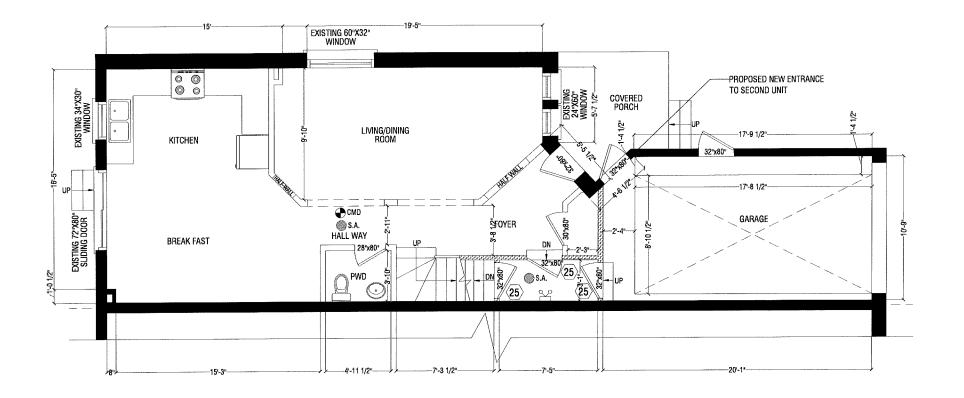


NOTES:

ALL WINDOWS EXISTING UNLESS OTHERWISE SPECIFIED FOR DETAILED SPECIFICATIONS AND LEGENDS SEE DWG. N-1 GENERAL NOTES:

- ALL EXISTING SITE CONDITIONS AND ALL DIMENSIONS ON DRAWINGS MUST BE CHECKED AND VERIFIED ON SITE BY CONTRACTOR, ANY VARIANCES OR DISCREPANCIES MUST BE REPORTED TO THE DESIGNER/ENGINEER PRIOR TO COMMENCEMENT OF THE WORK.

- ALL THE WORK SHALL BE CARRIED OUT IN ACCORDANCE WITH THE LATEST VERSION OF ONTARIO BUILDING CODE AND REQUIREMENTS OF AUTHORITIES
- HAVING JURISDICTION. - ALL FIRE SAFETY SYSTEM TO BE ACTIVE DURING AND AFTER CONSTRUCTION.
- IF EXISTING CONSTRUCTION IS DAMAGED DURING THE WORK, CONTRACTOR TO MAKE GOOD TO MATCH EXISTING.
- DO NOT SCALE THE DRAWING. - THE DESIGN AND CONTRACT DOCUMENTS ARE THE COPYRIGHT OF THE DESIGNER/ENGINEER AND MAY NOT BE REPRODUCED, REUSED OR ALTERED WITHOUT WRITTEN PERMISSION OF THE DESIGNER/ENGINEER.

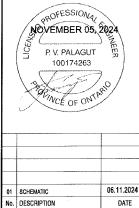

PROJECT:

67 LAURAGLEN CRESCENT BRAMPTON ONTARIO

EXISTING MAIN FLOOR PLAN


CONSULTANT:

PAVLO PALAGUT (416 528 3834) palagut@gmail.com

CHECKED BY: 06.11.2024 A-4 3/16"=1'-0"

LEGEND:

FIRE RATED WALLS REFER TO N-01 FOR DETAILS

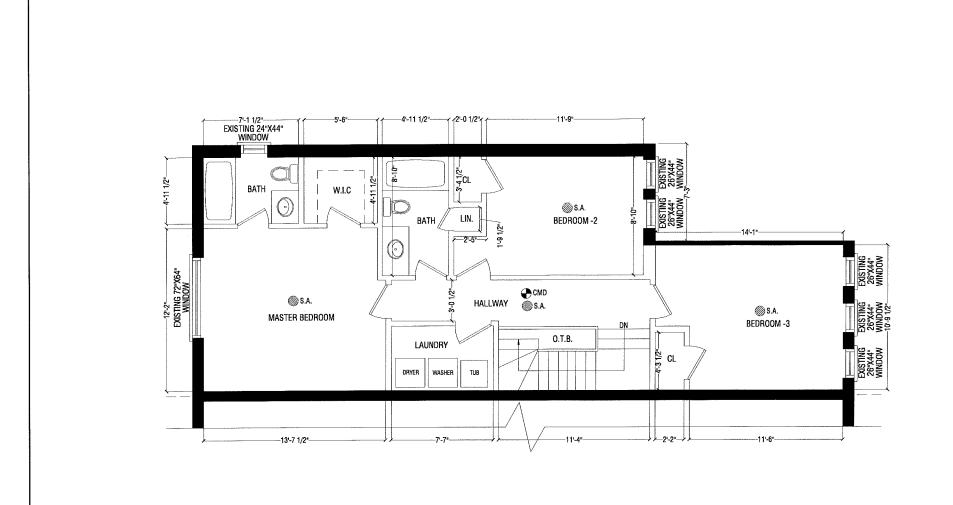

GENERAL NOTES:

- ALL EXISTING SITE CONDITIONS AND ALL DIMENSIONS ON DRAWINGS MUST BE CHECKED AND VERIFIED ON SITE BY CONTRACTOR, ANY VARIANCES OR DISCREPANCIES MUST BE REPORTED TO THE DESIGNER/ENGINEER PRIOR TO COMMENCEMENT OF THE WORK.

- ALL THE WORK SHALL BE CARRIED OUT IN ACCORDANCE WITH THE LATEST VERSION OF ONTARIO BUILDING CODE AND REQUIREMENTS OF AUTHORITIES HAVING JURISDICTION.

- ALL FIRE SAFETY SYSTEM TO BE ACTIVE DURING AND AFTER CONSTRUCTION. - IF EXISTING CONSTRUCTION IS DAMAGED DURING THE WORK, CONTRACTOR TO MAKE GOOD TO MATCH

EXISTING. - DO NOT SCALE THE DRAWING.

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01	SCHEMATIC	06.11.2024
No.	DESCRIPTION	DATE
PROJ	ECT:	

67 LAURAGLEN CRESCENT BRAMPTON ONTARIO

TITLE:

EXISTING SECOND FLOOR PLAN

CONSULTANT:


PAVLO PALAGUT

(416 528 3834) palagut@gmail.com

Df	RAWN BY: A.B.K	CHECKED BY: P.P
D	ATE: 06.11.2024	DRAWING NO:
S	3/16"=1'-0"	A-5

LEGEND:

CEILING HEIGHT = 8'-0"

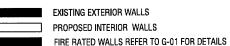

NOTES: ALL WINDOWS EXISTING UNLESS OTHERWISE SPECIFIED FOR DETAILED SPECIFICATIONS AND LEGENDS SEE DWG. N-1

CONSTRUCTION NOTES:

ALL CONSTRUCTION TO ADHERE TO THESE PLANS AND SPEC'S AND TO CONFORM TO THE ONTARIO BUILDING CODE AND ALL OTHER APPLICABLE CODES AND AUTHORITIES HAVING JURISDICTION. THESE REQUIREMENTS ARE TO BE TAKEN AS MINIMUM SPECIFICATIONS.

- EXTERIOR WALL CONSTRUCTION
 1/2" DRYWALL FINISH
 2"x4" WOOD STUD @ 16" O.C.
 1" AIR SPACE
 EXISTING ROLLED BATT INSULATION
 EXISTING VAPOUR BARRIER
 EXISTING 8" CONCRETE WALL
 EXISTING DAMP PROOFING PAPER
- 2 INTERIOR WALL CONSTRUCTION 1/2" DRYWALL 2"x4" WOOD STUD @ 16" O.C. 1/2" DRYWALL FINISH
- (3) INTERIOR WALL CONSTRUCTION 30 MIN FRR 1/2" DRYWALL FINISH 2"x4" WOOD STUD @ 16" O.C. 3 1/2" ROXULL SAFE 'N' SOUND INSULATION 1/2" DRYWALL FINISH
- CEILING: 1/2" GYPSUM BOARD PART 11 COMPLIANCE ALTERNATIVE C152 (9.10.9.14.(1) and (3);) In detached houses, semi-detached houses, townhouses and row houses containing not more than two dwelling units, 15 min horizontal fire separation is acceptable where, (i)smoke alarm are installed in every dwelling unit, sleeping rooms and in common areas in conformance with Subsection 9.10.19., and (ii)smoke alarms are interconnected.
- PART 11 COMPLIANCE ALTERNATIVE C95 (6.2.4.7.10); In a building containing not more than four dwelling units or residential suits, the existing heating or air-conditioning system may be altered to serve more than one dwelling unit or suite and provided smoke alarms are installed in each dwelling unit or suite and provided a smoke detector is installed in the supply or return air duct system serving the entire building which would turn off the fuel supply and electrical power to the heating system upon activation of such detector.
- 6 PART 11 COMPLIANCE ALTERNATIVE C152 (9.10.9.15(1)); In detached houses, semi-detached houses, townhouses and row houses containing not more than two dwelling units, the fireresistance rating of the fire separation is waived where the building is sprinklered.
- As per the requirements of OBC 9.10.19. Smoke alarms. All smoke alarms shall be interconnected with Audio and Visual Signal.
- As per the requirements of OBC 9.33.4
 A Carbon Monoxide Alarm shall be installed adjacent to every sleeping area for dwellings with fuel burning appliances.
- 9 EVERY DOOR IN A FIRE SEPARATION SHALL HAVE A SELF-CLOSING DEVICE.
 20 MIN FIRE PROTECTION RATING OF CLOSURE IS REQUIRED FOR 30 OR 45 MIN FRR OF FIRE SEPARATION.

- A LIGHT CONTROLLED BY A SWITCH IS REQUIRED IN EVERY KITCHEN, BEDROOM, LIVING ROOM, BATHROOM, VESTIBULE, HALLWAY, GARAGE AND CARPORT. A SWITCH RECEPTACLE MAY BE PROVIDED INSTEAD OF A LIGHT IN BEDROOMS AND LIVING ROOMS.
- PART 11 COMPLIANCE ALTERNATIVE C136 (9.9.9)
 In detached houses, semi-detached houses, townhouses and row houses containing not more than two dwelling units, exit requirements are acceptable if at least one of the following conditions exists:
 - (a.) a door, including a sliding door, that opens directly to the exterior from a dwelling unit, serves only that dwelling unit and has reasonable access to ground level, and the dwelling units are equipped with smoke alarms installed in conformance with Subsection 9.10.19..
 - (b.) an exit that is accessible to more than one dwelling unit, and provides the only means of egress from each dwelling unit, provided that the means of egress is separated from the remainder of the building and common areas by a fire separation having a 30 min fire-resistance rating and provided further that the required access to exit from any dwelling unit cannot be through another dwelling unit and common areas are provided with smoke alarms that are installed in conformance with Subsection 9.10.19 and are interconnected.
- ALL FRAMING LUMBER WHICH ARE SUPPORTED ON CONCRETE IN DIRECT CONTACT WITH SOIL SHALL BE SEPARATED FROM THE CONCRETE WITH 0.05MM POLYETHYLENE OR TYPE 'S' ROLL ROOFING.
- PART 11 COMPLIANCE ALTERNATIVE C102 (9.5.3.1)
 In detached houses, semi-detached houses, townhouses and row houses containing not more than two dwelling units,
 (a.) minimum room height shall not be less than 1950mm over the required floor area and in any location that would normally be used as a means of egress, or
 (b.) minimum room height shall not be less than 2030mm over at least 50% of the required floor area, provided that any part of the floor having a clear height of less than 1400mm shall no be considered in computing the required floor area.
- AN ADEQUATE SUPPLY OF COMBUSTION AIR MUST BE AVAILABLE FOR THE FURNACE AND HOT WATER TANK.
- THE FIRE SPRINKLER SYSTEM SHALL BE A FLOW THROUGH SYSTEM WITH A MINIMUM 3/4" COPPER PIPE CONNECTED TO AT LEAST A 3/4" COPPER WATER PIPE OR DIRECTLY AFTER THE WATER METER AND SHALL HAVE A SUPERVISED SHUT OFF SUPPLY VALVE.
- (16) AIR SUPPLY REGISTERS AT CEILING.
- (17) AIR RETURN REGISTERS AT FLOOR LEVEL.
- (18) EXHAUST FAN TO DIRECTLY DISCHARGE OUTSIDE.
- (19) UNDERCUT DOOR MIN 1" SHORT TO ANY ROOM WITHOUT RETURN GRILL.
- BATTERY POWERED EMERGENCY LIGHTING UNITS CONFORMING TO CSA C22.2 NO. 141 "EMERGENCY LIGHTING EQUIPMENT" SHALL BE PROVIDED IN ANY COMMON MEANS OF EGRESS

- 21) 2"X6" STUD 16" O.C.(2"X6") SIL PLATE ON DAMP PROOFING MATERIAL (1/2") DIA. ANCHOR BOLTS 8" LONG EMBEDDED MIN. (4") INTO CONCRETE 7"-10" O.C. (4") HIGH CONCRETE CURB ON (14"X6") CONCRETE FOOTING ADD HORIZONTAL BLOCKING AT MID-HEIGHT IF WALL IS UNFINISHED
- 22) INTERIOR WALL CONSTRUCTION 30 MIN FRR "TYPE C"
 1/2" DRYWALL FINISH
 2"x6" WOOD STUD @ 16" O.C.
 5 1/2" ROXULL SAFE 'N' SOUND INSULATION
 1/2" DRYWALL FINISH
- PROVIDE SMOKE DETECTOR IN THE SUPPLY OR RETURN AIR DUCT SYSTEM TO TURN OFF THE FUEL SUPPLY AND ELECTRICAL POWER TO THE HEATING SYSTEM UPON ACTIVATION OF SMOKE DETECTOR. SEE NOTE 5.
- PROVIDE SPRINKLERS IN AREAS WITH UNFINISHED CEILING. NEW SPRINKLER SYSTEM TO BE PROVIDED. SEE NOTE 15 GAS PROOF ALL CEILING VOIDS.
- 25 20 MIN RATED DOOR AND FRAME WITH SELF CLOSING DEVICE.
- Shut-off valves shall be installed in every suite in a building of residential occupancy as may be necessary to ensure that when the supply to one suite is shut off the supply to the remainder of the building is not interrupted.

LEGEND

CMD	CARBON MONOXIDE DETECTOR	
S.A.	SMOKE ALARM INTERCONNECTED	
SAO	WARM AIR REGISTER	
≅RAI	RETURN AIR REGISTER	
•	EXHAUST FAN	
CL	CLOSET	
EP	ELECTRICAL PANEL	
⊗ FD		
¤	LIGHT FIXTURE	
\$	SWITCH	
\$3	THREE WAY SWITCH	
	SPRINKLERS	

GENERAL SPECIFICATIONS:

ALL DRAWING TO BE USED FOR CONSTRUCTION ONLY WHEN APPROVED BY MUNICIPALITY ACCOMPANIED WITH THE BUILDING PERMIT. CONTRACTOR MUST VERIFY ALL DIMENSIONS ON THE JOB AND REPORT ANY DISCREPANCY TO THE DESIGNER BEFORE PROCEEDING WITH WORK

MANUFACTURED ITEMS MATERIALS AND CONSTRUCTION MUST COMPLY WITH ALL REQUIREMENTS OF CANADA MORTGAGE AND HOUSING CORPORATIONS (C.M.H.C.) AND CANADIAN STANDARDS ASSOCIATION (C.S.A).

DESIGNER SHALL TAKE NO RESPONSIBILITY FOR THE CONSTRUCTION OF THE PROJECT.

THE DRAWINGS ARE NOT TO BE SCALED

GENERAL NOTES: FERIAL - ALL EXISTING SI

- ALL EXISTING SITE CONDITIONS AND ALL DIMENSIONS ON DRAWINGS MUST BE CHECKED AND VERIFIED ON SITE BY CONTRACTOR. ANY VARIANCES OR DISCREPANCIES MUST BE REPORTED TO THE DESIGNER/ENGINEER PRIOR TO COMMENCEMENT OF THE WORK.

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01	SCHEMATIC	06.11.202
No.	DESCRIPTION	DATE
PROJ	ECT:	

67 LAURAGLEN CRESCENT BRAMPTON ONTARIO

TITLE:

CONSTRUCTION NOTES

CONSULTANT

PAVLO PALAGUT (416 528 3834)

(416 528 3834) palagut@gmail.com

DRAWN BY: A.B.K	CHECKED BY: P.P
DATE: 06.11.2024	DRAWING NO:
SCALE: 3/16"=1'-0"	N-1

Zoning Non-compliance Checklist

File No	1
A-2024-043	8

Owner: Kamaljeet Chana

Address: 67 LAURAGLEN CRES

Zoning: R2B-2883

By-law 270-2004, as amended

Category	Proposal	By-law Requirement	Section #
USE			"
LOT DIMENSIONS AREA / DEPTH / WIDTH			
BUILDING SETBACKS FRONT / SIDE / REAR			
BUILDING SIZE			
BUILDING HEIGHT			
GFA			
TOWER SEPARATION			
BELOW GRADE ENTRANCE			
ACCESSORY STRUCTURE SIZE / HEIGHT			
MULTIPLE ACCESSORY STRUCTURES			
DRIVEWAY WIDTH			
LANDSCAPED OPEN SPACE			
ENCROACHMENTS			
PARKING			
SCHEDULE "C"			
OTHER	To permit 1 (one) parking space for a single detached dwelling containing 1 (one) additional residential unit.	whereas the by-law requires a minimum of 2 (two) parking spaces for a single detached dwelling containing 1 (one) additional residential unit.	10.9.1.A

Ross Campbell
Reviewed by Zoning
Nov.00. 2024
Nov 09, 2024
Date