Flower City



FILE NUMBER: A- 20 24 -0459

The Personal Information collected on this form is collected pursuant to section 45 of the Planning Act and will be used in the processing of this application. Applicants are advised that the Committee of Adjustment is a public process and the information contained in the Committee of Adjustment files is considered public information and is available to anyone upon request. Questions about the collection of personal information should be directed to the Freedom of Information and Privacy Coordinator, City of Brampton.

APPLICATION Minor Variance or Special Permission

(Please read Instructions)

NOTE: It is required that this application be filed with the Secretary-Treasurer of the Committee of Adjustment and be accompanied by the applicable fee.

The undersigned hereby applies to the Committee of Adjustment for the City of Brampton under section 45 of the Planning Act, 1990, for relief as described in this application from By-Law 270-2004.

Name of C	wner(s) Amarjeet Singh/	Darsnan Didar Kaur	
Address	32 Willick Pl, Brampton, C	ON L6X4Z6	
5			
Phone #	647 876 7300	Fax #	_
Email	amarjeets@gmail.com	I ax #	
			
	VALIUDDIN MO	OH A MMED	
Name of A			
Address	6 Ripon St., Mississaug	a, ON LATTE2	
Phone #	416 627 4100	Fax #	
Email	INFO@MECHWAYS.COM		
Nature an	d extent of relief applied for (va	riances requested):	
		ullow a minimum side yard set back of 0.64	m whereas
1.2m i	required.		
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Why is it	not possible to comply with the	provisions of the by-law?	
	not possible to comply with the		line. However, the as
1.The be	elow grade entrance requires m	inimum1.2m setback to the side property	
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1.The besetback	elow grade entrance requires m	inimum1.2m setback to the side property 0.64 m. Hence seeking the relief for this 0.5	
1.The besetback Legal Des	elow grade entrance requires mof the below grade entrance is the below grade entrance is scription of the subject land:	LOT 113 MAP D3	
1.The besetback Legal Des Lot Numb	elow grade entrance requires mof the below grade entrance is of the below grade entrance is escription of the subject land:	LOT 113 MAP D3 PLAN M1409	
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1.The besetback Legal Des Lot Numb Plan Num Municipal	scription of the subject land: ber/Concession Number Address 32 Wi	LOT 113 MAP D3 PLAN M1409 Blick Pl,Brampton, ON L6X4Z6	
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Legal Des Lot Numb Plan Num Municipal Dimension Frontage Depth Area	scription of the subject land: ber ber/Concession Number Address 32 Wi	LOT 113 MAP D3 PLAN M1409 llick Pl,Brampton, ON L6X4Z6 8.93m 31.88m	
Legal Des Lot Numb Plan Num Municipal Dimension Frontage Depth Area	scription of the subject land: ber/Concession Number Address 32 Wi	LOT 113 MAP D3 PLAN M1409 llick Pl,Brampton, ON L6X4Z6 8.93m 31.88m 284.69 sqm	

8. Particulars of all buildings and structures on or proposed for the subject land:

(specify in metric units ground floor area, gross floor area, number of storeys, width, length, height, etc., where possible) **EXISTING BUILDINGS/STRUCTURES** on the subject land: Ground Floor Area - 80.31 Gross Floor Area - 183.05 Number of Storeys-2 PROPOSED BUILDINGS/STRUCTURES on the subject land: Ground Floor Area - 80.31 Gross Floor Area - 183.05 Number of Storeys-2 9. Location of all buildings and structures on or proposed for the subject lands: (specify distance from side, rear and front lot lines in metric units) **EXISTING** 6.05m Front yard setback 8.73m Rear yard setback Side yard setback 0.56 m Side yard setback 0.64 m **PROPOSED** 6.05m Front yard setback 8.73m Rear yard setback Side yard setback 0.56m Side yard setback 0.64m 2024 10. Date of Acquisition of subject land: Residential 11. Existing uses of subject property: Residential 12. Proposed uses of subject property: Residential 13. Existing uses of abutting properties: 2001 14. Date of construction of all buildings & structures on subject land: Since 2001 15. Length of time the existing uses of the subject property have been continued: 16. (a) What water supply is existing/proposed? Municipal Other (specify) Well What sewage disposal is/will be provided? (b) Other (specify) Municipal Septic (c) What storm drainage system is existing/proposed? Sewers **Ditches** Other (specify) ---**Swales**

17. Is the subject property the subject of an application under the Planning Act, for approval of a plan of subdivision or consent? _	
Yes No	
If answer is yes, provide details: File #Status	
18. Has a pre-consultation application been filed?	G.
Yes No V	Z PE
19. Has the subject property ever been the subject of an application for minor variance?	PA
Yes No√ Unknown PUBLIC	TI
If answer is yes, provide details:	and the
File # Decision Relief File # Decision Relief	
File # Decision Relief Relief	
Amiet Su	
Signature of Applicant(s) of Admorized Agent	
THIS A DAY OF 120 24	
IF THIS APPLICATION IS SIGNED BY AN AGENT, SOLICITOR OR ANY PERSON OTHER THAN THE OWNER OF	
THE SUBJECT LANDS, WRITTEN AUTHORIZATION OF THE OWNER MUST ACCOMPANY THE APPLICATION. IF THE APPLICANT IS A CORPORATION, THE APPLICATION SHALL BE SIGNED BY AN OFFICER OF THE	
CORPORATION AND THE CORPORATION'S SEAL SHALL BE AFFIXED.	
Valiaddin Mohammed HINN City OF Mississauga	
IN THE Region OF Peel SOLEMNLY DECLARE THAT:	
ALL OF THE ABOVE STATEMENTS ARE TRUE AND I MAKE THIS SOLEMN DECLARATION CONSCIENTIOUSLY BELIEVING IT TO BE TRUE AND KNOWING THAT IT IS OF THE SAME FORCE AND EFFECT AS IF MADE UNDER OATH.	
DECLARED BEFORE ME AT THE	E I
City OF larouto	
IN THE Trauling OF Ortanio THIS 28th DAY OF November 20 29 Signature of Applicant or Authorized Agent	
Outario THIS 28 DAY OF	
Signature of Applicant or Authorized Agent	1
- Wated	
A Cammissioner etc.	
Rameshbhai Somabhai Patel Ramesh Patel L. Associate Lawyers FOR OFFICE USE ONLY	
Professional of the Presignation: 127 Westmore Dr. Unit # 101,	
Tel: 416-742-2999 Fax: 416-742-3888 This application has been reviewed with respect to the variances required and the results of the mail@rplawbffice.net said review are outlined on the attached checklist.	
Zoning Officer Date	
DATE RECEIVED DEC 13/2025	

APPOINTMENT AND AUTHORIZATION OF AGENT

To: The Secretary-Treasurer
Committee of Adjustment
City of Brampton
2 Wellington Street West
Brampton, Ontario
L6Y 4R2

LOCATION	ON OF THE SUBJECT LAND:	32 WILLICK Pl, BRAMPTON, ON, L6X4Z6
I/We,	Amarjeet Singh Darshan Didar Kaur please	print/type the full name of the owner(s)
the unde	rsigned, being the registered	owner(s) of the subject lands, hereby authorize
Mechwa	ys Inc.	
-		print/type the full name of the agent(s)
	application to the City of Brain variance with respect to the	mpton Committee of Adjustment in the matter of an application e subject land.
Dated th	is day of	, 20 7/11/2024
(sigr	ارمان المعارضة المعا	Darshan owner is a firm or corporation, the signature of an officer of the owner.)
	(where the owner is a firm or corp	poration, please print or type the full name of the person signing.)

NOTE: If the owner is a firm or corporation, the corporate seal shall be affixed hereto.

PERMISSION TO ENTER

To: The Secretary-Treasurer
Committee of Adjustment
City of Brampton
2 Wellington Street West
Brampton, Ontario
L6Y 4R2

32 WILLICK Pl, BRAMPTON, ON, L6X4Z6 LOCATION OF THE SUBJECT LAND: **Amarjeet Singh** Darshan Didar Kaur I/We, please print/type the full name of the owner(s) the undersigned, being the registered owner(s) of the subject land, hereby authorize the Members of the City of Brampton Committee of Adjustment and City of Brampton staff members, to enter upon the above noted property for the purpose of conducting a site inspection with respect to the attached application for Minor Variance and/or consent. Dated this day of , 20____. 27/11/2024 Inojet Sayl Darshan (signature of the owner[s], or where the owner is a firm or corporation, the signature of an officer of the owner.) (where the owner is a firm or corporation, please print or type the full name of the person signing.)

NOTE: If the owner is a firm or corporation, the corporate seal shall be affixed hereto.

NO DISCUSSION SHALL TAKE PLACE BETWEEN THE COMMITTEE MEMBERS AND THE APPLICANT DURING THE SITE INSPECTION



Valiuddin Mohammed <info@mechways.com>

Submission: 24 427916 000 00 PREA - Rework Required

rose.bruno@brampton.ca <rose.bruno@brampton.ca>

To: INFO@mechways.com
Cc: amarjeets@gmail.com

21 November 2024 at 19:10

Please note that the above mentioned submission requires rework.

Address of the Property: 32 Willick PI, Brampton, ON, L6X 4Z6

Application Type: Permit to Construct or Demolish

Review Type: PRE - Zoning Screening

Rework Details: The below grade entrance requires a minimum 1.2 metre setback to the side property line.

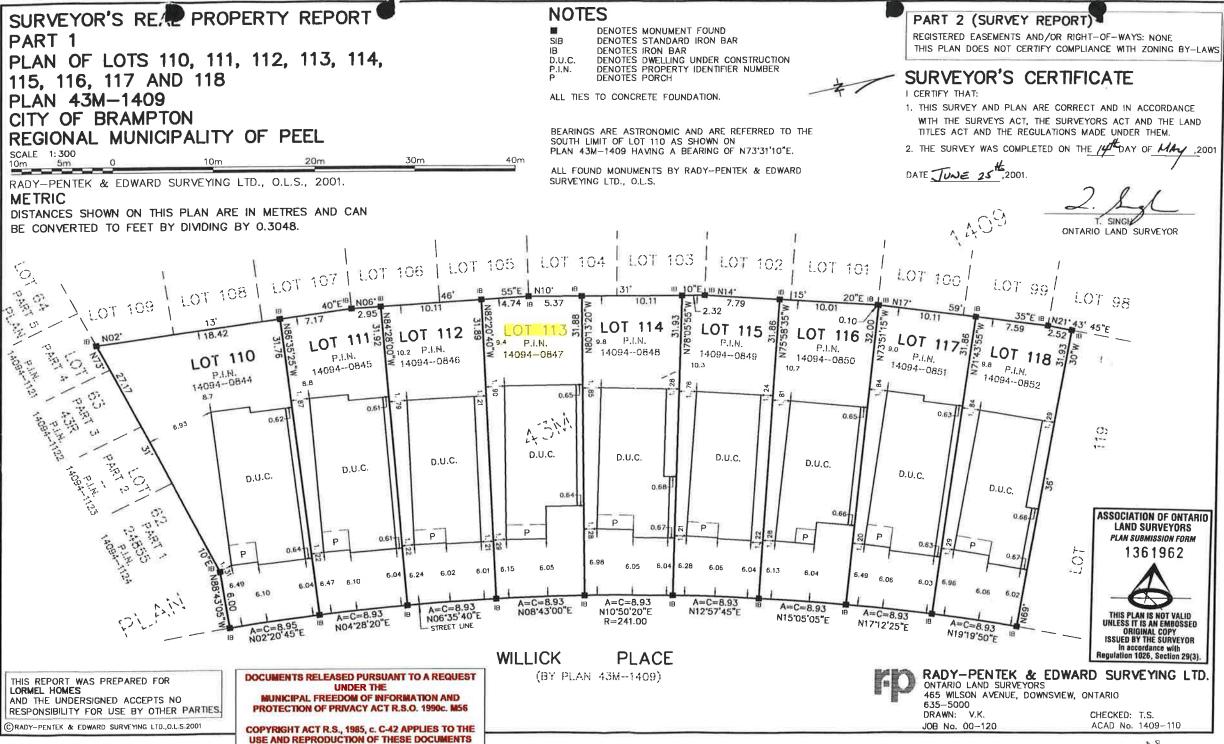
Please log into the Brampton Building and Business Portal and complete the rework requested. Once completed please click the 'Rework Completed' button so that the reviewer can be notified. You DO NOT NEED to submit a new application.

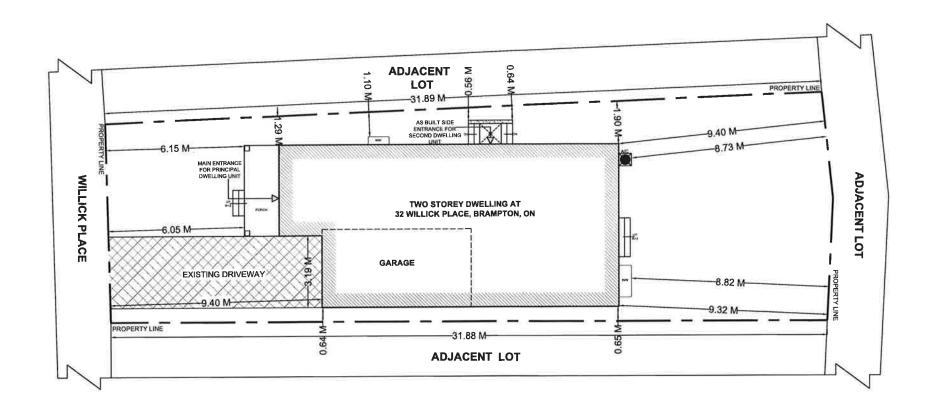
If there is no response by 21-DEC-24 your application will automatically be cancelled.

You can log into the Brampton Building and Business Portal by clicking the following link. https://bramptonbbp.brampton.ca/citizenportal/app/login

Thank You

Please review the City of Brampton e-mail disclaimer statement at: http://www.brampton.ca/EN/Online-Services/Pages/Privacy-Statement.aspx





AREA STATISTICS: **GROSS FLOOR AREA CALCULATIONS** A. PRINCIPAL RESIDENCE $= 864.50 \, \text{ft}^2 / 80.31 \, \text{m}^2$ MAIN FLOOR G.F.A = 1105.97 ft² / 102.74 m² SECOND FLOOR G.F.A = 1970.47 ft² / 183.06 m² TOTAL G.F.A B. = 864.50 ft² / 80.31 m² BASEMENT G.F.A BASEMENT APARTMENT G.F.A = 864.50 ft² / 80.31 m² **ENTRANCE / EGRESS**

SCOPE OF WORK

- A. LEGALIZATION OF AS BUILT BASEMENT TO **BASEMENT APARTMENT**
- **ENLARGEMENT OF TWO EXISTING WINDOWS**
- LEGALIZATION OF AS BUILT BELOW GRADE ENTRANCE

GENERAL NOTES:

GENERAL NOTES:

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WORK, THE DRAWINGS AND

DOCUMENTS PROVIDED HERE WITHIN

MECHHAY'S INC. REPRODUCTION OF

THE DOCUMENTS PROVIDED IS

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THE DESIGNER SHALL

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1	IBBUED FOR BUILDING PERMIT	NOV 16. 2
NO.	DESCRIPTION	DATE

ENGINEER:



Mechways Inc.

ADDRESS : 6 RIPON STREET

MISSIESAUGA, DN. L4T 1E2

TEL : 416-527-4100

EMAIL : INFO@MECHWAYS.COM

WEBSITE : WWW.MEDHWAYS.COM

CONSULTANT:

PROJECT:

BASEMENT APARTMENT AT 32 WILLICK, BRAMPTON, DN

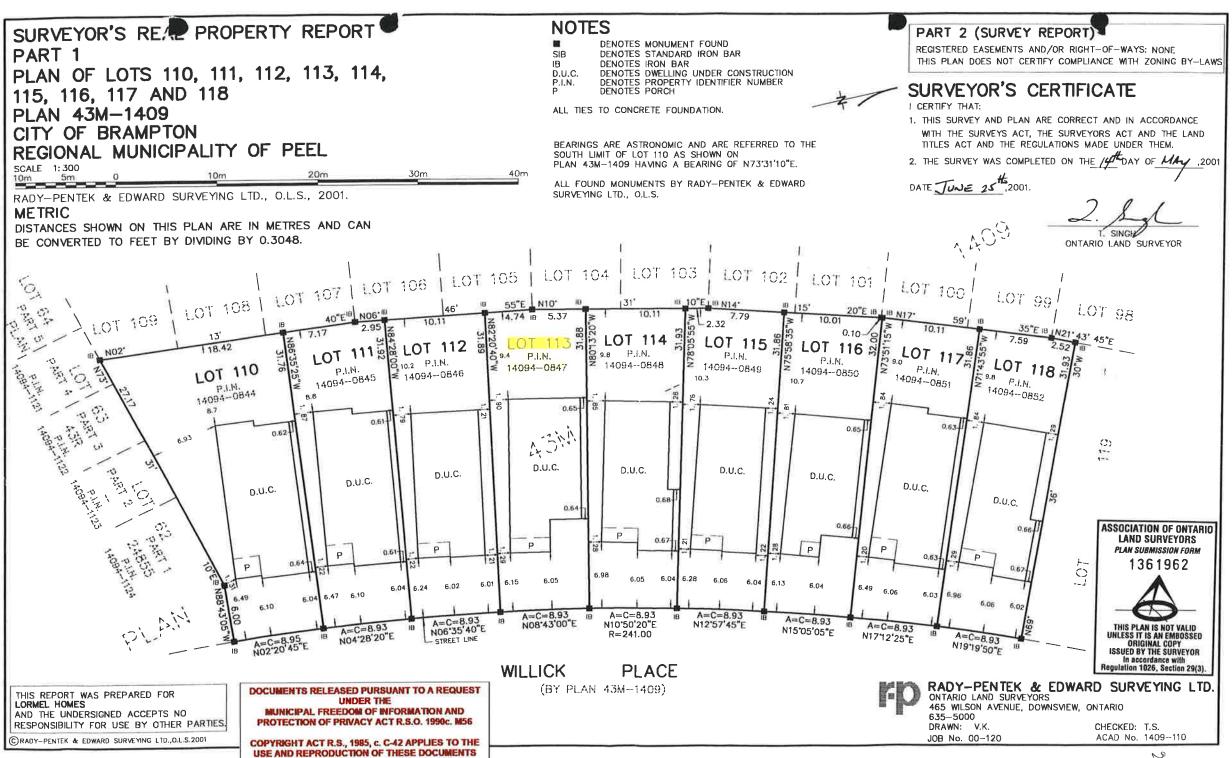
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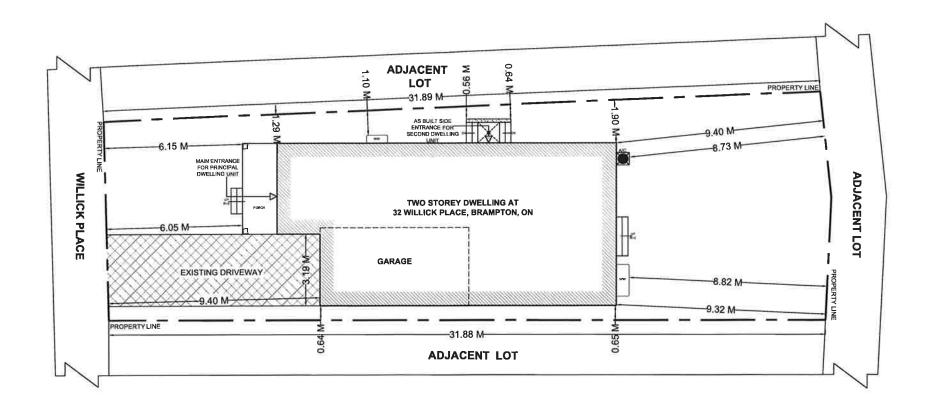
SITE PLAN

CHECKED: GS DRAWN: GS SCALE: 1:125 DATE: NOV 16, 2024



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AREA STATISTICS: **GROSS FLOOR AREA CALCULATIONS** A. PRINCIPAL RESIDENCE MAIN FLOOR G.F.A $= 864.50 \text{ ft}^2 / 80.31 \text{ m}^2$ SECOND FLOOR G.F.A = 1105.97 ft² / 102.74 m² TOTAL G.F.A = 1970.47 ft² / 183.06 m² B. = 864.50 ft² / 80.31 m² BASEMENT G.F.A BASEMENT APARTMENT G.F.A = 864.50 ft² / 80.31 m² ENTRANCE / EGRESS

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- B. ENLARGEMENT OF TWO EXISTING WINDOWS
- C. LEGALIZATION OF AS BUILT BELOW GRADE ENTRANCE

GENERAL NOTES:

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ì	IBBUED FOR BUILDING PERMIT	NOV 16, 20
ND.	DESCRIPTION	DATE

ENGINEER:



Mechways Inc.

TEL : 416-627-4100 EMAIL : INFP@MECHWAYS.COM

CONSULTANT:

PROJECT:

BASEMENT APARTMENT AT 32 WILLICK, BRAMPTON, ON

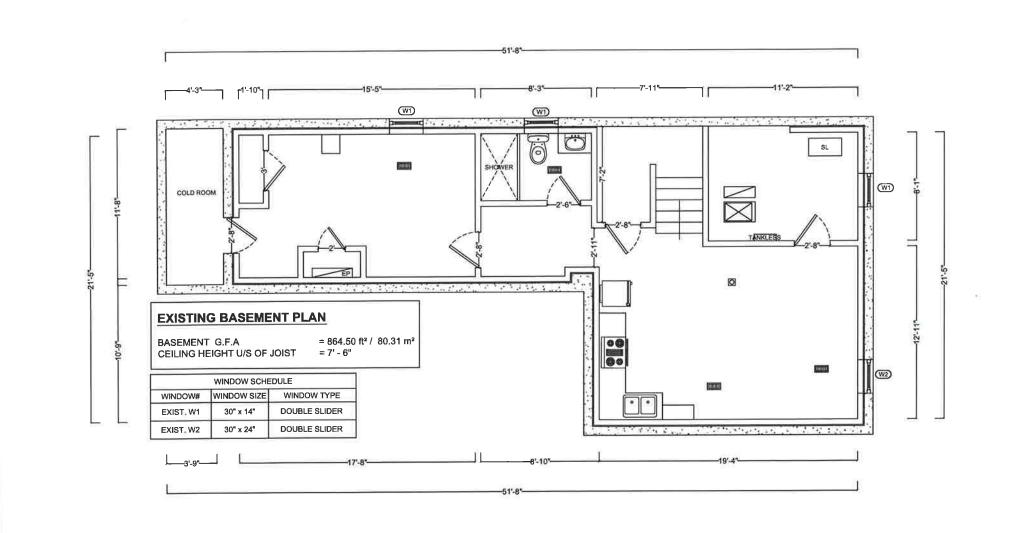
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SITE PLAN

CHECKED: BS DRAWN: GS SCALE: 1: 125 DATE: NOV 16, 2024



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1	ISSUED FOR BUILDING PERMIT	NDV 16, 2024
ND.	DESCRIPTION	DATE

ENGINEER:



Mechways Inc.

ADDRESS : 6 RIPON STREET MISSISSAUGA, UN. L41 162
TEL: :416-627-4100
EMAIL: INFO@MECHWAYS.COM
WEBSITE: WWW.MECHWAYS.COM

CONBULTANT:

PROJECT:

BASEMENT APARTMENT AT 32 WILLICK, BRAMPTON, ON

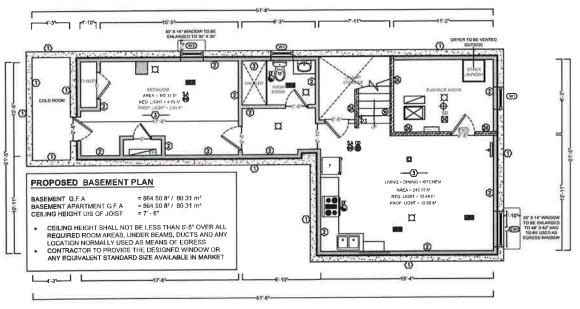
SHEET TITLE:

EXIST. BASEMENT PLAN

CHECKED: GS DRAWN: GS SCALE: 3 / 16" = 1' - 0" DATE: NOV 16, 2024



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WINDOW SCHEDULE
WINDOW# WINDOW SIZE WINDOW TYPE

30" x 14"

30° x 30°

EXIST, W1

PROP_EW1

DOUBLE SLIDER

SINGLE CASEMENT

EGRESS WINDOW OPENING INSIDE

DOUBLE SLIDER

CALCULATION OF GLASS AREA AS PER COMPLIANCE ALTERNATIVE C107 PART 11 OF OBC 2012

GLASS AREA

REQUIRED

@ 5% = 12.48

162 11 @ 2.5% = 4.05

GLASS AREA

12.60

5.62

TYPE

EW1

W3

ROOM

249.72

LIVING + DINING+

BEDROOM

	LEGEND
(I)	EXISTING FOUNDATION WALL (8" THICK CONCRETE WALL, MOISTURE BARRIER, 2x4 STURE © 16" O.G. EXISTING INSULATION, 17" CYPSIAM ONVAIL JOINTS TAPED AND SEALER AND PAINTED)
0	DRY WALL (WOOD FRAMED WALL CONSISTING OF 2x4 WOOD STUDS @ 16" O.C. WITH 1/2" DRY WALL ON BOTH SIDES, JOINTS TAPED AND SEALED. WATER RESISTANT GWB ON BATTHROOMS WALLS)
20	PROVIDE 30 MINUTE F.R.R (SB3 W1C 36 x 69 mm WOOD STUDS @ 610 mm O.C W/ 12.7 mm REGULAR CYPSUM ON EACH SIDE W/ 89 mm THUCK ABSORPTIVE MATERIAL (ROCKWOOL INSULATION)) TO NEW/EXISTING WALL.
SD X	DUCT-TYPE SMOKE DETECTOR TO BE INSTALLED IN THE SUPPLY OR RETURN AIR DUCT SYSTEM SERVING THE ENTIRE BUILDING THAT MUST TURN OFF THE FUEL SUPPLY AND ELECTRICAL POWER TO THE HEATING SYSTEM UPON ACTIVATION
8	SMOKE ALARMS W/STROBE LIGHT INSTALLED IN EVERY DWELLING UNIT AND COMMON AREAS IN CONFORMANCE WITH OBC 9.10 19 SMOKE ALARM SHALL BE WIRED AND INTERCONNECTED FOR THE ENTIRE BUILDING
8	CARBON MONO OXIDE ALARM
Ф	SPRINKLER
3	NEW / EXISTING HORIZONTAL SEPARATION 15 MINUTE F R.R (EXISTING CEILING)
8	EXHAUST FAN
*	EMERGENCY LIGHT
_	SAR (SUPPLY AIR REGISTER) 10" x 4"
	RAG (RETURN AIR GRILLE) 12" x 6"
8	PROVIDE 30 MINUTE F,R R (2 x ⅓ THICK TYPE 'X BOARD) UNDER THE \$TAIR SOFFIT/CEILING AND ON THE WALLS ENCLOSING STAIRWAYS CONNECTING BASEMENT TO MAIN FLOOR
n	цент
(FRD)	20 MIN, FIRE RESISTANCE RATED DOOR FOR COMMON AREA AND BETWEEN BUNGALOWAND PRINCIPAL RESIDENCE WITH SELF CLOSING DEVICE.
L1	2-2-36" WOOD UNTEL A. 1-3-6"x3-6"x0-25" STEEL LINTEL MINIMUM BEARING OF STEEL LINTEL 150 mm EACH SIDE MINIMUM BEARING OF WOOD
	LINTEL 90 mm ON EACH SIDE

GENERAL NOTES:

DRAWINGS ARE TO BE READ NOT BOALED.
CONTRACTOR MUBT VERIFY ALL
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REPORT ANY DISCREPANCIES TO THE
DESIGNARE BEFORE DOMENDING THE
DOCUMENTS PROVIDED HERE WITHIN ARE THE EXCLUSIVE PROPERTY OF
MCCHWAYS INC. REPRODUCTION OF
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ENGINEER:



NO.

Mechways Inc.

NOV 16, 2024

DATE

MISSISSAUGA, DN L4T 1E2
TEL : 416-627-4100
EMAIL : INFO@MECHWAYS, DOM
: WWW.MECHWAYS, GOM

ISSUED FOR BUILDING PERMIT

DESCRIPTION

CONBULTANT:

PROJECT:

BASEMENT APARTMENT AT 32 WILLICK, BRAMPTON, ON

SHEET TITLE:

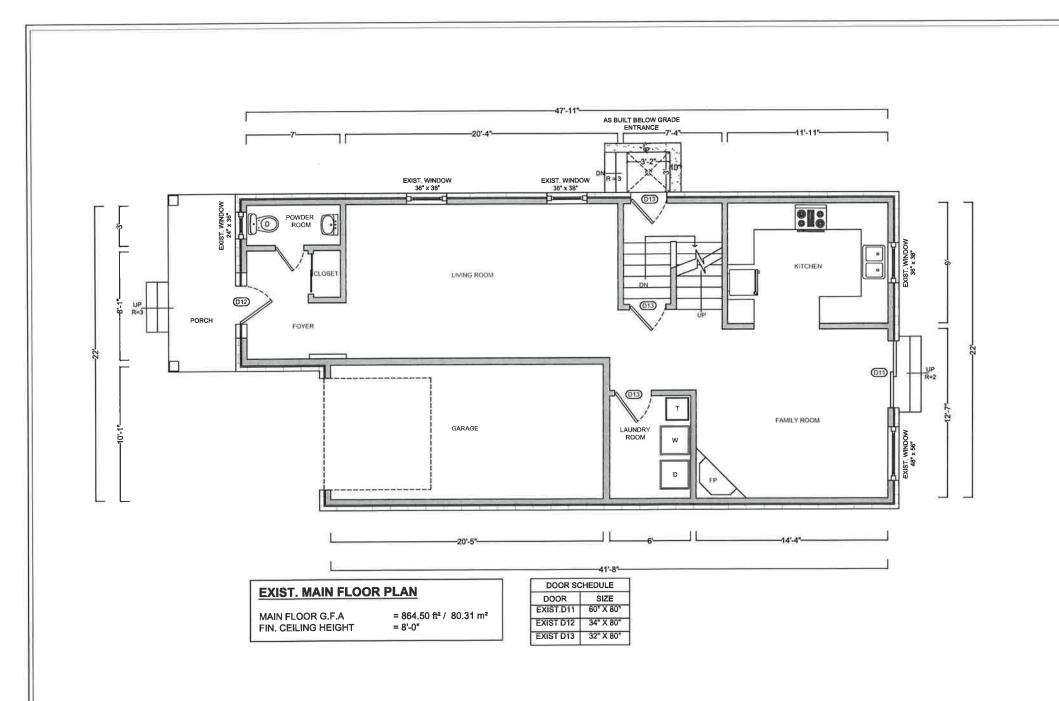
PROP. BASEMENT PLAN

CHECKED: GS
DRAWN: GS
SCALE: 1 / B" = 1' - 0"
DATE: NOV 16, 2024



DRAWING:

1.2



GENERAL NOTES:

DRAWINGS ARE TO BE READ NOT

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	1	ISSUED FOR BUILDING PERMIT	NOV 16, 202
1	NO.	DESCRIPTION	DATE

ENGINEER:



Mechways Inc.

ADDRESS: 6 RIPON STREET
MISSISSAUGA, ON L4T 1EZ
TEL: 415-627-41 IOC
EMAIL: INFO@MECHWAYS.COM
WEBSITE: WWW.MECHWAYS.COM

CONSULTANT:

PROJECT:

BASEMENT APARTMENT AT 32 WILLICK, BRAMPTON, ON

SHEET TITLE:

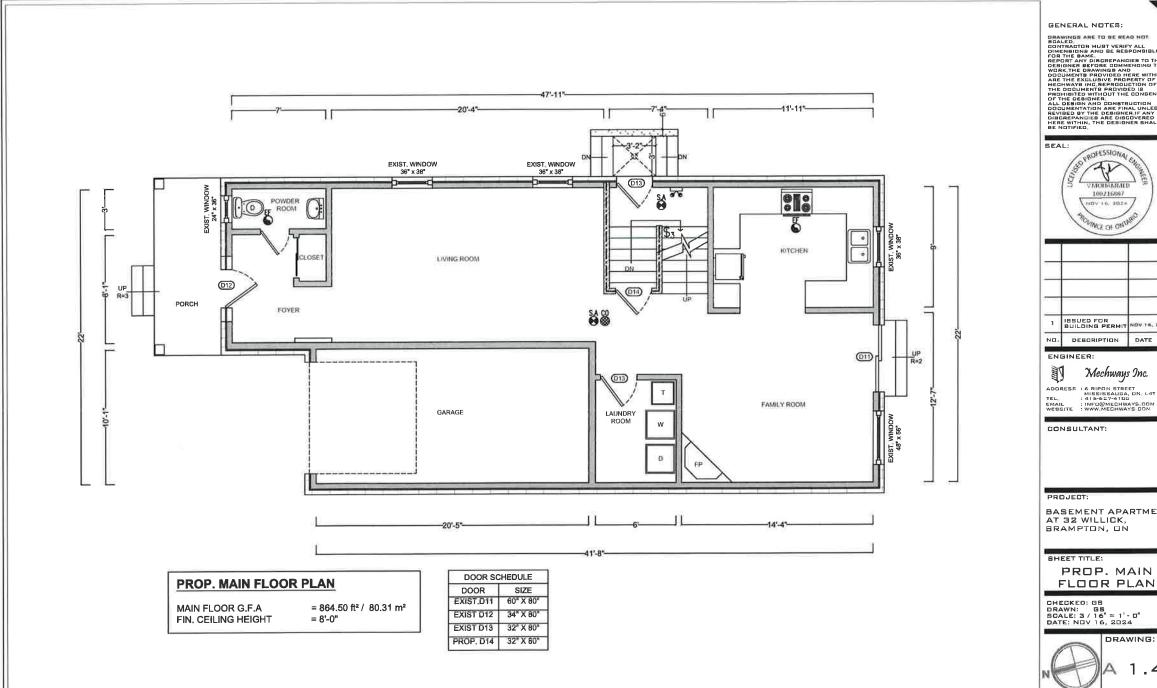
EXIST. MAIN FLOOR PLAN

CHECKED: G8
DRAWN: G8
BDALE: 3 / 16" = 1' - 0"
DATE: NOV 16, 2024



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GENERAL NOTIES:

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Mechways Inc.

ADDRESS : 6 RIPON STREET
MISSISSAUGA, ON, L4T 1E2
TEL : 415-627-4100
EMAIL : INFO@MECHWAYS DOM
WEBSITE : WWW.MECHWAYS DOM

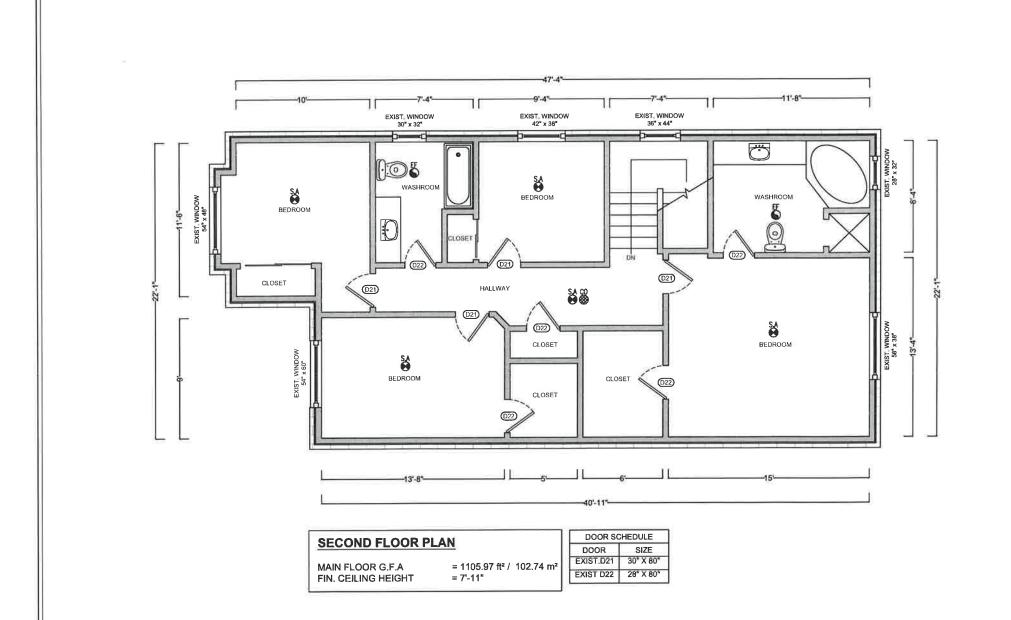
BASEMENT APARTMENT AT 32 WILLICK, BRAMPTON, ON

> PROP. MAIN FLOOR PLAN

CHECKED: GS DRAWN: GS SCALE: 3 / 16" = 1' - 0" DATE: NOV 16, 2024



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GENERAL NOTES:

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NET	DESCRIPTION	DATE
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ENGINEER:



Mechways Inc.

ADORESE : 6 RIPON STREET
MISSISSAUGA, ON: L4T 1E2
TEL: : 416-827-4100
EMAIL : INFO@MECHWAYS. COM
WEGSITE : WWW.MECHWAYS. COM

CONSULTANT:

PROJECT:

BASEMENT APARTMENT AT 32 WILLICK, BRAMPTON, ON

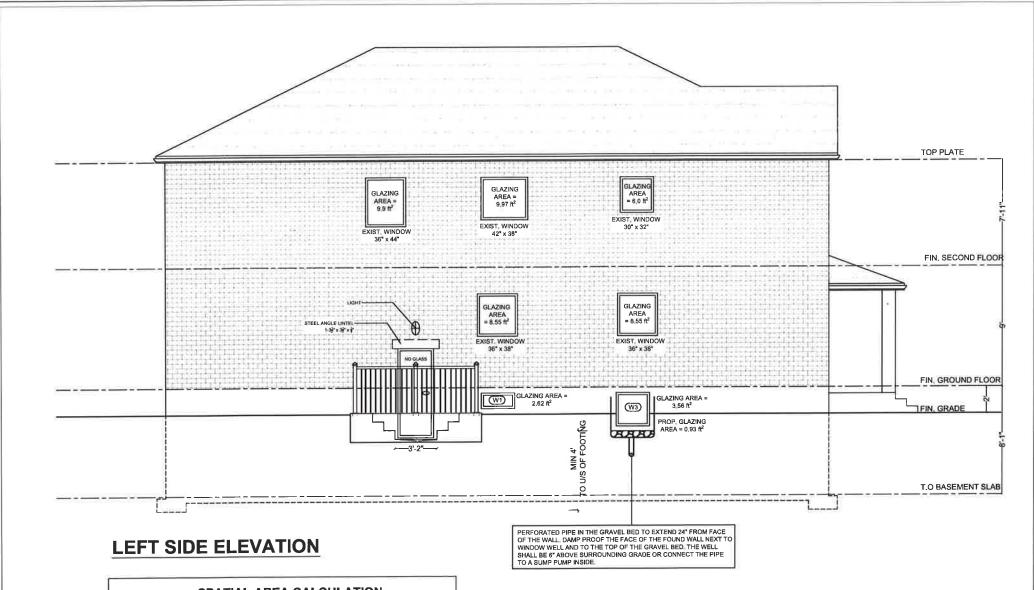
SHEET TITLE:

SECOND FLOOR PLAN

CHECKED: GS DRAWN: GS SCALE: 3 / 16" = 1' - 0" DATE: NOV 16, 2024



A 1.5



SPATIAL AREA CALCULATION

TOTAL WALL AREA / BUILDING FACE = 937.36 ft² / 87.08 m² = 1.2 m

LIMITING DISTANCE

MAXIMUM ALLOWABLE GLAZED AREA @ 7% = 65.61 ft² / 6.09 m² = 48.21 ft² / 4.47 m² EXISTING GLAZED AREA ABOVE GRADE PROPOSED GLAZED AREA ABOVE GRADE = 0.93 ft² / 0.08 m² TOTAL GLAZED AREA ABOVE GRADE = 49.14 ft² / 4.56 m²

GENERAL NOTES:

GENERAL NUITES:

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SOALED.

CONTRACTOR MUST VERIFY ALL

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MERCHANT HORSE THE CONTRACTOR

REVISED BY THE DESIGNER SHALL

BE NOTIFIED.



ISSUED FOR BUILDING PERMIT NOV 16, 2024

DESCRIPTION

ENGINEER:



Mechways Inc.

DATE

MISSISSAUGA ON LAT IEZ
TEL : 416-627-4100
DAL : INFO@MECHWAYS.COM
: WWW.MECHWAYS.COM

CONSULTANT:

PROJECT:

BASEMENT APARTMENT AT 32 WILLICK, BRAMPTON, ON

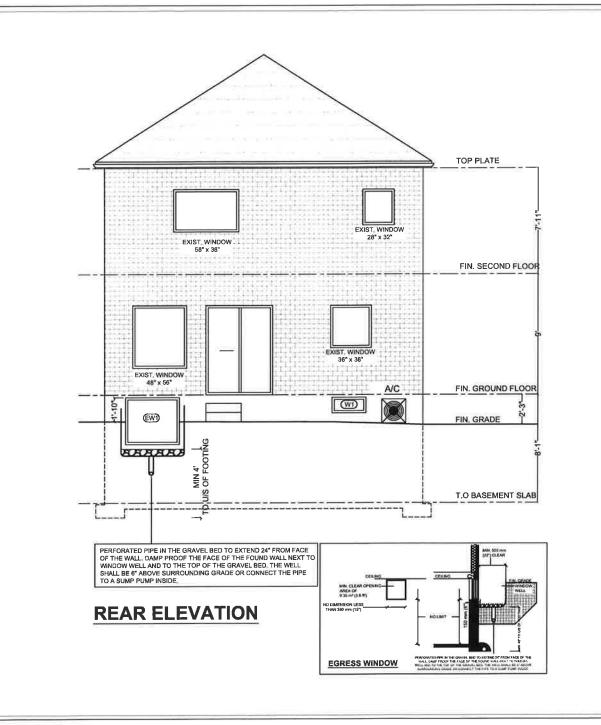
SHEET TITLE:

LEFT SIDE ELEVATION

CHECKED: GS
DRAWN: GS
SCALE: 3 / 16" = 1' · 0'
DATE: NOV 16, 2024

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GENERAL NOTES:

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CONSULTANT:

PROJECT:

BASEMENT APARTMENT AT 32 WILLICK, BRAMPTON, ON

SHEET TITLE:

REAR SIDE ELEVATION

CHECKED: GS
DRAWN: GS
SCALE: 3 / 16" = 1' - 0"
DATE: NOV 16, 2024

DRAWING:

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		R	OOM FINISH	ED SCHE	DULE - BASI	EMENT		
	FLOC	DR	WA	LL	CEILI	NG	исюнт	REMARKS
ROOM NAME	MATERIAL	FINISH	MATERIAL	FINISH	MATERIAL	MATERIAL FINISH	HEIGHT	REWARKS
LIVING, DINING, & KITCHEN	WOOD		DRYWALL	PAINT	GYPSUM BD.	PAINT		
BEDROOMS	WOOD		DRYWALL	PAINT	GYPSUM BD.	PAINT		
WASHROOMS	CERAMIC		DRYWALL	PAINT	GYPSUM BD.	PAINT		
UTILITY ROOM	CONCRETE		DRYWALL		GYPSUM BD.			

DOOR SCHEDULE

- 1. ALL INTERIOR DOORS ARE SLAB DOOR 1-3/8 TH, HOLLOW CORE, THE SIZES ARE MENTIONED ON THE FLOOR PLAN. THE HEIGHT OF ALL DOORS ARE 80"
- 2. EGRESS DOOR EXISTING ABOVE GRADE EXTERIOR TYPE STEEL DOOR PROVIDES ACCESS TO THE OUTSIDE

WINDOW SCHEDULE

ONE WINDOW PER FLOOR TO HAVE AN UNOBSTRUCTED OPEN PORTION W/A MIN. AREA OF $0.35 \,\mathrm{m}^2$ W/ NO DIMENSION LESS THAN 380mm & MAXIMUM SILL HEIGHT OF 1m ABOVE FLOOR WINDOW SIZES HAVE BEEN PROVIDED ON THE FLOOR PLANS

CONSTRUCTION NOTES

- FOUNDATION WALL INSULATION
 8" THICK CONCRETE WALL, MOISTURE BARRIER, 2x4 STUDS @ 16" O.C., EXISTING INSULATION. 1/2"
- GYPSUM DRYWALL JOINTS TAPED AND SEALED AND PAINTED

 INTERNAL WALLS
 WOOD FRAMED WALL CONSISTING OF 2x4 WOOD STUDS @ 16° O.C. WITH 1/2° DRY WALL ON BOTH

SIDES, JOINTS TAPED AND SEALED. WATER RESISTANT GWB ON BATHROOMS WALLS.

- 3 CEILING NEW / EXISTING HORIZONTAL SEPARATION 15 MINUTE F.R.R (EXISTING 1/2 " GYPSUM BOARD CEILING)
- EXISTING DUCT WORK LOCATED IN THE CEILING AND WALL HAS THE DIRECTION OF THE HEAT FLOW
 TOWARDS THE FLOOR
- MECHANICAL VENTILATION
 100 CFM EXHAUST FANS IN KITCHEN AND 50 CFM IN WASHROOM
- IN COMPLIANCE WITH C152(b) SMOKE ALARMS ARE INSTALLED IN EVERY DWELLING UNIT AND COMMON AREAS IN CONFORMANCE WITH OBC 9.10.19. SMOKE ALARM SHALL BE WIRED AND INTERCONNECTED FOR THE ENTIRE BUILDING
- PROVIDE CARBON MONOXIDE ALARM CONFIRMING TO CAN/CSA-6.19 "RESIDENTIAL CARBON MONOXIDE ALARMING DEVICES" ADJACENT TO EACH SLEEPING AREA WITHIN EACH DWELLING UNIT. CARBON MONOXIDE ALARMS MAY BE HARDWIRED, BATTERY OPERATED OR THE TYPE THAT CAN BE PLUGGED INTO ELECTRICAL OUTLET
- 8) FOR ALL ELECTRICAL WORK AND PERMIT CONTACT ELECTRICAL SAFETY AUTHORITY

GENERAL NOTES

- THE CONTRACTOR SHALL VERIFY ALL DIMENSIONS, SITE CONDITIONS AND ELEVATIONS WITH ARCHITECTURAL DRAWINGS AND RESOLVE ANY DISCREPANCIES WITH THE ENGINEER PRIOR TO START OF WORK
- ALL CONSTRUCTION SHALL BE IN ACCORDANCE WITH PART 9 AND 4 OF ONTARIO BUILDING CODE 2012 AND CITY BY-LAWS AND STANDARDS
- IT IS ASSUMED THAT THE WORK DEPICTED WILL BE PERFORMED BY AN EXPERIENCED CONTRACTOR AND/OR WORKMEN HAVING WORKING KNOWLEDGE OF THE APPLICABLE CODE, STANDARDS, INSURANCES AND REQUIREMENTS OF INDUSTRY ACCEPTED STANDARD, AS NOT EVERY CONDITION OR ELEMENT IS (OR CAN BE) EXPLICITLY SHOWN ON THESE DRAWINGS.
- BY COMMENCING CONSTRUCTION OF A BUILDING FROM THESE DRAWINGS, THE OWNER AND/OR BUILDER ACKNOWLEDGES THAT THE GENERAL NOTES HAVE BEEN READ AND UNDERSTOOD
- THE DRAWINGS PREPARED BY THE DESIGNER IS FOR THE PERMIT IN COMPLIANCE WITH OBC AND CITY BY-LAWS.
- THE DESIGNER IS NOT LIABLE FOR COST INCURRED FOR RE-WORK, ALTERATION, DISCREPANCIES OR ANY KIND OF CONSTRUCTION RELATED WORK
- ALL WOOD USED IN THE CONSTRUCTION SHALL BE SPF NO.1 OR NO.2
- . MINIMUM BEARING OF STEEL LINTELS 150 MM.
- MINIMUM BEARING OF WOOD BEAM / LINTELS 90 MM
- . MINIMUM BEARING OF WOOD JOISTS 40MM
- VERIFY EXISTING SUPPORT SYSTEM, INCLUDING FOUNDATIONS, FOR LOADS IMPOSED BY THE PROPOSED CONSTRUCTION
- PROVIDE ALL BRACING, SHORING AND NEEDLING NECESSARY FOR THE SAFE EXECUTION OF THIS WORK
- INFORM CITY OF ALL INSPECTION AHEAD OF TIME AND AT EACH STAGE OF CONSTRUCTION
- ANY DISCREPANCIES SHALL BE BROUGHT TO THE NOTICE OF ENGINEER PRIOR TO START OF WORK
- CONTRACTOR TO PROVIDE THE DESIGNED WINDOW / DOOR OR ANY EQUIVALENT STANDARD SIZE AVAILABLE IN MARKET

SWITCH

3 WAY SWITCH
INSTALL AT 3'-3" AFF
3 DENOTES 3-WAY SWITCH
SPECIFICATION GRADE WHITE,
WITH WHITE COVER PLATE
SHALL BE INSTALLED AT THE
ENDS OF EACH STAIRWAYS

15A, 120V DUPLEX RECEPTACLE
SPECIFICATION GRADE WHITE,
C/W WHITE COVER PLATE
GFI - GROUND FAULT TYPE
WP -WEATHERPROOF COVER

C - ABOVE COUNTER

RECEPTACLE 50A, 208V, STOVE OR DRIER OUTLET.

→ RECEPTACLE

SPOT LIGHT

MERGENCY LIGHT

FD: FLOOR DRAIN

⇒ SPRINKLER

DUCT TYPE SMOKE DETECTOR

SMOKE ALARM

CARBON MONOXIDE DETECTOR

│ 🐞 EXHAUST FAN

GENERAL NOTES:

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ı	NO.	DESCRIPTION	DATE

ENGINEER:



ADDRESS : 6 RIPON ETREET
MISSISSAUGA, ON L4T IE2
TEL : 416-527-4100
EMAIL : INFO@MECHWAYS.COM.
WEBSITE : WWW,MEDHWAYS.COM.

CONSULTANT:

PROJECT:

BASEMENT APARTMENT AT 32 WILLICK, BRAMPTON, ON

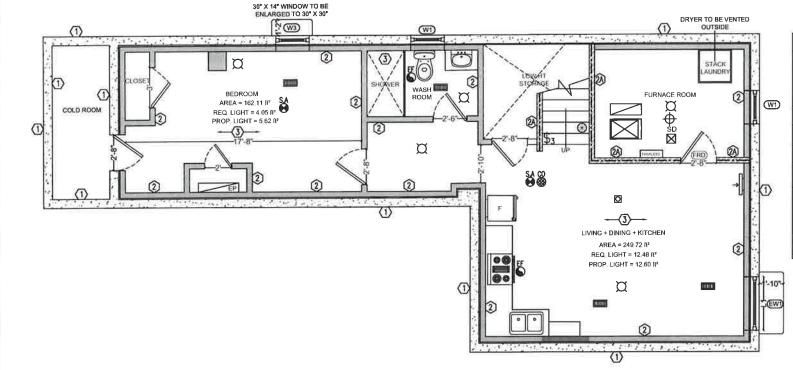
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GENERAL NOTES

CHECKED: GS DRAWN: GS SCALE: NT9 DATE: NOV 16, 2024

DRAWING:

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SD 🔀	DUCT-TYPE SMOKE DETECTOR TO BE INSTALLED IN THE SUPPLY OR RETURN AIR DUCT SYSTEM SERVING THE ENTIRE BUILDING THAT MUST TURN OFF THE FUEL SUPPLY AND ELECTRICAL POWER TO THE HEATING SYSTEM UPON ACTIVATION
ф	SPRINKLER
5	EXHAUST FAN
HIIBI	SAR (SUPPLY AIR REGISTER) 10" x 4"
1	RAG {RETURN AIR GRILLE} 12" x 6"

FURNACE DETAILS

MAKE : LENNOX

MODEL NO: CX35-18/24B-6F-20 SERIAL NUMBER: 1521K21172

GENERAL NOTES:

GENERAL NOTES:

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ENGINEER:



Mechways Onc.

ADDRESS: L R.PDIL STREET
MISBISSAUBA, DN. L4T 1E2
1416-627-4145-500
EMAIL: INFE@NECHWAYS.DDM
WEBSITE: WWW.MECHWAYS.DDM

CONBULTANT:

PROJECT:

BASEMENT APARTMENT AT 32 WILLICK, BRAMPTON, ON

SHEET TITLE:

HVAC PLAN

CHECKED: G\$

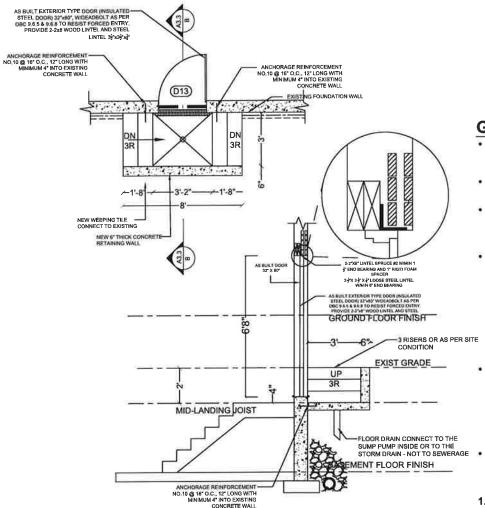
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SCALE: 3 / 16" = 1' - 0"

DATE: NOV 16, 2024

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- ALL WORK ACCORDING TO ONTARIO BUILDING CODE 2012 AND CITY OF BRAMPTON BY-LAWS
- ALL WORKING ACCORDING TO GOOD CONSTRUCTION PRACTICES
- UNDISTURBED SOIL OR COMPACTED GRANULAR FILL WITH A MINIMUM BEARING CAPACITY OF 75 KPA
- WHERE THE FOUNDATIONS OF A BUILDING ARE TO BE CONSTRUCTED BELOW THE LEVEL OF THE FOOTINGS OF AN ADJACENT BUILDING AND WITHIN THE ANGLE OF REPOSE OF THE SOIL, OR THE UNDERPINNING EXCEEDS 1200mm OF LATERALLY UNSUPPORTED HEIGHT OR THE SOIL IS CLAY OR SILT, THE UNDERPINNING & RELATED CONSECUTION SHALL BE DESIGNED BY A PROFESSIONAL ENGINEER.
- EXCAVATION SHALL BE UNDERTAKEN IN A MANNER SO AS TO PREVENT MOVEMENT WHICH WOULD CAUSE DAMAGE TO ADJACENT PROPERTIES, STRUCTURES, UTILITIES, ROADS & SIDEWALKS, CONTACT YOUR LOCAL UTILITIES PRIOR TO COMMENCING EXCAVATION.
- SHORE & BRACE WHERE NECESSARY TO ENSURE THE SAFETY & STABILITY OF THE EXISTING STRUCTURE DURING UNDERPINNING.

1. CONCRETE

- 1. MINIMUM COMPRESSIVE STRENGTH OF CONCRETE 32MPa @ 28 DAYS W/5% TO 8% AIR ENTRAINMENT.
- 2. MINIMUM YIELD STRENGTH OF STEEL 60 KSI.

3. EXTERIOR STAIRS

RISE 7 7/8" MAXIMUM 4 7/8" MINIMUM RUN 10" MINIMUM 14" MAXIMUM TREAD 10" MINIMUM 14" MAXIMUM TREAD SHOULD BE A MAX, OF 1" > RUN ADJUST STEP SIZE TO SUIT SITE

4. INSULATION

- ALL FOOTINGS SHALL REST ON NATURAL 4a. MIN. RSI 2.11 (R12) INSULATION & VAPOR BARRIER ON THE INSIDE FACE OF THE EXPOSED FOUNDATION WALL.
 - 4B PROVIDE 4" THICK RIGID STYROFOAM INSULATION UNDER THE STAIR SLAB AND LOWER LANDING AND OUTWARD FACE OF RETAINING WALLS.

RETAINING WALL

10" POURED CONCRETE WALL W/NO REINFORCING REQUIRED FOR WALL HEIGHTS TO A MAX. OF 1200mm, UNLESS MENTIONED OTHERWISE.

PROVIDE 15M VERTICAL STEEL REINFORCEMENT @ 12" O.C. AND 10M DISTRIBUTION REINFORCEMENT @12" O.C. PROVIDE MINIMUM 3" CONCRETE COVER FOR MAIN REINFORCEMENT PLACED TOWARD EARTH SIDE

6. GUARDS

42" HIGH WHERE DISTANCE FROM GRADE TO BOTTOM OF WALKOUT EXCEEDS 5'-11" 36" FOR LESSER HEIGHTS. MAXIMUM 4" BETWEEN VERTICAL PICKETS

7. EXTERIOR DOOR

BEARING OF 150MM

EXTERIOR TYPE DOOR (42MM INSULATED STEEL DOOR) SIZE 2'-8" x 6'-8", W/ DEADBOLT AS PER OBC 9.6.5 & 9.6.8TO RESIST FORCED ENTRY, PROVIDE LINTEL AS FOLLOWS: WOOD LINTEL: 2-2x8 SPF NO.1 OR NO.2 STEEL LINTEL: 1L 3 1/2"x3 1/2"x1/4" THICK

ANGLE STEEL LINTELS WITH MINIMUM

GENERAL NOTES:

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ENGINEER:



Mechways Inc.

ADDRESS : L A PO A ETRET
MISEISSAUGA, DN L4T 1E2
TEL : 416-627-4100
EMAIL : INFO@MECHWAYS.DDM
WEBSITE : WWW.MECHWAYS.DDM

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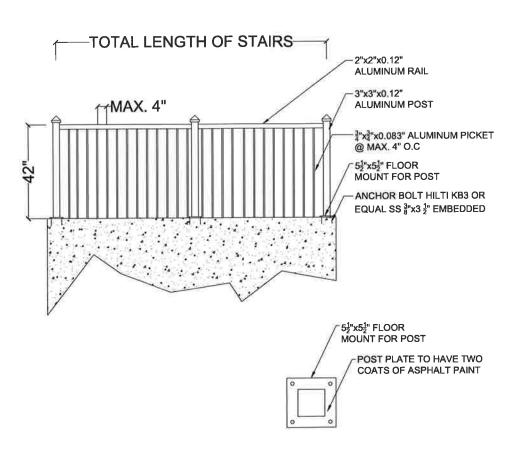
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BELOW GRADE DETAILS

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GENERAL NOTES:

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MECHWAYS INC, REPRODUCTION OF

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1 BSUED FOR BUILDING PERMIT NOV 16, 2024

DESCRIPTION

ENGINEER:



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ADDRESS : 6 RIPON STREET
MISSISSAUGA, DN. L4T 1E2
TEL : 416-627-4100
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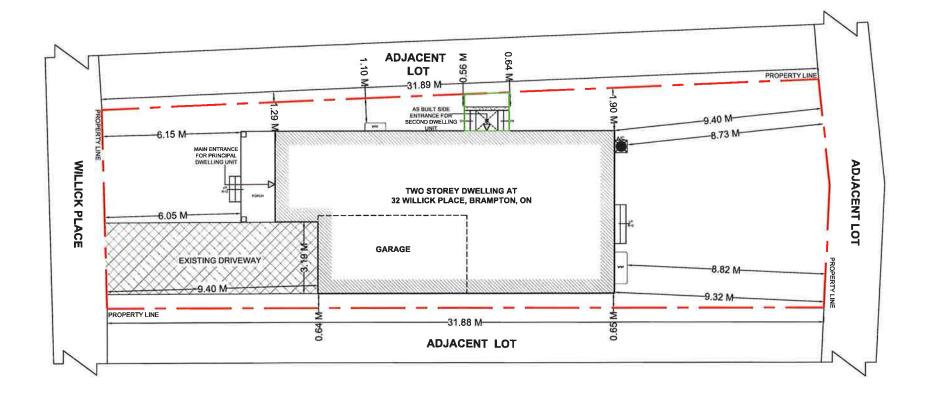
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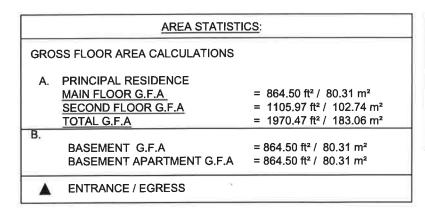
GUARD RAIL **DETAILS**

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SCALE: 3 / B" = 1' - 0"
DATE: NOV 16, 2024

DRAWING:

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SCOPE OF WORK

- A. LEGALIZATION OF AS BUILT BASEMENT TO **BASEMENT APARTMENT**
- B. ENLARGEMENT OF TWO EXISTING WINDOWS
- C. LEGALIZATION OF AS BUILT BELOW GRADE **ENTRANCE**

GENERAL NOTES:

SEAL:



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NO.	DESCRIPTION	DATE

ENGINEER:



Mechways Inc.

MISSISSAUGA, DN LAT) ES

EL : 416-627-4100

EL AL : INFO@MECHWAYS. GOM

: WWW.MECHWAYS. GOM

CONSULTANT:

PROJECT:

BASEMENT APARTMENT AT 32 WILLICK, BRAMPTON, ON

SHEET TITLE:

SITE PLAN

CHECKED: GS DRAWN: GS SCALE: 1:125 DATE: NOV 16, 2024



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Zoning Non-compliance Checklist

File No. A-2024- 0459

Applicant: Amarjeet Singh Address: 32 Willick Place Zoning: R1D Section 930 By-law 270-2004, as amended

Category	Proposal	By-law Requirement	Section #
USE			
LOT DIMENSIONS AREA / DEPTH / WIDTH			
BUILDING SETBACKS FRONT/ SIDE / REAR			
PATH OF TRAVEL			
BELOW GRADE ENTRANCE	To permit an interior side yard setback of .56 metres to an existing exterior stairway leading to a below grade entrance.	Whereas the by-law requires a minimum interior side yard setback of 1.2 metres on one side, and 0.6 metres on the other side.	930
	To permit an existing exterior stairway leading to a below grade entrance in a required side yard.	Whereas the by-law does not permit exterior stairways constructed below established grade in the required interior side yard.	10.23.1
COVERAGE		required interior erac yarar	
PARKING			
DRIVEWAY	_		
ACCESSORY STRUCTURE			
ACCESSORY STRUCTURE SIZE / HEIGHT			
MULTIPLE ACCESSORY STRUCTURES			
DRIVEWAY WIDTH			
LANDSCAPE OPEN SPACE			
SCHEDULE 'C'			
FENCE HEIGHT	i.		

Rose Bruno
Reviewed by Zoning