Flower City



For Office Use Only (to be inserted by the Secretary-Treasurer after application is deemed complete)

FILE NUMBER: A - 2024-0457

The Personal Information collected on this form is collected pursuant to section 45 of the Planning Act and will be used in the processing of this application. Applicants are advised that the Committee of Adjustment lies is considered public information and is available to anyone upon request and will be published on the City's website. Questions about the collection of personal information should be directed to the Secretary-Treasurer, Committee of Adjustment, City of Brampton.

APPLICATION Minor Variance or Special Permission

(Please read Instructions)

NOTE: It is required that this application be filed with the Secretary-Treasurer of the Committee of Adjustment and be accompanied by the applicable fee.

The undersigned hereby applies to the Committee of Adjustment for the City of Brampton under section 45 of the <u>Planning Act</u>, 1990, for relief as described in this application from By-Law **270-2004**.

1.	Name of Address	Owner(s) Agyei Peprah-/ 5 SUTHERLAND AVE, BRAN	Asiase and Irene S	arpong Peprah-Asiase	
	Phone # Email	416-939-1550 agyeipeprah@hotmail.co	om	Fax #	
2.	Name of Address	Agent ARYAN SHAR 96 KENNEDY RD SOUTH, U	MA NIT 206		
	Phone # Email	905-452-8200 info@thedesignfine.com		Fax #	
3.		nd extent of relief applied for DR VARIANCE FOR RED			M TO 4.07M
4.	Why is it	not possible to comply with ent minimum allowable fro	the provisions of the nt setback is 6.0 m	we propose 4.07 m.	
5.	Lot Num Plan Nur	scription of the subject land be <u>r 236</u> nber/Concession Number al Address <u>5 SUTHERLA</u>		ON	
6.	Dimension Frontage Depth Area	on of subject land (<u>in metric</u> 15.24 M 30.48 M 464.52 M	units)		
7.	Provinci Municipa	to the subject land is by: al Highway al Road Maintained All Year Right-of-Way		Seasonal Road Other Public Road Water	

8.	Particulars of all buildings and structures on or proposed for the subject land: (specify in metric units ground floor area, gross floor area, number of storeys, width, length, height, etc., where possible)				
	EXISTING BUILDINGS/STRUCTURES on the subject land: List all structures (dwelling, shed, gazebo, etc.)				
Detached Bungalow					
	PROPOSED BUILDINGS/STRUCTURES on the subject land:				
	Second story addi	ition attach to existin	g house.		
9.		_	uctures on or proposed for the subject lands: and front lot lines in <u>metric units</u>)		
	EXISTING				
	Front yard setback Rear yard setback	5.30 M 10.76 M			
	Side yard setback	1.86 M			
	PROPOSED Front yard setback Rear yard setback Side yard setback				
		10.76 M 1.86 M			
	Side yard setback	6.53 M			
10.	Date of Acquisition	of subject land:	unknown		
11.	Existing uses of sub	bject property:	RESIDENTIAL (TWO UNIT DWELLING)		
12.	Proposed uses of s	ubject property:	RESIDENTIAL (THREE UNIT DWELLING)		
13.	Existing uses of abo	utting properties:	RESIDENTIAL		
14.	Date of construction	n of all buildings & stru	uctures on subject land: 1960		
15.	Length of time the e	existing uses of the su	bject property have been continued: 6 YEARS		
16. (a)	What water supply Municipal Well	is existing/proposed?	Other (specify)		
(b)	What sewage dispo Municipal E Septic	osal is/will be provided]]	? Other (specify)		
(c)		ge system is existing/p	roposed?		
	Sewers Ditches Swales		Other (specify)		

17.	Is the subject p subdivision or		ect of an application und	der the Planning Act, for ap	proval of a plan of
	Yes	No 🔽			
	If answer is yes	, provide details	: File#	Status	
18.	Has a pre-cons	ultation applicati	on been filed?		
	Yes	No 🗹			
19.	Has the subject	property ever be	een the subject of an app	lication for minor variance	?
	Yes	No 🔽	Unknown		
	If answer is yes	, provide details	:		
	File#	Decision	\ 	Relief	
	File #	Decision		Relief Relief	
				1	
			Signa	ature of Applicant(s) or Autho	rized Agent
DATE	ED AT THE NO	/EMBER 28TH	OF <u>2024</u>		
THIS	28 DA	Y OF NOV	, 20 <u>24</u>		
F THIS A	PPLICATION IS	SIGNED BY AN	AGENT, SOLICITOR OR	ANY PERSON OTHER THA	N THE OWNER OF
				R MUST ACCOMPANY THE ALL BE SIGNED BY AN	
			'S SEAL SHALL BE AFFIX		OFFICER OF THE
	Davin	· One of	O.	col.	
I,	. Heyge	l Perrau	OF THE	CCH OF	sangton.
IN THE	Keepian (OF REE	SOLEMNLY	DECLARE THAT:	
				SOLEMN DECLARATION OF ME FORCE AND EFFECT A	
OATH.	GII IO BE IKO	E AND KNOWIN	Gagandeep Jaswa		3 IF MADE UNDER
DECLARE	D BEFORE ME	AT THE	Commissioner, e	10.,	
Atr.			Province of Ontari	o, of the	
	OF Bra	ampton	The second of th		
IN THE	Region	OF	Expires Septemb	er 20, 2026	ř
Peel	THIS L	Th DAY OF			
2	- · · · · · · · · · · · · · · · · · · ·				inad A want
acce	ember, 20	<u>d-9</u> ,	/ 519	nature of Applicant or Author	ized Agent
	CIT				
	A Commission	er etc.	1		
			FOR OFFICE USE ONL	.Y	
	Present Officia	l Plan Designatio	on:	•	<u>-</u> -
	Present Zoning	g By-law Classifi	cation:	4	<u>.</u>
	This application	n has been review	wed with respect to the var	iances required and the resul	ts of the
		Salu revie	w are outlined on the attac	Shou Greeklist.	
			.		<u>,</u>
		Zoning Officer		Date	
		DATE RECEIVE	Dec. 12,20	24	
		plication Deeme	d	<u> </u>	Revised 2022/02/17
	Complete b	y the Municipalit	y L		

APPOINTMENT AND AUTHORIZATION OF AGENT

To: The Secretary-Treasurer

Committee of Adjustment

City of Brampton

2 Wellington Street West

Brampton, Ontario

L6Y 4R2

coa@brampton.ca

LOCATION OF THE SUBJECT LAND: 5 SUTHERLAND AVE, BRAMPTON

I/We,

Agyei Peprah-Asiase

please print/type the full name of the owner(s)

the undersigned, being the registered owner(s) of the subject lands, hereby authorize

ARYAN SHARMA

please print/type the full name of the agent(s)

to make application to the **City of Brampton Committee of Adjustment** in the matter of an application for **minor variance** with respect to the subject land.

Dated this28

day of NOV

2024

(signature of the owner[s], or where the owner is a firm or corporation, the signature of an officer of the owner.)

(where the owner is a firm or corporation, please print or type the full name of the person signing.)

NOTE: If the owner is a firm or corporation, the corporate seal shall be affixed hereto.

NOTE: Unit owners within a Peel Standard Condominium Corporation are to secure authorization from the Directors of the Condominium Corporation in a form satisfactory to the City of Brampton, prior to submission of an application. Signatures from all Members of the Board of Directors are required.

PERMISSION TO ENTER

To: The Secretary-Treasurer
Committee of Adjustment
City of Brampton
2 Wellington Street West
Brampton, Ontario
L6Y 4R2

coa@brampton.ca

LOCATION OF THE SUBJECT LAND: 5 SUTHERLAND AVE, BRAMPTON

I/We, Agyei Peprah-Asiase

please print/type the full name of the owner(s)

the undersigned, being the registered owner(s) of the subject land, hereby authorize the Members of the City of Brampton Committee of Adjustment and City of Brampton staff members, to enter upon the above noted property for the purpose of conducting a site inspection with respect to the attached application for Minor Variance and/or consent.


Dated this 28 day of NOVEMBER , 2024 .

(signature of the owner[s], or where the owner is a firm or corporation, the signature of an officer of the owner.)

(where the owner is a firm or corporation, please print or type the full name of the person signing.)

NOTE: If the owner is a firm or corporation, the corporate seal shall be affixed hereto.

NO DISCUSSION SHALL TAKE PLACE BETWEEN THE COMMITTEE MEMBERS AND THE APPLICANT DURING THE SITE INSPECTION

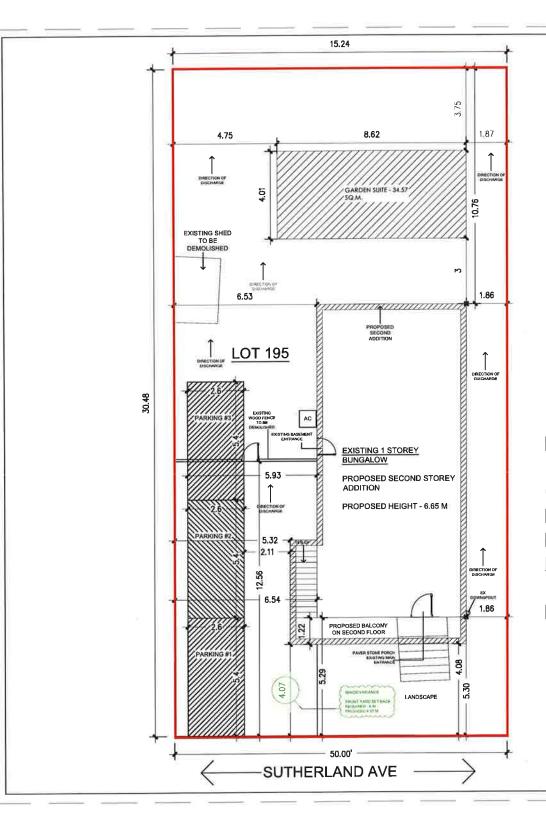

LOT COVERAGE: 30.71%

GARDEN SUITE - 34.57 SQM EXISTING SHED - TO BE DEMOLISHED EXISTING DWELLING - 98.23 SQM BALCONY - 9.84 SQM

LOT AREA - 464.52 SQM

 $\frac{\text{SITE PLAN}}{\text{SCALE-}\frac{3}{32}" = 1'0"}$

GENERAL NO

The contractor shall check and verify all dimensions and report all errors and omissions to the consultant. All drawings, specifications and related documents are copyright properties of the consultant and the copyright properties of the consultant and the copyright properties of the consultant and copyright properties of the consultant properties of the consult



PROJECT:

5 SUTHERLAND AVE

BRAMPTON

CLIENT:




CONSULTING ENGINEERS

96 KENNEDY ROAD SOUTH BRAMPTON, ON L6W 3E7 Ph. 905-452-8200 Fax: 905-452-8285 www.thedestgnfine.com

DRAWING TITLE

SITE KEY PLAN CH-GS-2024-0029

DESIGN AS	SCALE: AS NOTED	DRAWING NO
DRAWN: AS	DATE: JULY, 2024	C1
CHECKED:	PROJECT NO DEL-2024-24	31

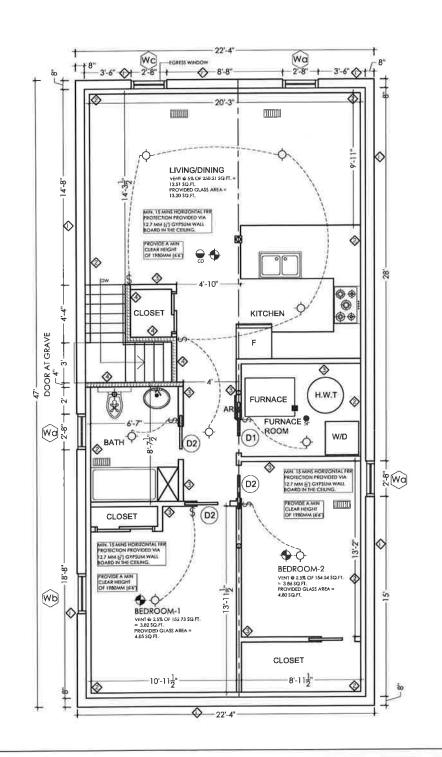

PROPOSED INTERIOR 38 X 140 @406 O/C 12.7 MM 1 GYPSUM WALL BOARD ON BOTH SIDES WITH 89MM THICK ABSORPTIVE MATERIAL FOR 30 MIN FRR (SB-3, TABLE 1-W1c)

PROPOSED INTERIOR 38 X 89 @406 O/C 12.7 MM GYPSUM WALL BOARDS ON BOTH THE SIDES

GYPSUM WALL BOARDS ON BOTH THE SIDES

> EXISTING 38 X 89 WOOD FRAMING @ 406 O.C. EXISTING INSULATION W/VAPOR BARRIER TO

EXISTING FOUNDATION WALL

LEGEND:

➡ ■ WIRED INTERCONNECTED SMOKE ALARM WITH VISUAL SIGNALING COMPONENT (STROBE) ■ - PROVIDE DUCT TYPE SMOKE DETECTOR WHICH

UPON ACTIVATION WILL TURN OFF FUEL SUPPLY AND ELECTRICAL TO THE HEATING SYSTEM


CLG MTD EXHAUST FAN POWERED BY ELECT, LIGHT SWITCH CONTD. TO O/S DAMPERED VENT

HEATING OUTLET

- ELECTRIC OUTLET

* SPRINKLER

CARBON MONO-OXIDE DETECTOR

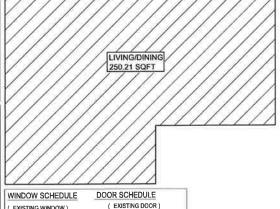

Wa 32" X 24" WINDOW Wb 36" X 18" WINDOW Wc 32" X 42" EGRESS

815 X 2100 (32" X 80") D-1 POCKET DOOR

765 X 2100 (30" X 80") POCKET DOOR

GENERAL NOTES:

1 ALL WORK SHALL CONFORM TO THE ONTARIO BUILDING CODE O. REG. 332 /12 AS AMENDED DIV. B. PART 7.

ELECTRICAL NOTES:

WINDOW

- 1... ALL THE ELECTRICAL INSTALLATIONS MUST BE INSPECTED BY THE ELECTRICAL SAFETY AUTHORITY.
- 2. ALL SMOKE ALARMS ARE LOCATED WITH CONFORMATION OF OBC. DIV.B 9.10.19.3.

PLUMBING NOTES:

- 1... ALL THE PLUMBING SHALL CONFORM TO THE ONTARIO BUILDING CODE O. REG. 332 /12 AS AMENDED DIV. B. PART 7.
- 2. PRESSURE BALANCE OR THERMOSTATIC MIXING VALVE REQUIRED ON SHOWER AS PER OBC DIV.B 7.6.5.2.(1)
- 3. THE MAXIMUM HOT WATER TEMPERATURE SUPPLIED TO THE FIXTURES IN RESIDENTIAL OCCUPANCIES SHALL NOT EXCEED 49° C (120° F) AS PER OBC ARTICLE 7.6.5.1. DISHWASHER AND CLOTHES WASHERS ARE EXEMPT FROM THIS REQUIREMENT.
- CONFORM TO CAN/CSA-B125 "PLUMBING FIXTURES" AND BE LABELED ACCORDINGLY.
- FLOW THROUGH SYSTEM WITH A MINIMUM A 3" COPPER WATER PIPE OR DIRECTLY AFTER THE WATER METER.

NOTE: THE INSTULLATION OF CARBON MONOXIDE DETECTOR S SHALL COMPLY WITH

- : INSTALLATION OF HVAC EQUIPMENTS SHALL CONFORM TO MANUFACTURE'S SPECIFICATIONS AND MANUALS
- : MECHANICAL VENTILATION SHALL BE PROVIDED IN CONFORMANCE WITH OBC DIV B.9.32.3 REQUIREMENTS.

EXISTING BASEMENT PLAN

 $SCALE \frac{3}{16}$ " = 1'

ALL THERMOSTATIC VALVES SHALL


THE FIRE SPRINKLER SYSTEM SHALL BE A

OBC DIV B.9.33.4 REQUIREMENTS.

The contractor shall check and verify all dimensions and report all errors and omissions to the consultant All drawings, specifications and related documents are the copyright property of DESIGN FINE LTD, and may not be reproduced without their permission. Do not scale drawings. This drawing shall not be used for construction purposes unless issued for construction and signed by DESIGN FINE LTD.

GENERAL NOTE



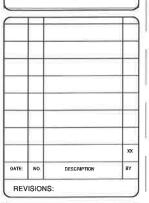

PROJECT: **5 SUTHERLAND AVE**

CLIENT:




CONSULTING ENGINEERS

96 KENNEDY ROAD SOUTH BRAMPTON, ON L6W 3E7 Pb: 905-452-8200 Fee: 805-452-8285 www.thedesignfine.com

EXISTING BASEMENT

DRAWING NO: AS NOTED DATE: MAY, 2022 DFL-2022-22

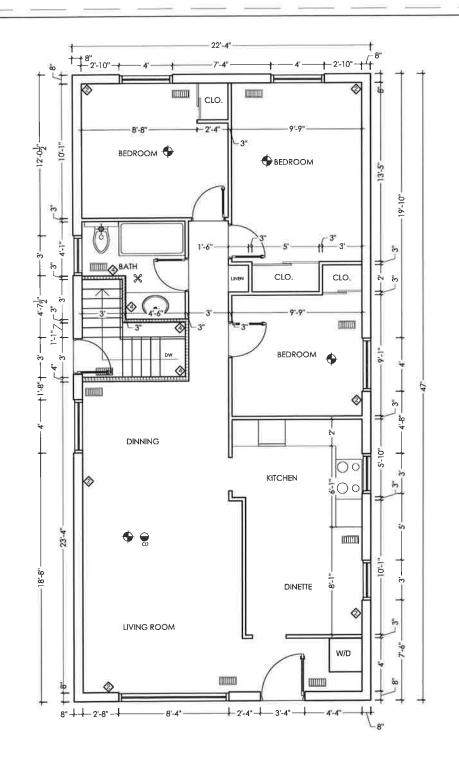



PROPOSED INTERIOR 38 X 140 @406 O/C 12.7
MM 3' GYPSUM WALL BOARD ON BOTH SIDES
WITH 89MM THICK ABSORPTIVE MATERIAL FOR
30 MIN FRR (SB-3, TABLE 1-W1c)

PROPOSED INTERIOR 38 X 89 @406 O/C 12.7 MM GYPSUM WALL BOARDS ON BOTH THE SIDES

SEXISTING INTERIOR 38 X 89 @406 O/C 12.7 MM GYPSUM WALL BOARDS ON BOTH THE SIDES TO REMAIN AS IS

EXISTING 38 X 89 WOOD FRAMING @ 406 O.C.
EXISTING INSULATION W/VAPOR BARRIER TO

EXISTING FOUNDATION WALL

LEGEND:

WIRED INTERCONNECTED SMOKE ALARM WITH VISUAL SIGNALING COMPONENT (STROBE)

■ - PROVIDE DUCT TYPE SMOKE DETECTOR WHICH UPON ACTIVATION WILL TURN OFF FUEL SUPPLY AND ELECTRICAL TO THE HEATING SYSTEM

CLG. MTD. EXHAUST FAN POWERED BY ELECT. LIGHT SWITCH CONTD. TO O/S DAMPERED VENT

HEATING OUTLET

ELECTRIC OUTLET
 SPRINKLER

§ .

CARBON MONO-OXIDE

DETECTOR

EXISTING MAIN FLOOR PLAN

SCALE $\frac{3}{16}$ " = 1'

GENERAL NOTE:

General, NO IE:
The contractor shall check and verify all dimensions and report all errors and ordisalons to the consultant. All drawings, specifications and railead documents are the copyright property of DESIGN FINE LTD. and may not be reproduced without high permission on not scale drawings. This drawing shall not be used for construction purposes unless issued for construction and signed by DESIGN FINE LTD.





PROJECT:

5 SUTHERLAND AVE

BRAMPTO

CLIENT




CONSULTING ENGINEERS

96 KENNEDY ROAD SOUTH BRAMPTON, ON L6W 3E7 Ph: 905-452-8200 Fax: 905-452-8285 www.thadestgriffne.com

DRAWING TITLE


EXISTING MAIN FLOOR

DESIGN: AS	SCALE: AS NOTED	DRAWING NO
DRAWN: AS	DATE: MAY, 2022	٨٥
CHECKED:	PROJECT NO DFL-2022-22	A2

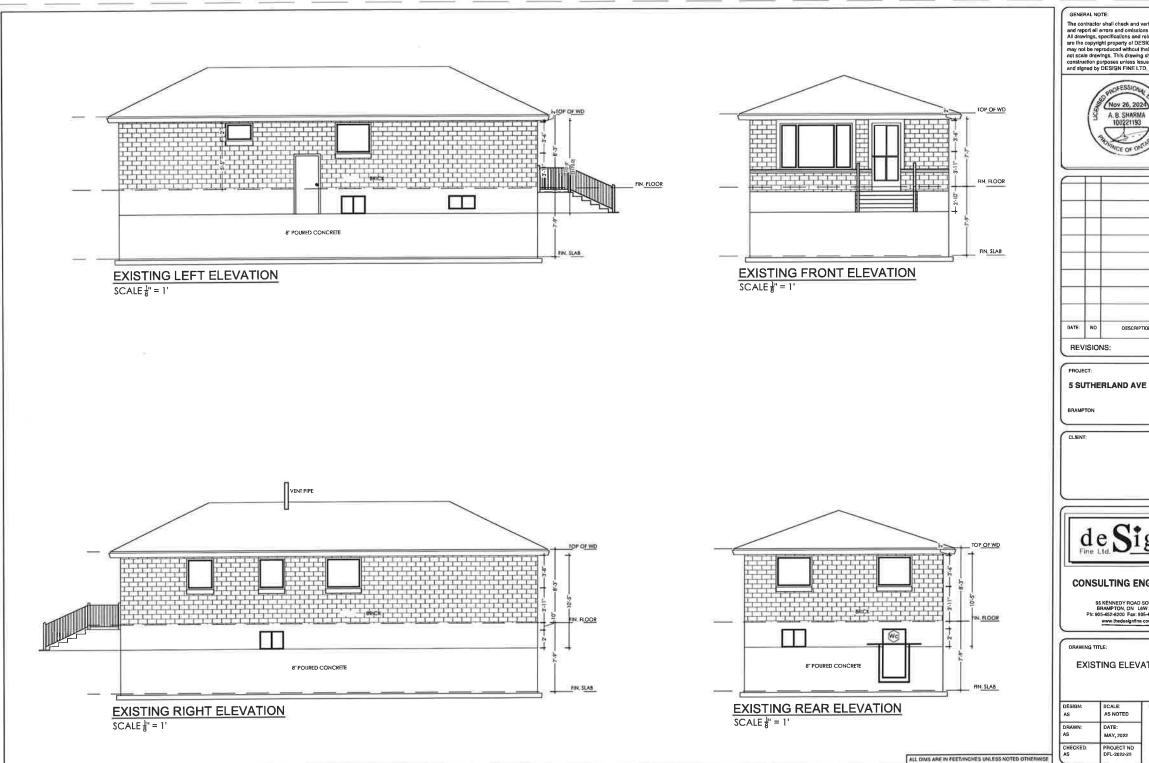

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BRAMPTON

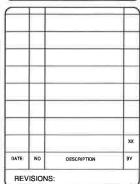


CONSULTING ENGINEERS

96 KENNEDY ROAD SOUTH BRAMPTON, ON L6W 3E7 Ph: 605-452-8200 Fax: 905-452-8285 www.thedesignfine.com

DRAWING TITLE:

EXISTING ELEVATIONS

DESIGN: AS	SCALE: AS NOTED	DRAWING NO
DRAWN: AS	DATE: MAY, 2022	۸2
CHECKED AS	PROJECT NO DFL-2022-22	AS

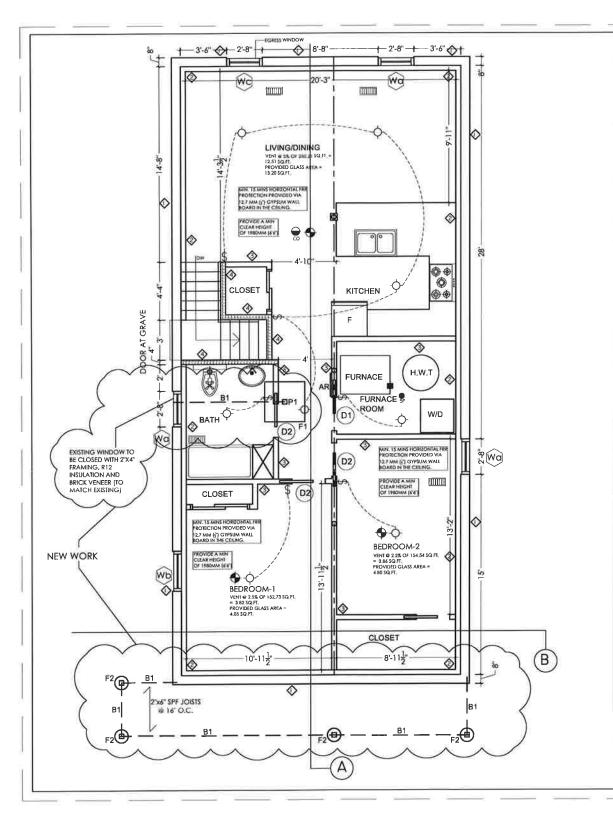

PROPOSED INTERIOR 38 X 140 @406 O/C 12.7 MM 2 GYPSUM WALL BOARD ON BOTH SIDES WITH 89MM THICK ABSORPTIVE MATERIAL FOR 30 MIN FRR (SB-3, TABLE 1-W1c)

PROPOSED INTERIOR 38 X 89 @406 O/C 12.7 MM GYPSUM WALL BOARDS ON BOTH THE SIDES

EXISTING INTERIOR 38 X 89 @406 O/C 12.7 MM GYPSUM WALL BOARDS ON BOTH THE SIDES TO REMAIN AS IS

> EXISTING 38 X 89 WOOD FRAMING @ 406 O.C. EXISTING INSULATION W/VAPOR BARRIER TO

EXISTING FOUNDATION WALL

LEGEND:

- ◆ WIRED INTERCONNECTED SMOKE ALARM WITH VISUAL SIGNALING COMPONENT (STROBE)
- PROVIDE DUCT TYPE SMOKE DETECTOR WHICH UPON ACTIVATION WILL TURN OFF FUEL SUPPLY AND FLECTRICAL TO THE HEATING SYSTEM
- → CLG. MTD. EXHAUST FAN POWERED BY ELECT. LIGHT SWITCH CONTD. TO O/S DAMPERED VENT

HEATING OUTLET

\$ ELECTRIC OUTLET

- SPRINKLER - CARBON MONO-OXIDE DETECTOR

BI - 3 PLY LVL BEAM 14" X 13" 2.1E W/ MIN BEARING OF 3.5" EACH SIDE.

FI - 36"X36"XI0" M32 CONCRETE FOOTING WITH I5 REBAR @ I2" BOTH WAYS

PI - 4"X4" SPF WOOD POST ATTACHED TO CONCRETE FOOTING VIA STEEL SADDLE

F2 - I2" DIA X 4' DEEP SONO TUB FOUNDATION - M32 CONCRETE, 4"X4" SPF WOOD POST ATTACHED VIA STEEL SADDLE, CONT' UP TO SECOND FLOOR

DOOR SCHEDULE

(EXISTING DOOR)

WINDOW SCHEDULE

(EXISTING WINDOW) Wa 32" X 24" WINDOW Wb 36" X 18" WINDOW

WINDOW

D-1 815 X 2100 (32" X 80") POCKET DOOR Wc 32" X 42" EGRESS

765 X 2100 (30" X 80") POCKET DOOR

GENERAL NOTES:

1. ALL WORK SHALL CONFORM TO THE ONTARIO BUILDING CODE O, REG. 332/12 AS AMENDED DIV. B. PART 7.

ELECTRICAL NOTES:

- ALL THE ELECTRICAL INSTALLATIONS MUST BE INSPECTED BY THE ELECTRICAL SAFETY AUTHORITY.
- ALL SMOKE ALARMS ARE LOCATED WITH CONFORMATION OF OBC. DIV.B 9.10.19.3.

PLUMBING NOTES:

- 1. ALL THE PLUMBING SHALL CONFORM TO THE ONTARIO BUILDING CODE O. REG. 332 /12 AS AMENDED DIV. B. PART 7.
- 2. PRESSURE BALANCE OR THERMOSTATIC MIXING VALVE REQUIRED ON SHOWER AS PER OBC DIV.B 7.6.5.2.(1)
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- ALL THERMOSTATIC VALVES SHALL CONFORM TO CAN/CSA-B125 "PLUMBING FIXTURES* AND BE LABELED ACCORDINGLY.
- THE FIRE SPRINKLER SYSTEM SHALL BE A FLOW THROUGH SYSTEM WITH A MINIMUM TOPPER PIPE CONNECTED TO AT LEAST A 3" COPPER WATER PIPE OR DIRECTLY AFTER THE WATER METER.

NOTE: THE INSTULLATION OF CARBON MONOXIDE DETECTOR 5 SHALL COMPLY WITH OBC DIV B.9.33.4 REQUIREMENTS:

- INSTALLATION OF HVAC EQUIPMENTS SHALL CONFORM TO MANUFACTURE'S SPECIFICATIONS AND MANUALS
- : MECHANICAL VENTILATION SHALL BE PROVIDED IN CONFORMANCE WITH OBC DIV B.9.32.3 REQUIREMENTS.


PROPOSED BASEMENT PLAN

SCALE 음'' = 1'

ALL DIMS ARE IN FEET/INCHES UNLESS NOTED OTHERWISE

The contractor shall check and verify all dimens and report all errors and omissions to the consultar All drawings, specifications and related documents are the copyright property of DESIGN FINE LTD, and may not be reproduced without their permission. Do not scale drawings, This drawing shall not be used for construction purposes unless issued for construction and signed by DESIGN FINE LTD.



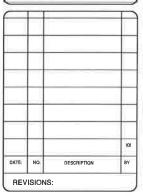

5 SUTHERLAND AVE

CLIENT:




CONSULTING ENGINEERS

Ph: 905-452-8200 Fax: 905-452-8285 www.thedesignfine.com

DRAWING TITLE:

PROPOSED BASEMENT PLAN

DRAWING NO: AS NOTED MAY, 2022 PROJECT NO DFL-2022-22

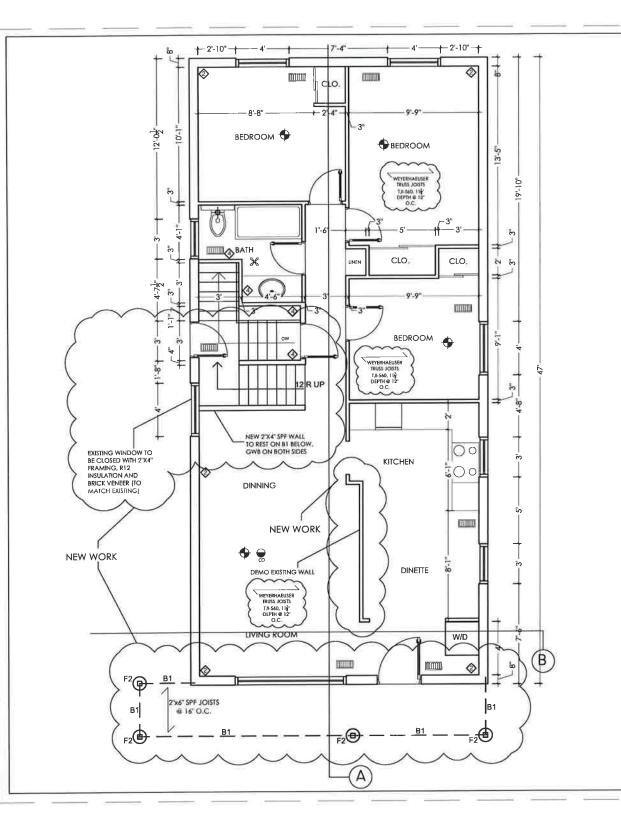

BI - 3 PLY LVL BEAM 14" X 13" 2.1E W/ MIN BEARING OF 3.5" EACH SIDE.

FI - 36"X36"XI0" M32 CONCRETE FOOTING WITH I5 REBAR @ I2" BOTH WAYS

PI - 4"X4" SPF WOOD POST ATTACHED TO CONCRETE FOOTING VIA STEEL SADDLE

F2 - I2" DIA X 4' DEEP SONO TUB FOUNDATION - M32 CONCRETE, 4"X4" SPF WOOD POST ATTACHED VIA STEEL SADDLE, CONT' UP TO SECOND FLOOR

WALL SCHEDULE

- PROPOSED INTERIOR 38 X 140 @406 O/C 12.7 MM 1 GYPSUM WALL BOARD ON BOTH SIDES WITH 89MM THICK ABSORPTIVE MATERIAL FOR 30 MIN FRR (SB-3, TABLE 1-W1c)
- PROPOSED INTERIOR 38 X 89 @406 O/C 12.7 MM GYPSUM WALL BOARDS ON BOTH THE SIDES
- EXISTING INTERIOR 38 X 89 @406 O/C 12.7 MM GYPSUM WALL BOARDS ON BOTH THE SIDES TO REMAIN AS IS
- EXISTING 38 X 89 WOOD FRAMING @ 406 O.C. EXISTING INSULATION W/VAPOR BARRIER TO
- EXISTING FOUNDATION WALL

LEGEND:


- ♣ WIRED INTERCONNECTED SMOKE ALARM WITH VISUAL SIGNALING COMPONENT (STROBE)
- PROVIDE DUCT TYPE SMOKE DETECTOR WHICH UPON ACTIVATION WILL TURN OFF FUEL SUPPLY AND ELECTRICAL TO THE HEATING SYSTEM
- → CLG. MTD. EXHAUST FAN POWERED BY ELECT, LIGHT SWITCH CONTD. TO O/S DAMPERED VENT
- HEATING OUTLET
- ELECTRIC OUTLET
- SPRINKLER
- CARBON MONO-OXIDE

PROPOSED MAIN FLOOR PLAN

 $SCALE \frac{3}{16}$ = 1'

The contractor shall check and verify all dimensions and report all errors and omissions to the consultant and report all errors and omissions to the consultant, All drawings, specifications and related documents are the copyright property of DESIGN FINE LTD. and may not be reproduced without that permission. Do not scale drawings. This drawing shall not be used for construction purposes unless issued for construction and signed by DESIGN FINE LTD.



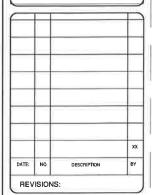

PROJECT: **5 SUTHERLAND AVE**


CLIENT:

CONSULTING ENGINEERS

96 KENNEDY ROAD SOUTH BRAMPTON, ON L6W 3E7 Ph: 905-452-8200 Fax: 905-452-8285

PROPOSED MAIN FLOOR PLAN

DRAWING NO: AS NOTED DATE: MAY, 2022 **A5** PROJECT NO DFL-2022-22 CHECKED

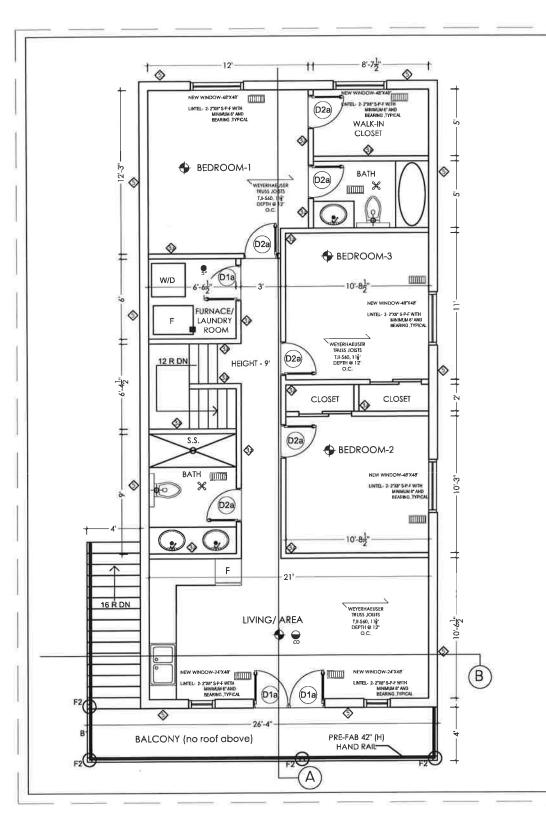

BI - 3 PLY LVL BEAM I4" X $\frac{13}{4}$ " 2.IE W/MIN BEARING OF 3.5" EACH SIDE.

FI - 36"X36"XI0" M32 CONCRETE FOOTING WITH I5 REBAR @ I2" BOTH WAYS

PI - 4"X4" SPF WOOD POST ATTACHED TO CONCRETE FOOTING VIA STEEL SADDLE

F2 - 12" DIA X 4' DEEP SONO TUB FOUNDATION - M32 CONCRETE, 4"X4" SPF WOOD POST ATTACHED VIA STEEL SADDLE, CONT' UP TO SECOND FLOOR

WALL SCHEDULE

PROPOSED 38 X 140 @406 O/C 12.7MM GWB W/
EXTERIOR STUCCO FINISH (3*) THICK & R24
INSULATION

PROPOSED INTERIOR 38 X 140 @406 O/C 12.7

MM § GYPSUM WALL BOARD ON BOTH SIDES

WITH 89MM THICK ABSORPTIVE MATERIAL FOR
30 MIN FRR (\$B-3, TABLE 1-W1c)

PROPOSED INTERIOR 38 X 89 @406 O/C 12.7 MM
GYPSUM WALL BOARDS ON BOTH THE SIDES

SEXISTING INTERIOR 38 X 89 @406 O/C 12.7 MM GYPSUM WALL BOARDS ON BOTH THE SIDES TO REMAIN AS IS

EXISTING 38 X 89 WOOD FRAMING @ 406 O.C.
EXISTING INSULATION W/VAPOR BARRIER TO REMAIN

EXISTING FOUNDATION WALL

LEGEND:

→ WIRED INTERCONNECTED SMOKE ALARM WITH VISUAL SIGNALING COMPONENT (STROBE)

 PROVIDE DUCT TYPE SMOKE DETECTOR WHICH UPON ACTIVATION WILL TURN OFF FUEL SUPPLY AND ELECTRICAL TO THE HEATING SYSTEM

CLG. MTD. EXHAUST FAN POWERED BY ELECT. LIGHT SWITCH CONTD. TO O/S DAMPERED VENT

HEATING OUTLET

ELECTRIC OUTLET

SPRINKLER

CARBON MONO-OXIDE

DOOR SCHEDULE (PROPOSED DOOR)

D-1a 815 X 2100 (32" X 80") POCKET DOOR

D-2a 765 X 2100 (30" X 80") POCKET DOOR

PROPOSED SECOND FLOOR PLAN

 $SCALE \frac{3}{16}$ " = 1'

GENERAL NOT

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5 SUTHERLAND AVE

BRAMPTON

PROJECT:

CLIENT




CONSULTING ENGINEERS

86 KENNEDY ROAD SOUTH BRAMPTON, ON L6W 3E7 Ph. 905-452-8290 Fax: 805-452-8285 www.thedesignfine.com


DRAWING TIT

PROPOSED SECOND FLOOR PLAN

DESIGN: AS	SCALE: AS NOTED	DRAWING NO:
DRAWN: AS	DATE: MAY, 2022	۸۵
CHECKED: AS	PROJECT NO DFL-2022-22	Ab

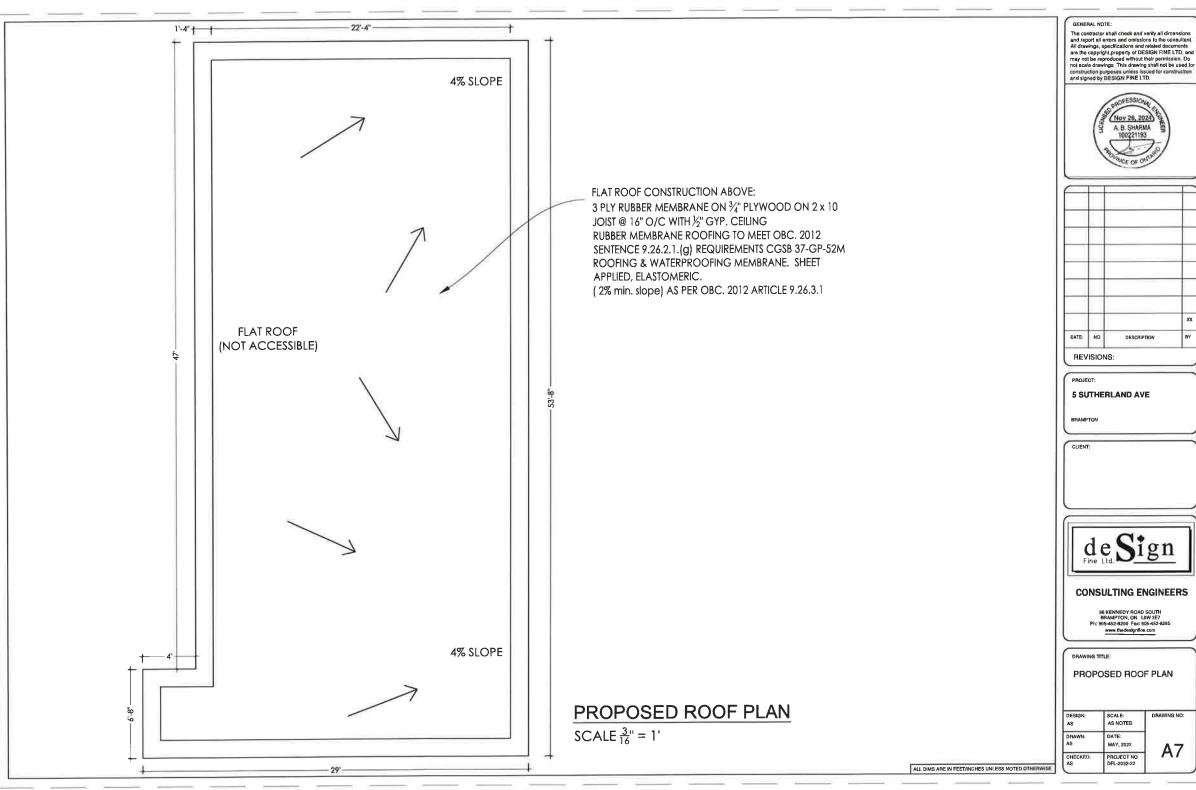




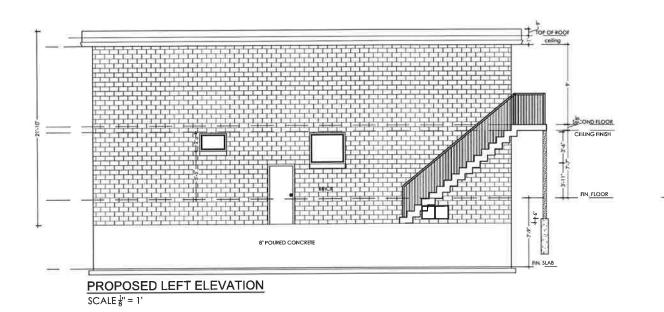



SCALE | " = 1"

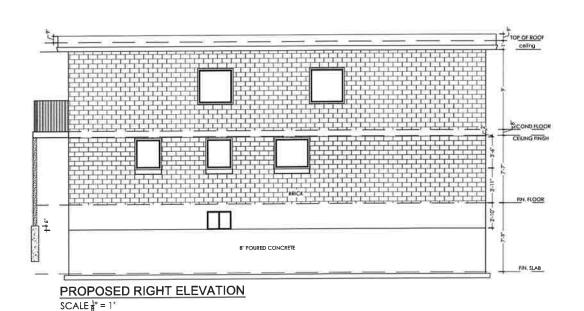




PROPOSED REAR ELEVATION SCALE | 3" = 1"

ALL DIMS ARE IN FEET/INCHES UNLESS NOTED OTHERWISE

GENERAL N

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BRAMPTON

CLIENT:

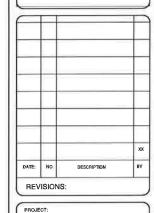5 SUTHERLAND AVE




CONSULTING ENGINEERS


BRAMPTON, ON L6W 3E7
Ph: 905-452-8280 Fax: 905-452-8285
www.thedesignfine.com


DRAWING TITLE

PROPOSED ELEVATIONS

l		
DESIGN: AS	SCALE: AS NOTED	DRAWING NO
DRAWN AS	DATE: MAY, 2022	۸٥
CHECKED: AS	PROJECT NO DFL-2022-22	Ao

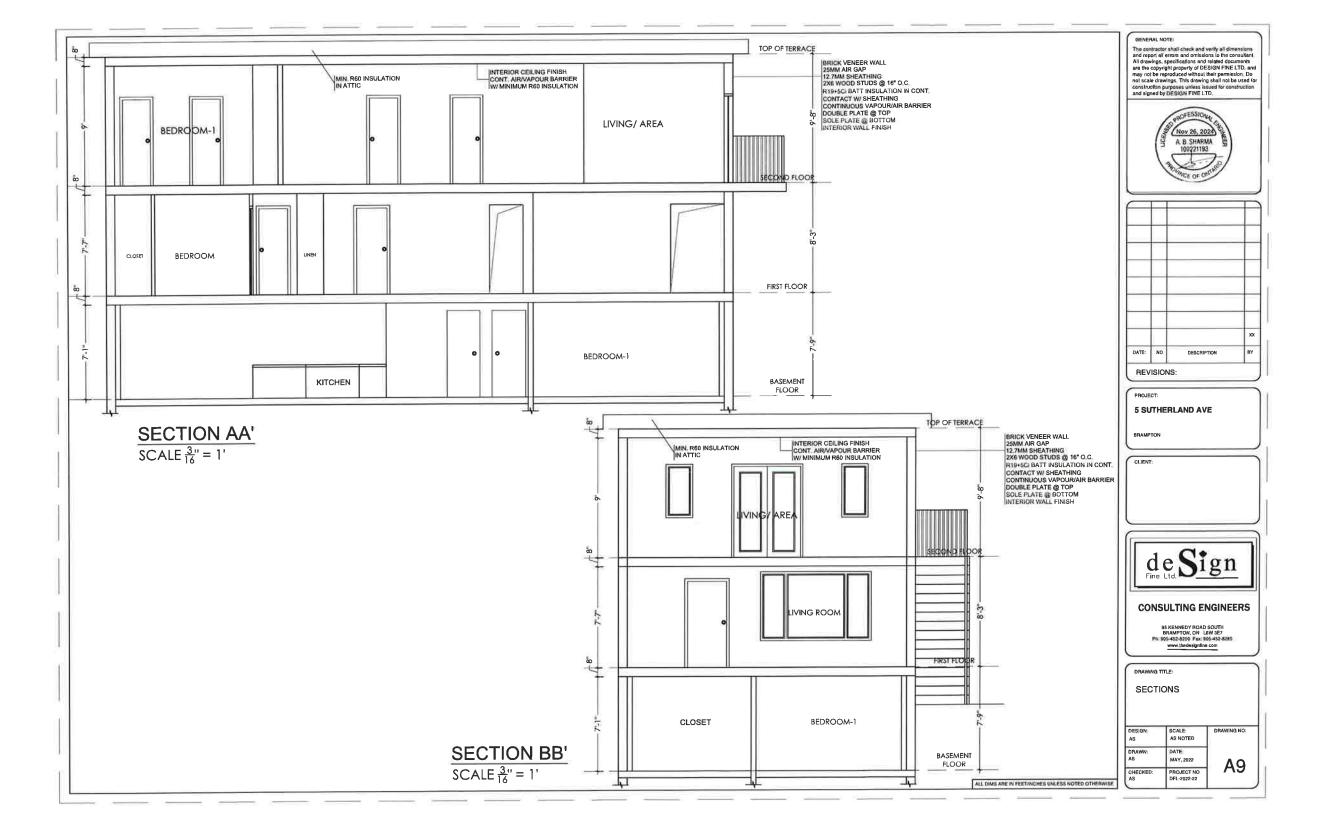

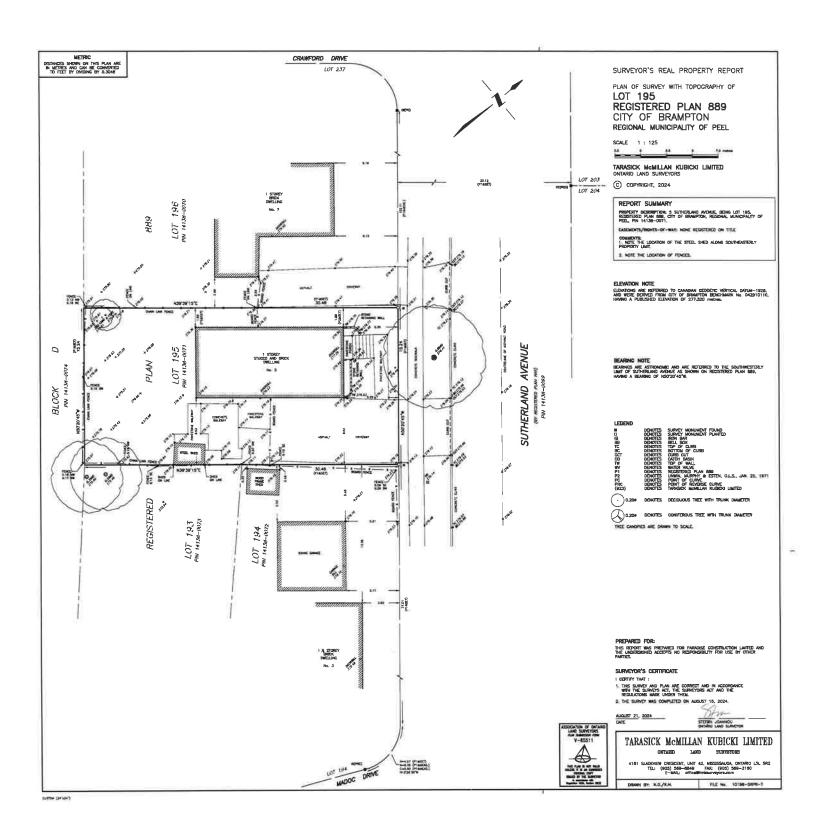

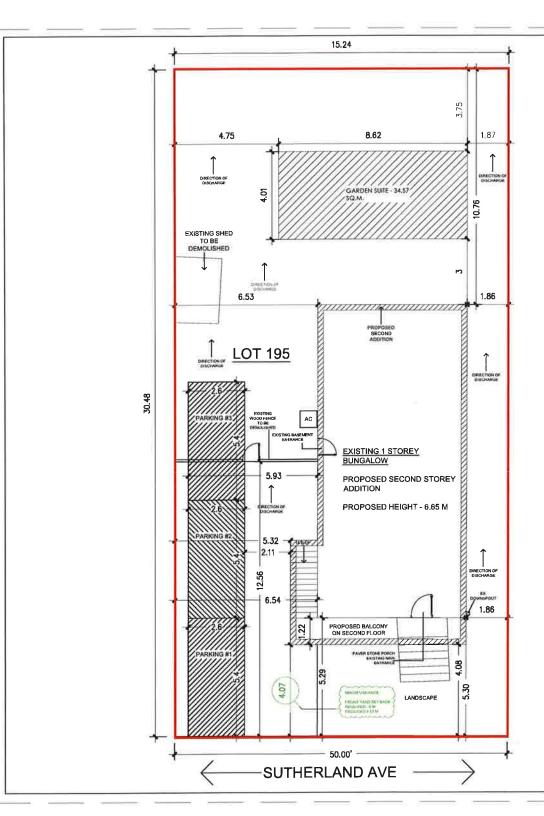


LOT COVERAGE: 30.71%

GARDEN SUITE - 34.57 SQM EXISTING SHED - TO BE DEMOLISHED EXISTING DWELLING - 98.23 SQM BALCONY - 9.84 SQM

LOT AREA - 464.52 SQM

 $\frac{\text{SITE PLAN}}{\text{SCALE-}\frac{3}{32}" = 1'0"}$

GENERAL NO

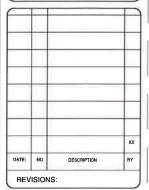

PROJECT

5 SUTHERLAND AVE

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CLIEN'




CONSULTING ENGINEERS

BRAMPTON, ON LSW 3E7
Ph: 905-452-8200 Fax: 905-452-8285
www.thedealgnfine.com

DRAWING 1

SITE KEY PLAN CH-GS-2024-0029

DESIGN: AS	SCALE: AS NOTED	DRAWING NO:
DRAWN AS	DATE: JULY, 2024	01
CHECKED: AS	PROJECT ND DFL-2024-24	31

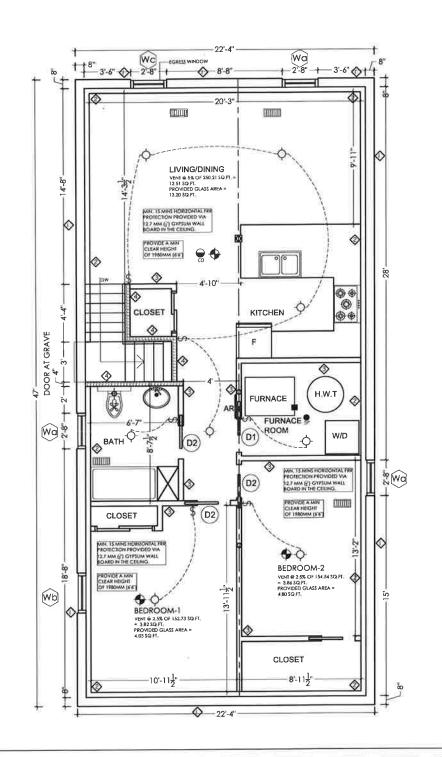

PROPOSED INTERIOR 38 X 140 @406 O/C 12.7 MM 3" GYPSUM WALL BOARD ON BOTH SIDES WITH 89MM THICK ABSORPTIVE MATERIAL FOR 30 MIN FRR (SB-3, TABLE 1-W1c)

PROPOSED INTERIOR 38 X 89 @406 O/C 12.7 MM GYPSUM WALL BOARDS ON BOTH THE SIDES

GYPSUM WALL BOARDS ON BOTH THE SIDES TO REMAIN AS IS

EXISTING 38 X 89 WOOD FRAMING @ 406 O.C. EXISTING INSULATION W/VAPOR BARRIER TO

EXISTING FOUNDATION WALL

LEGEND:

- WIRED INTERCONNECTED SMOKE ALARM WITH VISUAL SIGNALING COMPONENT (STROBE) - PROVIDE DUCT TYPE SMOKE DETECTOR WHICH UPON ACTIVATION WILL TURN OFF FUEL SUPPLY AND ELECTRICAL TO THE HEATING SYSTEM


CLG_MTD_EXHAUST FAN POWERED BY ELECT, LIGHT SWITCH CONTD, TO O/S DAMPERED VENT

- HEATING OUTLET

ELECTRIC OUTLET

SPRINKLER

CARBON MONO-OXIDE DETECTOR

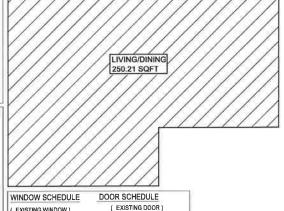

EXISTING WINDOW Wa 32" X 24" WINDOW Wb 36" X 18" WINDOW Wc 32" X 42" EGRESS

WINDOW

D-1 815 X 2100 (32" X 60") POCKET DOOR

765 X 2100 (30" X 80") POCKET DOOR

GENERAL NOTES:

1. ALL WORK SHALL CONFORM TO THE ONTARIO BUILDING CODE O. REG. 332/12 AS AMENDED DIV. B. PART 7.

ELECTRICAL NOTES:

- 1... ALL THE ELECTRICAL INSTALLATIONS MUST BE INSPECTED BY THE ELECTRICAL SAFETY AUTHORITY.
- 2. ALL SMOKE ALARMS ARE LOCATED WITH CONFORMATION OF OBC. DIV.B 9.10.19.3.

PLUMBING NOTES:

- 1... ALL THE PLUMBING SHALL CONFORM TO THE ONTARIO BUILDING CODE O. REG. 332 /12 AS AMENDED DIV. B, PART 7,
- 2. PRESSURE BALANCE OR THERMOSTATIC MIXING VALVE REQUIRED ON SHOWER AS PER OBC DIV.B 7.6.5.2.(1)
- 3. THE MAXIMUM HOT WATER TEMPERATURE SUPPLIED TO THE FIXTURES IN RESIDENTIAL OCCUPANCIES SHALL NOT EXCEED 49° C (120° F) AS PER OBC ARTICLE 7.6.5.1. DISHWASHER AND CLOTHES WASHERS ARE EXEMPT FROM THIS REQUIREMENT.
- ALL THERMOSTATIC VALVES SHALL CONFORM TO CAN/CSA-B125 "PLUMBING FIXTURES* AND BE LABELED ACCORDINGLY.
- THE FIRE SPRINKLER SYSTEM SHALL BE A FLOW THROUGH SYSTEM WITH A MINIMUM ₹ COPPER PIPE CONNECTED TO AT LEAST A 3" COPPER WATER PIPE OR DIRECTLY AFTER THE WATER METER.

NOTE: THE INSTULLATION OF CARBON MONOXIDE DETECTOR 5 SHALL COMPLY WITH OBC DIV B.9.33.4 REQUIREMENTS.


- : INSTALLATION OF HVAC EQUIPMENTS SHALL CONFORM TO MANUFACTURE'S SPECIFICATIONS AND MANUALS
- : MECHANICAL VENTILATION SHALL BE PROVIDED IN CONFORMANCE WITH OBC DIV B.9.32.3 REQUIREMENTS.

EXISTING BASEMENT PLAN

 $SCALE \frac{3}{16}" = 1"$

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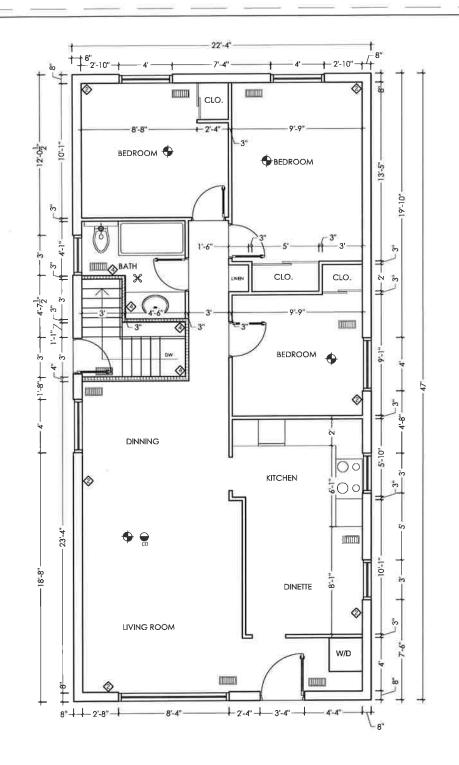
CONSULTING ENGINEERS

Ph; 805-452-8200 Fax: 905-452-8285 www.thedesignfine.com

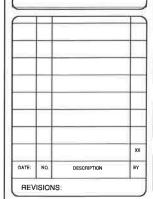DRAWING TITLE:

EXISTING BASEMENT

DESIGN: AS	SCALE: AS NOTED	DRAWING NO
DRAWN: AS	DATE: MAY, 2022	۸.
CHECKED AS	PROJECT NO DFL-2022-22	A



PROPOSED INTERIOR 38 X 140 @406 O/C 12.7

MM §* GYPSUM WALL BOARD ON BOTH SIDES
WITH 59MM THICK ABSORPTIVE MATERIAL FOR
30 MIN FRR (SB-3, TABLE 1-W1c)

PROPOSED INTERIOR 38 X 89 @406 O/C 12.7 MM
GYPSUM WALL BOARDS ON BOTH THE SIDES

EXISTING INTERIOR 38 X 89 @406 O/C 12.7 MM GYPSUM WALL BIDARDS ON BOTH THE SIDES TO REMAIN AS IS

EXISTING 38 X 89 WOOD FRAMING @ 406 O.C.
EXISTING INSULATION W/VAPOR BARRIER TO

EXISTING FOUNDATION WALL

LEGEND:

- WIRED INTERCONNECTED SMOKE ALARM
 WITH VISUAL SIGNALING COMPONENT (STROBE)
- PROVIDE DUCT TYPE SMOKE DETECTOR WHICH UPON ACTIVATION WILL TURN OFF FUEL SUPPLY AND ELECTRICAL TO THE HEATING SYSTEM
- CLG. MTD. EXHAUST FAN POWERED
 BY ELECT. LIGHT SWITCH CONTD. TO
 O/S DAMPERED VENT
- HEATING OUTLET
- ELECTRIC OUTLET
 SPRINKLER
- | Ψ .
 - CARBON MONO-OXIDE
 - DETECTOR

EXISTING MAIN FLOOR PLAN


 $SCALE \frac{3}{16} = 1'$

GENERAL NOTE

General Roll:

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PROJECT:
5 SUTHERLAND AVE

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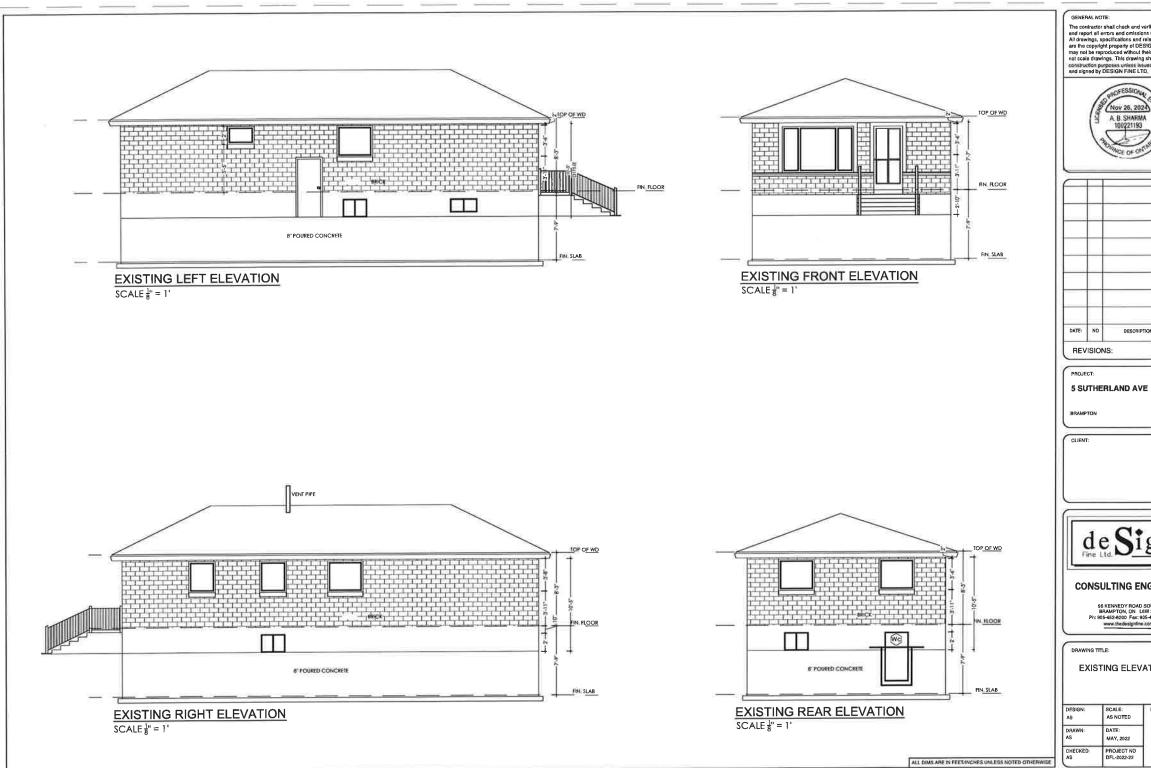
CONSULTING ENGINEERS

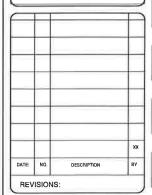B6 KENNEDY ROAD SOUTH BRAMPTON, ON L6W 3E7 Ph. 905-452-8200 Fax: 805-452-8285 www.thedealgriftne.com

DRAWING TITLE


EXISTING MAIN FLOOR

DES(GN: AS NOTED DRAWING NO: AS NOTED DRAWN: DATE: AS MMY, 2022 CHECKED: PROJECT NO AS DFL-2022-22



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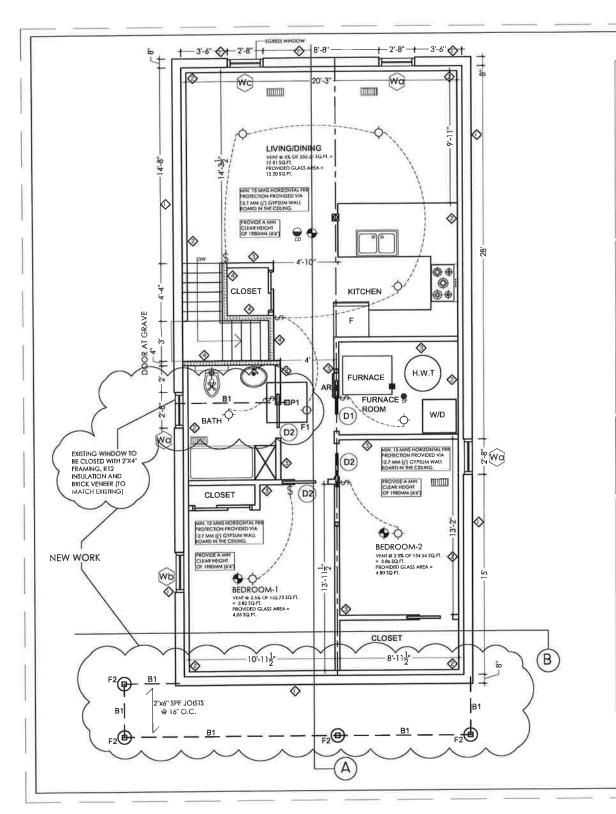


CONSULTING ENGINEERS

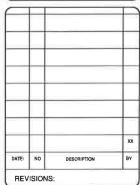98 KENNEDY ROAD SOUTH BRAMPTON, ON L6W 3E7 Ph: 905-452-8200 Fax: 905-452-8285

EXISTING ELEVATIONS

DRAWING NO: SCALE: AS NOTED MAY, 2022 **A3** PROJECT NO DFL-2022-22



PROPOSED INTERIOR 38 X 140 @406 O/C 12.7
MM ½" GYPSUM WALL BOARD ON BOTH SIDES
WITH 89MM THICK ABSORPTIVE MATERIAL FOR
30 MIN FRR (\$B-3, TABLE 1-W1c)

PROPOSED INTERIOR 38 X 89 @406 O/C 12.7 MM
GYPSUM WALL BOARDS ON BOTH THE SIDES

EXISTING INTERIOR 38 X 89 @406 O/C 12.7 MM GYPSUM WALL BOARDS ON BOTH THE SIDES TO REMAIN AS IS

EXISTING 38 X 89 WOOD FRAMING @ 406 O.C.
EXISTING INSULATION W/VAPOR BARRIER TO REMAIN

EXISTING FOUNDATION WALL

LEGEND:

₩ WIRED INTERCONNECTED SMOKE ALARM WITH VISUAL SIGNALING COMPONENT (STROBE)

PROVIDE DUCT TYPE SMOKE DETECTOR WHICH
UPON ACTIVATION WILL TURN OFF FUEL SUPPLY
AND ELECTRICAL TO THE HEATING SYSTEM

CLG. MTD. EXHAUST FAN POWERED
BY ELECT, LIGHT SWITCH CONTD. TO
O/S DAMPERED VENT

III - HEATING OUTLET

SPRINKLER - SPRINKLER

- CARBON MONO-OXIDE
DETECTOR

BI - 3 PLY LVL BEAM I4" X I³/₄" 2.IE W/ MIN BEARING OF 3.5" EACH SIDE.

FI - 36"X36"X|0" M32 CONCRETE FOOTING WITH I5 REBAR @ 12" BOTH WAYS

PI - 4"X4" SPF WOOD POST ATTACHED TO CONCRETE FOOTING VIA STEEL SADDLE

F2 - 12" DIA X 4' DEEP SONO TUB FOUNDATION - M32 CONCRETE, 4"X4" SPF WOOD POST ATTACHED VIA STEEL SADDLE, CONT' UP TO SECOND FLOOR

WINDOW SCHEDULE

WINDOW

(EXISTING WINDOW)

DOOR SCHEDULE (EXISTING DOOR)

(EXISTING WINDOW)
Wa 32" X 24" WINDOW
Wb 38" X 18" WINDOW
Wc 32" X 42" EGRESS

D-1 815 X 2100 (32" X 80") POCKET DOOR

D-2 765 X 2100 (30" X 80") POCKET DOOR

GENERAL NOTES:

 ALL WORK SHALL CONFORM TO THE ONTARIO BUILDING CODE O, REG. 332 /12 AS AMENDED DIV. B. PART 7.

ELECTRICAL NOTES:

- ALL THE ELECTRICAL INSTALLATIONS MUST BE INSPECTED BY THE ELECTRICAL SAFETY AUTHORITY.
- ALL SMOKE ALARMS ARE LOCATED WITH CONFORMATION OF OBC. DIV.B 9.10.19.3.

PLUMBING NOTES:

- ALL THE PLUMBING SHALL CONFORM TO THE ONTARIO BUILDING CODE O. REG. 332 /12 AS AMENDED DIV. B. PART 7.
- 2. PRESSURE BALANCE OR THERMOSTATIC MIXING VALVE REQUIRED ON SHOWER AS PER OBC DIV.B 7.6.5.2.(1)
- THE MAXIMUM HOT WATER TEMPERATURE SUPPLIED TO THE FIXTURES IN RESIDENTIAL OCCUPANCIES SHALL NOT EXCEED 49° C (120° F) AS PER OBC ARTICLE 7.6.5.1. DISHWASHER AND CLOTHES WASHERS ARE EXEMPT FROM THIS REQUIREMENT.
- ALL THERMOSTATIC VALVES SHALL CONFORM TO CAN/CSA-B125 *PLUMBING FIXTURES* AND BE LABELED ACCORDINGLY.
- 5. THE FIRE SPRINKLER SYSTEM SHALL BE A FLOW THROUGH SYSTEM WITH A MINIMUM ³ COPPER PIPE CONNECTED TO AT LEAST A ³ COPPER WATER PIPE OR DIRECTLY AFTER THE WATER METER.

NOTE: THE INSTULLATION OF CARBON MONOXIDE DETECTOR 5 SHALL COMPLY WITH OBC DIV B. 9.33.4 REQUIREMENTS.

- : INSTALLATION OF HVAC EQUIPMENTS SHALL CONFORM TO MANUFACTURE'S SPECIFICATIONS AND MANUALS
- : MECHANICAL VENTILATION SHALL BE PROVIDED IN CONFORMANCE WITH OBC DIV B.9.32,3 REQUIREMENTS.

PROPOSED BASEMENT PLAN


 $SCALE \frac{3}{16}$ " = 1'

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GENERAL NO

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PROJECT:

5 SUTHERLAND AVE

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CONSULTING ENGINEERS

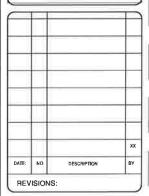96 KENNEDY ROAD SOUTH BRAMPTON, ON L6W 3E7 Ph: 905-452-8200 Fax: 905-452-8285 www.thedesignfine.com


DRAWING TIT

PROPOSED BASEMENT PLAN

DESIGN: SCALE:
AS NOTED

DRAWN: DATE:
AS MAY, 2022

CHECKED: PROJECT ND AS DFL-2022-22

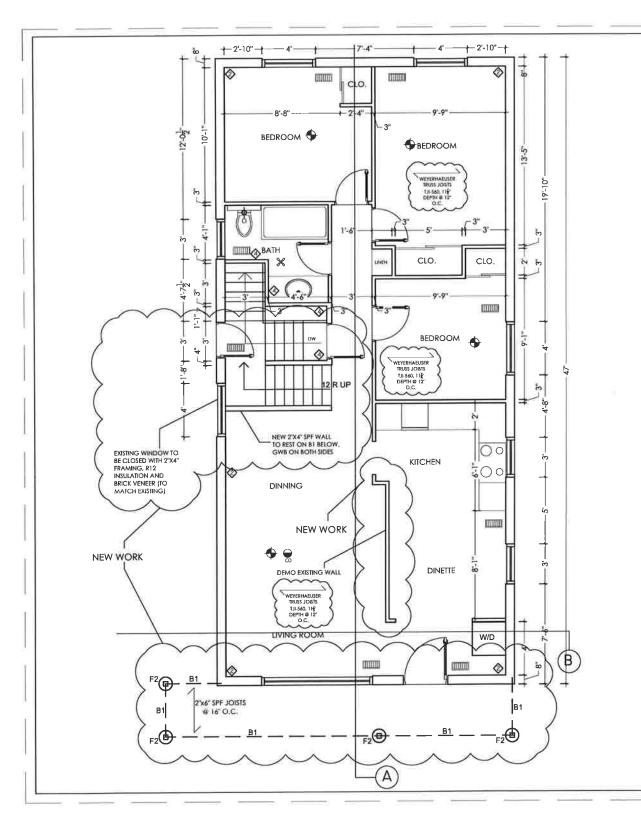

BI - 3 PLY LVL BEAM I4" X $\frac{13}{4}$ " 2.IE W/MIN BEARING OF 3.5" EACH SIDE.

FI - 36"X36"X10" M32 CONCRETE FOOTING WITH 15 REBAR @ 12" BOTH WAYS

PI - 4"X4" SPF WOOD POST ATTACHED TO CONCRETE FOOTING VIA STEEL SADDLE

F2 - 12" DIA X 4' DEEP SONO TUB FOUNDATION - M32 CONCRETE, 4"X4" SPF WOOD POST ATTACHED VIA STEEL SADDLE, CONT' UP TO SECOND FLOOR

WALL SCHEDULE

PROPOSED INTERIOR 38 X 140 @406 O/C 12.7
MM ½" CYPSUM WALL BOARD ON BOTH SIDES
WITH 89MM THICK ABSORPTIVE MATERIAL FOR
30 MIN FRR (SB-3, TABLE 1-W1c)

PROPOSED INTERIOR 38 X 89 @406 O/C 12.7 MM
GYPSUM WALL BOARDS ON BOTH THE SIDES

EXISTING INTERIOR 38 X 89 @406 O/C 12.7 MM
 GYPSUM WALL BOARDS ON BOTH THE SIDES
 TO REMAIN AS IS

EXISTING 38 X 89 WOOD FRAMING @ 406 O.C.
EXISTING INSULATION W/VAPOR BARRIER TO REMAIN

EXISTING FOUNDATION WALL

LEGEND:

→ WIRED INTERCONNECTED SMOKE ALARM WITH VISUAL SIGNALING COMPONENT (STROBE)

 PROVIDE DUCT TYPE SMOKE DETECTOR WHICH UPON ACTIVATION WILL TURN OFF FUEL SUPPLY AND ELECTRICAL TO THE HEATING SYSTEM

S - CLG. MTD. EXHAUST FAN POWERED BY ELECT, LIGHT SWITCH CONTD, TO O/S DAMPERED VENT

HEATING OUTLET

ELECTRIC OUTLET

- SPRINKLER

 CARBON MONO-OXIDE DETECTOR


PROPOSED MAIN FLOOR PLAN

 $SCALE \frac{3}{16}$ = 1'

GENERAL NOTE:

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PROJECT:
5 SUTHERLAND AVE

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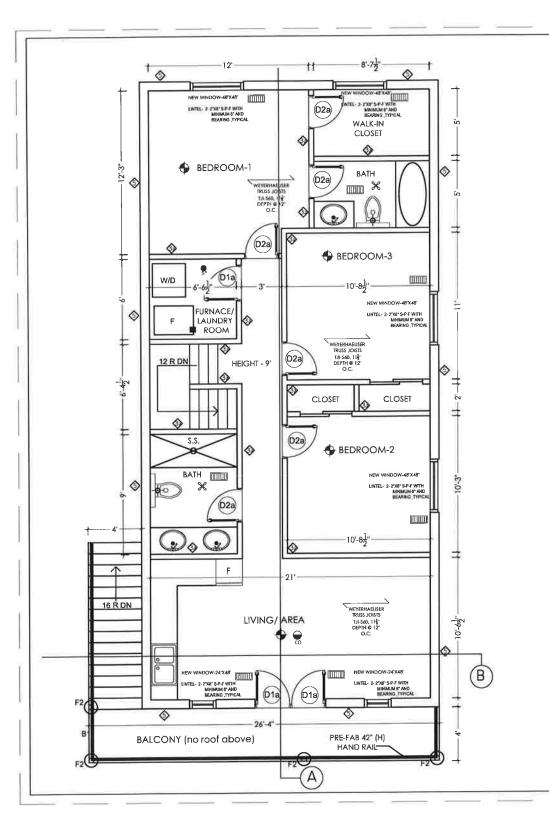
CONSULTING ENGINEERS

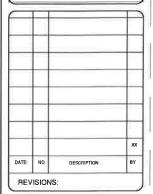96 KENNEDY ROAD SOUTH BRAMPTON, ON L6W 3E7 Ph 905-452-8250 Fax: 905-452-8285 www.lhedesignfine.com

DRAWING TITL

PROPOSED MAIN FLOOR PLAN

DESIGN AS	SCALE: AS NOTED	DRAWING NO:
DRAWN: AS	DATE: MAY, 2022	٨٥
CHECKED: AS	PROJECT NO DFL-2022-22	AS



BI - 3 PLY LVL BEAM I4" X $1\frac{3}{4}$ " 2.1E W/MIN BEARING OF 3.5" EACH SIDE.

FI - 36"X36"XI0" M32 CONCRETE FOOTING WITH I5 REBAR @ I2" BOTH WAYS

PI - 4"X4" SPF WOOD POST ATTACHED TO CONCRETE FOOTING VIA STEEL SADDLE

F2 - 12" DIA X 4' DEEP SONO TUB FOUNDATION - M32 CONCRETE, 4"X4" SPF WOOD POST ATTACHED VIA STEEL SADDLE, CONT' UP TO SECOND FLOOR

WALL SCHEDULE

PROPOSED 38 X 140 @406 O/C 12.7MM GWB W/
EXTERIOR STUCCO FINISH (\$^*) THICK & R24
INSULATION

PROPOSED INTERIOR 38 X 140 @406 O/C 12.7

MM ½ GYPSUM WALL BOARD ON BOTH SIDES

WITH 89MM THICK ABSORPTIVE MATERIAL FOR
30 MIN FRR (SB-3, TABLE 1-W1c)

PROPOSED INTERIOR 38 X 89 @406 O/C 12.7 MM
GYPSUM WALL BOARDS ON BOTH THE SIDES

SEXISTING INTERIOR 38 X 89 @406 O/C 12.7 MM
GYPSUM WALL BOARDS ON BOTH THE SIDES
TO REMAIN AS IS

EXISTING 38 X 89 WOOD FRAMING @ 406 O.C.
EXISTING INSULATION W/VAPOR BARRIER TO REMAIN

EXISTING FOUNDATION WALL

LEGEND:

WIRED INTERCONNECTED SMOKE ALARM
WITH VISUAL SIGNALING COMPONENT (STROBE)
PROVIDE DUCT TYPE SMOKE DETECTOR WHICH
UPON ACTIVATION WILL TURN OFF FUEL SUPPLY
AND ELECTRICAL TO THE HEATING SYSTEM

CLG. MTD. EXHAUST FAN POWERED BY ELECT, LIGHT SWITCH CONTD. TO O/S DAMPERED VENT

HEATING OUTLET

ELECTRIC OUTLET

- SPRINKLER

CARBON MONO-OXIDE

(PROPOSED DOOR)

D-1a 815 X 2100 (32° X 80°) POCKET DOOR

D-2a 765 X 2100 (30" X 80") POCKET DOOR


PROPOSED SECOND FLOOR PLAN

 $SCALE \frac{3}{16}$ = 1'

GENERAL NOTE

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5 SUTHERLAND AVE

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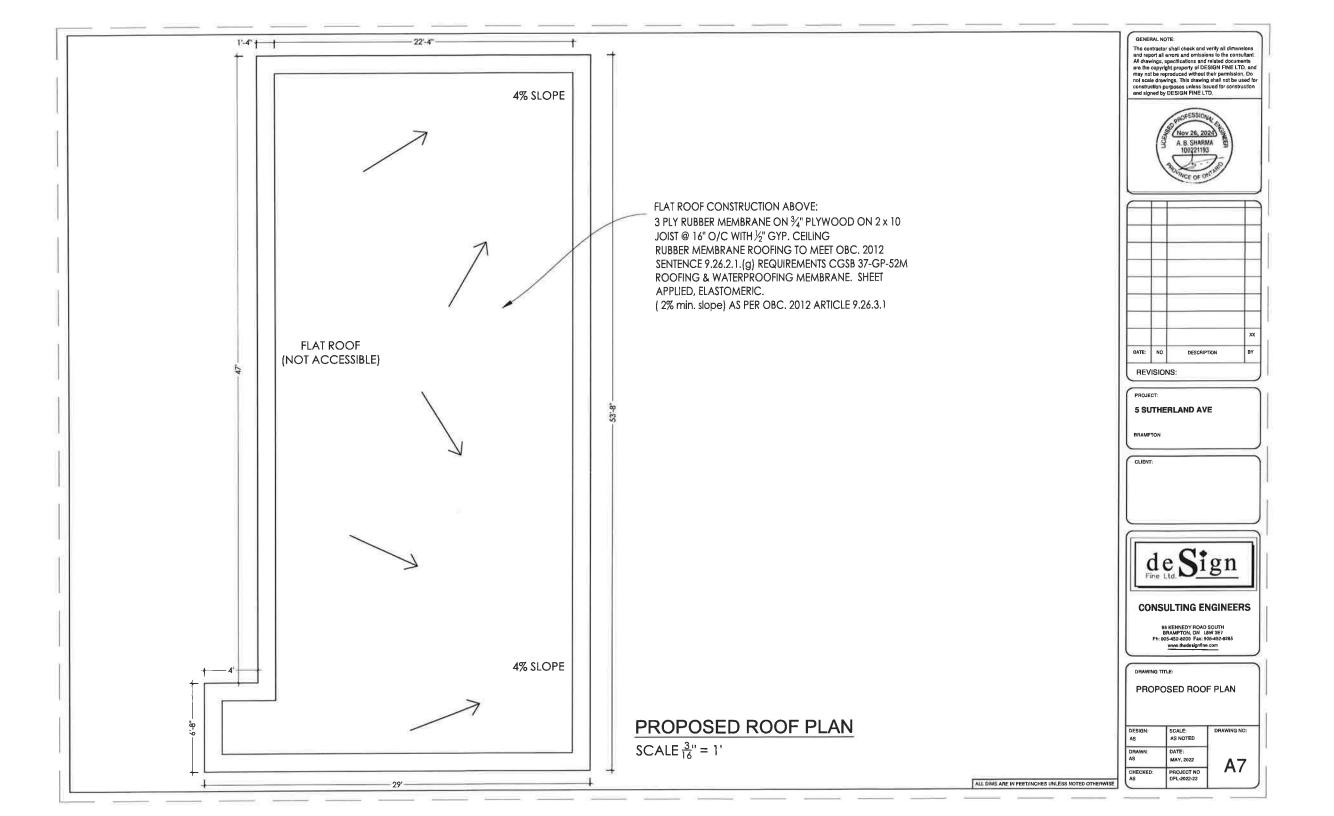
CONSULTING ENGINEERS

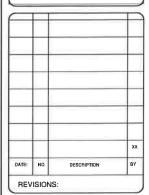
96 KENNEDY ROAD SOUTH BRAMPTON, ON L6W 3E7 Ph. 905-452-6700 Fax: 905-452-6265 www.thedealgriftne.com

DRAWING TIT

PROPOSED SECOND FLOOR PLAN


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DESIGN AS	SCALE: AS NOTED	DRAWING NO:
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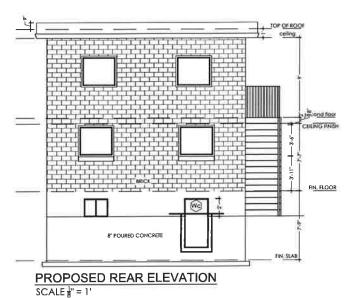




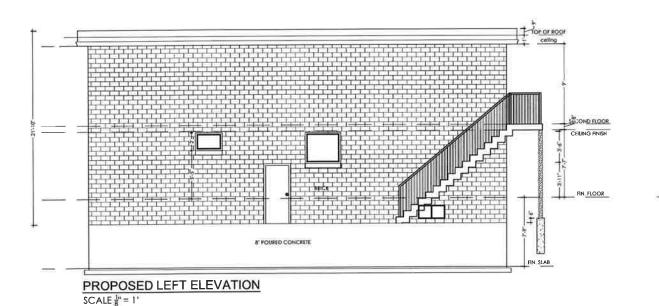

SCALE | " = 1"



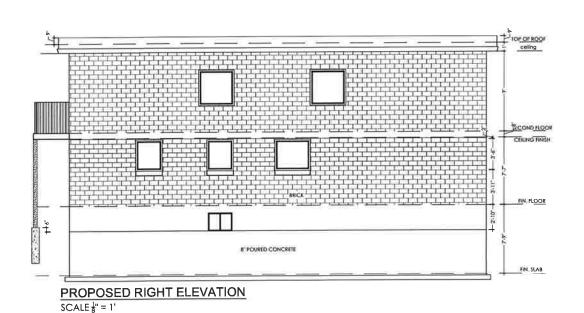


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PROJECT: 5 SUTHERLAND AVE

BRAMPTON

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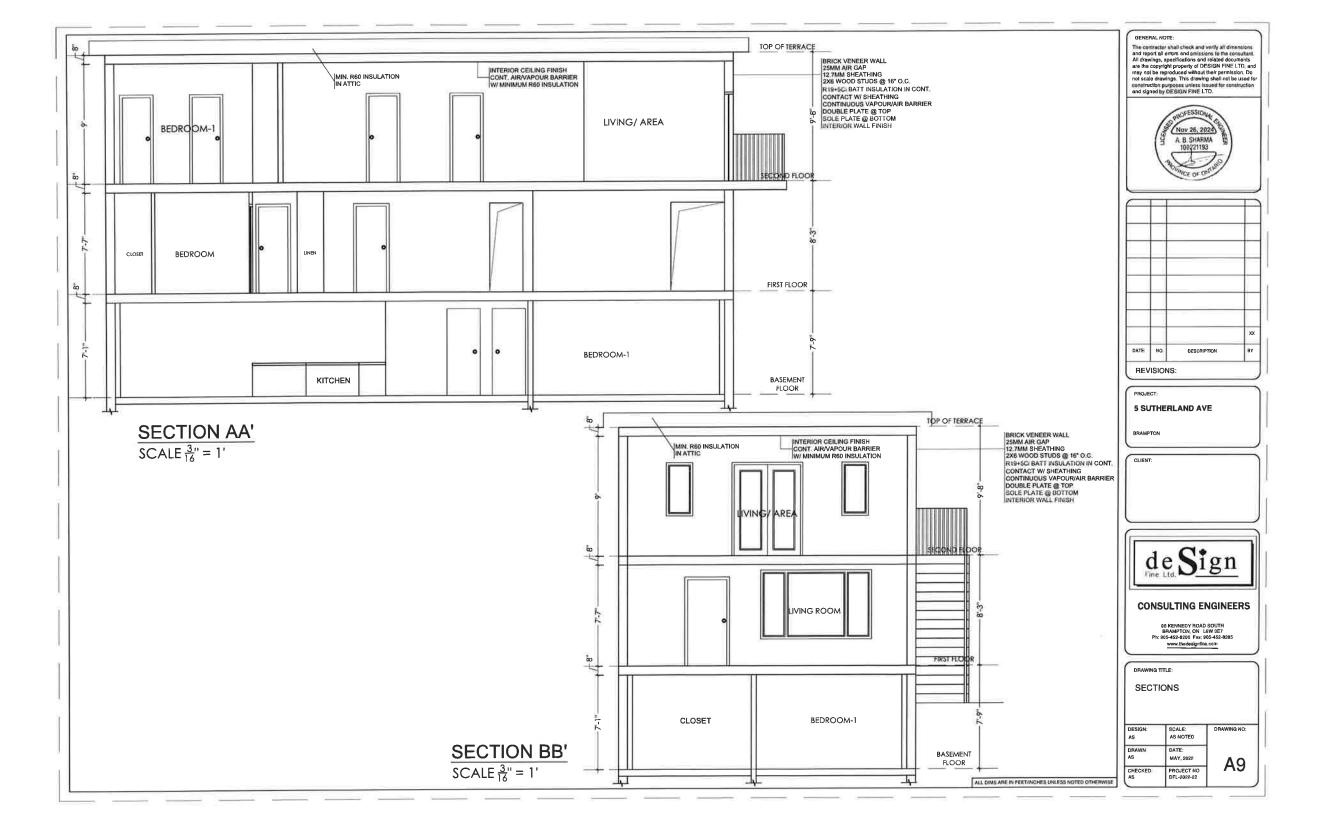
CONSULTING ENGINEERS

96 KENNEDY ROAD SOUTH BRAMPTON, ON L6W 9E7 Ph: 905-452-8200 Fax: 905-452-8285 www.thedesignfine.com

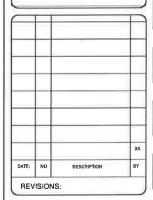DRAWING TITLE:

PROPOSED ELEVATIONS

DESIGN: SCALE: AS NOTED DRAWN: MAY, 2022 **A8** PROJECT NO CHECKED DFL-2022-22



Zoning Non-compliance Checklist

File No. A-3024-0457

Owner: AGYEI PEPRAH-ASIASE Address: 5 SUTHERLAND AVE

Zoning: R1B & Mature Neighbourhood

By-law 270-2004, as amended

Category	Proposal	By-law Requirement	Section #
USE			
LOT DIMENSIONS AREA / DEPTH / WIDTH			
BUILDING SETBACKS FRONT / SIDE / REAR	To permit a proposed deck to encroach 1.93m (6.33 ft.) into the front yard setback, resulting in a setback of 4.07m (13.35) from the porch to the front lot line,	whereas the by-law permits a deck to encroach a maximum 1.8m into the front yard setback, resulting in a required setback of 4.20m (13.77ft.) from the deck to the front lot line;	6.13 (b)
BUILDING SIZE			
BUILDING HEIGHT			
GFA			
TOWER SEPARATION			
BELOW GRADE ENTRANCE			
ACCESSORY STRUCTURE SIZE / HEIGHT			
MULTIPLE ACCESSORY STRUCTURES			
DRIVEWAY WIDTH			
LANDSCAPED OPEN SPACE			
ENCROACHMENTS			
PARKING			
SCHEDULE "C"			

Philip Gaspar				
Reviewed	by	Zoning		

_____Dec 10, 2024 Date