## Flower City



For Office Use Only (to be inserted by the Secretary-Treasurer after application is deemed complete)

FILE NUMBER: A-2025 - 0038

The Personal Information collected on this form is collected pursuant to section 45 of the Planning Act and will be used in the processing of this application. Applicants are advised that the Committee of Adjustment is a public process and the information contained in the Committee of Adjustment files is considered public information and is available to anyone upon request and will be published on the City's website. Questions about the collection of personal information should be directed to the Secretary-Treasurer, Committee of Adjustment, City of Brampton.

# APPLICATION Minor Variance or Special Permission

(Please read Instructions)

**NOTE:** It is required that this application be filed with the Secretary-Treasurer of the Committee of Adjustment and be accompanied by the applicable fee.

The undersigned hereby applies to the Committee of Adjustment for the City of Brampton under section 45 of the <u>Planning Act</u>, 1990, for relief as described in this application from By-Law **270-2004**.

1.	Name of C		aramjeet Kohli		
	Address	2035 Embleton Rd.			
	Phone #			Fax #	
	Email				
	Linaii			_	
2.	Name of A	gent Andrii Golovnia			
		224-2275 Lakeshore Blvd W	Etobicoke ON M8V 3	Y3	
		<u> </u>			
	Phone #	6478853585		Fax #	
	Email	info@ithd.ca			
3.	Nature and	d extent of relief applied for	(variances requested	d):	
	We are s	eeking relief on the side	setback zoning wh	ich is 7.5 m. the proper	tv buildina line
		d cover walk out is 5.5 m		, р. сро.	.,
	10 / a	a dovor want dut le die in			
4.	Mby in it w	at pessible to comply with	the previolence of the	hy lew?	
4.		not possible to comply with			
		d like to provide the fami			
	designed	I house while still maintai	ining the character	and integrity of the neigh	ghborhood.
	1				
	1				
5.	I enal Des	cription of the subject land:			
0.	Lot Numb				
		ber/Concession Number	Plan No A-94		
	Municipal		rampton, ON L6Y 0E9		
					•
6.	Dimensio	n of subject land ( <u>in metric ı</u>	units)		
	Frontage				
	Depth	31.39			
	Area	3923.80			
7.	Access to	the subject land is by:			
		l Highway		Seasonal Road	
		Road Maintained All Year	<b>V</b>	Other Public Road	
		ght-of-Way		Water	

8.	land: (specify	f all buildings and structures on or proposed for the subject y in metric units ground floor area, gross floor area, number of n, length, height, etc., where possible)				
	EXISTING BUILDING	SS/STRUCTURES on the	ne subject land: List all structures (dwelling, shed, gazebo, etc.)			
	1 unit 2 storey hou					
	PROPOSED BUILDIN	NGS/STRUCTURES on	the subject land:			
	New 2 storey build	ding with swimming	pool			
9.		_	ructures on or proposed for the subject lands: and front lot lines in metric units)			
	EXISTING					
	Front yard setback Rear yard setback					
	Side yard setback		,			
	Side yard setback					
	PROPOSED Front yard setback Rear yard setback Side yard setback Side yard setback	29.90 m 34.48 m 14.56 m 5.53 m				
10.	Date of Acquisition	of subject land:	2019			
11.	Existing uses of sub	pject property:	Residential			
12.	Proposed uses of si	ubject property:	Residential			
13.	Existing uses of abo	utting properties:	Residential			
14.	Date of construction	n of all buildings & stru	uctures on subject land: N/A			
15.	Length of time the e	xisting uses of the sul	bject property have been continued: N/A			
16. (a)	What water supply i Municipal  Well	s existing/proposed? ] ]	Other (specify)			
(b)	What sewage dispo Municipal Septic	sal is/will be provided ] ]	? Other (specify)			
(c )	What storm drainag	e system is existing/p	roposed?			
	Sewers  Ditches  Swales		Other (specify)			

subdivision or consent?	t of an application under the Planning Act, for approval of a plan of
Yes No 🗸	
If answer is yes, provide details:	File # Status
18. Has a pre-consultation application	been filed?
Yes No	
19. Has the subject property ever been	the subject of an application for minor variance?
Yes No No	Unknown
If answer is yes, provide details:	
File # Decision	Relief
File # Decision File # Decision	ReliefRelief
	16000 m
	Signature of Applicant(s) or Authorized Agent
DATED AT THE Town	OF New Tecumseth
THIS 17th DAY OF March	, <b>20</b> _ <u>25</u>
I, Andrii Golovnia	
IN THE Province OF ON	SOLEMNLY DECLARE THAT:
	JE AND I MAKE THIS SOLEMN DECLARATION CONSCIENTIOUSLY THAT IT IS OF THE SAME FORCE AND EFFECT AS IF MADE UNDER  SOLEMNLY DECLARED and subscribed remotely by Andrii Golovnia stated as being in ETOBICOKE, ONTARIO, before ME in the Town of NEW TECUMSET in the Province of ONTARIO on this 17th day of MARCH 2025 in accordance wood Reg 431/20, Administering Oath or Declaration Remotely.
N THE Province OF	
Ontario THIS 17th DAY OF	1500
March , <b>20</b> 25 .	Signature of Applicant or Authorized Agent
Loyal	σ <b>σ</b>
A Commissioner etc.	
F	FOR OFFICE USE ONLY
Present Official Plan Designation:	
Present Zoning By-law Classificati	ion:
Enforcement Action File Number:	
	with respect to the variances required and the results of the are outlined on the attached checklist.
Zoning Officer	Date
DATE RECEIVED _	Ol April (2025
Date Application Deemed	Revised 2022/02/17

Merceyn

### **APPOINTMENT AND AUTHORIZATION OF AGENT**

To: The Secretary-Treasurer
Committee of Adjustment
City of Brampton
2 Wellington Street West
Brampton, Ontario
L6Y 4R2

LOCATION OF THE SUBJECT LAND: 2035 Embleton Rd, Brampton, ON L6Y 0E9

I/We, Simardeep Kohli and Paramjeet Kohli

coa@brampton.ca

please print/type the full name of the owner(s)

the undersigned, being the registered owner(s) of the subject lands, hereby authorize

Andrii Golovnia

please print/type the full name of the agent(s)

to make application to the **City of Brampton Committee of Adjustment** in the matter of an application for **minor variance** with respect to the subject land.

Dated this 11

day of Marci

signature of the owner[s], or where the owner is a firm or corporation the signature of an officer of the owner.

(where the owner is a firm or corporation, please print or type the full name of the person signing.)

NOTE: If the owner is a firm or corporation, the corporate seal shall be affixed hereto.

NOTE: Unit owners within a Peel Standard Condominium Corporation are to secure authorization from the Directors of the Condominium Corporation in a form satisfactory to the City of Brampton, prior to submission of an application. Signatures from all Members of the Board of Directors are required.

#### **PERMISSION TO ENTER**

To: The Secretary-Treasurer
Committee of Adjustment
City of Brampton
2 Wellington Street West
Brampton, Ontario

L6Y 4R2

coa@brampton.ca

LOCATION OF THE SUBJECT LAND: 2035 Embleton Rd, Brampton, ON L6Y 0E9

I/We,

Simardeep Kohli and Paramjeet Kohli

please print/type the full name of the owner(s)

the undersigned, being the registered owner(s) of the subject land, hereby authorize the Members of the City of Brampton Committee of Adjustment and City of Brampton staff members, to enter upon the above noted property for the purpose of conducting a site inspection with respect to the attached application for Minor Variance and/or consent.

Dated this 11th day of March , 2035 ...

(signature of the owner[s], or where the owner is a firm or corporation, the signature of an officer of the owner.)

(where the owner is a firm or corporation, please print or type the full name of the person signing.)

NOTE: If the owner is a firm or corporation, the corporate seal shall be affixed hereto.

NO DISCUSSION SHALL TAKE PLACE BETWEEN THE COMMITTEE MEMBERS AND THE APPLICANT DURING THE SITE INSPECTION



## **Audit Trail**

#### **Document Details**

Title Application Form (Minor Variance)\_2023\_250314\_155418.pdf

File Name Application Form (Minor Variance)\_2023\_250314\_155418.pdf

Document ID

Fingerprint f : f

Status Completed

**Document History** 

**Document** Document Created by Timothy Loyal (tloyal@downtown-notary.ca)

Created Fingerprint: 5dba72937a5e137806469addd2cb50db

7806469addd2cb50db America/Toronto

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Document Sent to Andrii Golovnia (andrii@ithd.ca)

05:35PM America/Toronto

2025 Mar 17

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**Document** Viewed Document Viewed by Andrii Golovnia (andrii@ithd.ca)

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Document Signed by Andrii Golovnia (andrii@ithd.ca)

Document Signed

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2025 Mar 17 05:36PM America/Toronto

Document Signed by Timothy Loyal (tloyal@downtown-notary.ca) IP: 72.136.117.40

Document Signed

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2025 Mar 17 05:37PM America/Toronto





Date: 2025-03-18

Subject: Minor Variance Application
To: Committee of Adjustment

Dear Committee Members,

I am submitting this letter in support of my **Minor Variance Application** for the property located at 2035 Embleton Rd. The purpose of this application is to request relief from **side setback zoning, property building line and cover walk out to** facilitate a 2 storey residential house with swimming pool.

The proposed variance is **minor in nature** and maintains the intent of the zoning by-law and the Official Plan, and it will not negatively impact neighboring properties or the surrounding community. I have taken steps to ensure that the proposal aligns with the character of the neighborhood and does not create any adverse effects.

I am open to any reasonable modifications or conditions that the Committee may suggest. Enclosed with this application are **the required site plan, drawings, and any supporting documents**.

I appreciate your time and consideration of this application. Please feel free to contact me at **647-885-3585** or at **info@ithd.ca** if further information is required. I look forward to your review and a positive outcome

Sincerely,

Andrii Golovnia CFO. P. Fna



Project Name:


Address:


**NEW CUSTOM HOUSE** 

2035 Embleton Rd., Brampton ON., L6Y OE9

In Tech House Design Corporation 2275 Lake Shore Blvd. West Suite 224, Toronto, ON M8V3Y3 www.ithd.ca, info@ithd.ca +1(647)478-5055



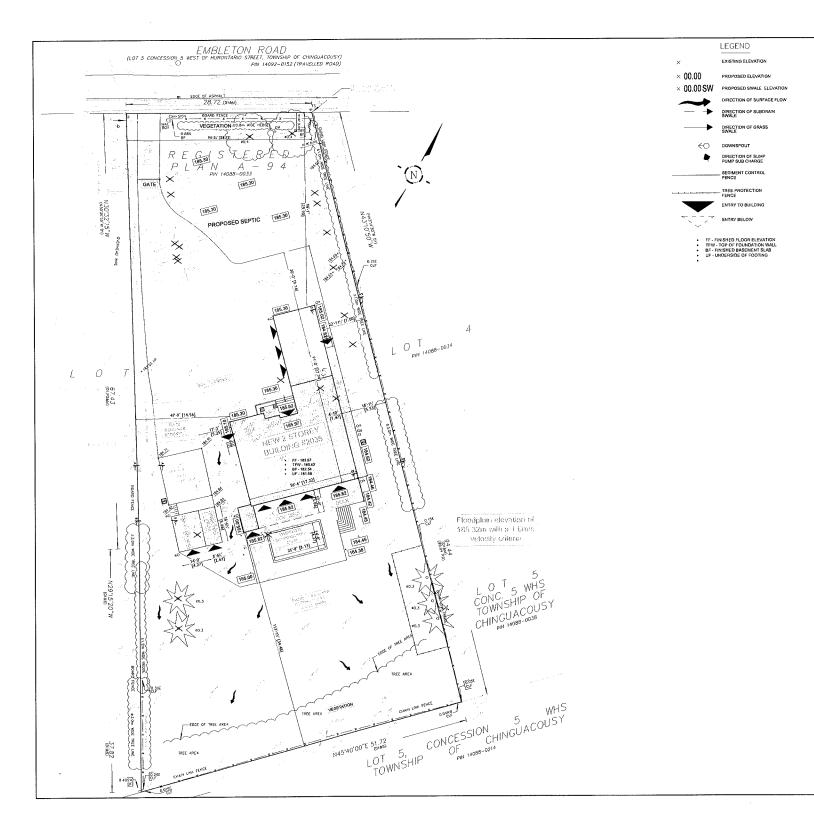

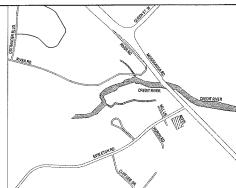

KEYPLAN: 2035 EMBLETON RD. ON. L6Y 0E9 SCALE: NTS

RD((12.0;#370)(x1463)

FRONT YARD LANDSCAPING AREA SOFT LANDSCAPE AREA HARD LANDSCAPE AREA

REAR YARD AREA BREAK DOWN COVERED DECK

SWIMMING POOL

LOT AREA			42235.75	3923.80
EX. BUILDING AREA			553.59	51.43
NEW BUILDING AREA			4002.85	371.87
NEW STORAGE AREA			259.45	24.10
NEW POOL EQUIPMENT AREA			158.50	14.73
LOT COVERAGE				11.8%
0	ROSS FLOOR	RAREA		
	SQ.FT	m³	SQ.FT	III)
FIRST FLOOR			2754.50	255.90
SECOND FLOOR	-		2654.16	246.58
TOTAL G.F.A.			5408.66	502.48
FINISHED BASEMENT	-		2635.03	244.80
				,
	FT	m	FT	m
AVERAGE ESTABLISH GRADE NORTH (FRONT)				185.36
BUILDING HEIGHT NORTH (FRONT)		10.60	30"-11 1/4"	9.43 m
AVERAGE ESTABLISH GRADE SOUTH (REAR)				185.36
BUILDING HEIGHT SOUTH (REAR)		10.60	30'-11 1/4"	9.43 m
AVERAGE ESTABLISH GRADE EAST SIDE				185.36
BUILDING HEIGHT EAST SIDE		10.60	30'-11 1/4"	9.43 m
AVERAGE ESTABLISH GRADE WEST SIDE				185.36
BUILDING HEIGHT WEST SIDE		10.60	30'-11 1/4"	9.43 m
BUILDING LENGTH			103'-0"	31.39
BUILDING DEPTH			103'-0"	31.39
LOT FRONTAGE			94'-2 1/2"	28.72
	SETBACK	S		-
	FT	m	FT	m
FRONT	<u> </u>	12,00	98'-1"	29.90
REAR		7.50	113'-1 35"	34,48



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GRADE				185.36
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		7.50	47'-9"	14.56
		15	18'-1 1/2"	6.53
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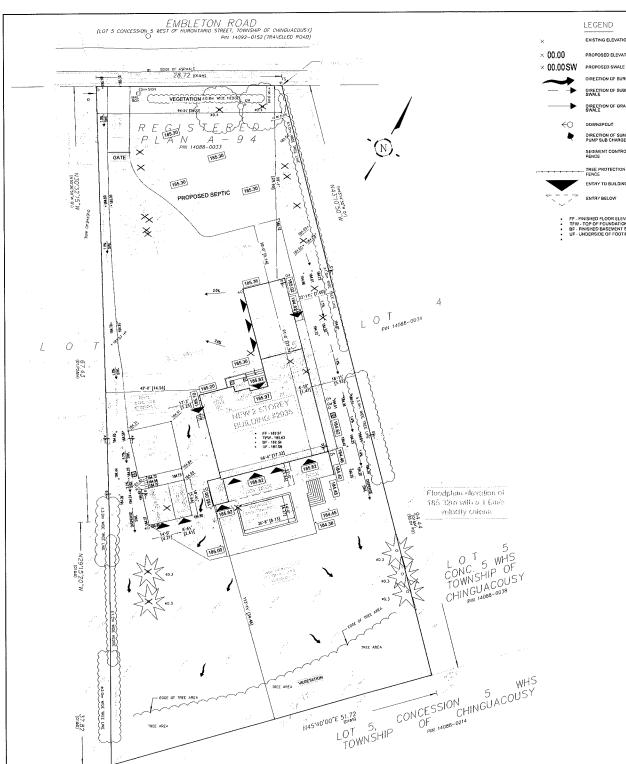
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ALE:	1;200	SP-
TE:	2024/12/28	5
OJECT M:	24-699	



#### LEGEND

EXISTING ELEVATION

PROPOSED ELEVATION

× 00.00 SW PROPOSED SWALE ELEVATION

DIRECTION OF SURFACE FLOW

DIRECTION OF SUBDRAIN SWALE

DIRECTION OF GRASS SWALE DOWNSPOUT

DIRECTION OF SUMP PUMP SUB CHARGE

SEDIMENT CONTROL



- FF FINISHED FLOOR ELEVATION TFW TOP OF FOUNDATION WALL 8F FINISHED BASEMENT SLAB UF UNDERSIDE OF FOOTING

GENERAL NOTES

- SUNCEY PAGE AND THE PAGE AND THE RECOMMEND THE PAGE AS PARK TO SURVEY PAGE AND THE PAGE AS PAG

#### ELEVATION NOTE:

ELEVATIONS ARE GEODETIC IN ORIGIN AND WERE DERIVED FROM OBSERVED REFRENCE POINTS (ORP) USING THE LEICA SMARTNET NETWORK (2010 EPOCH) AND ARE REFERRED TO THE CGVD28:1978 (HTV2.0) DATUM.

#### BENCHMARK NOTE:

- CITY OF BRANDTON BENCHMARK No. 042200354.
  ELEVATION = 205.880 METRES (CGVD28:78 ADJUSTMENT).
  31.77m NORTH OF CENTRELINE OF QUEENSTREET WEST, 60.18m EAST OF CENTRELINE OF MISSISSAUGA RD.

#### BEARING NOTE:

- BEARINGS ARE ASTRONOMIC AND ARE REFERRED TO THE SOUTHERLY LIMIT OF THE EMBLETON ROAD AS SHOWN ON PLAN 43R-25290, HAVING A BEARING OF N61\*00\*10\* E
- SURFACE DRAINAGE TO BE DIRECTED AWAY FROM THE BUILDING TO SIDE YARD SWALES OR DITCHES, MAXIMUM SIDE SLOPES NOT TO EXCEED 3:1
- ALL STORM WATER SHALL BE DIRECTED IN SUCH A MANNER THAT WATER WILL NOT ACCUMULATE AT OR NEAR A BUILDING INCLUDING FOUNDATION WALLS, WINDOWS, ENTRANCES AND WALKWAYS.
- ALL DISTURBED AREAS TO BE SUDDED OR SEEDED OVER 75mm OF TORSON.

#### CONSTRUCTION SCHEDULE

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  5. UNDER NO CIRCUMSTANCES IS SEDIMENT TO BE RELEASED INTO THE

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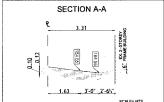
#### UNDERGROUND SERVICES


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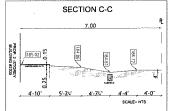
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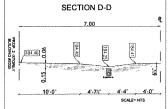
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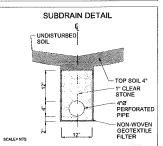
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INSTALLATION OF CLEAR STONE AND ROOF DRAIN PIPE.










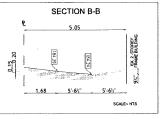

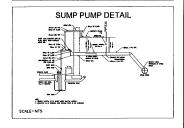



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THE CONTRACTOR AND/OR THE OWNER DILLL BE RESPONSIBLE FOR THE ARRANGEMENT OF ALL NICESSAY PROPERTIONS AND FOLLOW AND/OTHER STATES

ALL TEMPORARY WORKS INCLICING SHORING ARE TO SE PROVIDED BY THE CONTRACTOR MEAN THIS DRAWING IN CONJUNCTION WITH OTHER PRINTINGS.
ARCHITECT, STRUCTURAL, ARCHANGEL, ELECTRICAL AND OTHER
MUTURN PRINTING AND SHOULD ATTOM

THESE DRAWING MUST NOT BE DUPLICATED IN ANY FORM, OR USE FOR ANY OTHER PROJECTS, WITHOUT WINITEN CONSENT OF THE




	RE	ISIONS AND ISSUES
1014/12/18	3	REVISED PER CITY COMMENTS
2024/11/07	2	REVISED PER CITY COMMENTS
2024/09/25	1	ISSUED FOR CVC PERMIT
DATE		DESCRIPTION




**New Custom House** 2035 Embleton Rd. Brampton, ON. L6Y 0E9

Grading Plan

CHECKED BY: AG 1:200 C-1 DATE: 2024/12/28 PROJECT No: 24-699

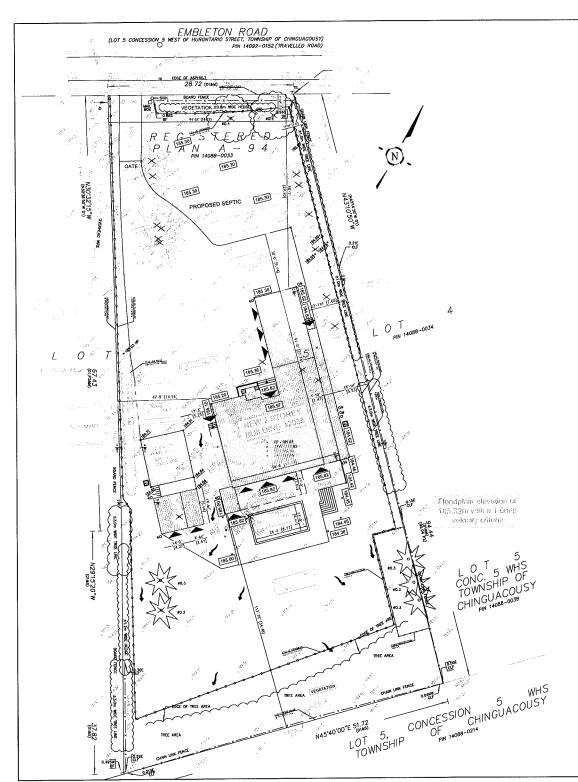

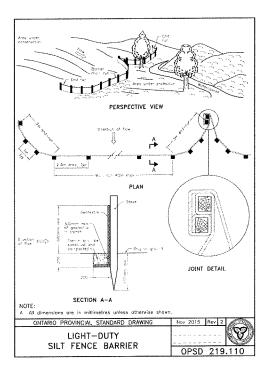

#### ESC LEGEND

A STOREST



#### SCHEDULE

INITIAL SEDIMENT CONTROL INSTALLATION; TBD 2024-2025

#### SEDIMENT CONTROL INSPECTION AND MAINTENANCE OF SEDIMENT FERCE

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#### EROSION AND SEDIMENT CONTROL / GENERAL NOTES

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SEDIMENT AND EROSION CONTROL NOTES

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- CONSTRUCTION NOTES.

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Phone: +1(647)478-5:55 Tolt free: -1(885)561-4161 Info@sthd.ca

- EBAL NOTES

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2024/11/07	2	REVISED PER CITY COMMENTS
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New Custom House 2035 Embleton Rd. Brampton, ON. L6Y 0E9

SHEET TITLE: Erosion & Sediment Control Plan

 DESIGN BY
 RH

 DRAWN BY
 JT


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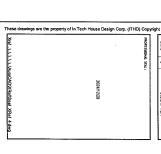
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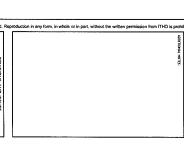












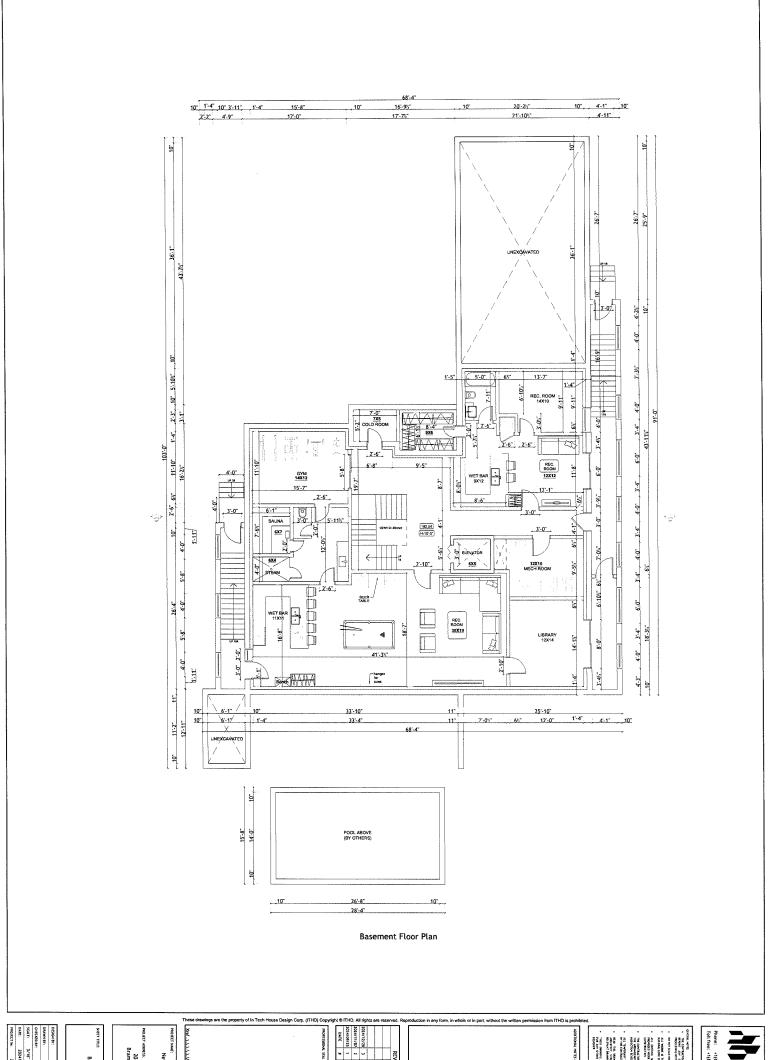

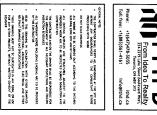

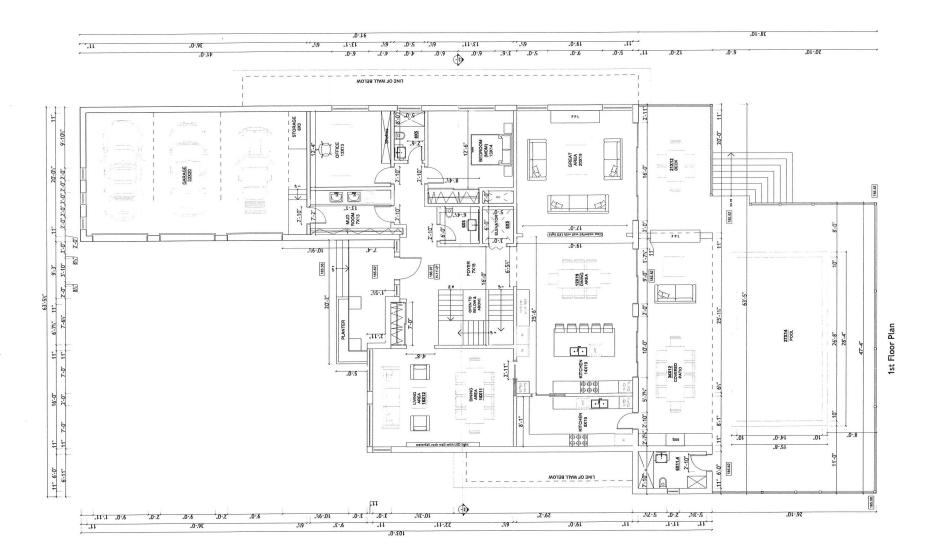



NEAL NOTES
THE CONTRACTOR SHALL VERIFY ALL DIMENSIONS AT THE SITE AND REPORT ANY DISCREPANCIES TO THE CONSULTANT BEFORE PROCEEDING WITH WORK DO NOT SCALE DRAWINGS

ALL WORKS IS TO BE CARRIED OUT ACCORDING TO THE ONTARIO BUILDING CODE 2012 AND 8Y-LAWS

THESE DRAWING MUST NOT BE DUPLICATED IN ANY FORM, OR USE FOR ANY OTHER PROJECTS, WITHOUT WRITTEN CONSENT OF THE DESIGNER

ADDITIONAL NOTES:	
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2024/09/25	1	ISSUED FOR CVC PERMIT
DATE		DESCRIPTION



**New Custom House** 2035 Embleton Rd. Brampton, ON. L6Y 0E9

FIRST FLOOR PLAN

DRAWN BY: CHECKED BY: AG SCALE: PRESENCES DATE: 2024/12/28

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New Custom House

PROJECT ADDRESS:

2035 Embleton Rd.
Brampton, ON. L6Y 0E9

T TITLE: SECOND FLOOR PLAN

DESIGN BY: RH

DRAWN BY: JT


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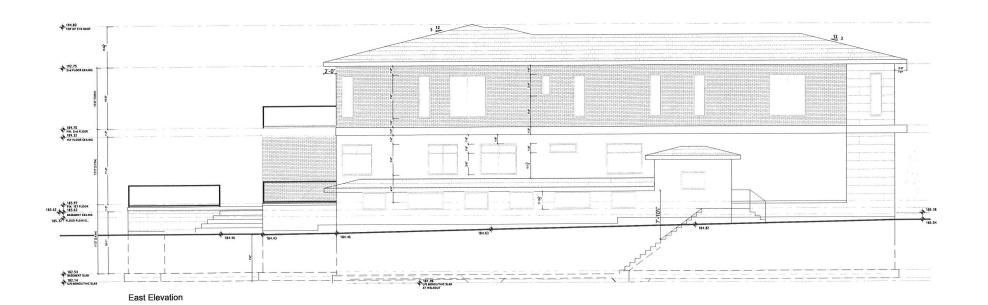
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PROJECT NAME:
New Custom House
PROJECT ADDRESS:
2035 Embleton Rd.
Brampton, ON. L6Y 0E9

ROOF PLAN

DESIGN BY:	RH
DRAWN BY:	JΤ
CHECKED BY:	AG
SCALE:	3/16" = 1'-0"
DATE:	2024/12/28
PROJECT No:	24-699

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THESE DRAWING MUST NOT BE DUPLICATED IN ANY FORM, OR US FOR ANY OTHER PROJECTS, WITHOUT WIRTTEN CONSENT OF THE DESIGNER

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2024/09/25	1	ISSUED FOR CVC PERMIT
DATE		DESCRIPTION

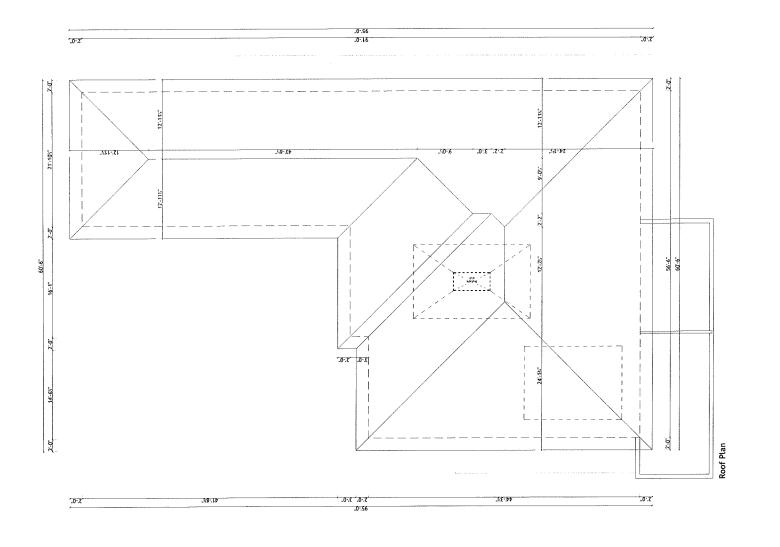

**New Custom House** 2035 Embleton Rd. Brampton, ON. L6Y 0E9

FRONT & LEFT ELEVATIONS

DESIGN BY:		RH
DRAWN BY:		JT
CHECKED BY:		AG
CALE:	3/16" = 1	-0-
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DO NOT SCALE DRAWINGS

ALL WORKS IS TO BE CARRIED OUT ACCORDING TO THE ONTARIO BUILDING CODE 2012 AND BY LAWS

ALL EXISTING SURFACES AND STRUCTURES ADJACENT TO THE PROPOSED WORK ARE TO BE PROTECTED BURING DEMOLITION AND CONSTRUCTION

THESE BRAWING MUST NOT BE DUPLICATED IN ANY FORM, OR USE FOR ANY OTHER PROJECTS, WITHOUT WRITTEN CONSENT OF THE DESIGNER

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**New Custom House** 2035 Embleton Rd. Brampton, ON. L6Y 0E9

REAR & RIGHT ELEVATIONS

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 RH


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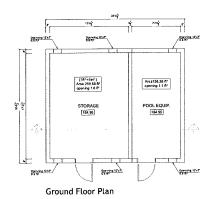
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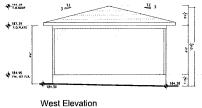



New Custom House 2035 Embleton Rd.


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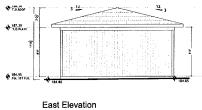
DATE: 2024/12/28







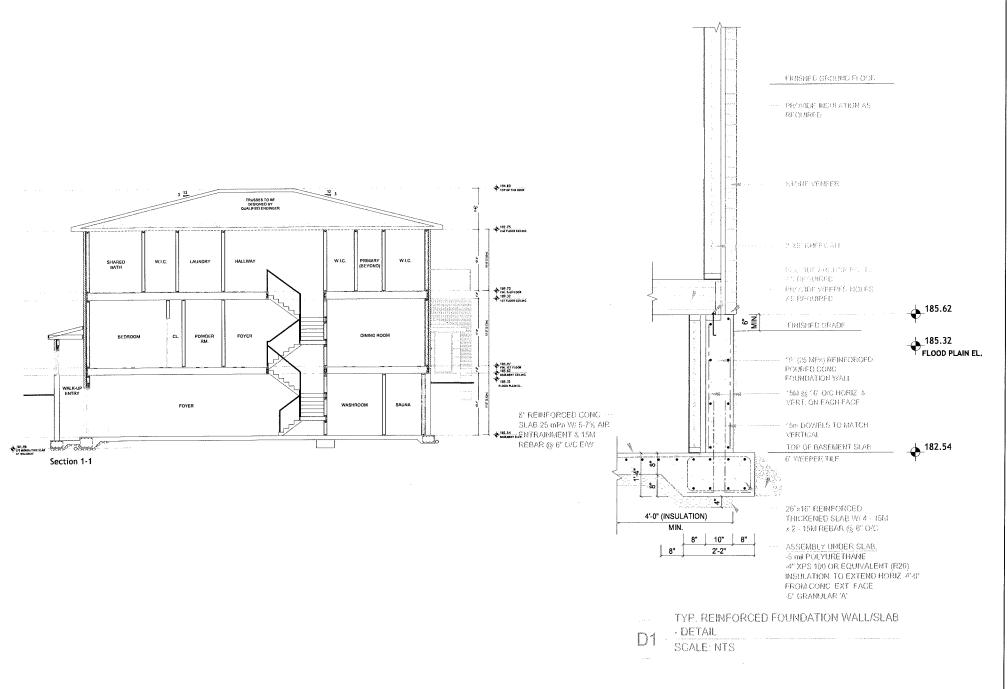

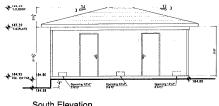

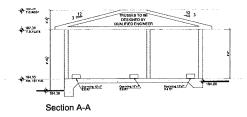

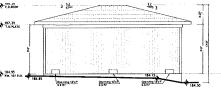

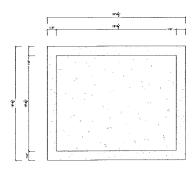

Footing Plan





2035 Embleton Rd. Brampton, ON. L6Y 0E9

Xref .1.1.1.1.1.AutoCADIXRefSeal XRef 4.dwg New Custom House

From Idea To Reality
274-2275 Lake Shore Bookerand West,
Teronic, OK May 173

Phone: +1(647)478-0505 (thd. ca
Toll free: +1(885)561-4161 (nfo@/thd. ca

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REVISIONS AND ISSUES


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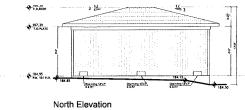
ADDITIONAL NOTES:

DESIGN 8Y:	RH
DRAWN BY:	JΤ
CHECKED BY:	AG
SCALE:	3/16" = 1'-0"
DATE:	2024/12/28

PROJECT No: 24-699

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# **Zoning Non-compliance Checklist**

File No. A-2025-	ळॐ
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Owner: Simardeep Kohli Address: 2035 Embleton Road Zoning: Residential "RHM1" Zone By-law 270-2004, as amended

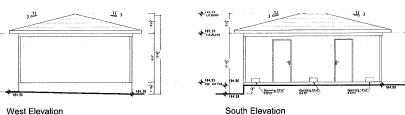Category	Proposal	By-law Requirement	Section #
USE			
LOT DIMENSIONS AREA / DEPTH / WIDTH			
BUILDING SETBACKS FRONT / SIDE / REAR	To permit an interior side yard setback of 5.53m to a proposed two storey single detached dwelling.	Whereas the by-law requires a minimum interior side yard setback of 7.5m.	11.4.2 (e)
BUILDING SIZE			
BUILDING HEIGHT			
COVERAGE			
BELOW GRADE ENTRANCE			
ACCESSORY STRUCTURE SETBACKS			
ACCESSORY STRUCTURE SIZE / HEIGHT			
MULTIPLE ACCESSORY STRUCTURES			
DRIVEWAY WIDTH			
LANDSCAPED OPEN SPACE			
ENCROACHMENTS			
PARKING			
SCHEDULE "C"			

Note: This property is located within the Credit Valley Conservation Fill Regulated Area. Please obtain clearance from the Credit Valley Conservation Authority prior to resubmitting your application. They can be reached at planning@cvc.ca.

Aman Hansra				
Reviewed by Zoning				
March 26, 2025				
Date				



Project Name:


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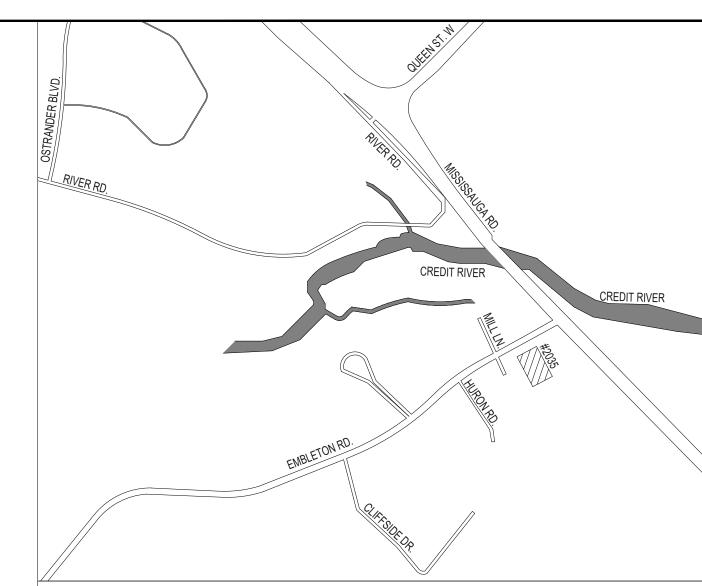
NEW CUSTOM HOUSE

2035 Embleton Rd., Brampton ON., L6Y 0E9

In Tech House Design Corporation 2275 Lake Shore Blvd. West Suite 224, Toronto, ON M8V3Y3 www.ithd.ca, info@ithd.ca +1(647)478-5055





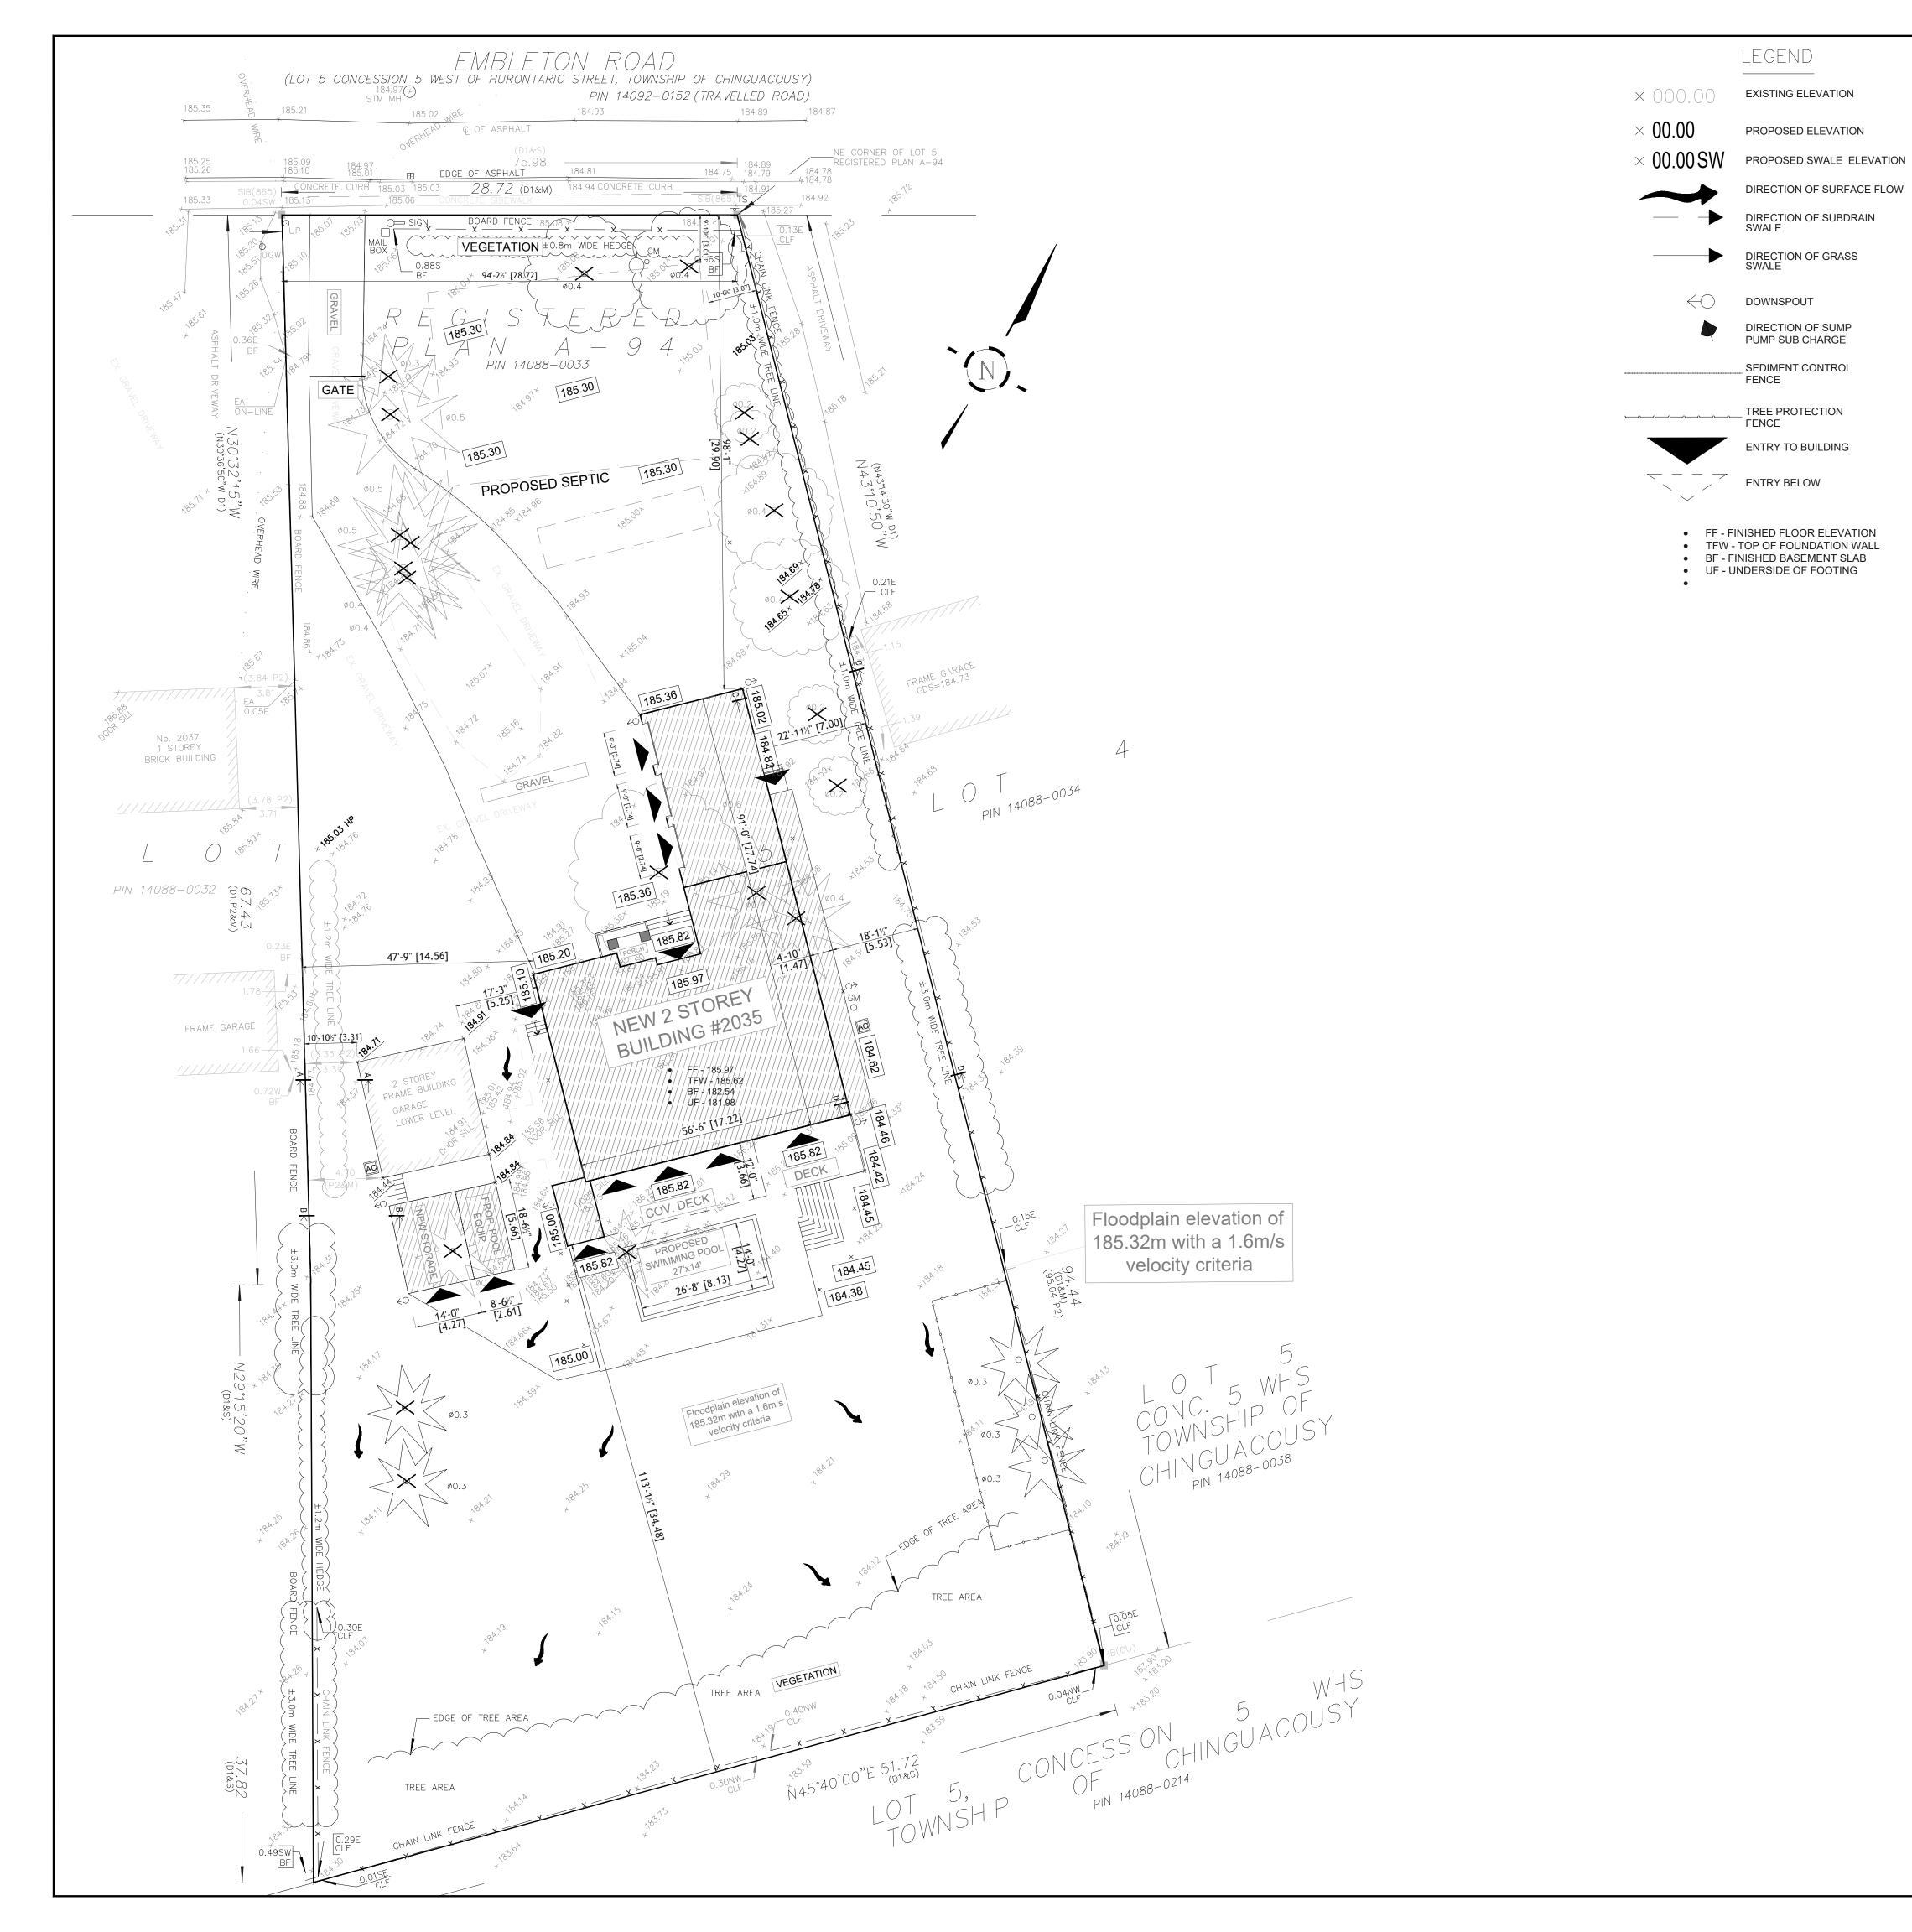

KEYPLAN: 2035 EMBLETON RD. ON. L6Y 0E9 SCALE: NTS

	REQU	IRED	PROPOSED	
	SQ.FT	m²	SQ.FT	m²
LOT AREA			42235.75	3923.8
EX. BUILDING AREA			553.59	51.43
NEW BUILDING AREA			4002.85	371.8
NEW STORAGE AREA			259.45	24.10
NEW POOL EQUIPMENT AREA			158.50	14.73
LOT COVERAGE				11.
	GROSS FLOOR	1		
FIRST FLOOR	SQ.FT	m²	SQ.FT	m²
FIRST FLOOR SECOND FLOOR	-	-	2754.50 2654.16	255.9 246.5
SECOND FLOOR	-	-	2034.10	240.5
TOTAL G.F.A.	-	-	5408.66	502.4
FINISHED BASEMENT	-	-	2635.03	244.8
	FT	m	FT	m
AVERAGE ESTABLISH GRADE			<u> </u>	
NORTH (FRONT)				185
BUILDING HEIGHT NORTH (FRONT)		10.60	30'-11 1/4"	9.43
(I KONT)				
AVERAGE ESTABLISH GRADE				185
SOUTH (REAR)				.55
BUILDING HEIGHT SOUTH (REAR)		10.60	30'-11 1/4"	9.43
AVERAGE ESTABLISH GRADE				185
EAST SIDE				100
BUILDING HEIGHT EAST SIDE		10.60	30'-11 1/4"	9.43
AVERAGE ESTABLISH GRADE WEST SIDE				185
BUILDING HEIGHT WEST SIDE		10.60	30'-11 1/4"	9.43
BUILDING LENGTH			103'-0"	31
BUILDING DEPTH			103-0"	31
LOT FRONTAGE			94'-2 ½"	28
		1	, <u>r</u>	
	SETBACK	T		
EDONT	FT	m 12.00	FT 98'-1"	20 O
FRONT REAR		7.50	98'-1" 113'-1 ½"	29.90 34.48
WEST SIDE		7.50	47'-9"	14.50
EAST SIDE		15	18'-1 ½"	5.53
<del></del>	LANDSCAPI		- · / <b>Z</b>	
	REQU		PROPO	SED
	SQ.FT	m²	SQ.FT	m²
FRONT YARD LANDSCAPING AREA			15061.99	1399.2
SOFT LANDSCAPE AREA			10543.56	989.5
HARD LANDSCAPE AREA	-	-	4518.43	419.7
REAR YARD AREA BREAK DOWN		70%		7
			416.00	20.0
COVERED DECK			416.00	38.6
SWIMMING POOL			443.89	41.24
	1	1	443.09	41.4



Phone: +1(647)478-5055 Toll free: +1(885)561-4161 info@ithd.ca

GENERAL NOTES

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DO NOT SCALE DRAWINGS

ALL WORKS IS TO BE CARRIED OUT ACCORDING TO THE ONTARIO BUILDING CODE 2012 AND BY-LAWS ALL EXISTING SURFACES AND STRUCTURES ADJACENT TO THE PROPOSED WORK ARE TO BE PROTECTED DURING DEMOLITION AND CONSTRUCTION

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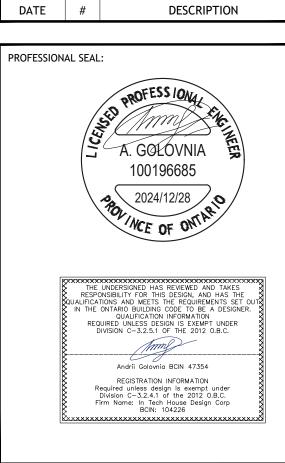
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ADDITIONAL NOTES:

REVISIONS AND ISSUES 2024/12/28 3 REVISED PER CITY COMMENTS

2024/11/07 2 REVISED PER CITY COMMENTS

2024/09/25 1 ISSUED FOR CVC PERMIT



PROJECT NAME: **New Custom House** PROJECT ADDRESS:


2035 Embleton Rd. Brampton, ON. L6Y 0E9

Site Plan & Key Plan

DESIGN BY: DRAWN BY: CHECKED BY: 2024/12/28

PROJECT №:

DRAWING №: SP-1

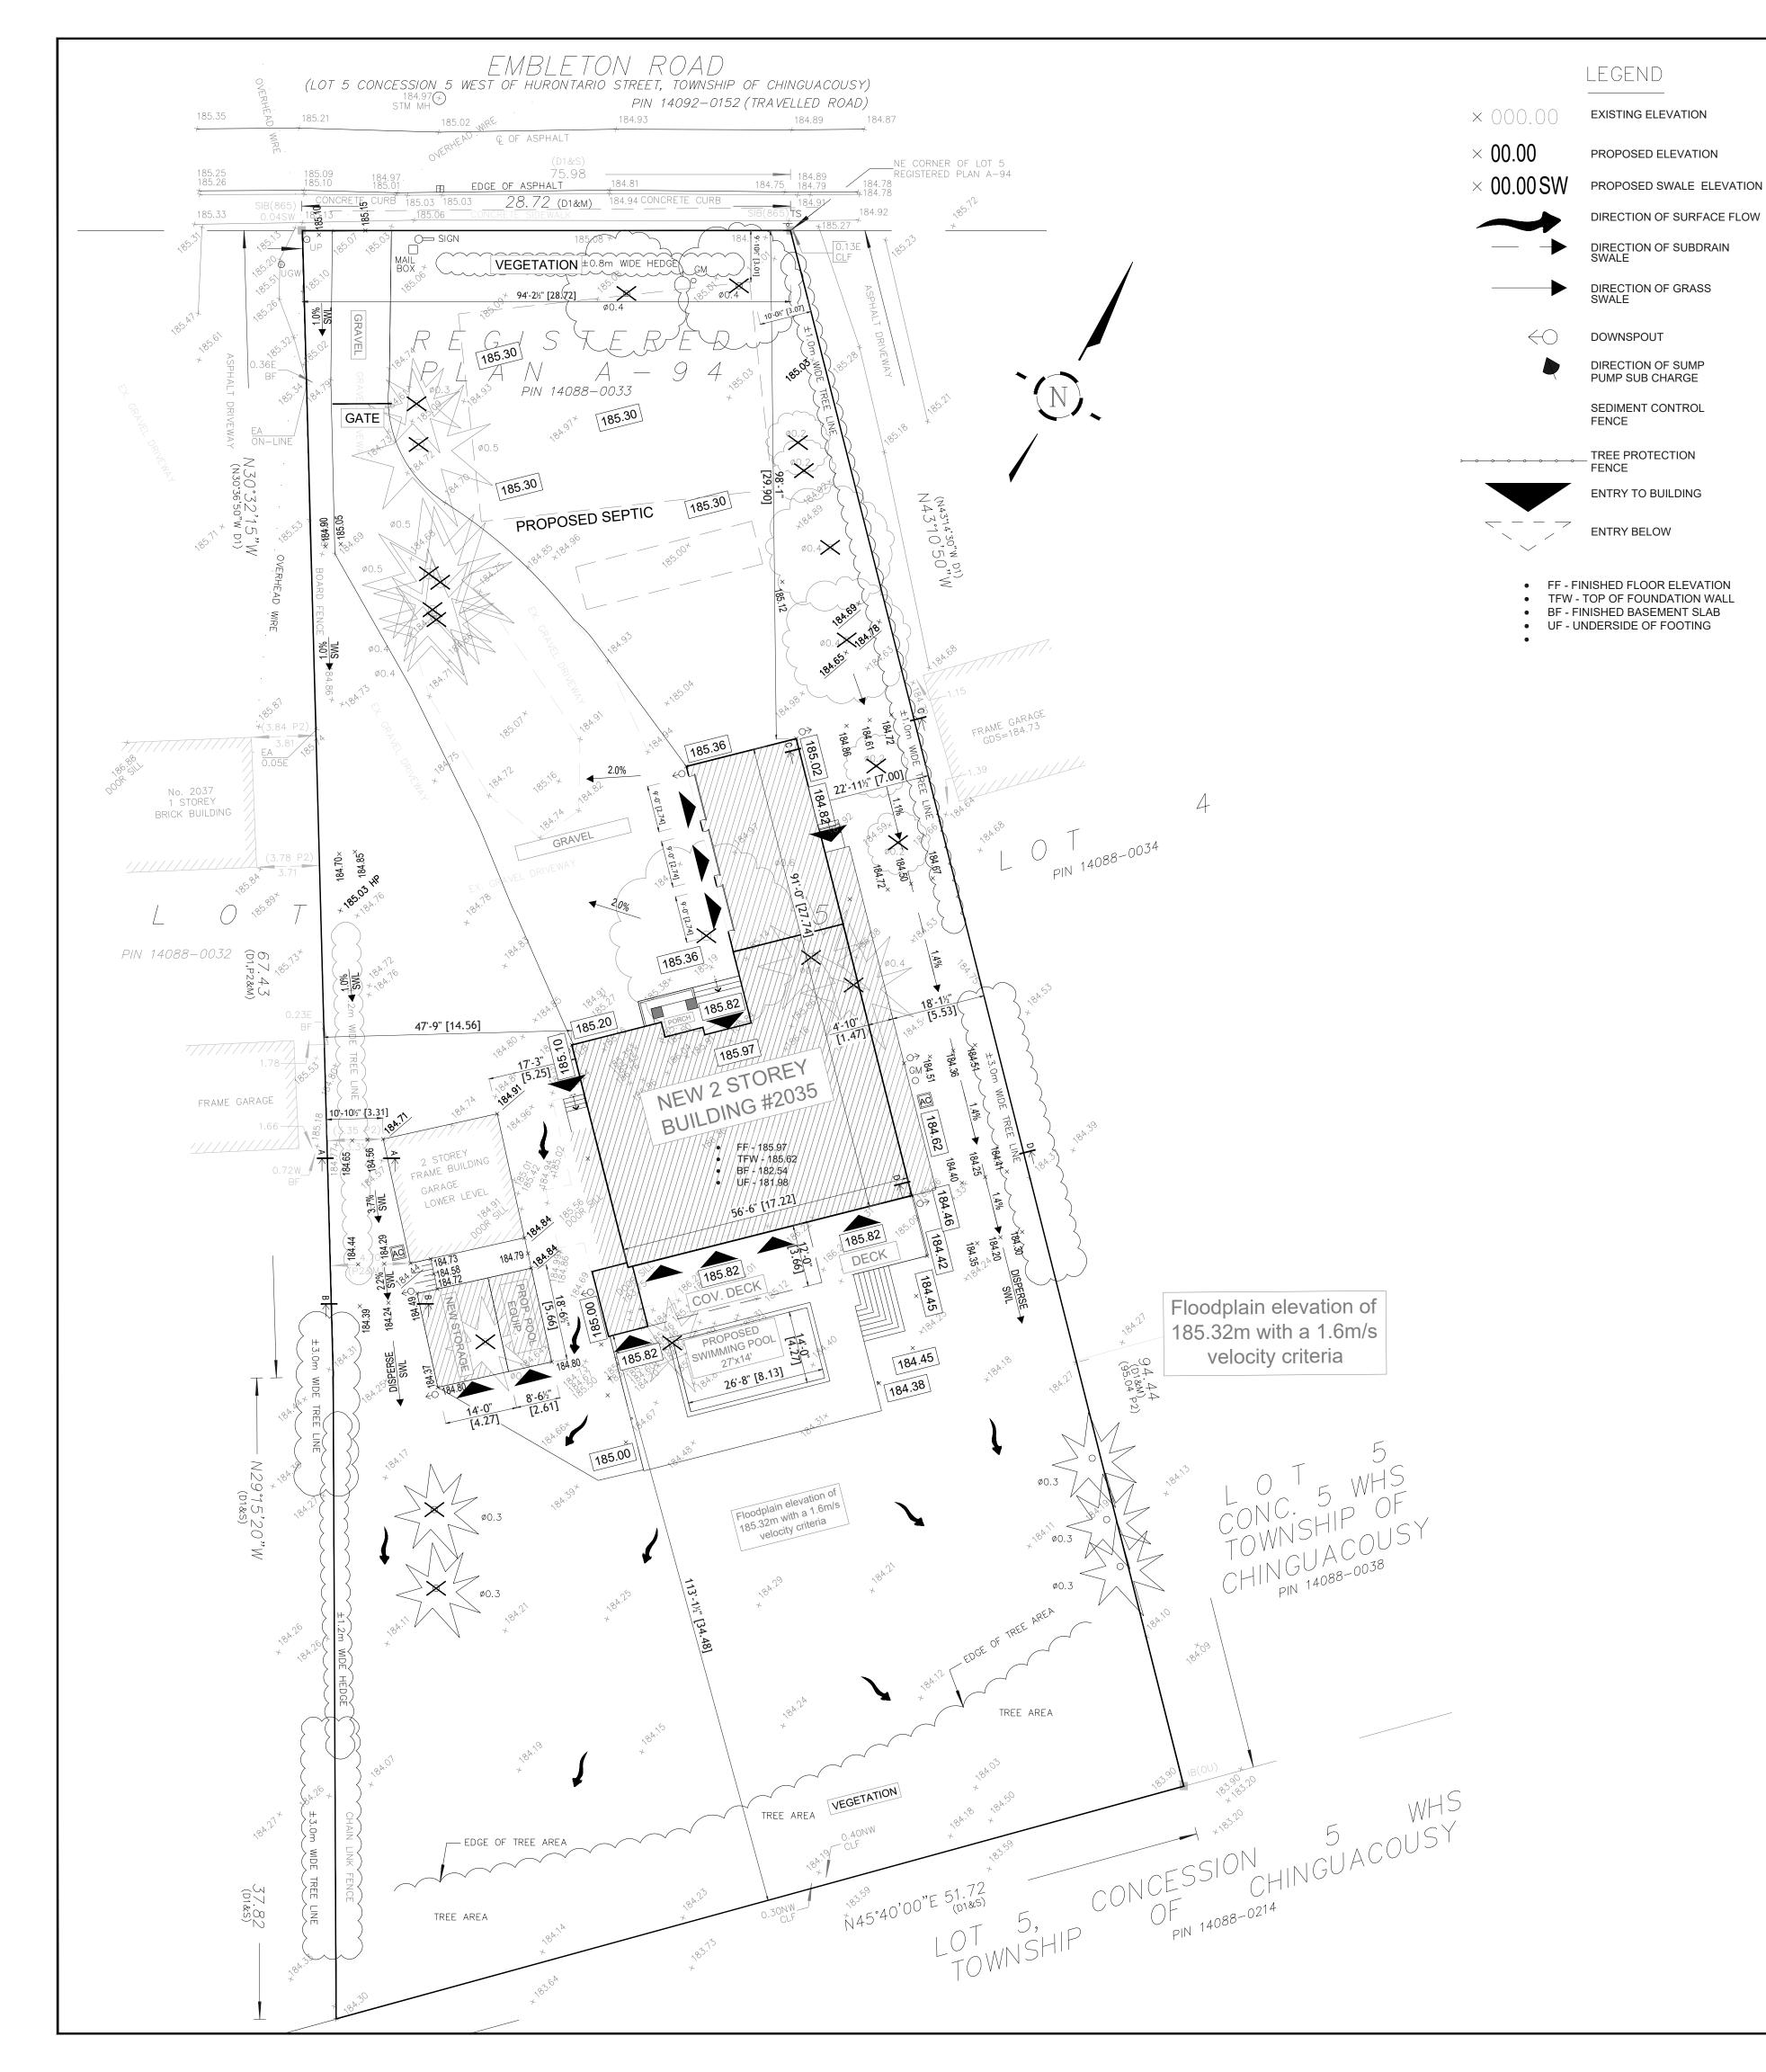

## **GENERAL NOTES**

- BOUNDARY INFORMATION SHOWN HERE IS COMPILED FROM A PLAN OF SURVEY BY AISAR BHERI OF MACKAY, MACKAY & PETERS LIMITED. DATED DECEMBER 8, 2021. ALL CONSTRUCTION SHELL BE IN ACCORDANCE WITH CURRENT ONTARIO
- PROVINCIAL STANDARD DRAWINGS AND SPECIFICATIONS. ALL DIMENSION SHELL BE CHECKED AND VERIFIED BY THE CONTRACTOR. ANY DISCREPANCIES TO BE REPORTED TO THE ENGINEER. LOCATIONS AND ELEVATIONS OF EXISTING UTILITIES AND SERVICES SHOWN ON THE PLAN ARE FOR REFERENCE ONLY. THE CONTRACTOR IS RESPONSIBLE FOR LOCATING AND PROTECTING ALL UTILITIES AND

### SERVICES. **ELEVATION NOTE:**

• ELEVATIONS ARE GEODETIC IN ORIGIN AND WERE DERIVED FROM OBSERVED REFERENCE POINTS (ORP) USING THE LEICA SMARTNET NETWORK (2010 EPOCH) AND ARE REFERRED TO THE CGVD28:1978

### (HTv2.0) DATUM. **BENCHMARK NOTE:**

- CITY OF BRAMPTON BENCHMARK No. 042200354.
- ELEVATION = 205.880 METRES (CGVD28:78 ADJUSTMENT). 31.77m NORTH OF CENTRELINE OF QUEENSTREET WEST, 60.18m EAST OF CENTRELINE OF MISSISSAUGA RD.

### **BEARING NOTE:**

- BEARINGS ARE ASTRONOMIC AND ARE REFERRED TO THE SOUTHERLY LIMIT OF THE EMBLETON ROAD AS SHOWN ON PLAN 43R-25290, HAVING A BEARING OF N61°00'10" E
- SURFACE DRAINAGE TO BE DIRECTED AWAY FROM THE BUILDING TO SIDE YARD SWALES OR DITCHES. MAXIMUM SIDE SLOPES NOT TO EXCEED 3:1
- ALL STORM WATER SHALL BE DIRECTED IN SUCH A MANNER THAT WATER WILL NOT ACCUMULATE AT OR NEAR A BUILDING INCLUDING FOUNDATION WALLS, WINDOWS, ENTRANCES AND WALKWAYS.
- ALL DISTURBED AREAS TO BE SODDED OR SEEDED OVER 75mm OF TOPSOIL.

## CONSTRUCTION SCHEDULE

- 1. ALL SNOW FENCING AND SEDIMENT CONTROL FENCING TO BE INSTALLED AND MAINTAINED THROUGHOUT THE ENTIRE CONSTRUCTION PHASE. 2. SEDIMENT CONTROLS ARE TO BE INSPECTED REGULARLY TO ENSURE
- PROPER FUNCTION. FOLLOW THE SCHEDULE SHOWN. 3. SEDIMENT AND EROSION CONTROL MEASURES SHOULD BE UPGRADED
- IMMEDIATELY IF THEY ARE NOT EFFECTIVE. 4. ALL DAMAGED SEDIMENT AND EROSION CONTROL MEASURES SHOULD BE REPAIRED AND/OR REPLACED WITHIN 48 HOURS OF DISCOVERING THE
- 5. UNDER NO CIRCUMSTANCES IS SEDIMENT TO BE RELEASED INTO THE
- NATURAL ENVIRONMENT
- 6. IF A LARGE RAIN EVENT IS IMMINENT, EARTH WORK ACTIVITIES WILL CEASE AND ALL EROSION AND SEDIMENT CONTROL MEASURES WILL BE INSPECTED TO ENSURE THEY ARE IN GOOD WORKING ORDER.
- 7. IF SITE CONSTRUCTION ACTIVITIES ARE INTERRUPTED AND/OR INACTIVITY EXCEEDS 30 DAYS ALL STRIPPED AND/OR BARE SOIL AREAS ARE TO BE STABILIZED BY SODDING/SEEDING/MULCHING OR OTHER APPROVED METHOD TO THE SATISFACTION OF THE CITY OF TORONTO.
- 8. DURING ALL CONSTRUCTION PHASES, MUD TRACKING CONTROL WILL CONSIST OF MAINTAINING THE STONE PAD CONSTRUCTION ENTRANCE AND/OR FLUSHING OR SWEEPING ROADS AS WARRANTED.

- EX. SAN CON. TO BE DECOMMISSIONED BY CITY AT OWNER EXPENSE - EX. STORM CON. TO BE DECOMMISSIONED BY CITY AT OWNER EXPENSE - EX. WATER CON. TO BE DECOMMISSIONED BY CITY AT OWNER EXPENSE

## **UNDERGROUND SERVICES**

THE LOCATION OF UNDERGROUND SERVICES SHOWN ON THIS PLAN IS ONLY APPROXIMATE AND IS FOR PLANNING AND DESIGN PURPOSES ONLY. THIS INFORMATION MUST NOT BE ASSUMED TO BE COMPLETE OR UP-TO-DATE. THE UNDERNAMED COMPANY AND EACH UTILITY ACCEPTS NO RESPONSIBILITY FOR ANY CLAIMS OR LOSSES DUE TO IMPROPER USE OF THE INFORMATION SHOWN HEREON AND EACH UTILITY MUST BE CONTACTED FOR AN ON-SITE LOCATE PRIOR TO ANY EXCAVATION.

- ALL FOOTING FORMWORK ELEVATIONS AND SETBACKS ARE TO BE CONFIRMED BY A REGISTERED PROFESSIONAL ENGINEER OR A REGISTERED ONTARIO LAND SURVEYOR PRIOR TO THE PLACING OF ANY CONCRETE. - PRIOR TO THE SUPERSTRUCTURE WORKS PROCEEDING AND THE RELEASE OF THE COMPLETION STAGE PERMIT, THAT OWNER S CONSULTANT MUST CERTIFY THAT THE TOP OF FOUNDATIONS IS IN CONFORMITY WITH THE GRADING PLAN REVIEWED BY TOWN,

- ALL RAINWATER LEADERS SHALL DISCHARGE ONTO CONCRETE SPLASH PADS AT GROUND LEVEL AT THE LOCATIONS INDICATED ON THIS PLAN - EXISTING BOUNDARY ELEVATIONS ALONG THE SITE PERIMETER SHALL REMAIN UNDISTURBED. DRAINAGE RECEIVED FROM ADJACENT PROPERTIES SHALL BE ACCOMMODATED AND DRAINAGE FROM THE SUBJECT LANDS SHALL BE SELF-CONTAINED.


- THE OWNER SHALL CONTACT THE TOWNS ARBORIST FOR CONSENT PRIOR TO ANY TREE BEING REMOVED. - THE OWNER SHALL CONTACT THE OPERATIONS SECTION OF THE ENGINEERING


& PUBLIC WORKS DEPARTMENT AND MAKE ALL ARRANGEMENTS NECESSARY FOR DRIVEWAY ACCESS AND SITE SERVICE CONNECTIONS. - THE OWNER SHALL CONTACT THE TOWNS BUILDING SERVICES DIVISION A


MINIMUM OF 48 HOURS IN ADVANCE OF CONSTRUCTION OF ANY RETAINING WALL DEEMED TO BE A "DESIGNATED STRUCTURE". IN ORDER TO ARRANGE FOR ANY NECESSARY INSPECTIONS:


- THE OWNER IS RESPONSIBLE TO ENSURE ALL CONSTRUCTION ACTIVITY AND FINAL PRODUCT CONFORMS TO ALL TOWN BYLAWS.


- FOR PROPOSED INFILTRATION GALLERIES, THE OWNER SHALL PROVIDE THE TOWN WITH CONSTRUCTION PHOTOS AFTER EXCAVATION OF THE GALLERY AND TRENCHES FOR ROOF DRAIN PIPE CONNECTIONS. PRIOR TO BACKFILLING, THE OWNER SHALL ALSO PROVIDE CONSTRUCTION PHOTOS AFTER INSTALLATION OF CLEAR STONE AND ROOF DRAIN PIPE.

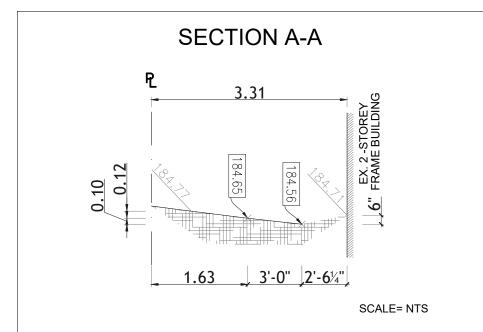


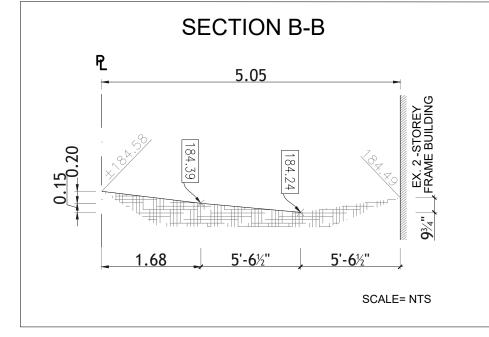

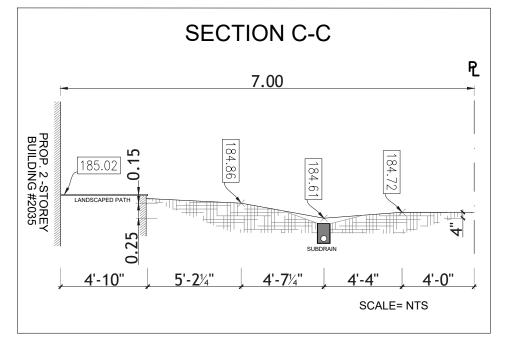

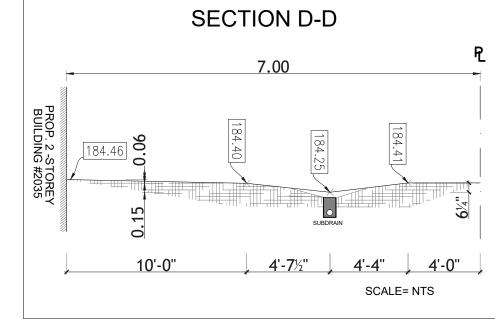

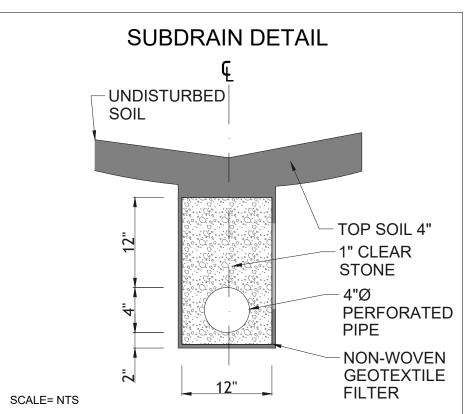

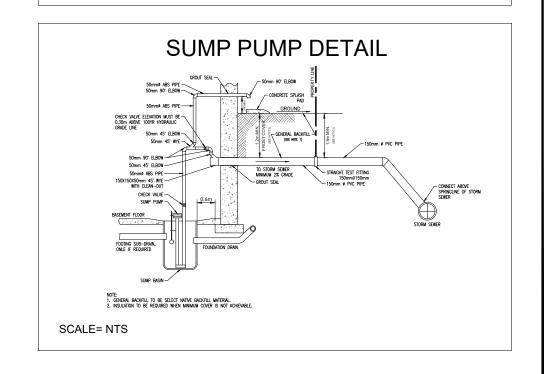



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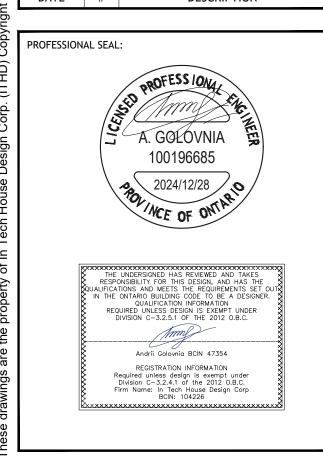
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RELEVANT DRAWINGS AND SPECIFICATIONS THESE DRAWING MUST NOT BE DUPLICATED IN ANY FORM, OR USE FOR ANY OTHER PROJECTS, WITHOUT WRITTEN CONSENT OF THE

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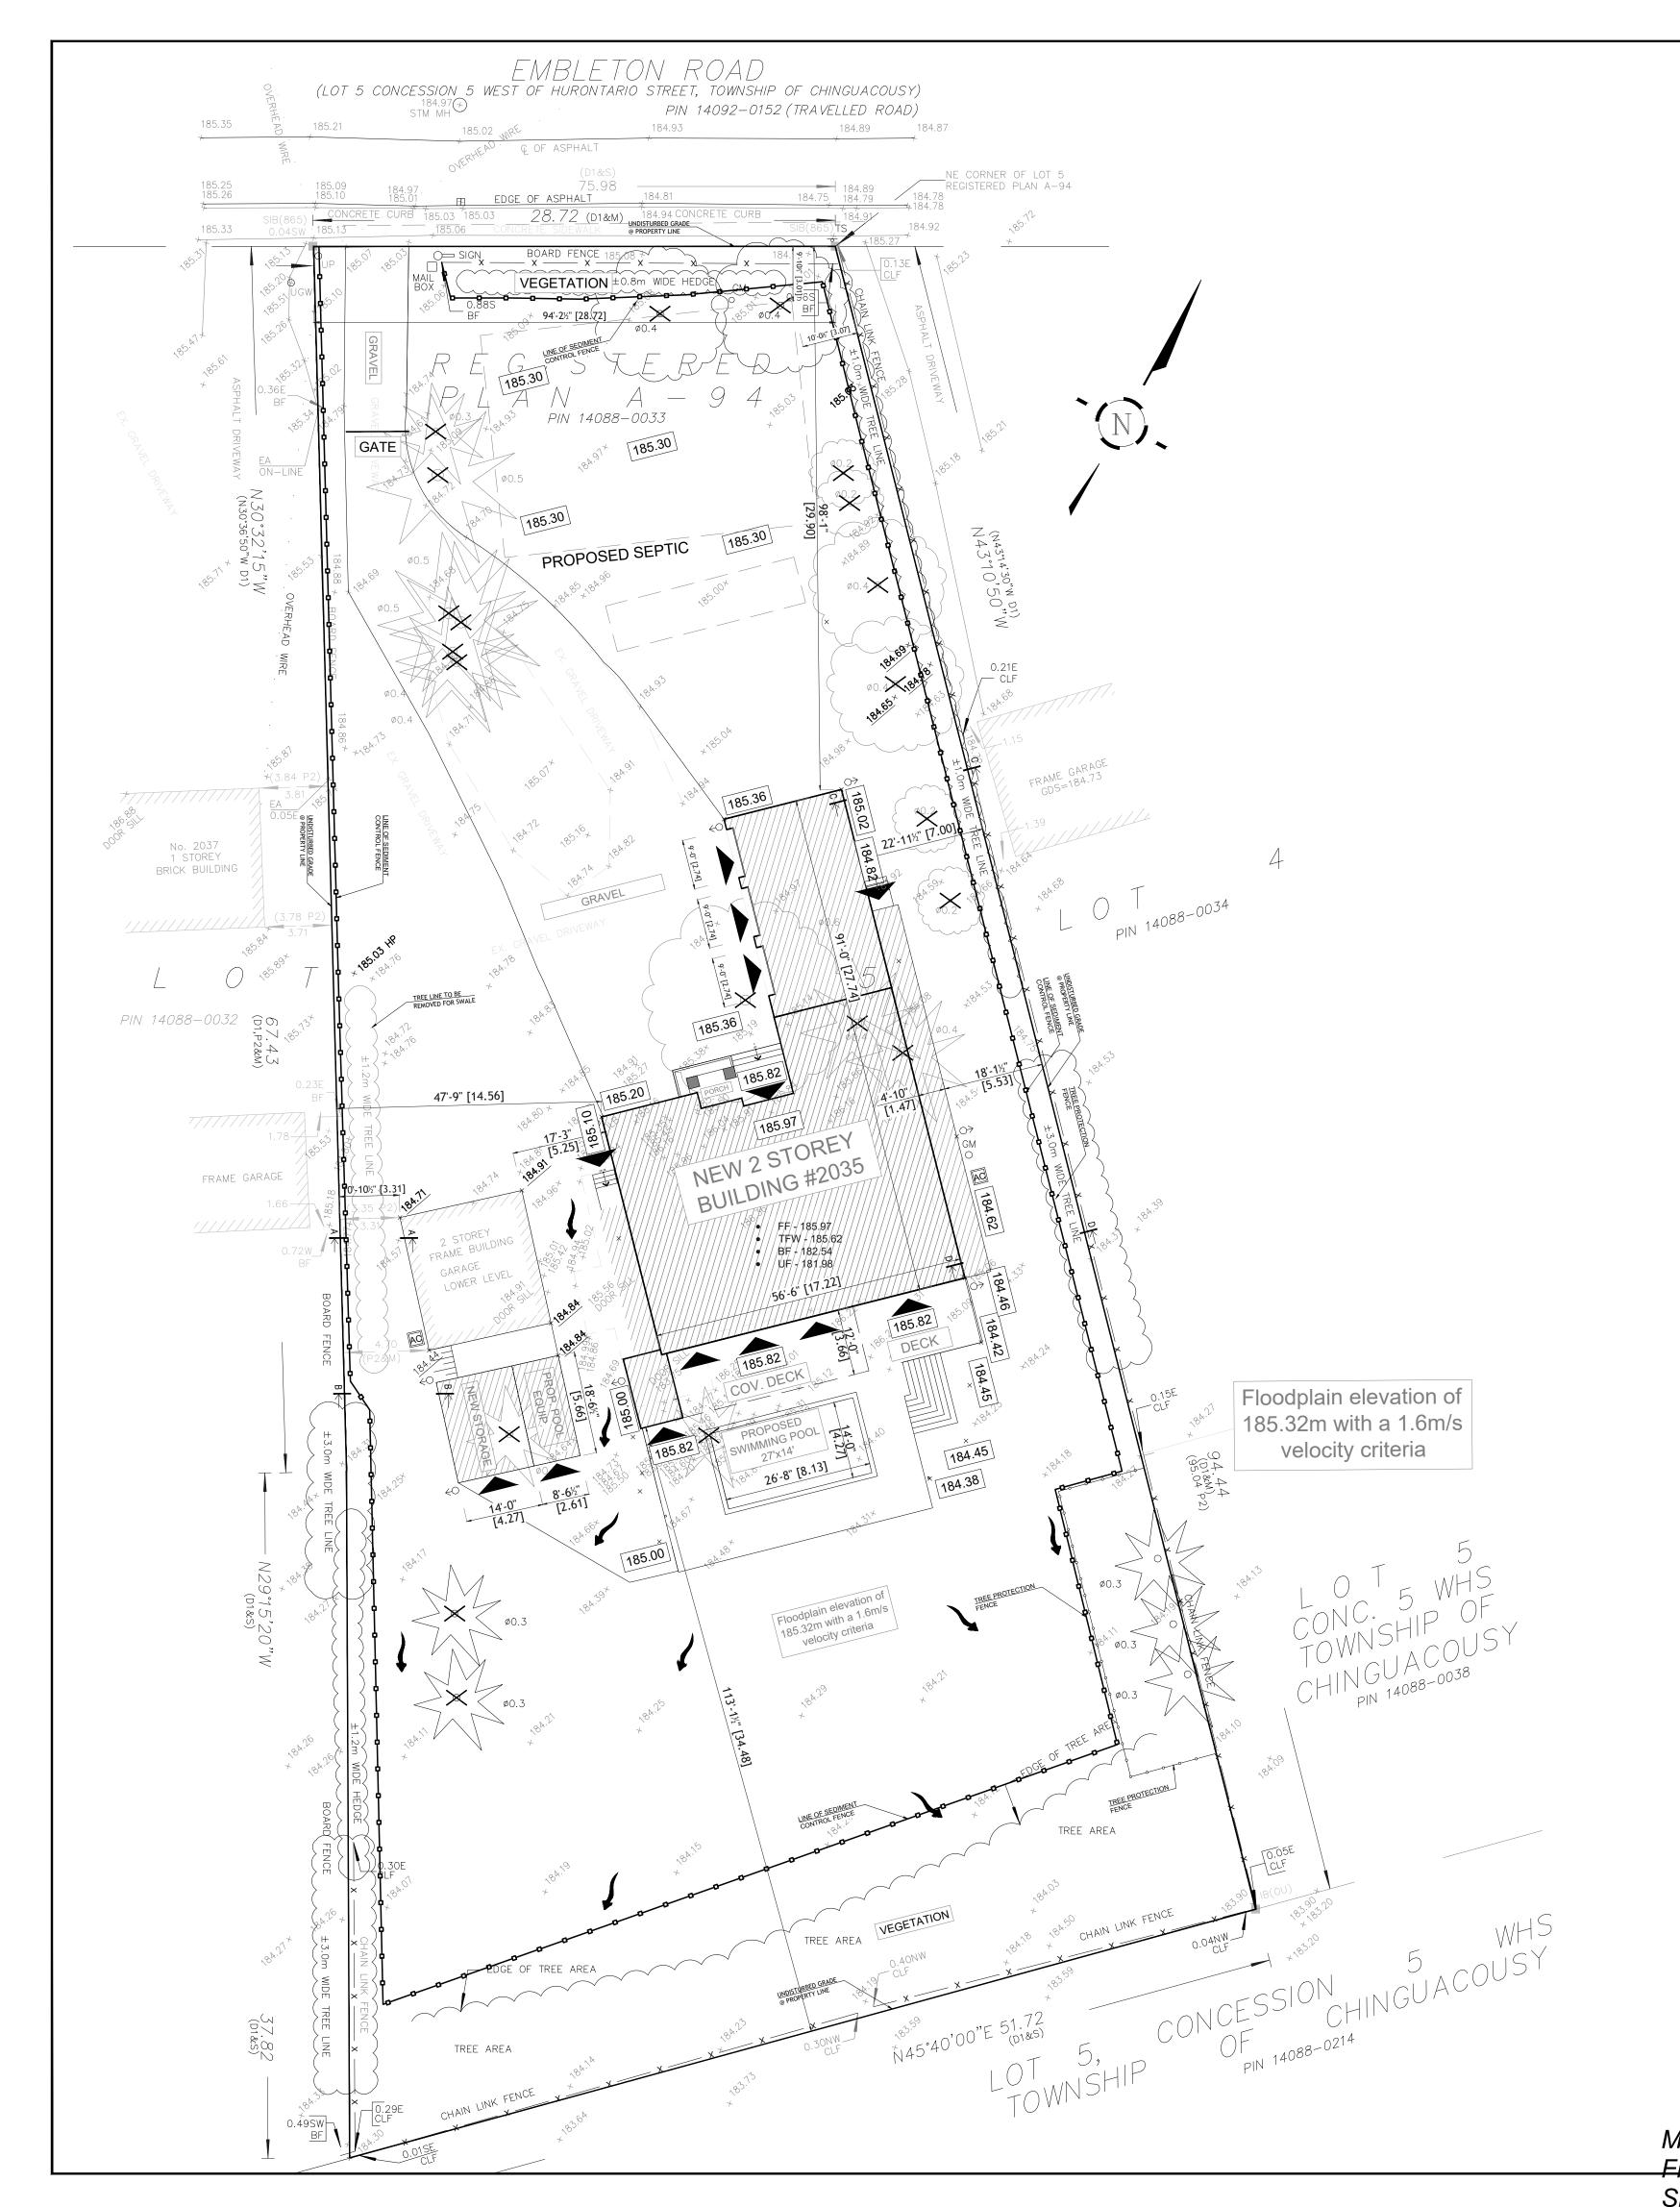
**REVISIONS AND ISSUES** 2024/12/28 3 REVISED PER CITY COMMENTS 2024/11/07 2 REVISED PER CITY COMMENTS 2024/09/25 1 ISSUED FOR CVC PERMIT DATE # DESCRIPTION




PROJECT NAME: New Custom House PROJECT ADDRESS: 2035 Embleton Rd. Brampton, ON. L6Y 0E9

**Grading Plan** 

DESIGN BY: DRAWN BY: DRAWING №: CHECKED BY: 2024/12/28 PROJECT №:



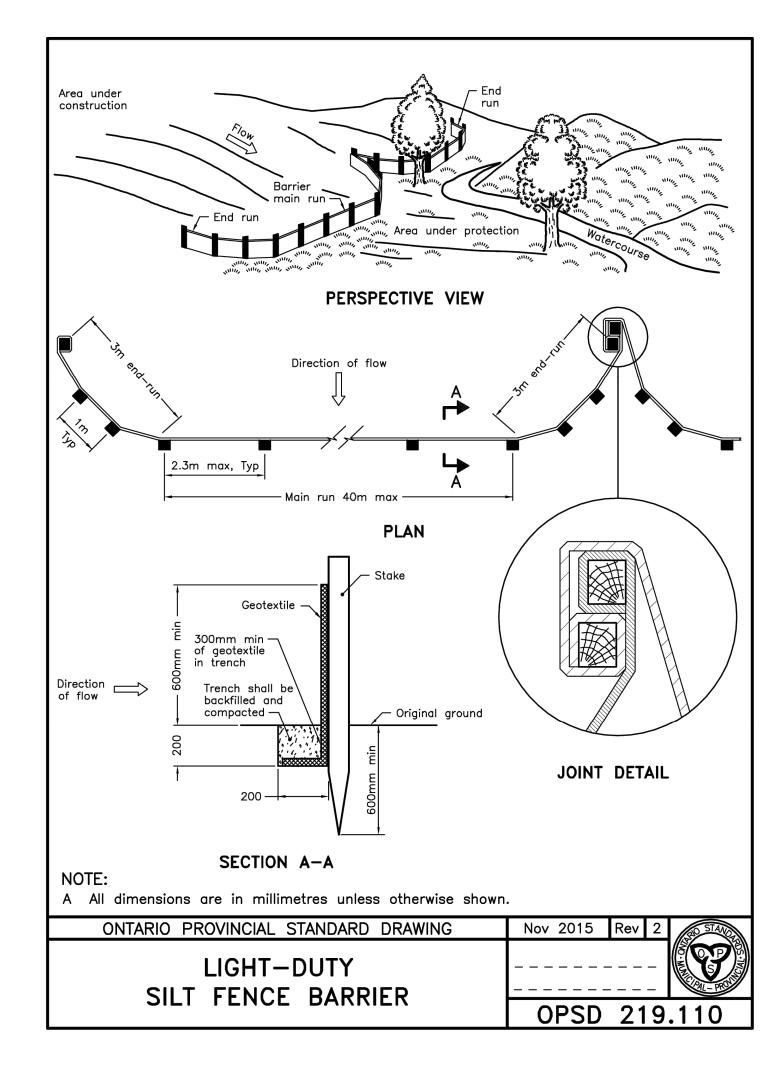

ESC LEGEND

← DOWNSPOUT DIRECTION OF SUMP PUMP SUB CHARGE  $\multimap$  TREE PROTECTION BARRIERS -□--- DENOTES SILT FENCE

FFE - FIRST FLOOR ELEVATION
TOFFW - TOP OF FOUNDATION WALI
TOFBS - TOP BASEMENT SLAB
BOFF - BOTTOM OF THE FOOTING ENTRY TO BUILDING

C - Z ENTRY BELOW TREES TO BE REMOVED

### **SCHEDULE**

INITIAL SEDIMENT CONTROL INSTALLATION; TBD 2024-2025 SITE GRADING OPERATION; TBD 2025 UNDERGROUND SERVICING OPERATIONS; TBD 2025 BUILDING CONSTRUCTION; TBD 2025 FINAL GRADING OPERATION; TBD 2025

#### SEDIMENT CONTROL INSPECTION AND MAINTENANCE OF SEDIMENT FENCE

1. CHECK FOR ANY LOOSE ENDS AND ATTACH TO THE TEE STAKES OR BURY INTO THE GROUND AND/OR PLACE CLEAR STONE AT THE BOTTOM OF THE FENCE AS REQUIRED. 2. CHECK FOR ANY DAMAGED, BROKEN FENCE AND REPLACE WITH

NEW FILTER FABRIC, ATTACH TO THE TEE STAKES AND BURY INTO THE GROUND AS REQUIRED. 3. CHECK FOR SEDIMENT BUILD UP AND CLEAN IF NECESSARY.

#### **EROSION AND SEDIMENT CONTROL / GENERAL NOTES**

1. SEDIMENT BARRIERS, CHECK DAMS. AND TEMPORARY CONSTRUCTION ACCESS TO BE INSTALLED PRIOR TO THE BEGINNING OF CONSTRUCTION.

2. ALL SEDIMENT CONTROL DEVICES TO BE ROUTINELY INSPECTED AND MAINTAINED IN PROPER WORKING ORDER UNTIL AREA IS STABILIZED.

3. IF NECESSARY, TRUCKS WILL BE WASHED DOWN BEFORE LEAVING THE SITE.

4. THE SITE WILL BE WET DOWN IF NECESSARY TO CONTROL DUST. 5. ALL CONSTRUCTION EQUIPMENT MUST BE PARKED ON-SITE.

6. WILL COMPLY WITH KING CITY NOISE BY-LAW. 7. SEDIMENT CONTROL FENCE TO BE AS PER LSRCA STANDARD 8. ALL CONSTRUCTION VEHICLES TO ENTER AND EXIT SITE FROM

TEMPORARY CONSTRUCTION ACCESS. 9. ALL TOPSOIL STOCKPILES TO BE SURROUNDED WITH SEDIMENT CONTROL FENCING.

#### SEDIMENT AND EROSION CONTROL NOTES

INSTALL ALL EROSION AND SEDIMENT CONTROL MEASURES APPROVED BY THE LOCAL CONSERVATION AUTHORITY AND THE CITY, PRIOR TO DEVELOPMENT, AND MAINTAIN SUCH MEASURES THROUGHOUT THE CONSTRUCTION PROCESS, UNTIL ALL DISTURBED AREAS HAVE BEEN INSPECTED. MAINTAIN ALL EROSION AND SEDIMENT CONTROL MEASURES AFTER EACH RAINFALL TO THE SATISFACTION OF THE CITY. MAINTAIN A DIARY FOR REVIEW UPON REQUEST.

PROVIDE SUITABLE TEMPORARY MULCH AND SEED COVER WITHIN SEVEN (7) DAYS OF THE COMPLETION OF A PARTICULAR PHASE OF CONSTRUCTION FOR ANY DISTURBED AREA NOT SCHEDULED FOR FURTHER CONSTRUCTION WITHIN FORTY-FIVE (45) DAYS; AND RE-VEGETATED ALL DISTURBED AREAS WITH PERMANENT COVER IMMEDIATELY FOLLOWING COMPLETION OF CONSTRUCTION.

THE EROSION AND SEDIMENT CONTROL STRATEGIES OUTLINED ON THE PLANS ARE NOT STATIC AND MAY NEED TO BE UPGRADED/AMENDED AS SITE CONDITIONS CHANGE TO MINIMIZE SEDIMENT LADEN RUNOFF FROM LEAVING THE WORK AREAS. IF THE PRESCRIBED MEASURES ON THE PLANS ARE NOT EFFECTIVE IN PREVENTING THE RELEASE OF A DELETERIOUS SUBSTANCE, INCLUDING SEDIMENT, THEN ALTERNATIVE MEASURES MUST BE IMPLEMENTED IMMEDIATELY TO MINIMIZE POTENTIAL ECOLOGICAL IMPACTS. LSRCA ENFORCEMENT OFFICER SHOULD BE IMMEDIATELY CONTACTED. ADDITIONAL ESC MEASURES SUCH AS CLEAR STONE, FILTER FABRIC, PUMPS HOSES AND SILTSOXX TO BE KEPT ON SITE AT ALL TIME FOR CONDUCTING REPAIRS TO SEDIMENT CONTROL MEASURES.

## **CONSTRUCTION NOTES**

- 1. ALL SNOW FENCING AND SEDIMENT CONTROL FENCING TO BE INSTALLED
- AND MAINTAINED THROUGHOUT THE ENTIRE CONSTRUCTION PHASE. 2. SEDIMENT CONTROLS ARE TO BE INSPECTED REGULARLY TO ENSURE
- PROPER FUNCTION. FOLLOW THE SCHEDULE SHOWN. 3. SEDIMENT AND EROSION CONTROL MEASURES SHOULD BE UPGRADED IMMEDIATELY IF THEY ARE NOT EFFECTIVE. 4. ALL DAMAGED SEDIMENT AND EROSION CONTROL MEASURES SHOULD BE

REPAIRED AND/OR REPLACED WITHIN 48 HOURS OF DISCOVERING THE

- 5. UNDER NO CIRCUMSTANCES IS SEDIMENT TO BE RELEASED INTO THE
- NATURAL ENVIRONMENT. 6. IF A LARGE RAIN EVENT IS IMMINENT, EARTH WORK ACTIVITIES WILL
- CEASE AND ALL EROSION AND SEDIMENT CONTROL MEASURES WILL BE INSPECTED TO ENSURE THEY ARE IN GOOD WORKING ORDER. 7. IF SITE CONSTRUCTION ACTIVITIES ARE INTERRUPTED AND/OR INACTIVITY EXCEEDS 30 DAYS ALL STRIPPED AND/OR BARE SOIL AREAS ARE TO BE STABILIZED BY SODDING/SEEDING/MULCHING OR OTHER
- APPROVED METHOD TO THE SATISFACTION OF THE CITY OF TORONTO. 8. DURING ALL CONSTRUCTION PHASES, MUD TRACKING CONTROL WILL CONSIST OF MAINTAINING THE STONE PAD CONSTRUCTION ENTRANCE AND/OR FLUSHING OR SWEEPING ROADS AS WARRANTED.



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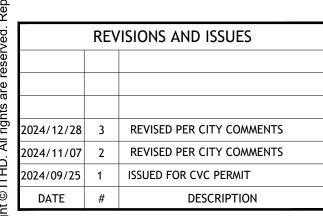
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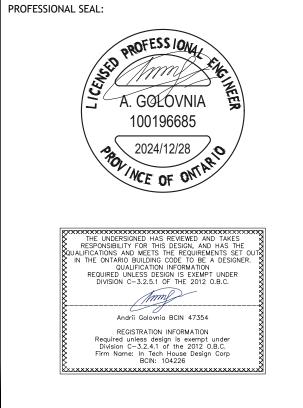
BY THE CONTRACTOR

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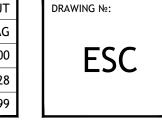
**New Custom House** 


PROJECT ADDRESS:

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Erosion & Sediment Control Plan

DESIGN BY: CHECKED BY: 2024/12/28 PROJECT №:





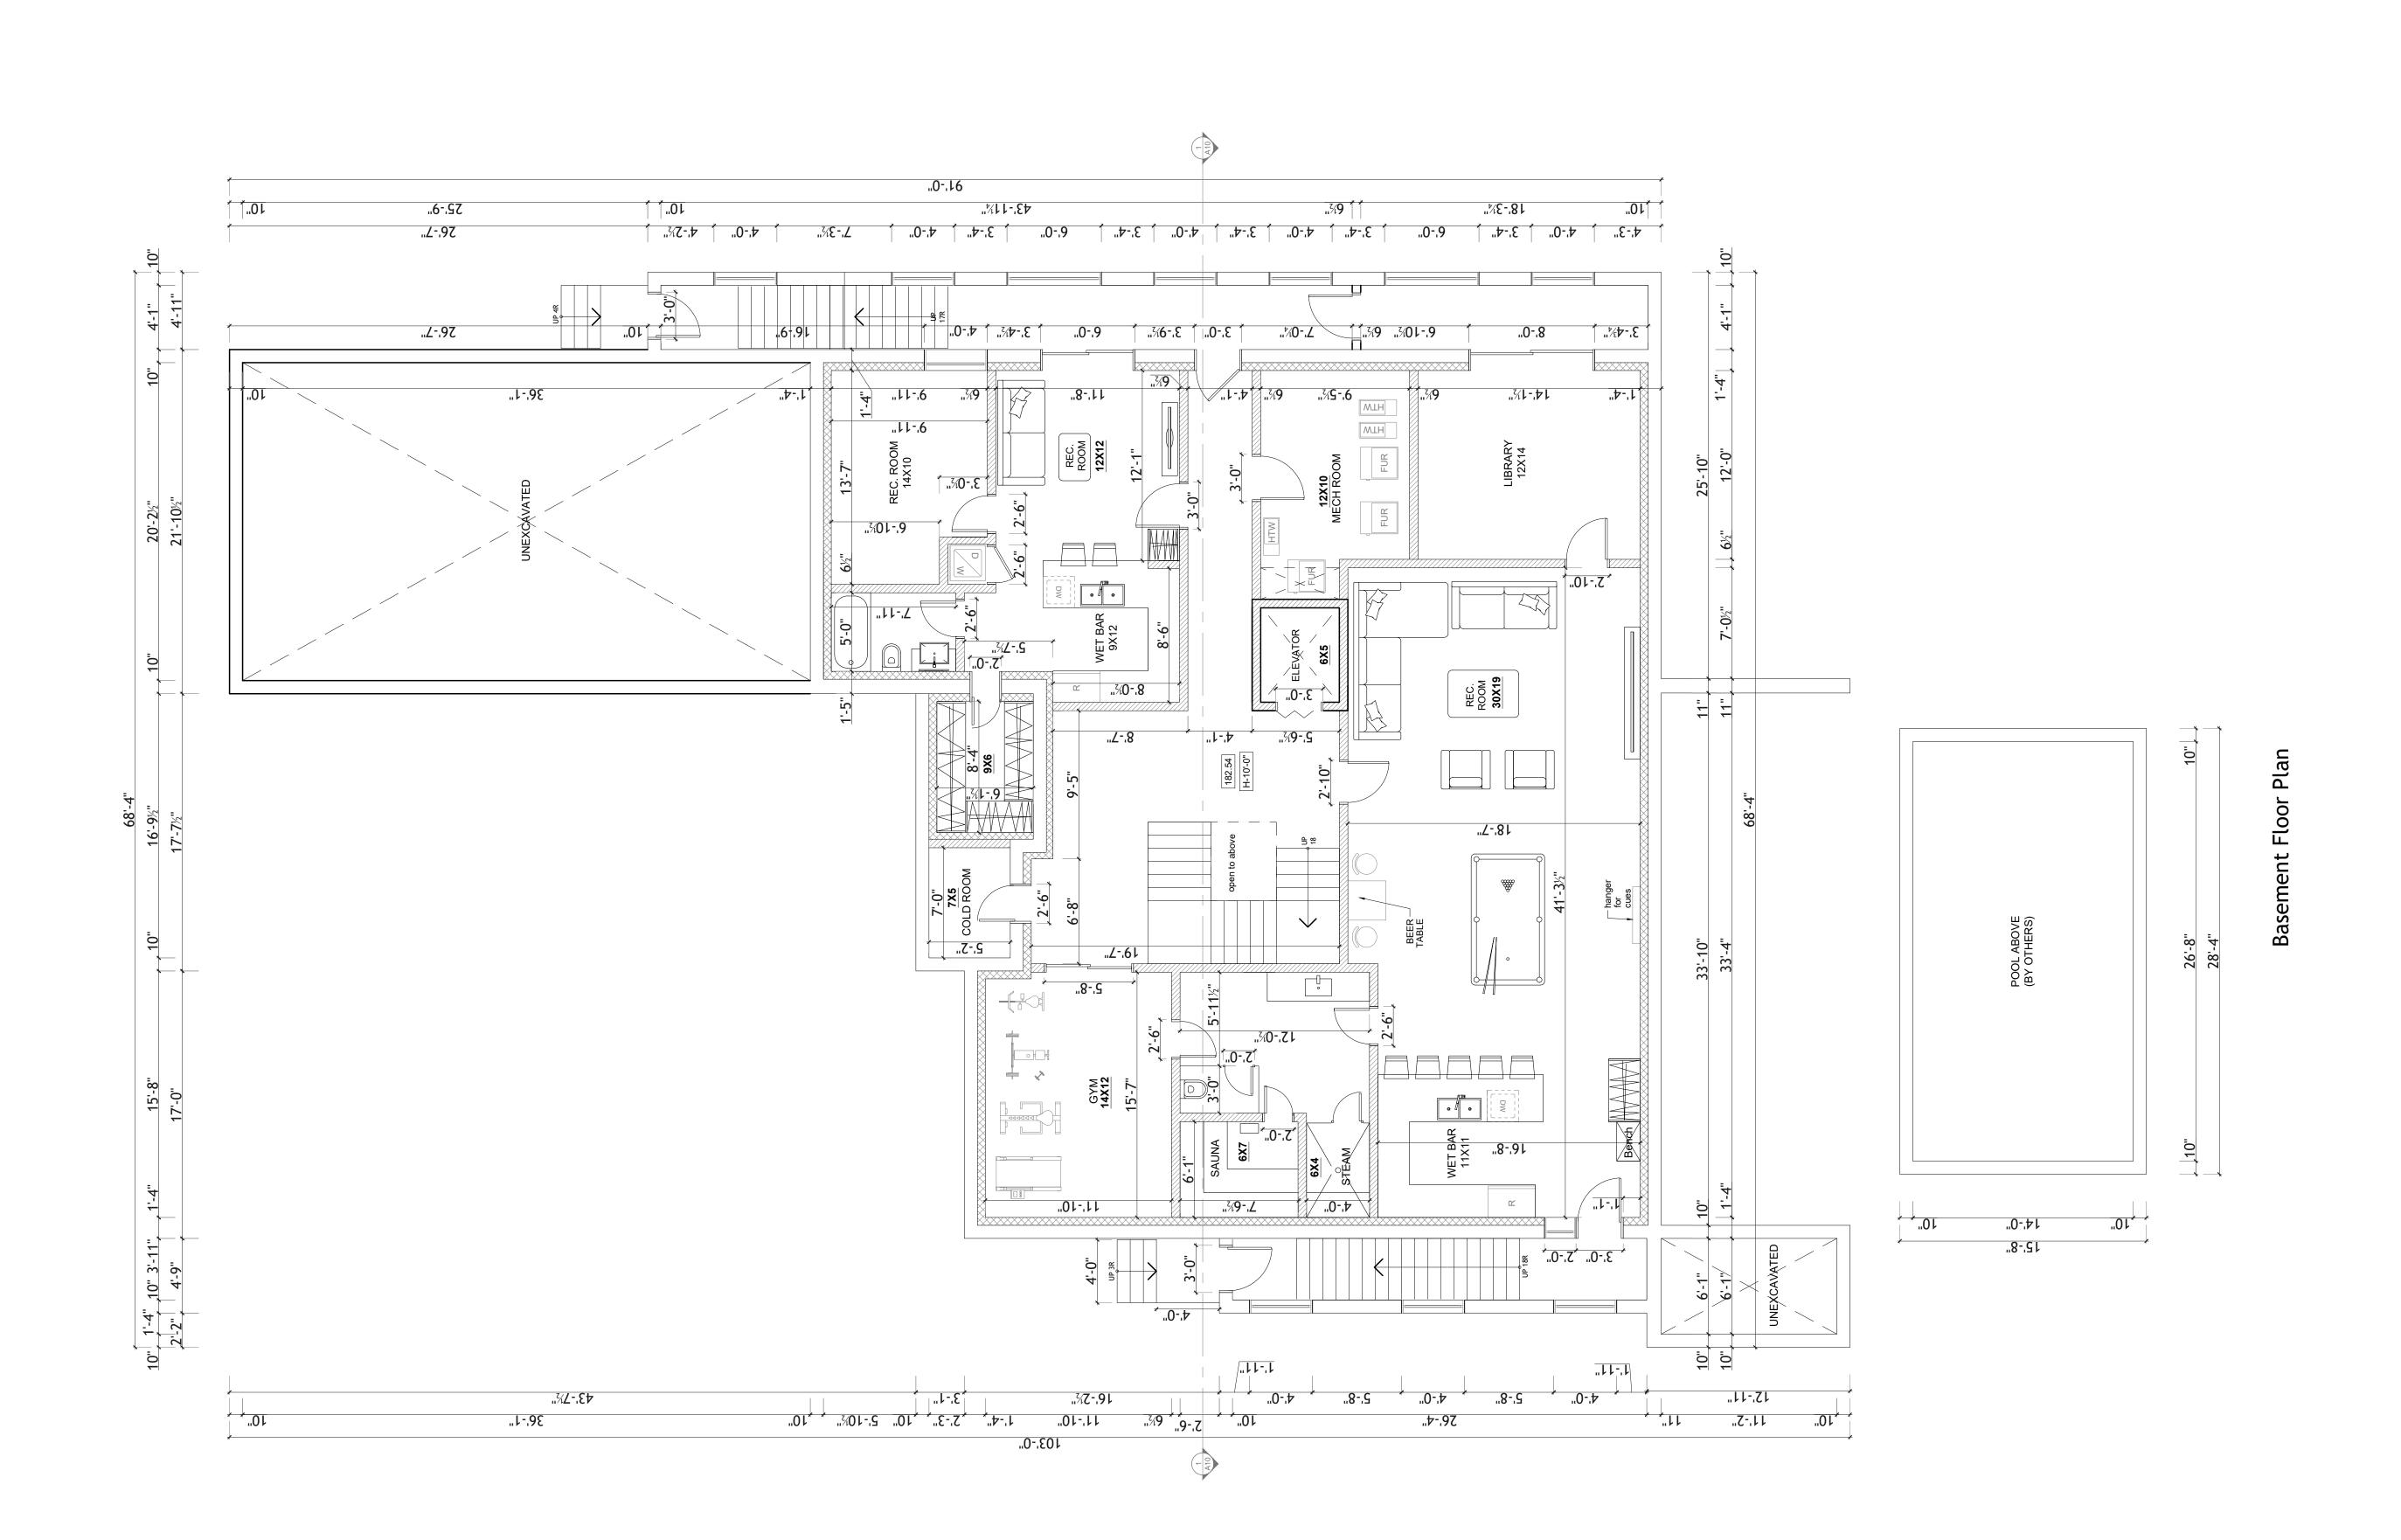

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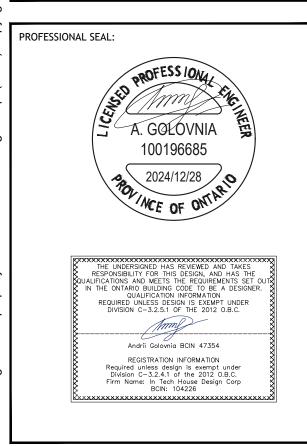
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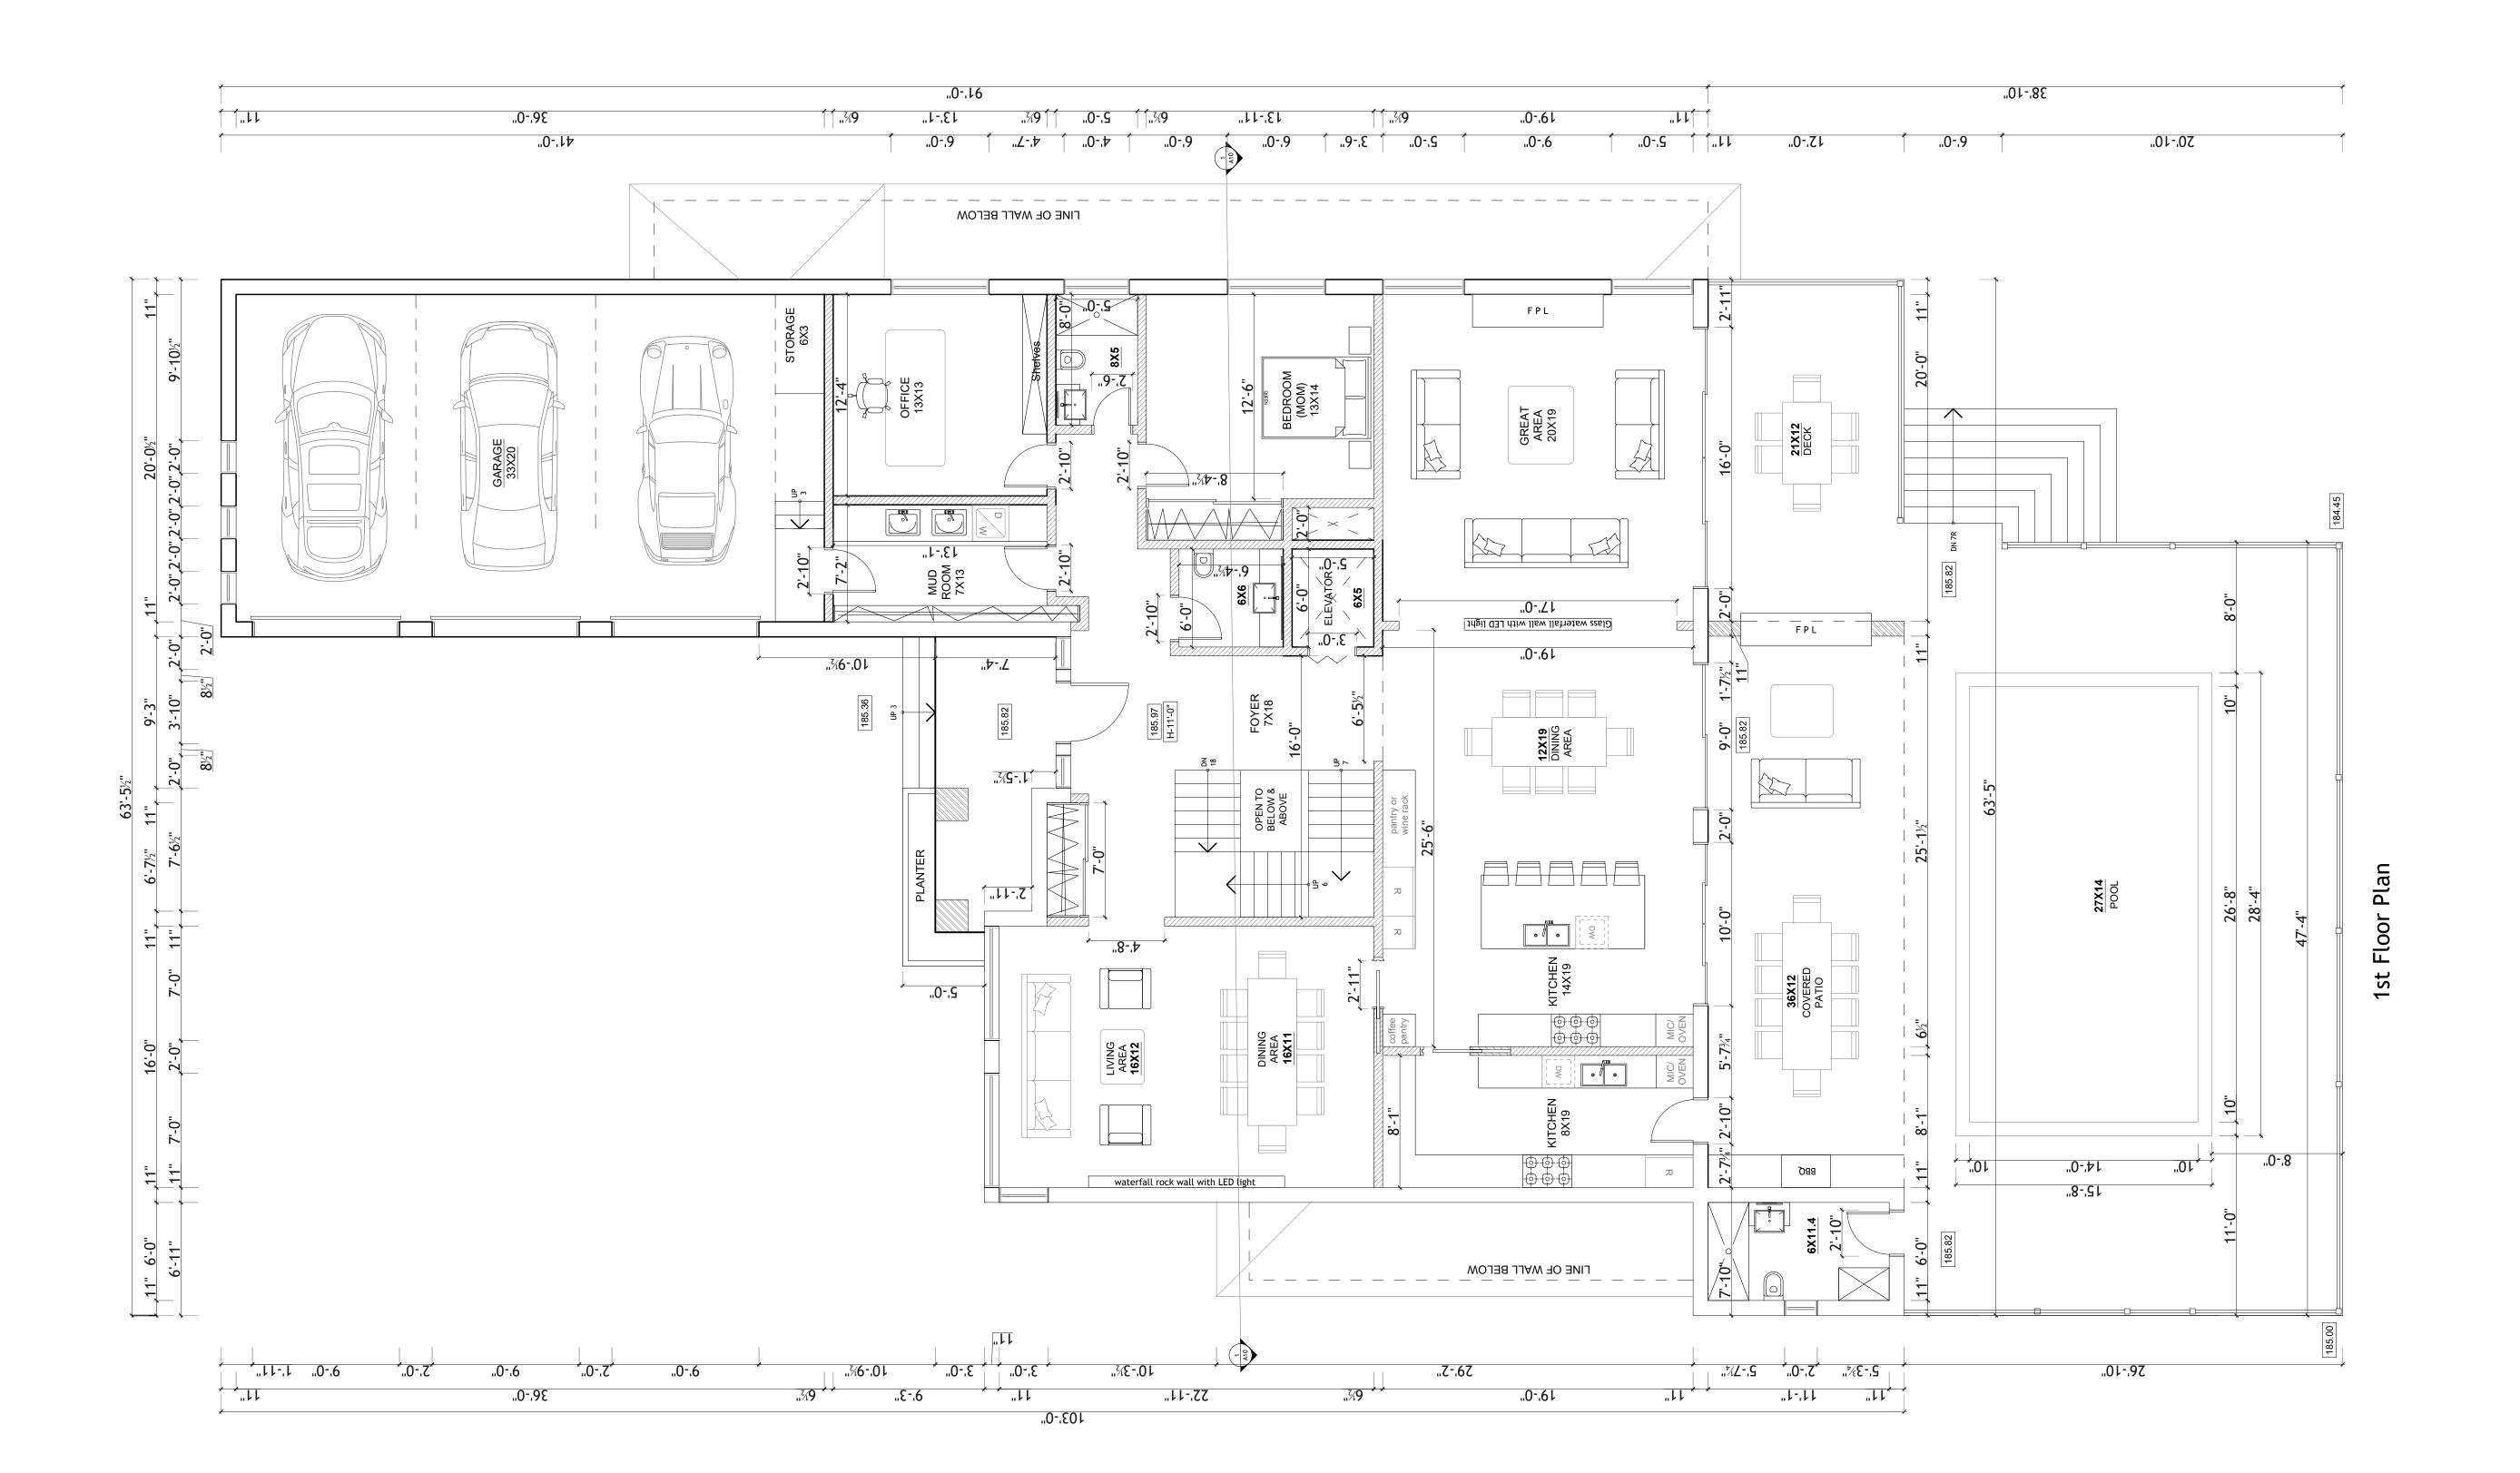
PROJECT NAME: **New Custom House** 

PROJECT ADDRESS: 2035 Embleton Rd. Brampton, ON. L6Y 0E9

BASEMENT PLAN

DESIGN BY:	RH	
DRAWN BY:	JT	DRAWING №:
CHECKED BY:	AG	
SCALE:	3/16" = 1'-0"	Δ1
DATE:	2024/12/28	
PROJECT №:	24-699	

SIZE: ARCH D 36"X24"





RAL NOTES

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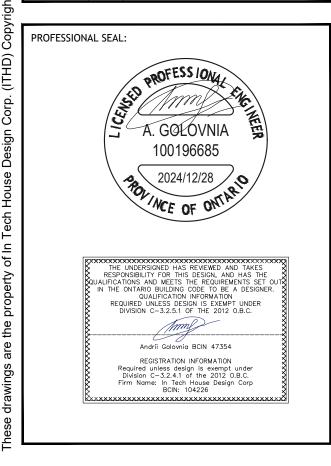
REVISIONS AND ISSUES

2024/12/28 3 REVISED PER CITY COMMENTS
2024/11/07 2 REVISED PER CITY COMMENTS

DESCRIPTION

2024/09/25 1 ISSUED FOR CVC PERMIT

DATE #



PROJECT NAME:

New Custom House

PROJECT ADDRESS:

2035 Embleton Rd.
Brampton, ON. L6Y 0E9

SHEET TITLE:

FIRST FLOOR PLAN

DESIGN BY: RH

DRAWN BY: JT

CHECKED BY: AG

SCALE: ###########


DATE: 2024/12/28

PROJECT №: 24-699

DRAWING №:

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SIZE: ARCH D 36"X24"

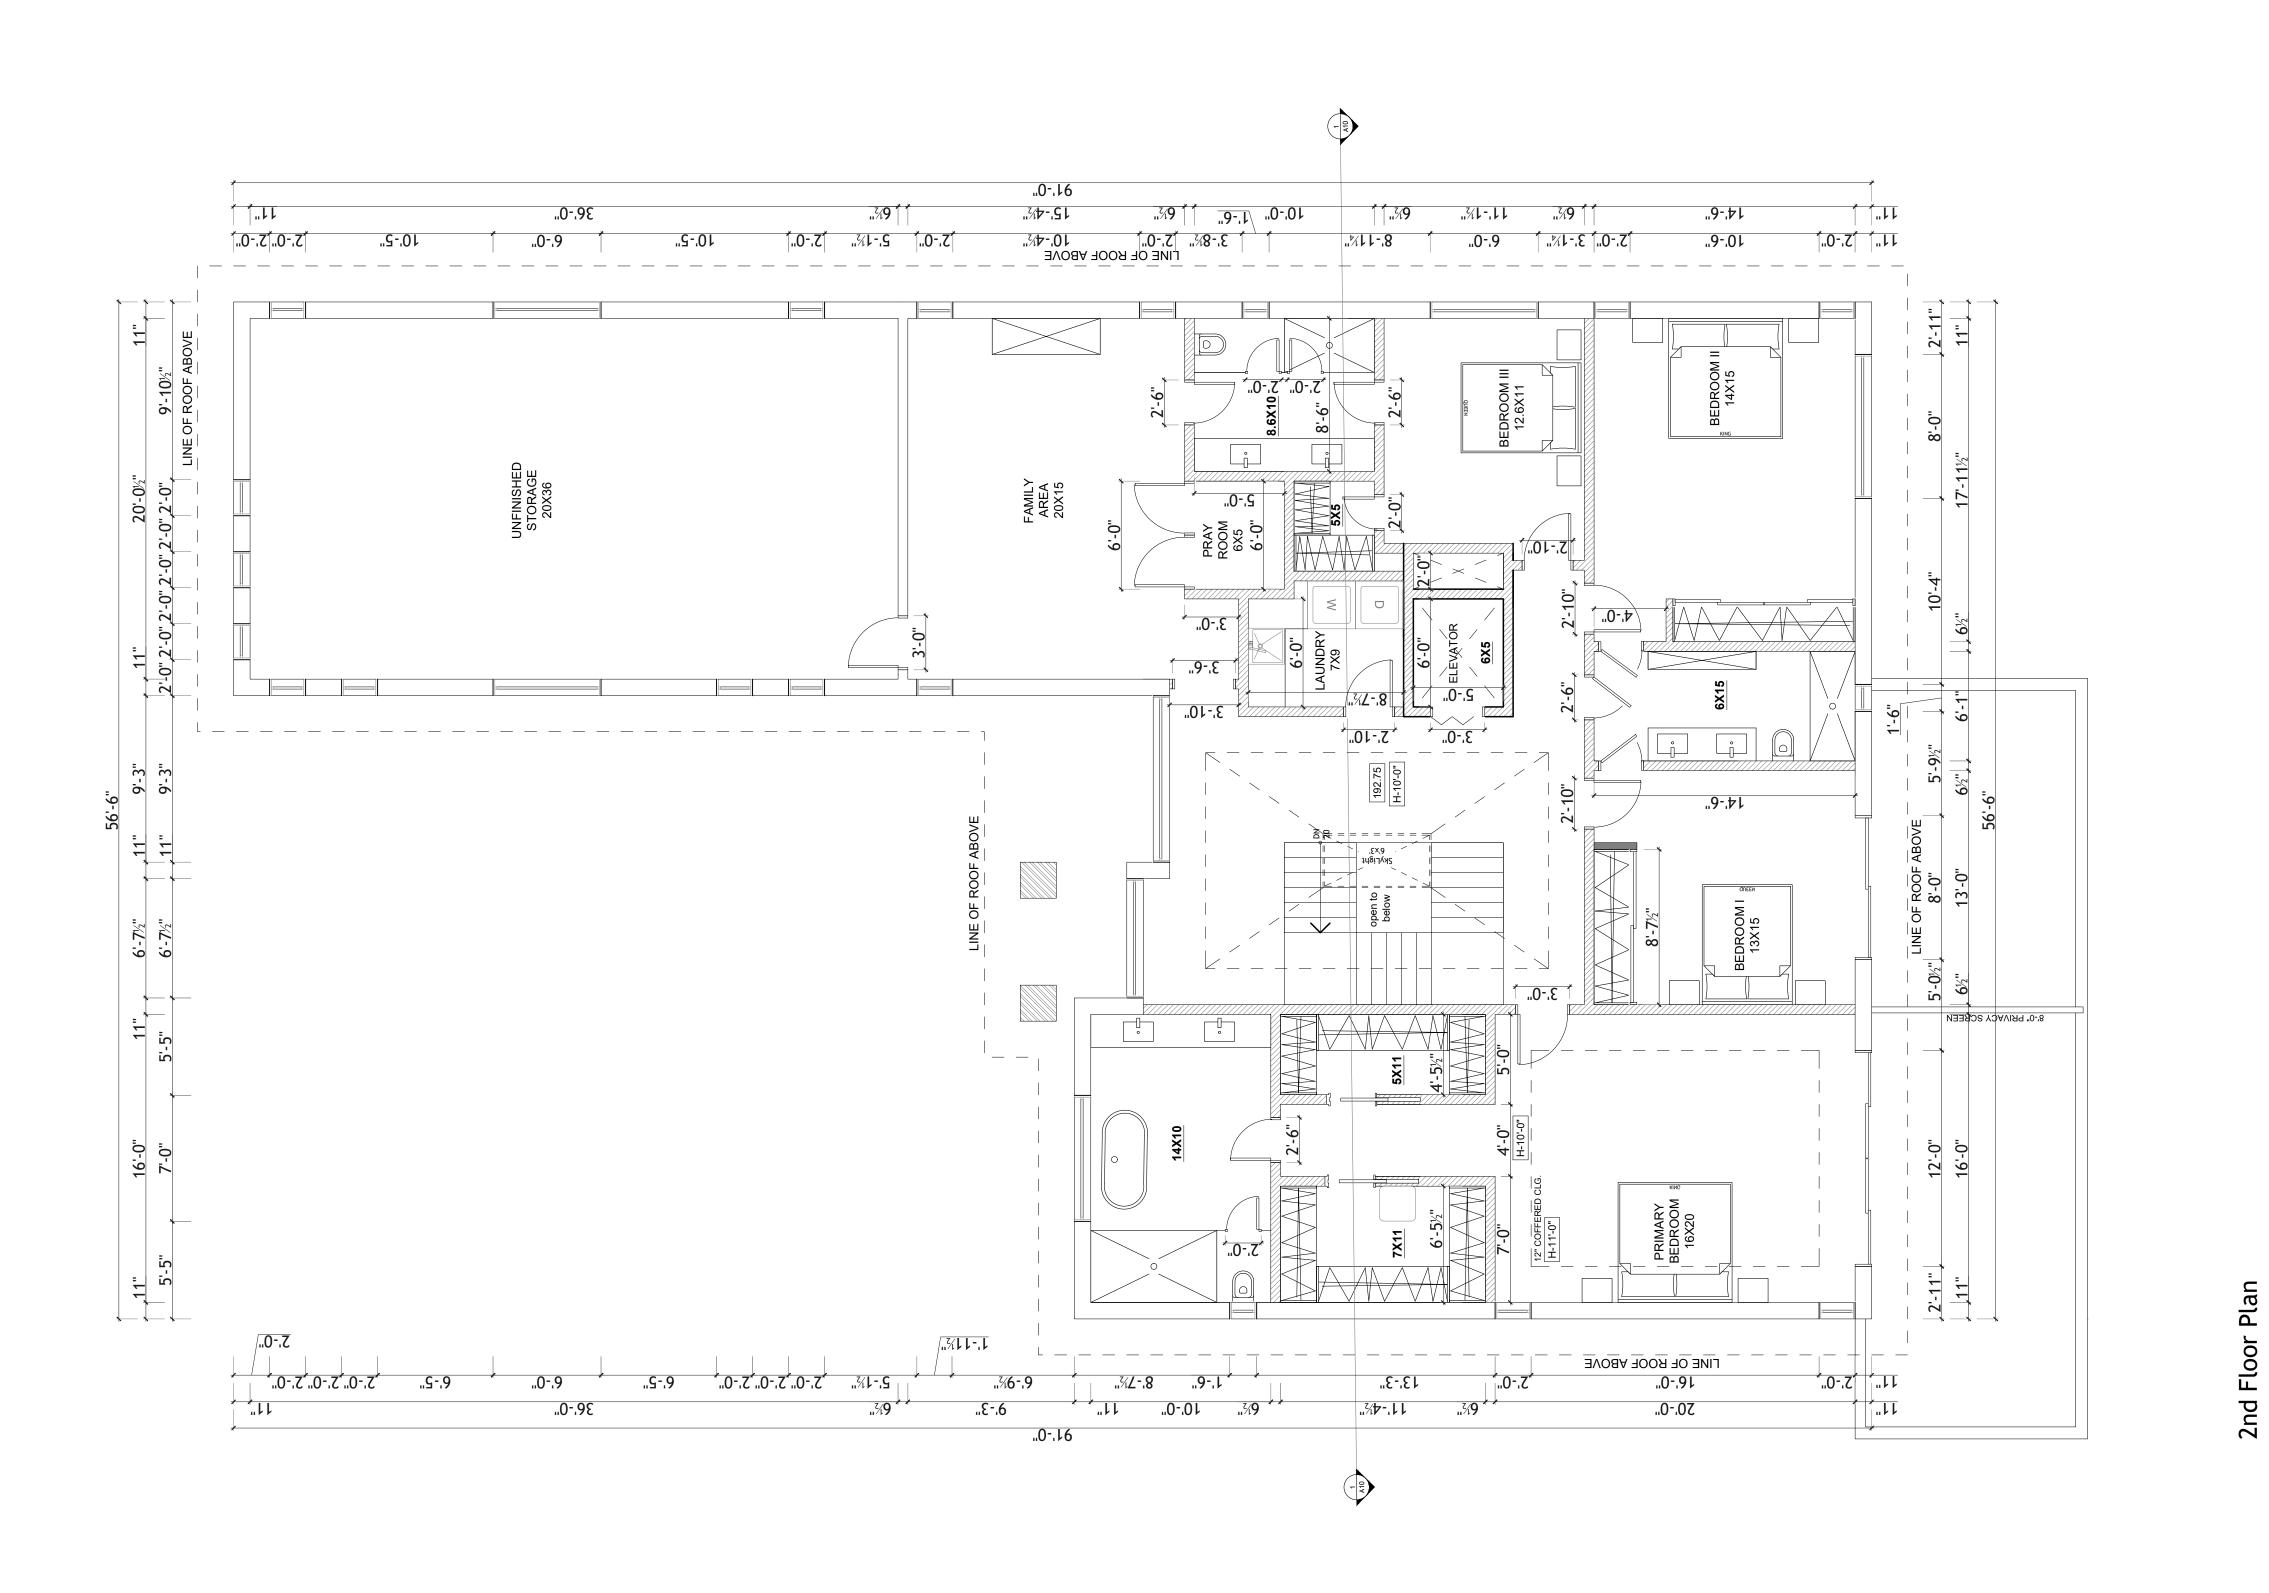

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DESCRIPTION

PROFESSIONAL SEAL:

A. GOLOVNIA 2024/12/28

Andrii Golovnia BCIN 47354 REGISTRATION INFORMATION
Required unless design is exempt under
Division C-3.2.4.1 of the 2012 O.B.C.
Firm Name: In Tech House Design Corp
BCIN: 104226

PROJECT NAME:

**New Custom House** 

PROJECT ADDRESS:

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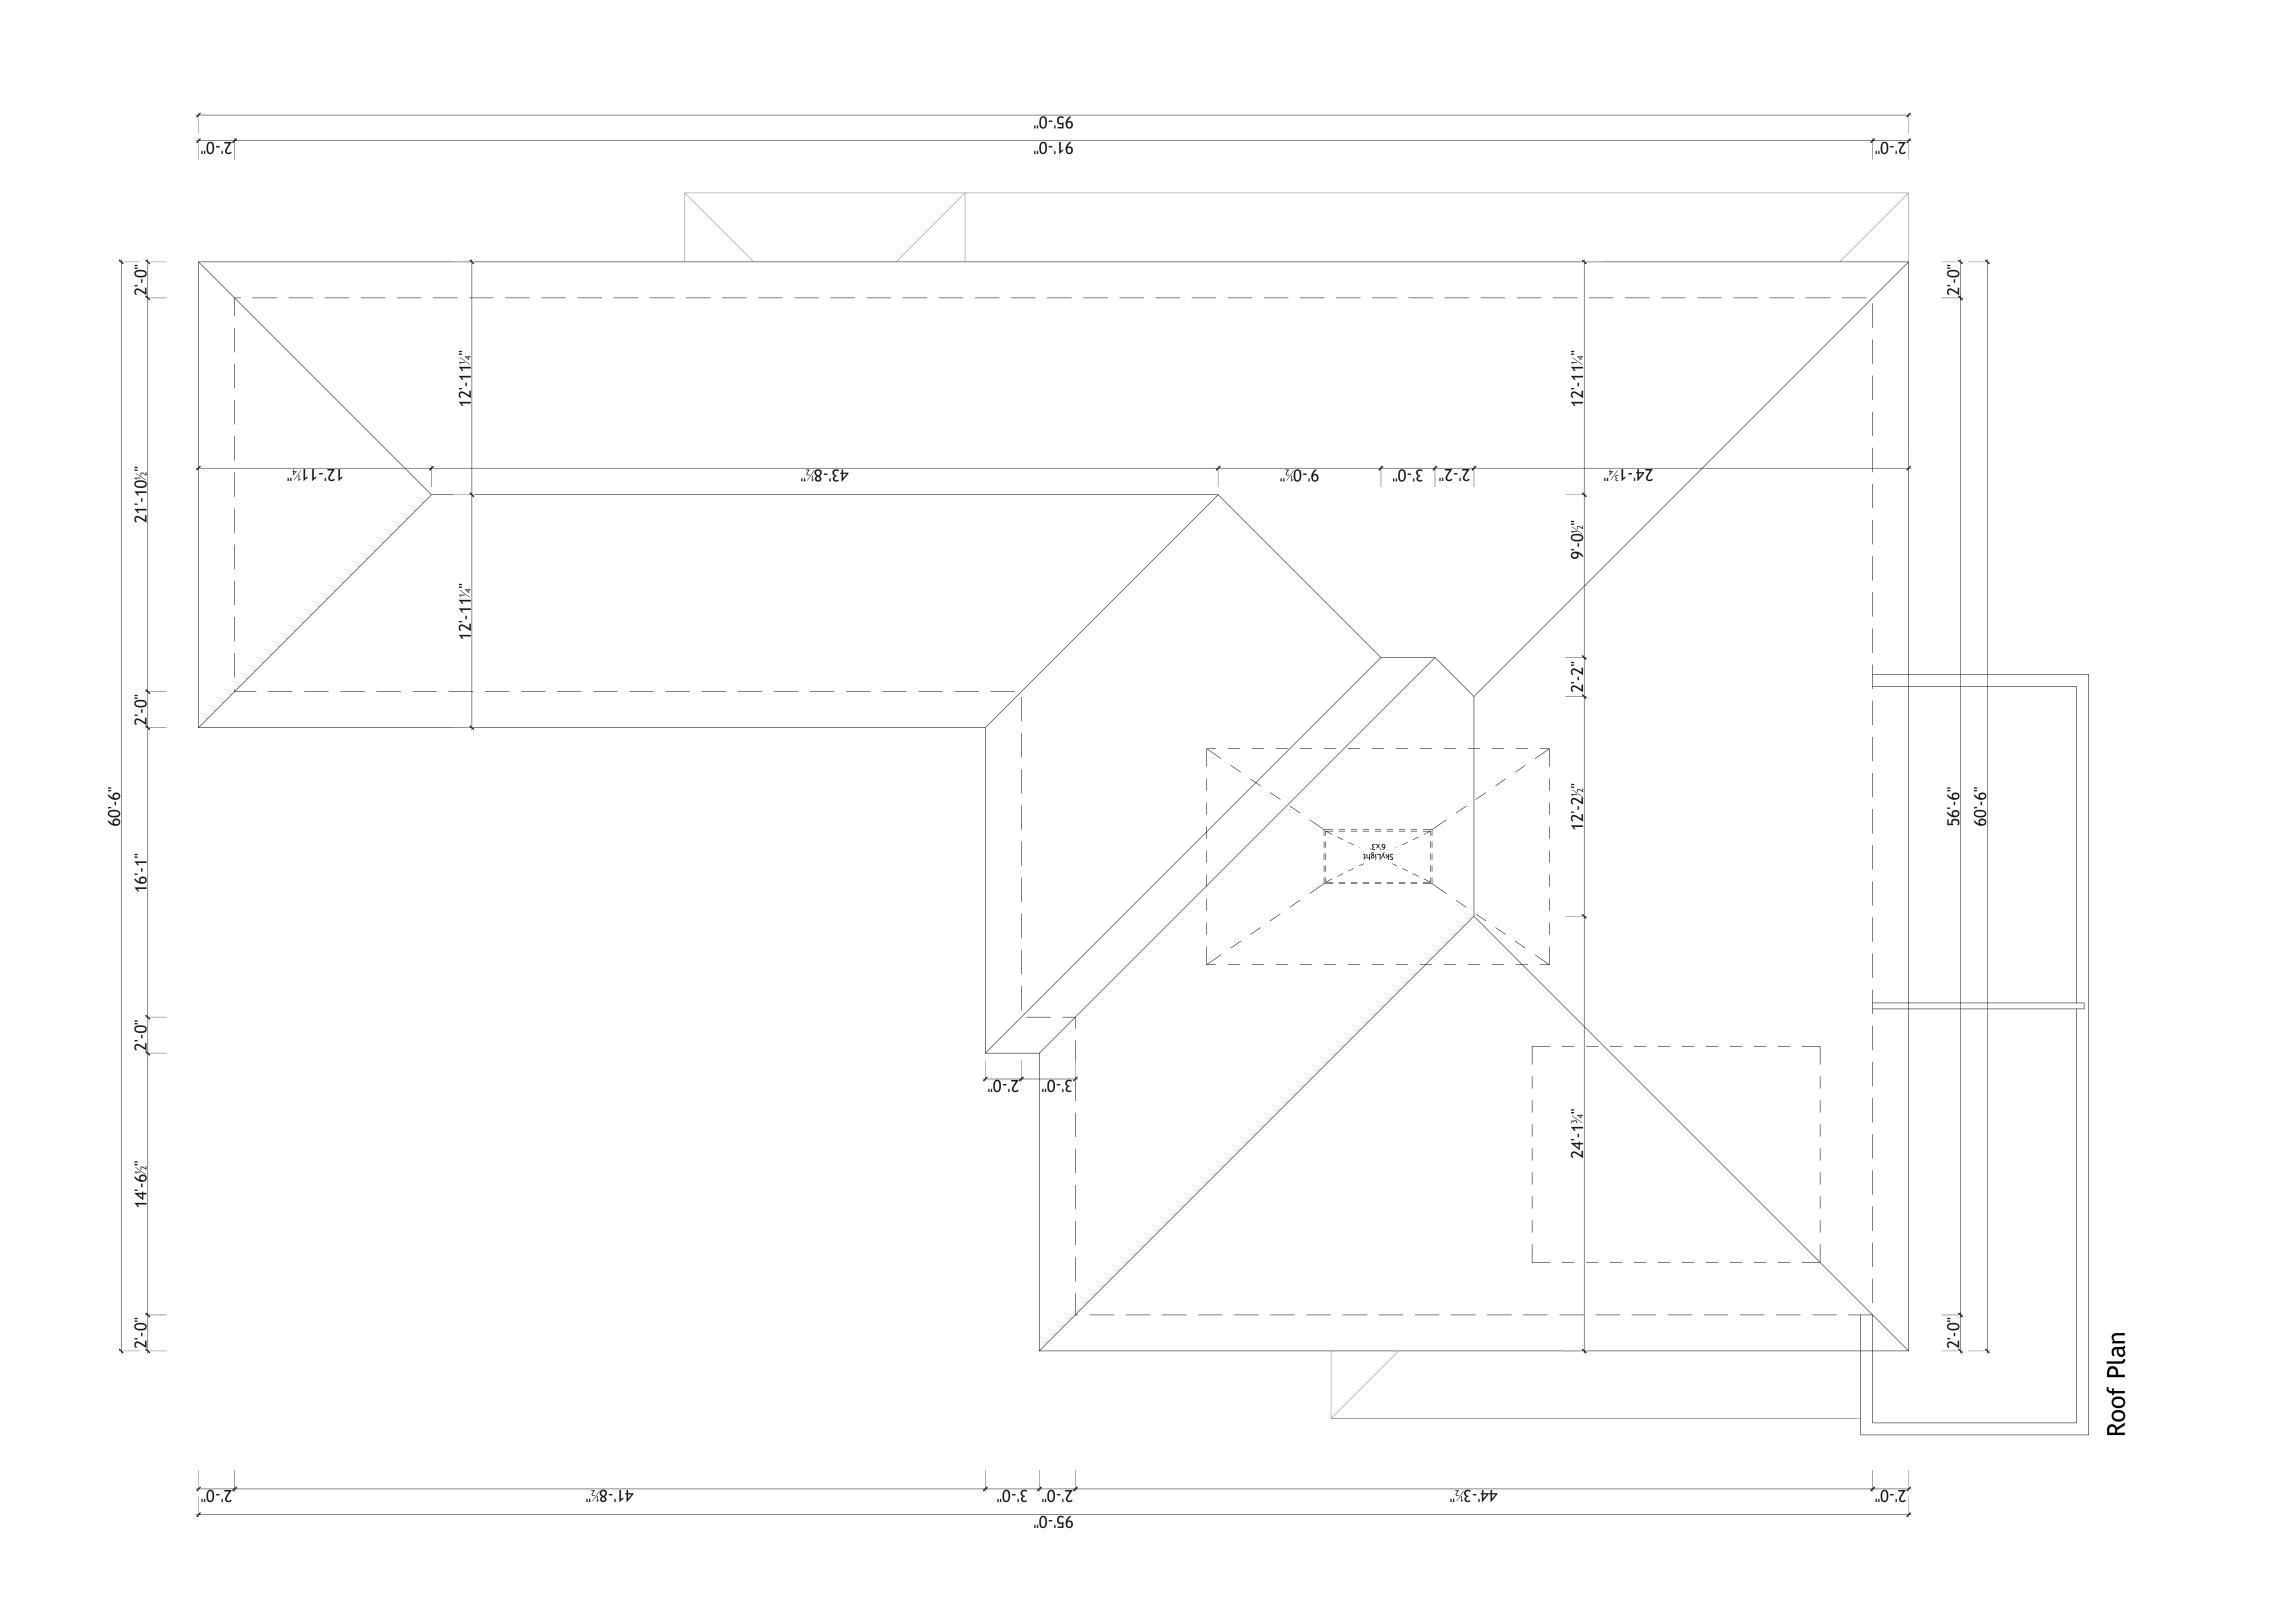
SECOND FLOOR PLAN

DESIGN BY: DRAWN BY: CHECKED BY: SCALE: ############# DATE: 2024/12/28

PROJECT №: 24-699

DRAWING №:

SIZE: ARCH D 36"X24"





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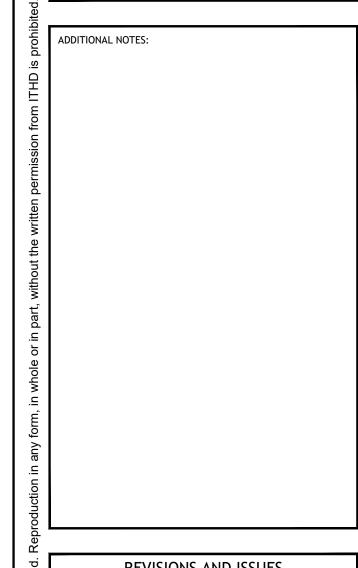
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PROFESSIONAL SEAL: THE UNDERSIGNED HAS REVIEWED AND TAKES
RESPONSIBILITY FOR THIS DESIGN, AND HAS THE
QUALIFICATIONS AND MEETS THE REQUIREMENTS SET
IN THE ONTARIO BUILDING CODE TO BE A DESIGNER
QUALIFICATION INFORMATION
REQUIRED UNLESS DESIGN IS EXEMPT UNDER
DIVISION C-3.2.5.1 OF THE 2012 O.B.C.

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Firm Name: In Tech House Design Corp
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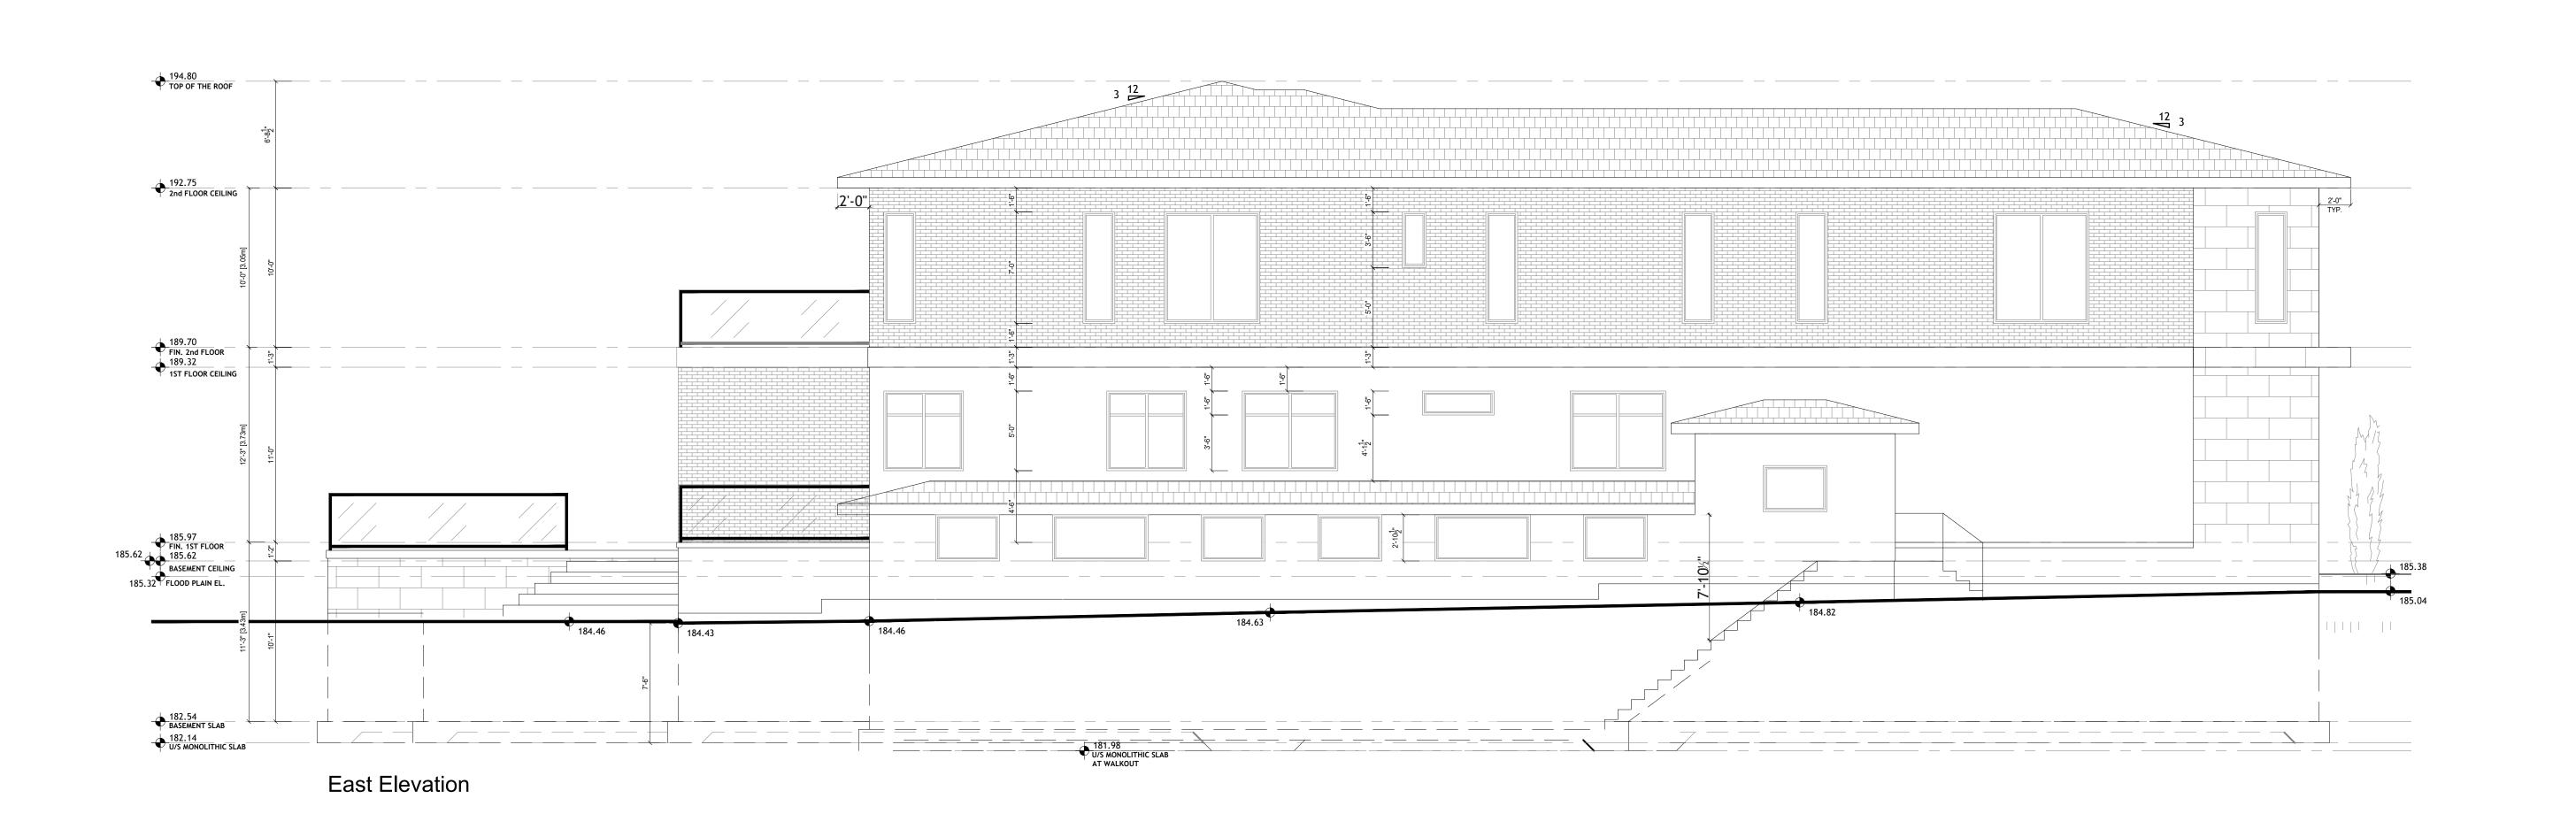
PROJECT NAME: **New Custom House** 

PROJECT ADDRESS: 2035 Embleton Rd. Brampton, ON. L6Y 0E9

**ROOF PLAN** 

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PROJECT №:	24-6

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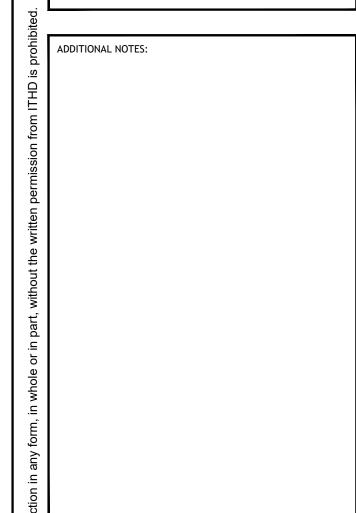





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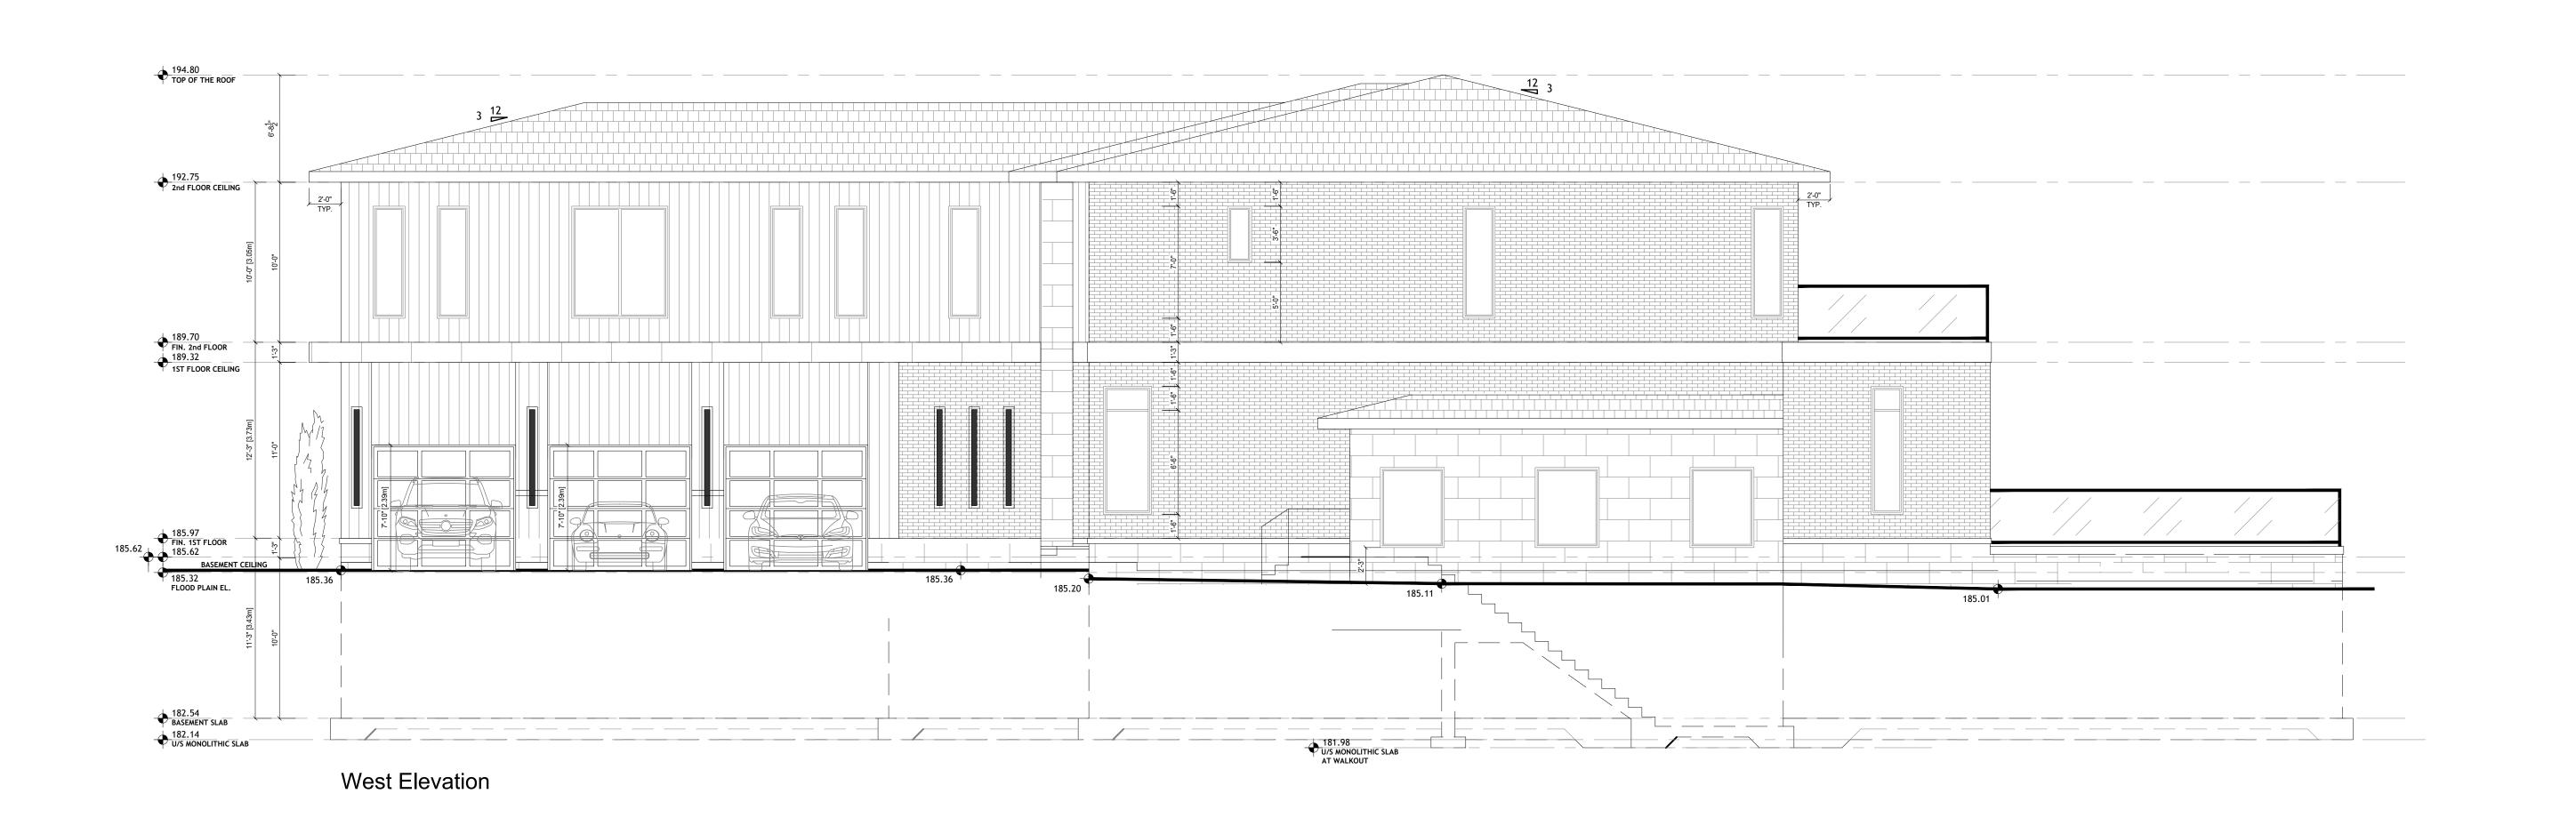
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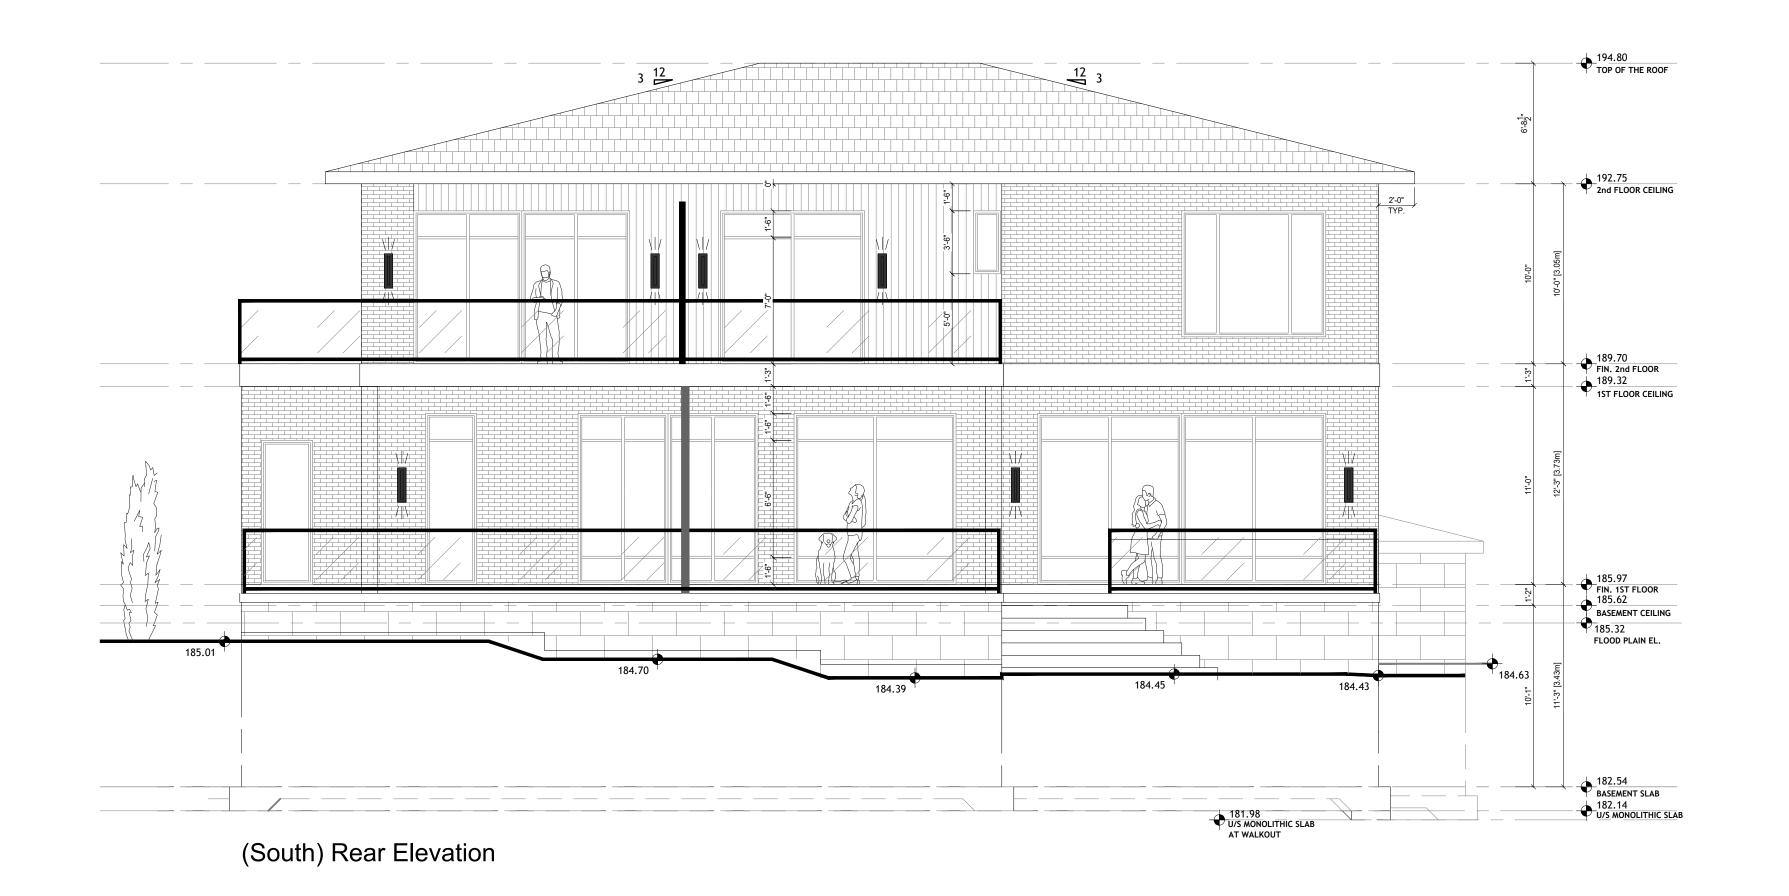
PROJECT ADDRESS: 2035 Embleton Rd. Brampton, ON. L6Y 0E9

FRONT & LEFT ELEVATIONS

DESIGN BY:	RH
DRAWN BY:	JT
CHECKED BY:	AG
SCALE:	3/16" = 1'-0"
DATE:	2024/12/28
PROJECT №:	24-699

DRAWING №:



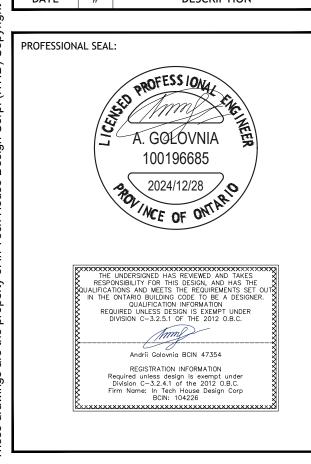



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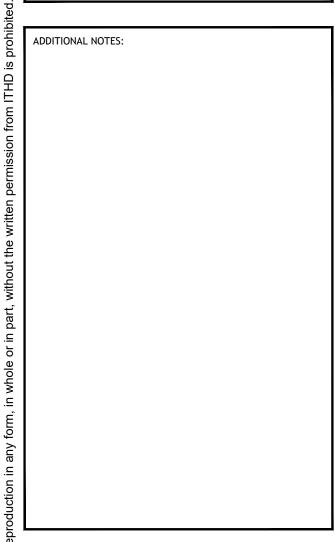
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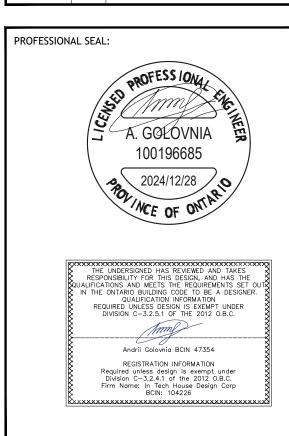
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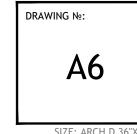





PROJECT ADDRESS: 2035 Embleton Rd. Brampton, ON. L6Y 0E9

REAR & RIGHT ELEVATIONS

DESIGN BY:	RH
DRAWN BY:	JT
CHECKED BY:	AG
SCALE:	3/16" = 1'-0"
DATE:	2024/12/28
PROJECT №:	24-699



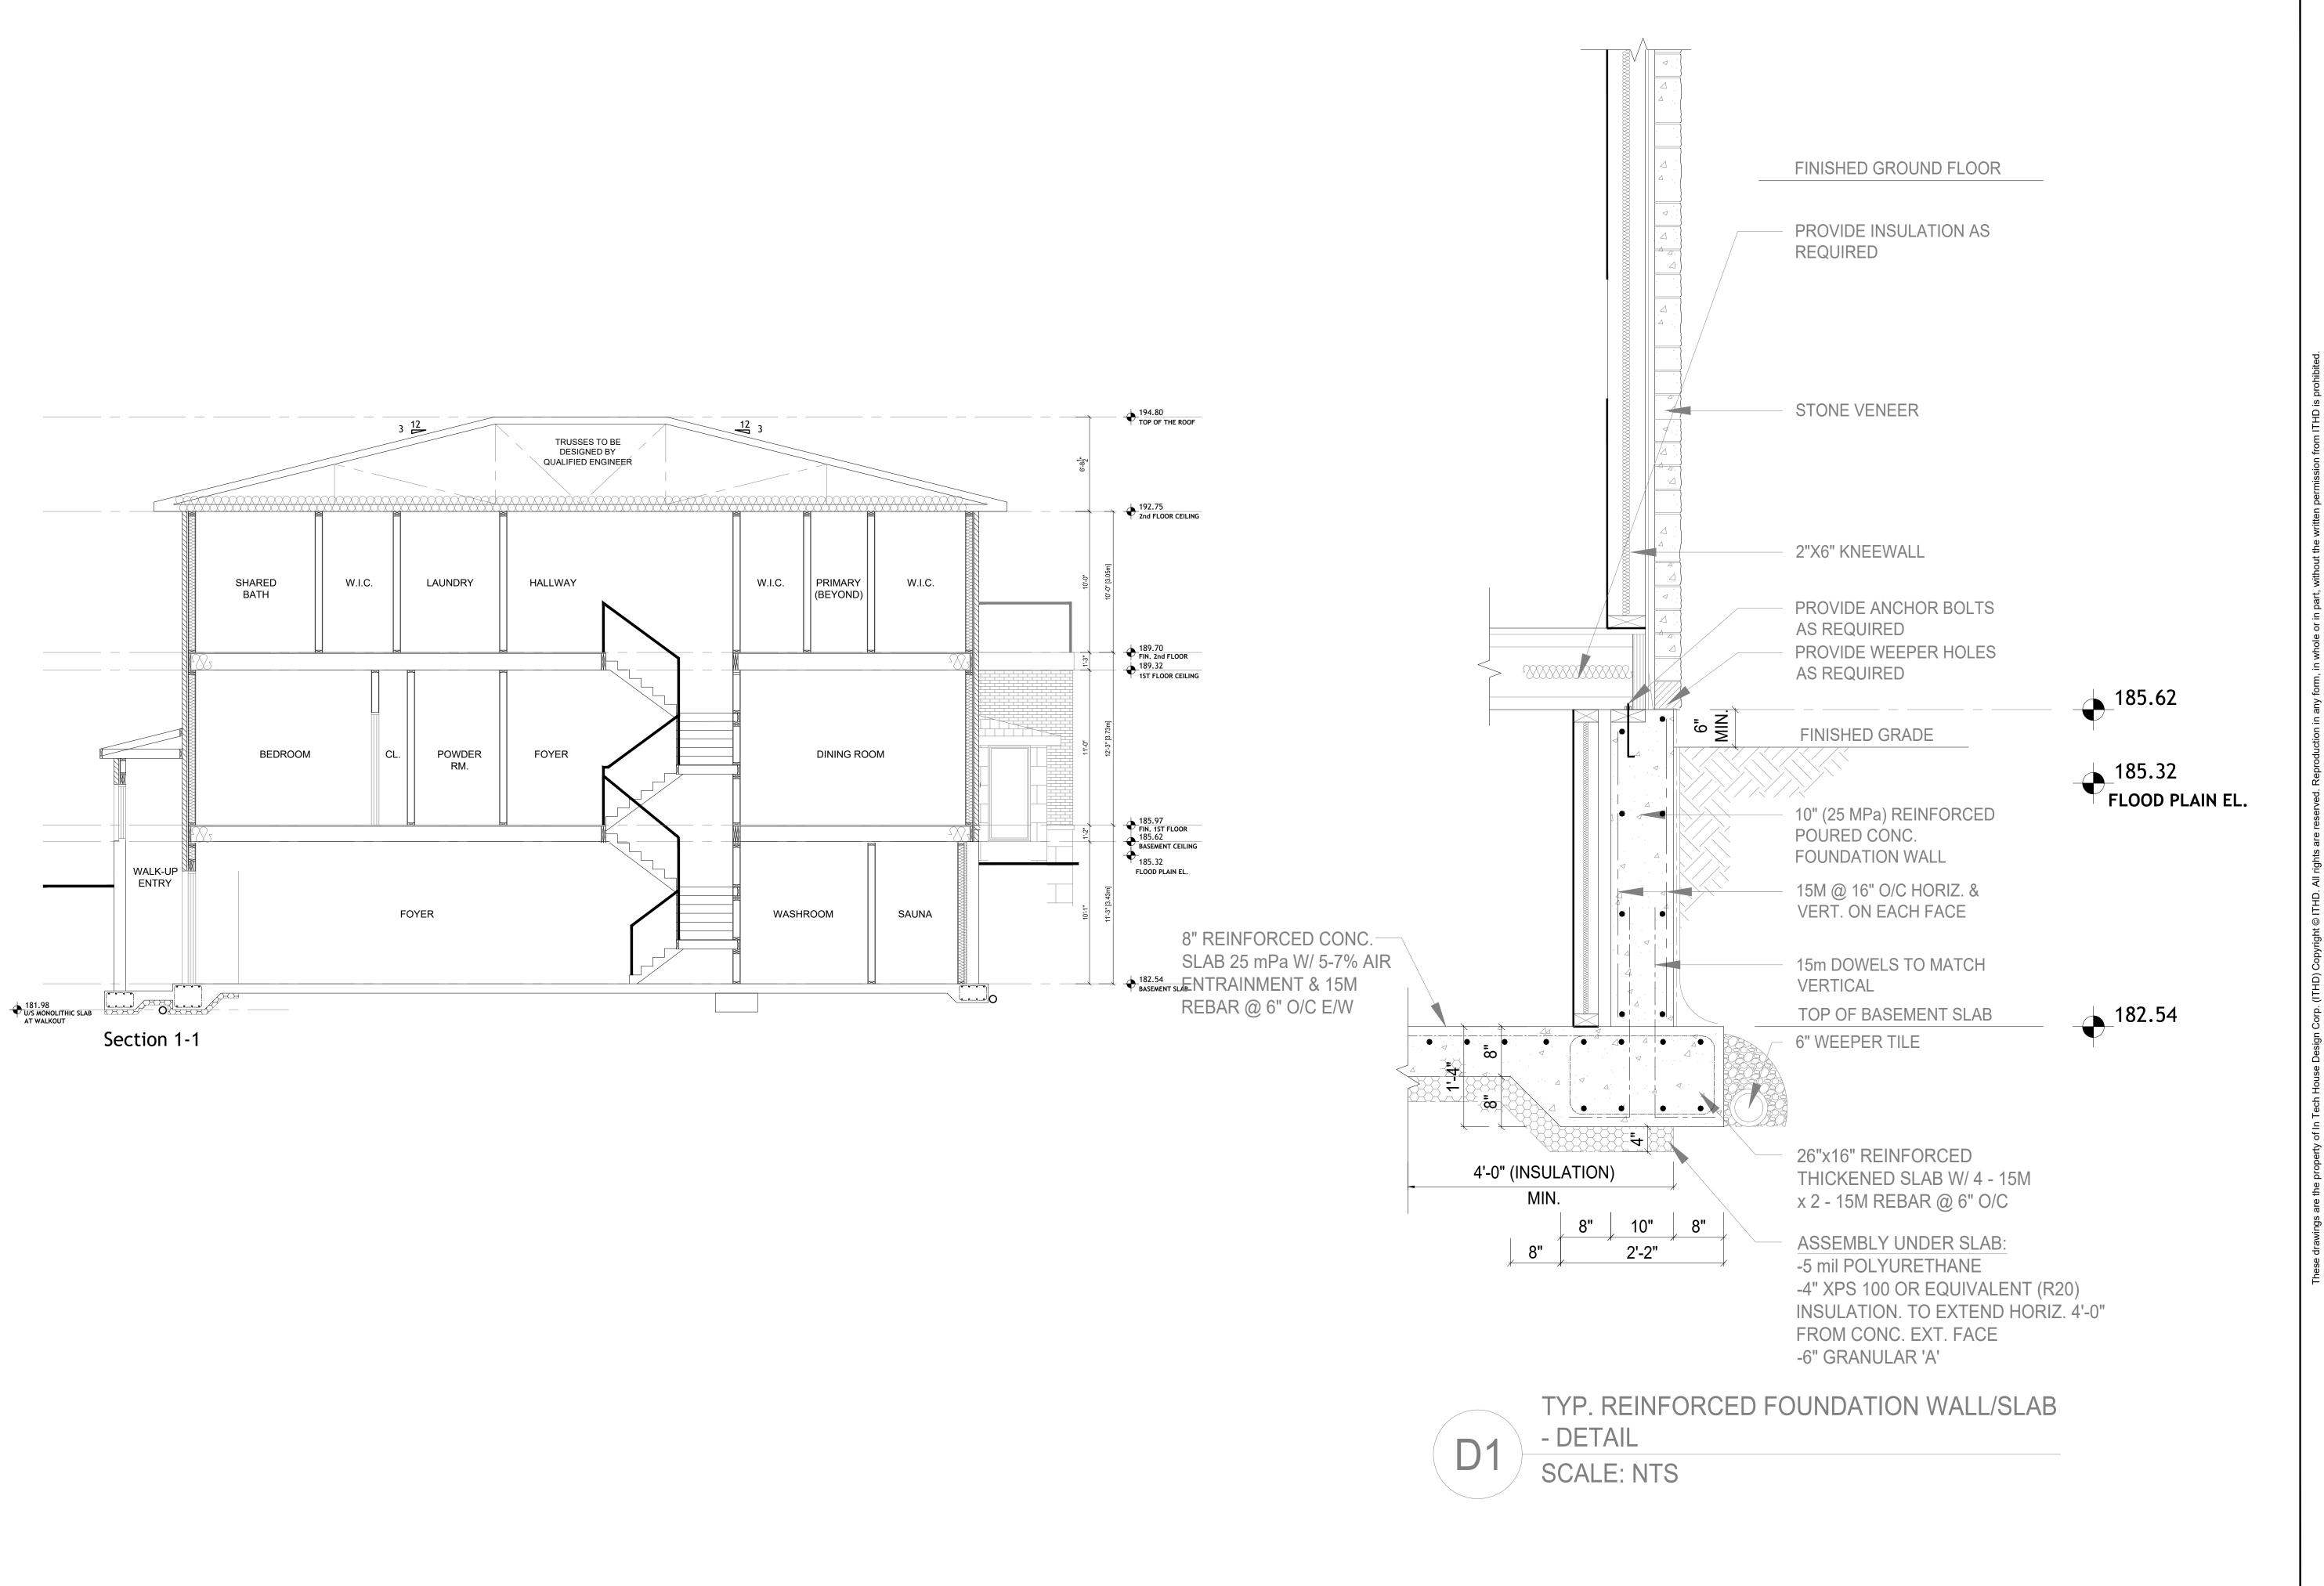



GENERAL NOTES

DO NOT SCALE DRAWINGS

THE CONTRACTOR SHALL VERIFY ALL DIMENSIONS AT THE SITE AND REPORT ANY DISCREPANCIES TO THE CONSULTANT BEFORE PROCEEDING WITH WORK

ALL WORKS IS TO BE CARRIED OUT ACCORDING TO THE ONTARIO BUILDING CODE 2012 AND BY-LAWS


ALL EXISTING SURFACES AND STRUCTURES ADJACENT TO THE PROPOSED WORK ARE TO BE PROTECTED DURING DEMOLITION AND CONSTRUCTION

THE CONTRACTOR AND/OR THE OWNER SHALL BE RESPONSIBLE FOR THE ARRANGEMENT OF ALL NECESSARY INSPECTIONS AND FOLLOW INSPECTION SCHEDULES


ALL TEMPORARY WORKS INCLUDING SHORING ARE TO BE PROVIDED

READ THIS DRAWING IN CONJUNCTION WITH OTHER DRAWINGS: ARCHITECT, STRUCTURAL, MECHANICAL, ELECTRICAL AND OTHER RELEVANT DRAWINGS AND SPECIFICATIONS

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	REV	ISIONS AND ISSUES
2024/12/28	3	REVISED PER CITY COMMENTS
2024/11/07	2	REVISED PER CITY COMMENTS
2024/09/25	1	ISSUED FOR CVC PERMIT
DATE	#	DESCRIPTION
	2024/09/25	2024/12/28 3 2024/11/07 2 2024/09/25 1

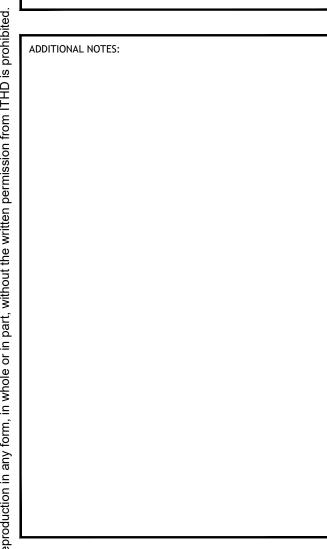



PROJECT NAME: **New Custom House** PROJECT ADDRESS: 2035 Embleton Rd. Brampton, ON. L6Y 0E9

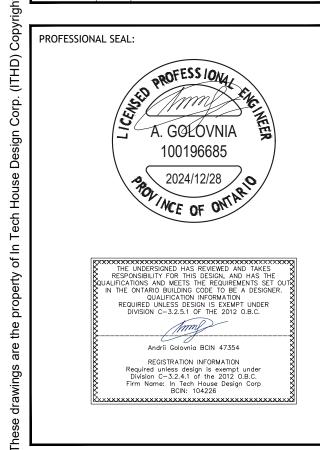
SECTION '1-1' & DETAIL


CHECKED BY: 2024/12/28 PROJECT №:

DRAWING №: SIZE: ARCH D 36"X24"

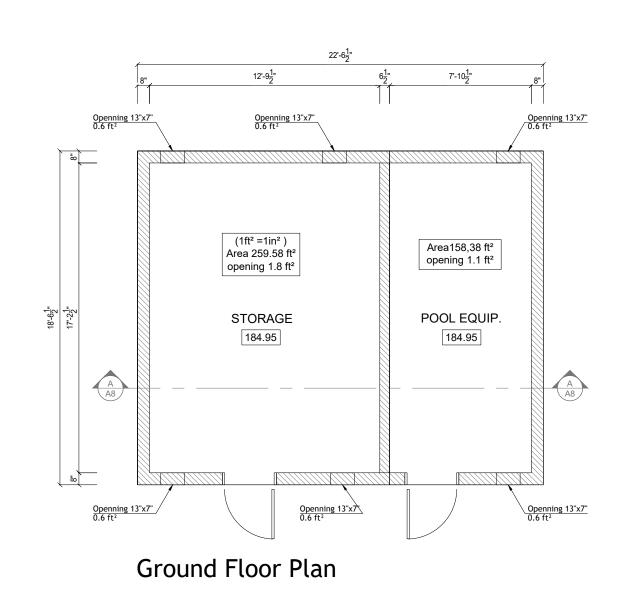


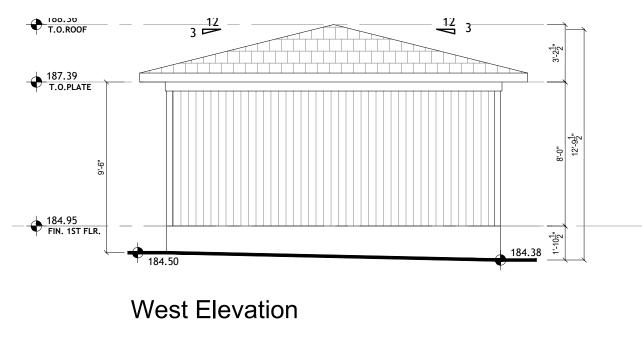


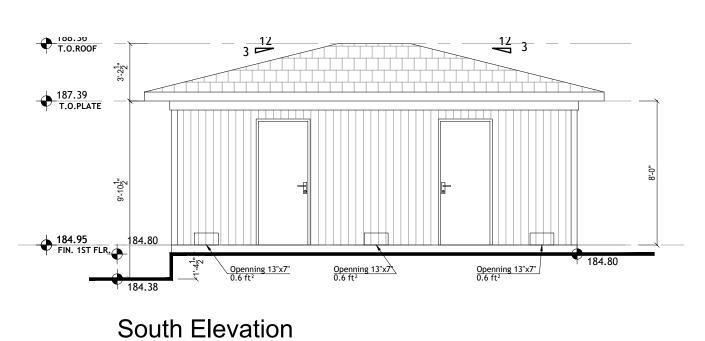

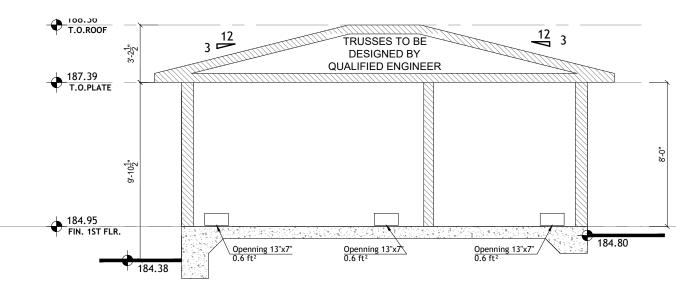


Section A-A

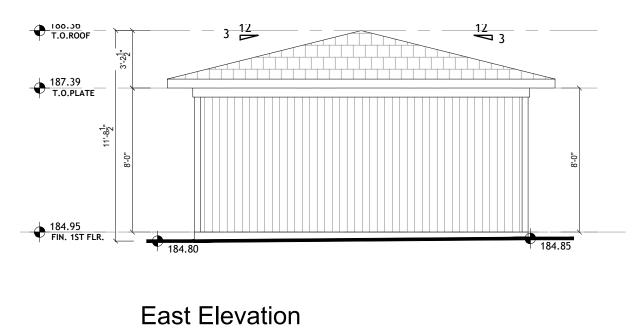

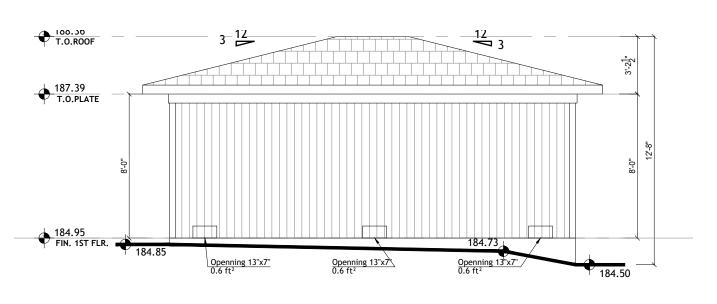

North Elevation

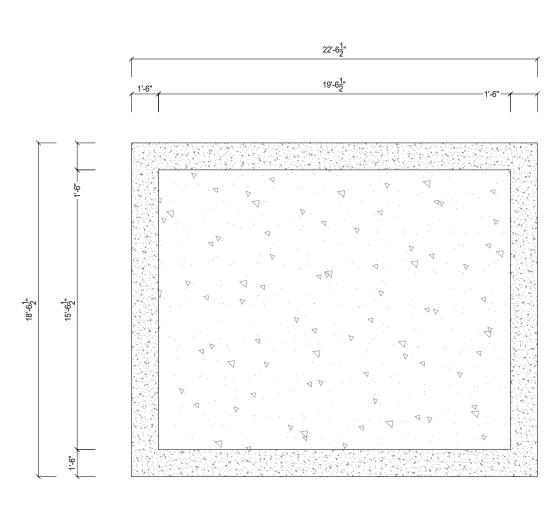

Footing Plan



GENERAL NOTES

Toll free: +1(885)561-4161

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info@ithd.ca

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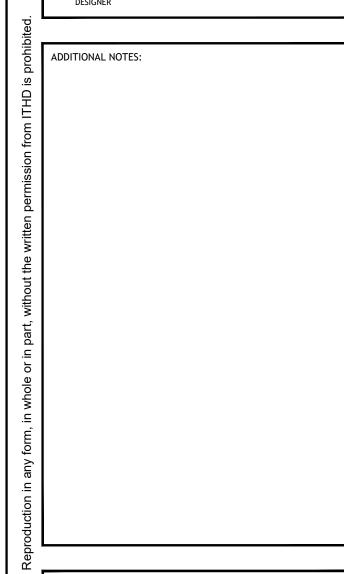
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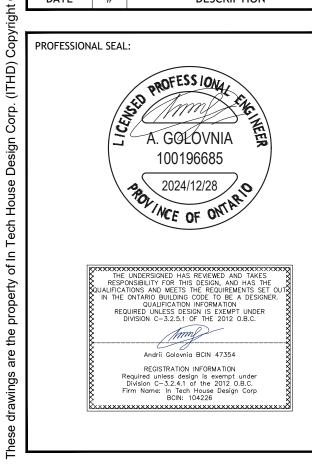
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I rig	2024/12/28	3	REVISED PER CITY COMMENTS
). Al	2024/11/07	2	REVISED PER CITY COMMENTS
Ϊ	2024/09/25	1	ISSUED FOR CVC PERMIT
0	DATE	#	DESCRIPTION



PROJECT NAME: New Custom House

PROJECT ADDRESS:

2035 Embleton Rd. Brampton, ON. L6Y 0E9

STORAGE HOUSE PLAN & **ELEVATIONS & SECTION A-A** 

DESIGN BY:	RH
DRAWN BY:	JT
CHECKED BY:	AG
SCALE:	3/16" = 1'-0"
DATE:	2024/12/28
PROJECT №:	24-699

DRAWING №:



Project Name:


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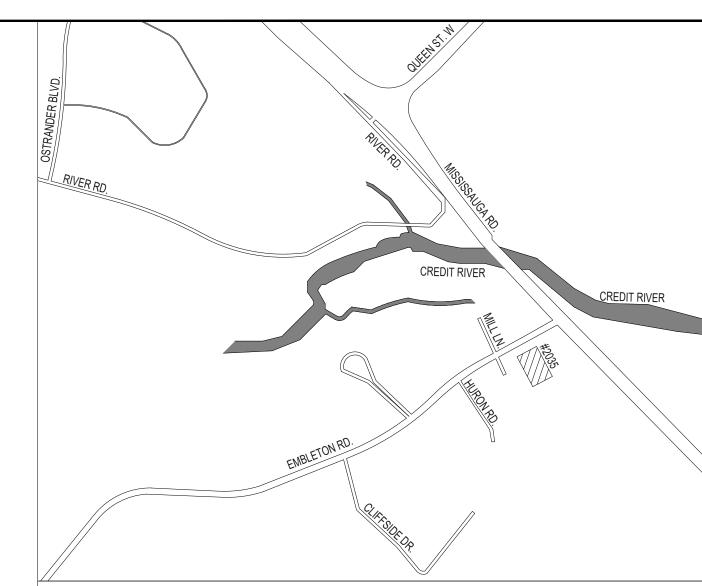
NEW CUSTOM HOUSE

2035 Embleton Rd., Brampton ON., L6Y 0E9

In Tech House Design Corporation 2275 Lake Shore Blvd. West Suite 224, Toronto, ON M8V3Y3 www.ithd.ca, info@ithd.ca +1(647)478-5055





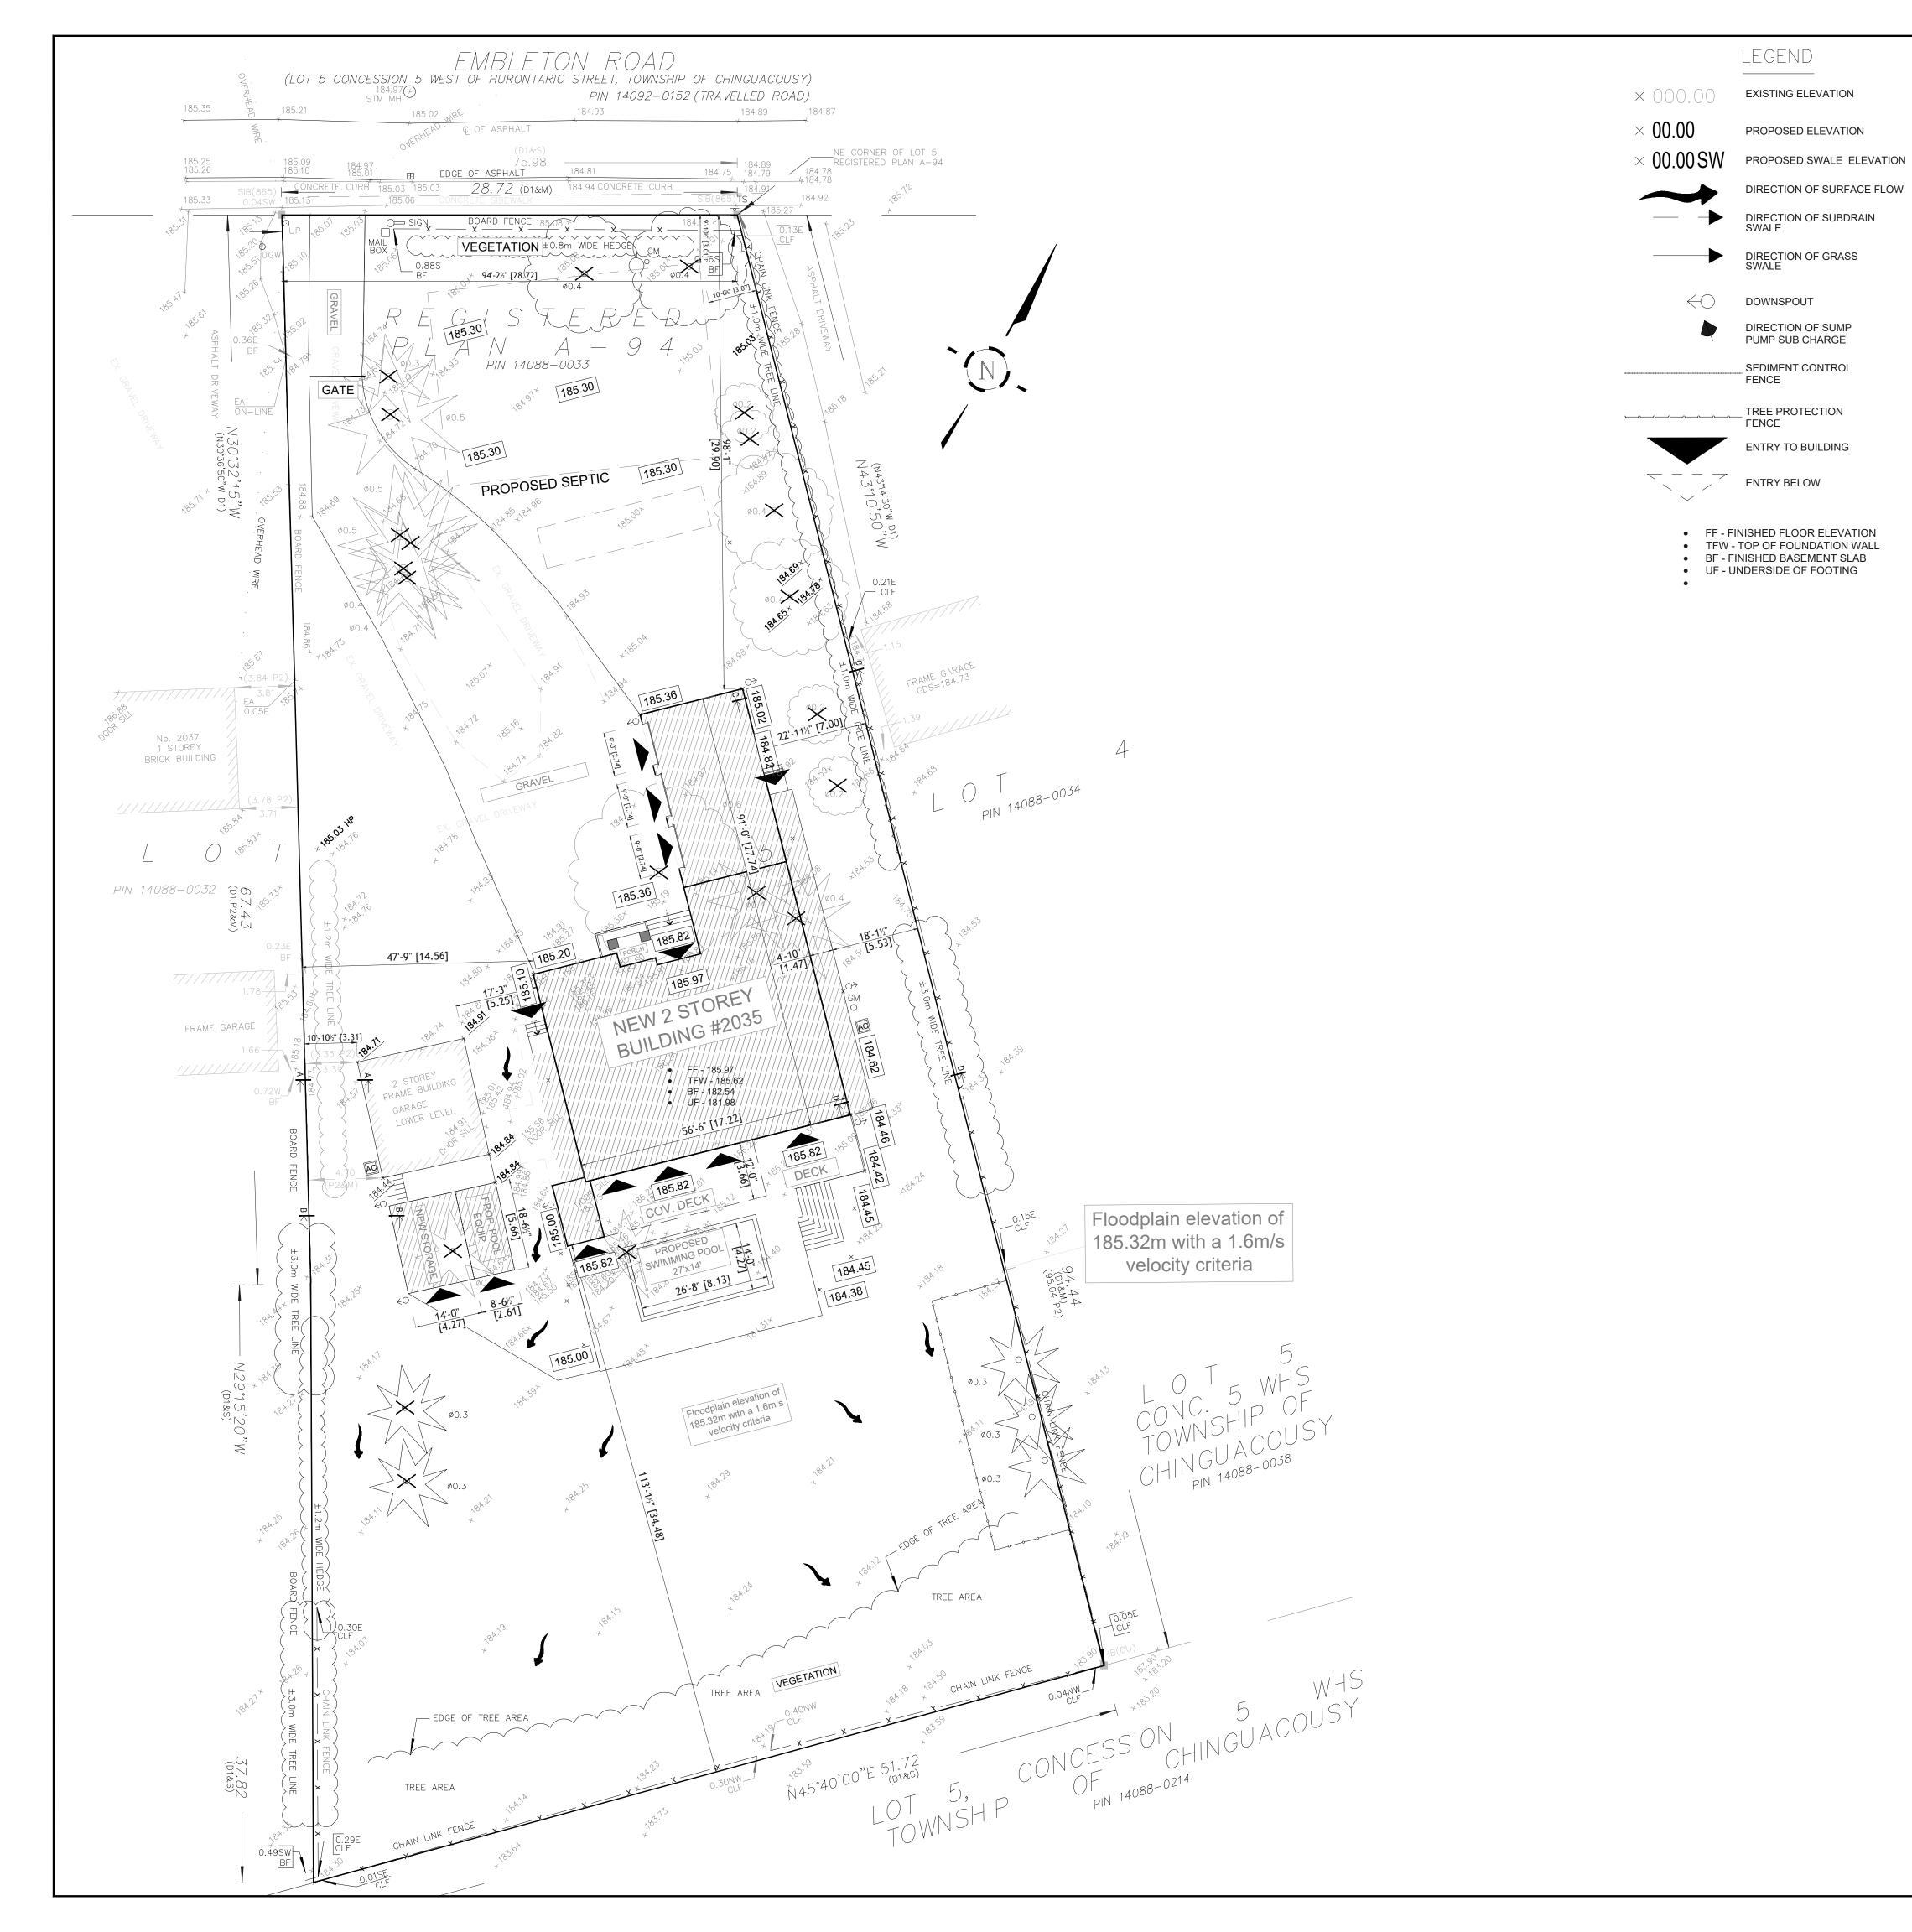

KEYPLAN: 2035 EMBLETON RD. ON. L6Y 0E9 SCALE: NTS

RD(f12.0;a370)(x1463)	REQU	IRED	PROPOSED	
	SQ.FT	m²	SQ.FT	m²
LOT AREA			42235.75	3923.8
EX. BUILDING AREA			553.59	51.43
NEW BUILDING AREA			4002.85	371.8
NEW STORAGE AREA			259.45	24.10
NEW POOL EQUIPMENT AREA			158.50	14.73
LOT COVERAGE				11.
G	ROSS FLOOR		00.57	
FIRST FLOOR	SQ.FT	m²	SQ.FT 2754.50	m² 255.9
SECOND FLOOR	<u> </u>	-	2654.16	246.5
OLOGINE I LOGIN			2004.10	240.0
TOTAL G.F.A.	-	-	5408.66	502.4
FINISHED BASEMENT	-	-	2635.03	244.8
	FT	m	FT	m
AVERAGE ESTABLISH GRADE NORTH (FRONT)				185
BUILDING HEIGHT NORTH (FRONT)		10.60	30'-11 ½"	9.43
,				
AVERAGE ESTABLISH GRADE SOUTH (REAR)				185
BUILDING HEIGHT SOUTH (REAR)		10.60	30'-11 1/4"	9.43
AVERAGE ESTABLISH GRADE EAST SIDE				185
BUILDING HEIGHT EAST SIDE		10.60	30'-11 1/4"	9.43
AVERAGE ESTABLISH GRADE WEST SIDE				185
BUILDING HEIGHT WEST		10.60	30'-11 ½"	9.43
SIDE		10.00	00-11/4	0.40
BUILDING LENGTH			103'-0"	31
BUILDING DEPTH			103'-0"	31
LOT FRONTAGE			94'-2 ½"	28
	SETBACK	S		
	FT	m	FT	m
FRONT		12.00	98'-1"	29.90
			440' 4""	2/1/0
REAR		7.50	113'-1 ½"	
REAR WEST SIDE		7.50	47'-9"	14.56
REAR	LANDSCAPI	7.50 15		14.56
REAR WEST SIDE	LANDSCAPI REQU	7.50 15 NG	47'-9"	14.56 5.53
REAR WEST SIDE EAST SIDE		7.50 15 NG	47'-9" 18'-1 ½"	14.56 5.53
REAR WEST SIDE	REQU	7.50 15 NG IRED	47'-9" 18'-1 ½" PROPO	14.56 5.53 SED m²
REAR WEST SIDE EAST SIDE FRONT YARD LANDSCAPING	REQU	7.50 15 NG IRED	47'-9" 18'-1 ½" PROPO SQ.FT	14.56 5.53 SED m <sup>2</sup> 1399.2
REAR WEST SIDE EAST SIDE FRONT YARD LANDSCAPING AREA	REQU	7.50 15 NG IRED m²	47'-9" 18'-1½" PROPO SQ.FT 15061.99	14.50 5.53 SED m² 1399.3 989.5 419.7
REAR WEST SIDE EAST SIDE FRONT YARD LANDSCAPING AREA SOFT LANDSCAPE AREA	REQU SQ.FT	7.50 15 NG IRED	47'-9" 18'-1 ½" PROPO SQ.FT 15061.99 10543.56	14.56 5.53 SED m² 1399.2 989.5 419.7
REAR WEST SIDE EAST SIDE  FRONT YARD LANDSCAPING AREA SOFT LANDSCAPE AREA HARD LANDSCAPE AREA REAR YARD AREA BREAK DOWN	REQU SQ.FT	7.50 15 NG IRED m²	47'-9" 18'-1 ½" PROPO SQ.FT 15061.99 10543.56 4518.43	m² 1399.2 989.5 419.7
REAR WEST SIDE EAST SIDE  FRONT YARD LANDSCAPING AREA SOFT LANDSCAPE AREA HARD LANDSCAPE AREA	REQU SQ.FT	7.50 15 NG IRED m²	47'-9" 18'-1 ½" PROPO SQ.FT 15061.99 10543.56	14.56 5.53 SED m² 1399.2 989.5 419.7



Phone: +1(647)478-5055 Toll free: +1(885)561-4161 info@ithd.ca

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ADDITIONAL NOTES:

REVISIONS AND ISSUES

2024/12/28 3 REVISED PER CITY COMMENTS 2024/11/07 2 REVISED PER CITY COMMENTS 2024/09/25 1 ISSUED FOR CVC PERMIT DATE # DESCRIPTION

PROFESSIONAL SEAL: A. GOLOVNIA 2024/12/28 Andrii Golovnia BCIN 47354 REGISTRATION INFORMATION
Required unless design is exempt under
Division C-3.2.4.1 of the 2012 O.B.C.
Firm Name: In Tech House Design Corp
BCIN: 104226


PROJECT NAME: **New Custom House** 

PROJECT ADDRESS: 2035 Embleton Rd. Brampton, ON. L6Y 0E9

Site Plan & Key Plan

DESIGN BY:	RH
DRAWN BY:	JT
CHECKED BY:	AG
SCALE:	1:200
DATE:	2024/12/28
PROJECT №:	24-699

DRAWING №: SP-1

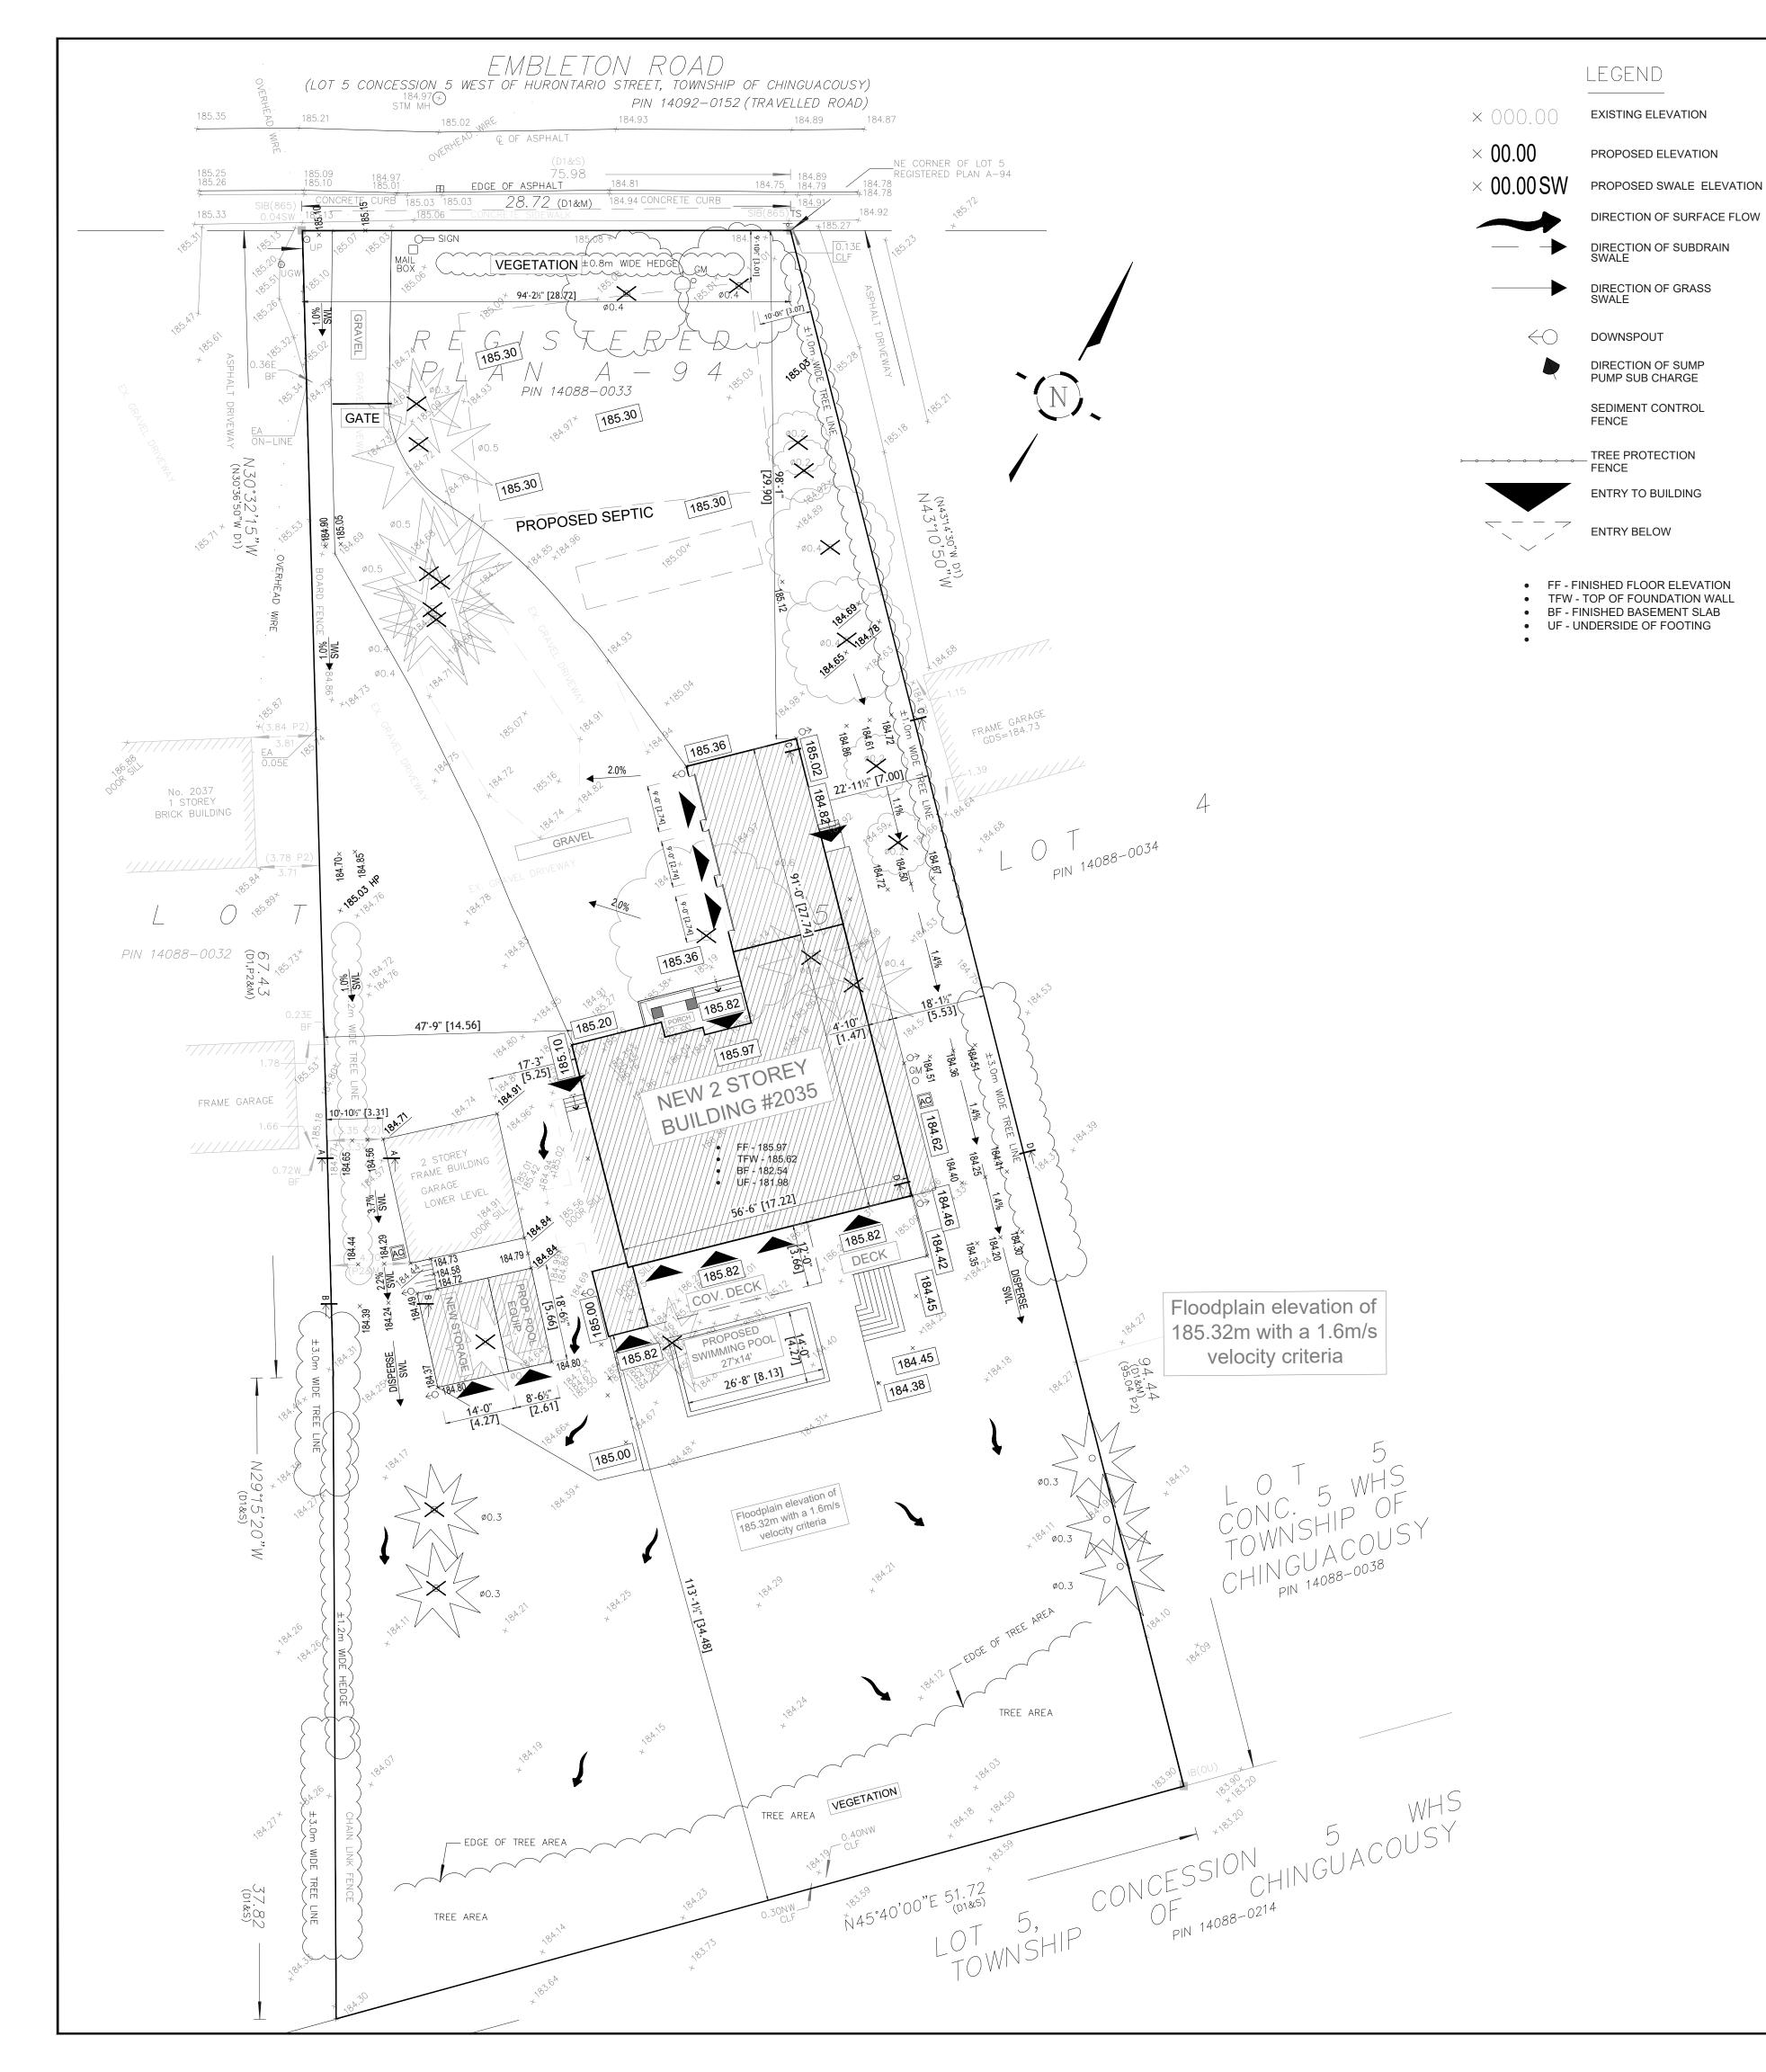

## **GENERAL NOTES**

- BOUNDARY INFORMATION SHOWN HERE IS COMPILED FROM A PLAN OF SURVEY BY AISAR BHERI OF MACKAY, MACKAY & PETERS LIMITED. DATED DECEMBER 8, 2021. ALL CONSTRUCTION SHELL BE IN ACCORDANCE WITH CURRENT ONTARIO
- PROVINCIAL STANDARD DRAWINGS AND SPECIFICATIONS. ALL DIMENSION SHELL BE CHECKED AND VERIFIED BY THE CONTRACTOR. ANY DISCREPANCIES TO BE REPORTED TO THE ENGINEER. LOCATIONS AND ELEVATIONS OF EXISTING UTILITIES AND SERVICES SHOWN ON THE PLAN ARE FOR REFERENCE ONLY. THE CONTRACTOR IS
- RESPONSIBLE FOR LOCATING AND PROTECTING ALL UTILITIES AND SERVICES.

#### **ELEVATION NOTE:**

• ELEVATIONS ARE GEODETIC IN ORIGIN AND WERE DERIVED FROM OBSERVED REFERENCE POINTS (ORP) USING THE LEICA SMARTNET NETWORK (2010 EPOCH) AND ARE REFERRED TO THE CGVD28:1978 (HTv2.0) DATUM.

## **BENCHMARK NOTE:**

- CITY OF BRAMPTON BENCHMARK No. 042200354.
- ELEVATION = 205.880 METRES (CGVD28:78 ADJUSTMENT). • 31.77m NORTH OF CENTRELINE OF QUEENSTREET WEST, 60.18m EAST OF CENTRELINE OF MISSISSAUGA RD.

### **BEARING NOTE:**

- BEARINGS ARE ASTRONOMIC AND ARE REFERRED TO THE SOUTHERLY LIMIT OF THE EMBLETON ROAD AS SHOWN ON PLAN 43R-25290, HAVING A BEARING OF N61°00'10" E
- SURFACE DRAINAGE TO BE DIRECTED AWAY FROM THE BUILDING TO SIDE YARD SWALES OR DITCHES. MAXIMUM SIDE SLOPES NOT TO EXCEED 3:1
- ALL STORM WATER SHALL BE DIRECTED IN SUCH A MANNER THAT WATER WILL NOT ACCUMULATE AT OR NEAR A BUILDING INCLUDING FOUNDATION WALLS, WINDOWS, ENTRANCES AND WALKWAYS.
- ALL DISTURBED AREAS TO BE SODDED OR SEEDED OVER 75mm OF TOPSOIL.

#### CONSTRUCTION SCHEDULE

- 1. ALL SNOW FENCING AND SEDIMENT CONTROL FENCING TO BE INSTALLED AND MAINTAINED THROUGHOUT THE ENTIRE CONSTRUCTION PHASE. 2. SEDIMENT CONTROLS ARE TO BE INSPECTED REGULARLY TO ENSURE
- PROPER FUNCTION. FOLLOW THE SCHEDULE SHOWN. 3. SEDIMENT AND EROSION CONTROL MEASURES SHOULD BE UPGRADED
- IMMEDIATELY IF THEY ARE NOT EFFECTIVE. 4. ALL DAMAGED SEDIMENT AND EROSION CONTROL MEASURES SHOULD BE
- REPAIRED AND/OR REPLACED WITHIN 48 HOURS OF DISCOVERING THE
- 5. UNDER NO CIRCUMSTANCES IS SEDIMENT TO BE RELEASED INTO THE NATURAL ENVIRONMENT
- 6. IF A LARGE RAIN EVENT IS IMMINENT, EARTH WORK ACTIVITIES WILL CEASE AND ALL EROSION AND SEDIMENT CONTROL MEASURES WILL BE INSPECTED TO ENSURE THEY ARE IN GOOD WORKING ORDER.
- 7. IF SITE CONSTRUCTION ACTIVITIES ARE INTERRUPTED AND/OR INACTIVITY EXCEEDS 30 DAYS ALL STRIPPED AND/OR BARE SOIL AREAS ARE TO BE STABILIZED BY SODDING/SEEDING/MULCHING OR OTHER APPROVED METHOD TO THE SATISFACTION OF THE CITY OF TORONTO.
- 8. DURING ALL CONSTRUCTION PHASES, MUD TRACKING CONTROL WILL CONSIST OF MAINTAINING THE STONE PAD CONSTRUCTION ENTRANCE AND/OR FLUSHING OR SWEEPING ROADS AS WARRANTED.

- EX. SAN CON. TO BE DECOMMISSIONED BY CITY AT OWNER EXPENSE - EX. STORM CON. TO BE DECOMMISSIONED BY CITY AT OWNER EXPENSE - EX. WATER CON. TO BE DECOMMISSIONED BY CITY AT OWNER EXPENSE

## **UNDERGROUND SERVICES**

THE LOCATION OF UNDERGROUND SERVICES SHOWN ON THIS PLAN IS ONLY APPROXIMATE AND IS FOR PLANNING AND DESIGN PURPOSES ONLY. THIS INFORMATION MUST NOT BE ASSUMED TO BE COMPLETE OR UP-TO-DATE. THE UNDERNAMED COMPANY AND EACH UTILITY ACCEPTS NO RESPONSIBILITY FOR ANY CLAIMS OR LOSSES DUE TO IMPROPER USE OF THE INFORMATION SHOWN HEREON AND EACH UTILITY MUST BE CONTACTED FOR AN ON-SITE LOCATE PRIOR TO ANY EXCAVATION.

- ALL FOOTING FORMWORK ELEVATIONS AND SETBACKS ARE TO BE CONFIRMED BY A REGISTERED PROFESSIONAL ENGINEER OR A REGISTERED ONTARIO LAND SURVEYOR PRIOR TO THE PLACING OF ANY CONCRETE. - PRIOR TO THE SUPERSTRUCTURE WORKS PROCEEDING AND THE RELEASE OF THE COMPLETION STAGE PERMIT, THAT OWNER S CONSULTANT MUST CERTIFY THAT THE TOP OF FOUNDATIONS IS IN CONFORMITY WITH THE GRADING PLAN REVIEWED BY TOWN,

- ALL RAINWATER LEADERS SHALL DISCHARGE ONTO CONCRETE SPLASH PADS AT GROUND LEVEL AT THE LOCATIONS INDICATED ON THIS PLAN - EXISTING BOUNDARY ELEVATIONS ALONG THE SITE PERIMETER SHALL REMAIN UNDISTURBED. DRAINAGE RECEIVED FROM ADJACENT PROPERTIES SHALL BE ACCOMMODATED AND DRAINAGE FROM THE SUBJECT LANDS SHALL BE SELF-CONTAINED.


- THE OWNER SHALL CONTACT THE TOWNS ARBORIST FOR CONSENT PRIOR TO ANY TREE BEING REMOVED.


- THE OWNER SHALL CONTACT THE OPERATIONS SECTION OF THE ENGINEERING & PUBLIC WORKS DEPARTMENT AND MAKE ALL ARRANGEMENTS NECESSARY FOR DRIVEWAY ACCESS AND SITE SERVICE CONNECTIONS.


- THE OWNER SHALL CONTACT THE TOWNS BUILDING SERVICES DIVISION A MINIMUM OF 48 HOURS IN ADVANCE OF CONSTRUCTION OF ANY RETAINING WALL DEEMED TO BE A "DESIGNATED STRUCTURE".


IN ORDER TO ARRANGE FOR ANY NECESSARY INSPECTIONS: - THE OWNER IS RESPONSIBLE TO ENSURE ALL CONSTRUCTION ACTIVITY AND FINAL PRODUCT CONFORMS TO ALL TOWN BYLAWS.


- FOR PROPOSED INFILTRATION GALLERIES, THE OWNER SHALL PROVIDE THE TOWN WITH CONSTRUCTION PHOTOS AFTER EXCAVATION OF THE GALLERY AND TRENCHES FOR ROOF DRAIN PIPE CONNECTIONS. PRIOR TO BACKFILLING, THE OWNER SHALL ALSO PROVIDE CONSTRUCTION PHOTOS AFTER INSTALLATION OF CLEAR STONE AND ROOF DRAIN PIPE.

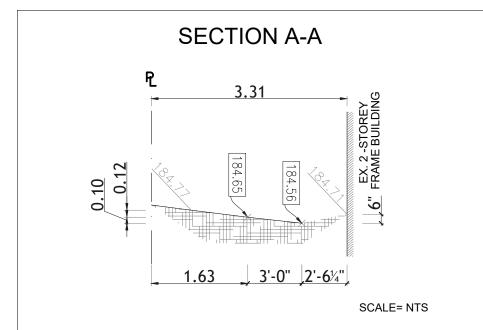


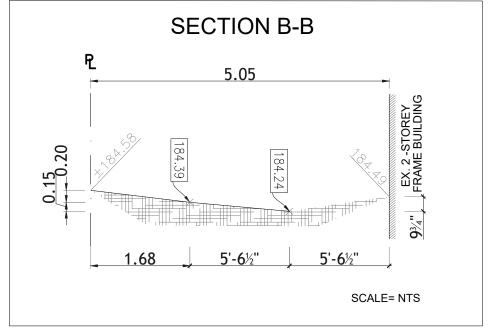

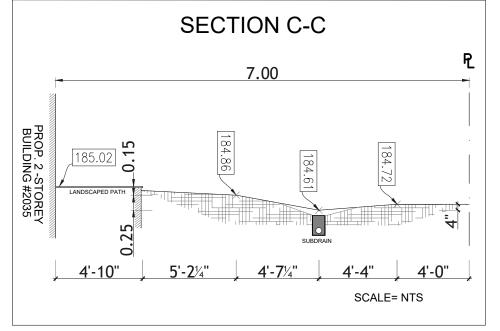

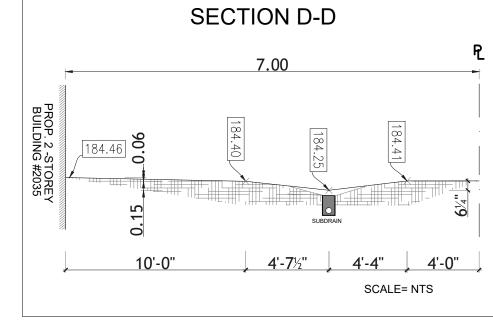

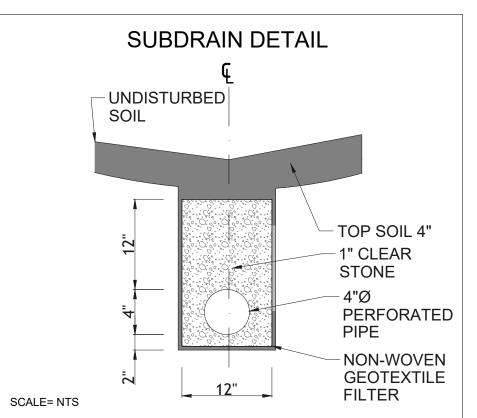

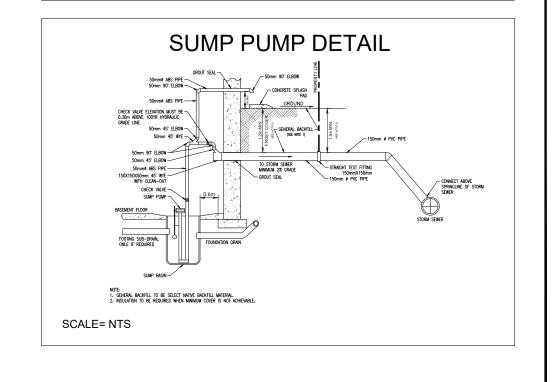



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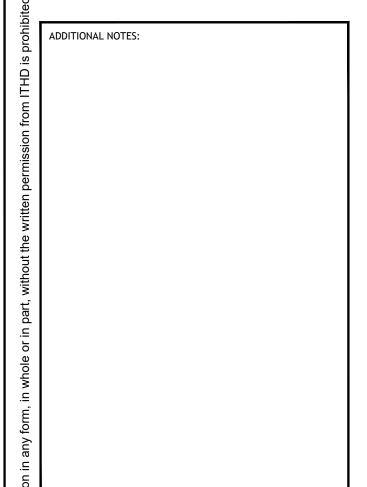
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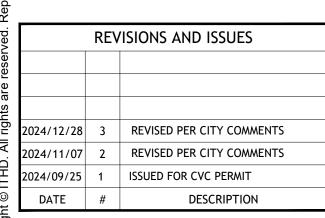
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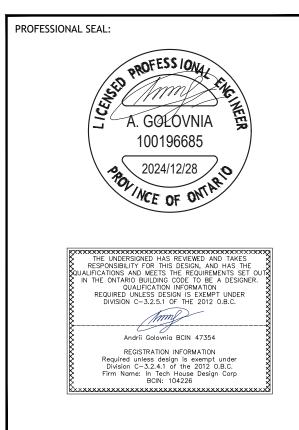
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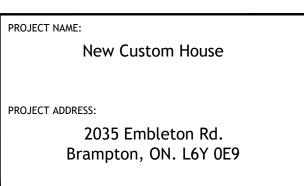
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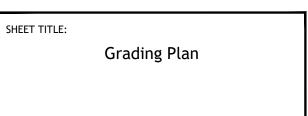
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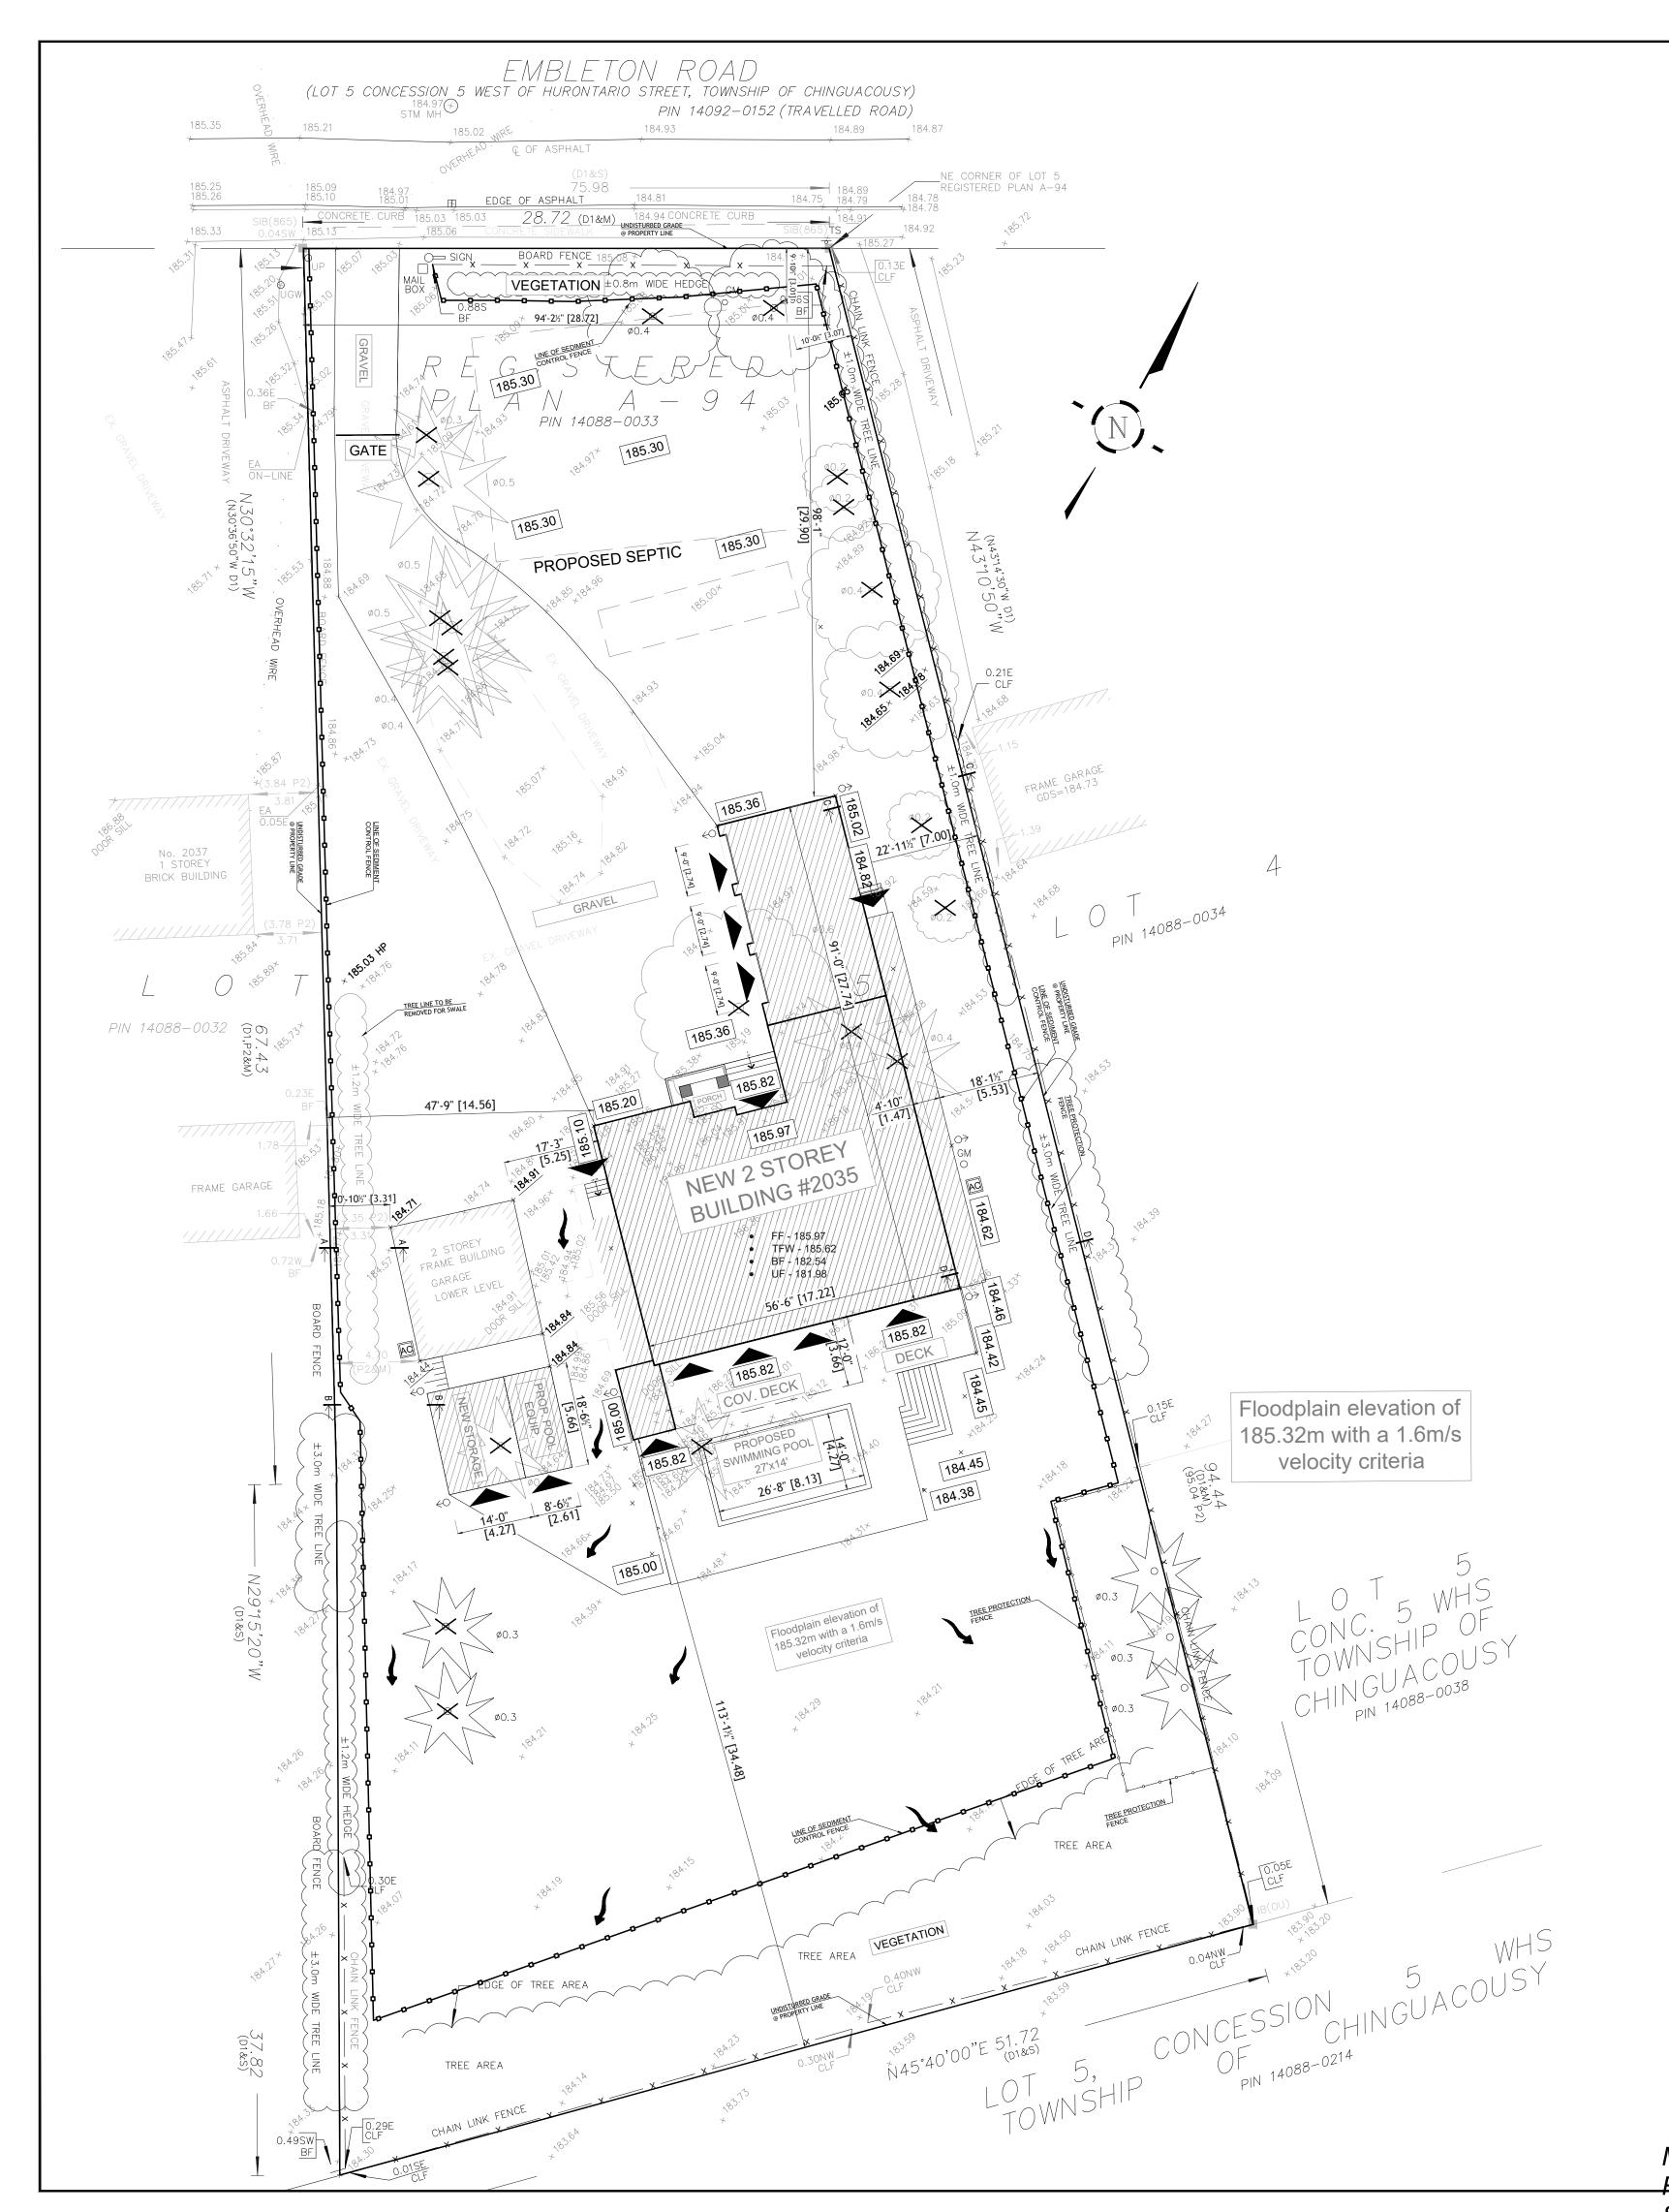







**C-**1

DESIGN BY:	RH	
DRAWN BY:	JT	1
CHECKED BY:	AG	
SCALE:	1:200	
DATE:	2024/12/28	
PROJECT №:	24-699	



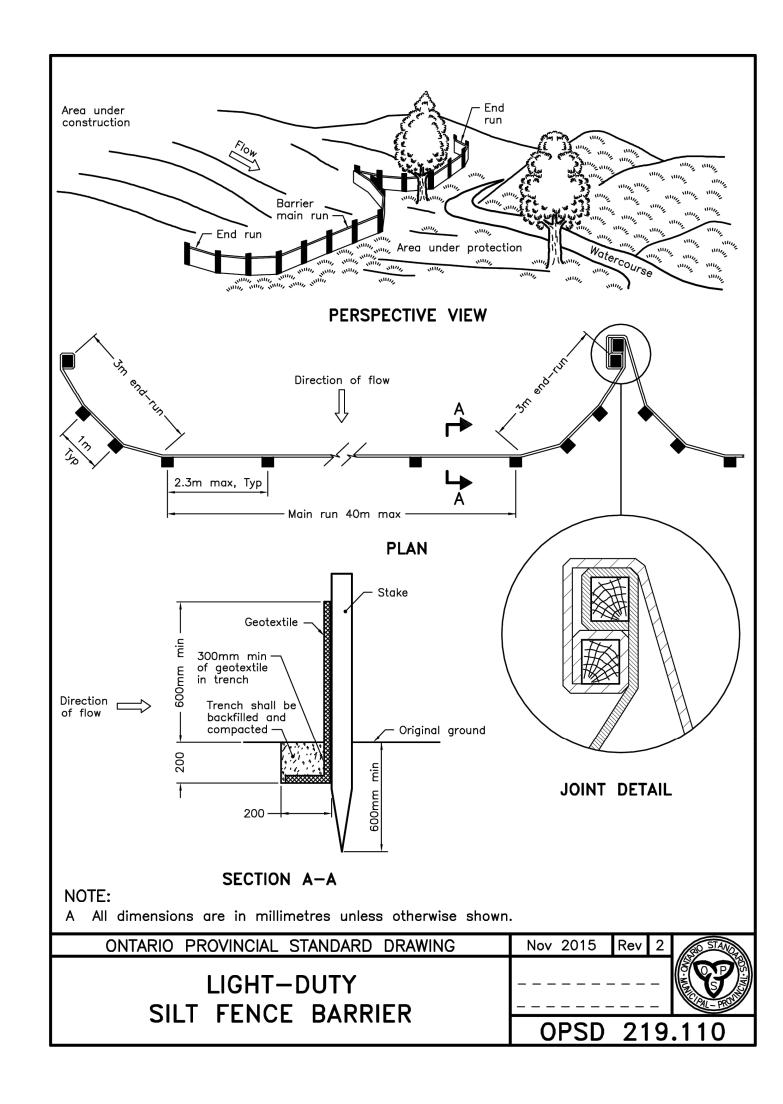

ESC LEGEND 1.

DOWNSPOUT

DIRECTION OF SUMP PUMP SUB CHARGE

TREE PROTECTION BARRIERS

DENOTES SILT FENCE

TREES TO BE REMOVED

FFE - FIRST FLOOR ELEVATION
TofFW - TOP OF FOUNDATION WALI
TofBS - TOP BASEMENT SLAB
BofF - BOTTOM OF THE FOOTING

ENTRY TO BUILDING

ENTRY BELOW

### SCHEDULE

SEDIMENT FENCE

INITIAL SEDIMENT CONTROL INSTALLATION; TBD 2024-2025 SITE GRADING OPERATION; TBD 2025 UNDERGROUND SERVICING OPERATIONS; TBD 2025 BUILDING CONSTRUCTION; TBD 2025 FINAL GRADING OPERATION; TBD 2025

SEDIMENT CONTROL INSPECTION AND MAINTENANCE OF

1. CHECK FOR ANY LOOSE ENDS AND ATTACH TO THE TEE STAKES OR BURY INTO THE GROUND AND/OR PLACE CLEAR STONE AT THE

BOTTOM OF THE FENCE AS REQUIRED.

2. CHECK FOR ANY DAMAGED, BROKEN FENCE AND REPLACE WITH NEW FILTER FABRIC, ATTACH TO THE TEE STAKES AND BURY INTO THE GROUND AS REOUIRED.

3. CHECK FOR SEDIMENT BUILD UP AND CLEAN IF NECESSARY.

\_\_\_\_\_

EROSION AND SEDIMENT CONTROL / GENERAL NOTES

1. SEDIMENT BARRIERS, CHECK DAMS. AND TEMPORARY CONSTRUCTION ACCESS TO BE INSTALLED PRIOR TO THE BEGINNING OF CONSTRUCTION.

ALL SEDIMENT CONTROL DEVICES TO BE ROUTINELY INSPECTED
AND MAINTAINED IN PROPER WORKING ORDER UNTIL AREA IS
STABILIZED.
 IF NECESSARY, TRUCKS WILL BE WASHED DOWN BEFORE

LEAVING THE SITE.
4. THE SITE WILL BE WET DOWN IF NECESSARY TO CONTROL DUST.

5. ALL CONSTRUCTION EQUIPMENT MUST BE PARKED ON-SITE.6. WILL COMPLY WITH KING CITY NOISE BY-LAW.

7. SEDIMENT CONTROL FENCE TO BE AS PER LSRCA STANDARD
8. ALL CONSTRUCTION VEHICLES TO ENTER AND EXIT SITE FROM

TEMPORARY CONSTRUCTION ACCESS.

9. ALL TOPSOIL STOCKPILES TO BE SURROUNDED WITH SEDIMENT CONTROL FENCING.

#### SEDIMENT AND EROSION CONTROL NOTES

INSTALL ALL EROSION AND SEDIMENT CONTROL MEASURES APPROVED BY THE LOCAL CONSERVATION AUTHORITY AND THE CITY, PRIOR TO DEVELOPMENT, AND MAINTAIN SUCH MEASURES THROUGHOUT THE CONSTRUCTION PROCESS, UNTIL ALL DISTURBED AREAS HAVE BEEN INSPECTED. MAINTAIN ALL EROSION AND SEDIMENT CONTROL MEASURES AFTER EACH RAINFALL TO THE SATISFACTION OF THE CITY. MAINTAIN A DIARY FOR REVIEW UPON

REQUEST.
PROVIDE SUITABLE TEMPORARY MULCH AND SEED COVER WITHIN SEVEN (7) DAYS OF THE COMPLETION OF A PARTICULAR PHASE OF CONSTRUCTION FOR ANY DISTURBED AREA NOT SCHEDULED FOR FURTHER CONSTRUCTION WITHIN FORTY-FIVE (45) DAYS; AND RE-VEGETATED ALL DISTURBED AREAS WITH PERMANENT COVER IMMEDIATELY FOLLOWING COMPLETION OF CONSTRUCTION.

#### NOTE

THE EROSION AND SEDIMENT CONTROL STRATEGIES OUTLINED ON THE PLANS ARE NOT STATIC AND MAY NEED TO BE UPGRADED/AMENDED AS SITE CONDITIONS CHANGE TO MINIMIZE SEDIMENT LADEN RUNOFF FROM LEAVING THE WORK AREAS. IF THE PRESCRIBED MEASURES ON THE PLANS ARE NOT EFFECTIVE IN PREVENTING THE RELEASE OF A DELETERIOUS SUBSTANCE, INCLUDING SEDIMENT, THEN ALTERNATIVE MEASURES MUST BE IMPLEMENTED IMMEDIATELY TO MINIMIZE POTENTIAL ECOLOGICAL IMPACTS. LSRCA ENFORCEMENT OFFICER SHOULD BE IMMEDIATELY CONTACTED. ADDITIONAL ESC MEASURES SUCH AS CLEAR STONE, FILTER FABRIC, PUMPS HOSES AND SILTSOXX TO BE KEPT ON SITE AT ALL TIME FOR CONDUCTING REPAIRS TO SEDIMENT CONTROL MEASURES.

## CONSTRUCTION NOTES

- ALL SNOW FENCING AND SEDIMENT CONTROL FENCING TO BE INSTALLED
- AND MAINTAINED THROUGHOUT THE ENTIRE CONSTRUCTION PHASE.

  2. SEDIMENT CONTROLS ARE TO BE INSPECTED REGULARLY TO ENSURE
- PROPER FUNCTION. FOLLOW THE SCHEDULE SHOWN.

  3. SEDIMENT AND EROSION CONTROL MEASURES SHOULD BE UPGRADED IMMEDIATELY IF THEY ARE NOT EFFECTIVE.

  4. ALL DAMAGED SEDIMENT AND EROSION CONTROL MEASURES SHOULD BE

REPAIRED AND/OR REPLACED WITHIN 48 HOURS OF DISCOVERING THE

- 5. UNDER NO CIRCUMSTANCES IS SEDIMENT TO BE RELEASED INTO THE
- NATURAL ENVIRONMENT.
  6. IF A LARGE RAIN EVENT IS IMMINENT, EARTH WORK ACTIVITIES WILL
- CEASE AND ALL EROSION AND SEDIMENT CONTROL MEASURES WILL BE INSPECTED TO ENSURE THEY ARE IN GOOD WORKING ORDER.

  7. IF SITE CONSTRUCTION ACTIVITIES ARE INTERRUPTED AND/OR INACTIVITY EXCEEDS 30 DAYS ALL STRIPPED AND/OR BARE SOIL AREAS ARE TO BE STABILIZED BY SODDING/SEEDING/MULCHING OR OTHER
- APPROVED METHOD TO THE SATISFACTION OF THE CITY OF TORONTO.

  8. DURING ALL CONSTRUCTION PHASES, MUD TRACKING CONTROL WILL CONSIST OF MAINTAINING THE STONE PAD CONSTRUCTION ENTRANCE AND/OR FLUSHING OR SWEEPING ROADS AS WARRANTED.



Phone: +1(647)478-5055 ithd.ca
Toll free: +1(885)561-4161 info@ithd.ca

GENERAL NOTES

PROCEEDING WITH WORK

THE CONTRACTOR SHALL VERIFY ALL DIMENSIONS AT THE SITE AND REPORT ANY DISCREPANCIES TO THE CONSULTANT BEFORE

DO NOT SCALE DRAWINGS
 ALL WORKS IS TO BE CARRIED OUT ACCORDING TO THE

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 ALL EXISTING SURFACES AND STRUCTURES ADJACENT TO THE PROPOSED WORK ARE TO BE PROTECTED DURING DEMOLITION AND


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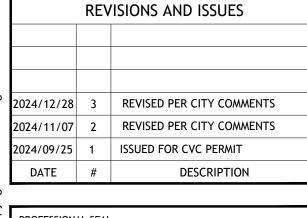
ALL TEMPORARY WORKS INCLUDING SHORING ARE TO BE PROVIDED.

BY THE CONTRACTOR

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PROJECT ADDRESS:

2035 Embleton Rd.
Brampton, ON. L6Y 0E9

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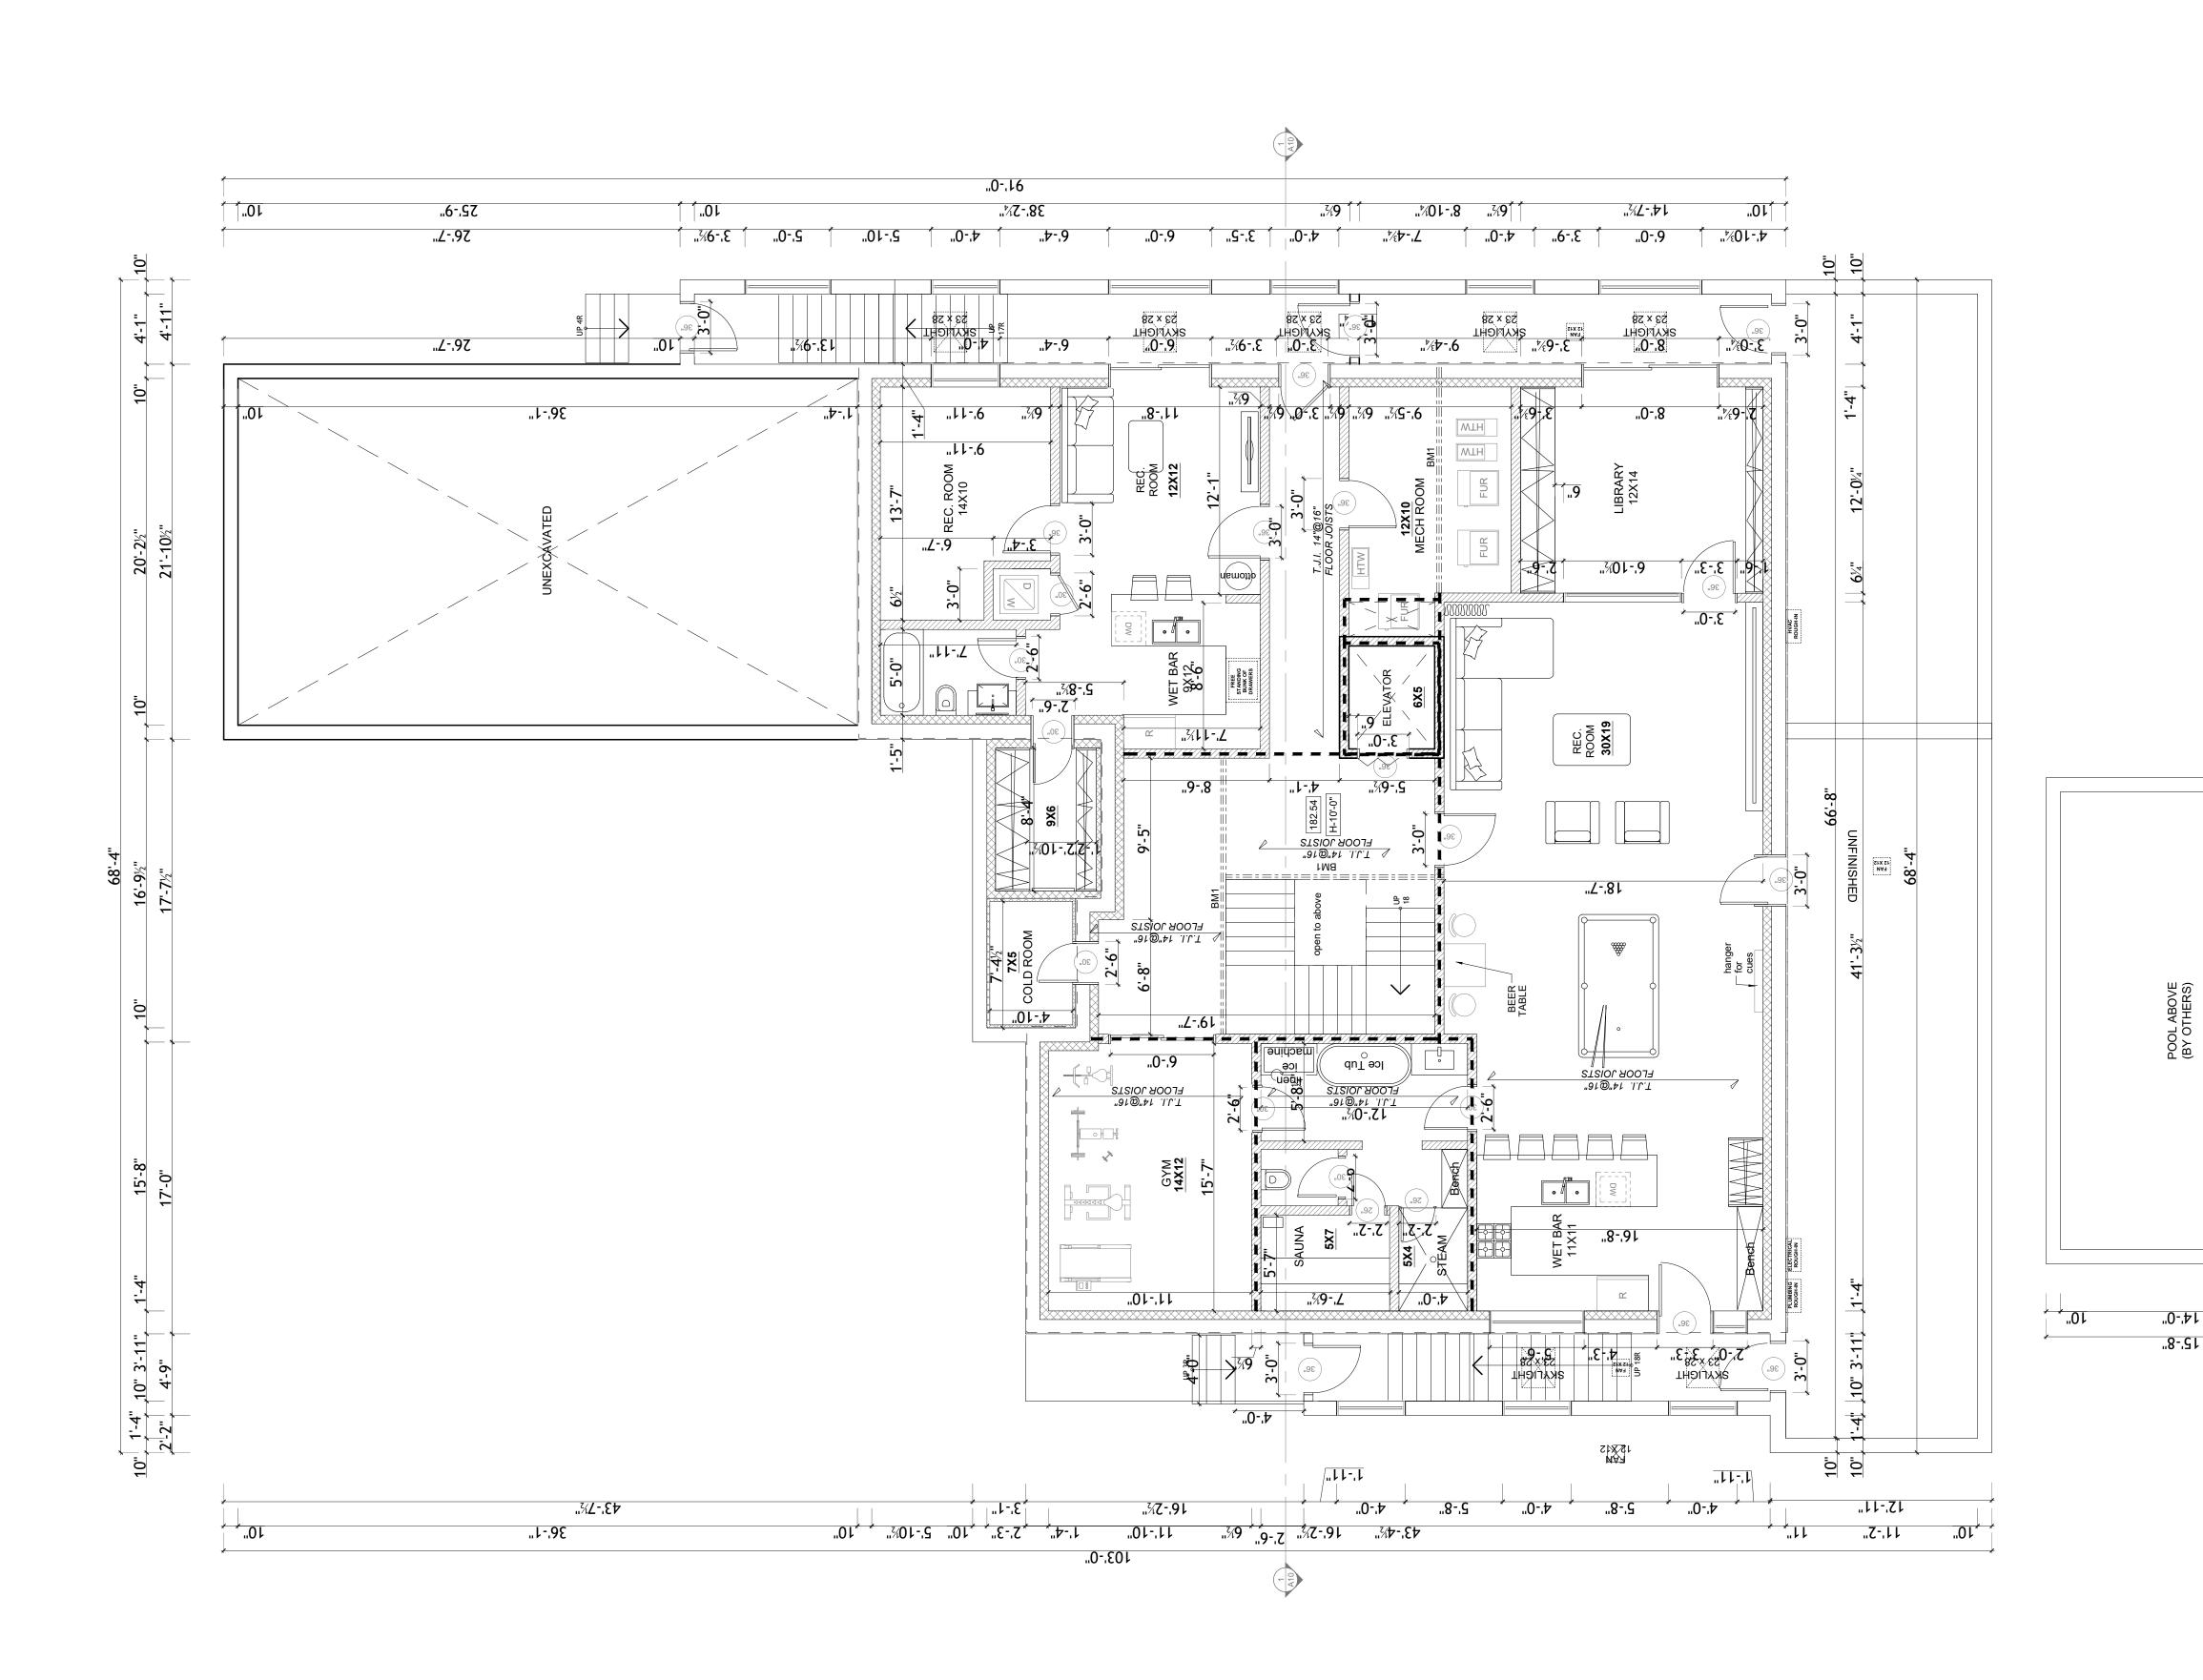
Erosion & Sediment Control Plan

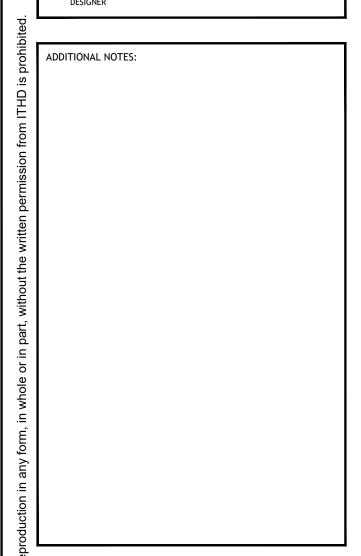DESIGN BY:	RH	
DRAWN BY:	JT	
CHECKED BY:	AG	
SCALE:	1:200	
DATE:	2024/12/28	
PROJECT №:	24-699	

JT
AG
1:200
2024/12/28
24-699

DRAWING №:

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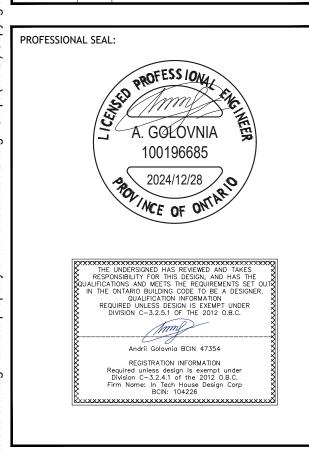
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ADDITIONAL NOTES:

	REVISIONS AND ISSUES		
2024/12/28	3	REVISED PER CITY COMMENTS	
2024/11/07	2	REVISED PER CITY COMMENTS	
2024/09/25	1	ISSUED FOR CVC PERMIT	
DATE	#	DESCRIPTION	



PROJECT NAME: New Custom House

PROJECT ADDRESS:

2035 Embleton Rd. Brampton, ON. L6Y 0E9

BASEMENT PLAN

DESIGN BY: DRAWN BY: CHECKED BY: SCALE: 3/16" = 1'-0" 2024/12/28

PROJECT №:

DRAWING №: SIZE: ARCH D 36"X24"





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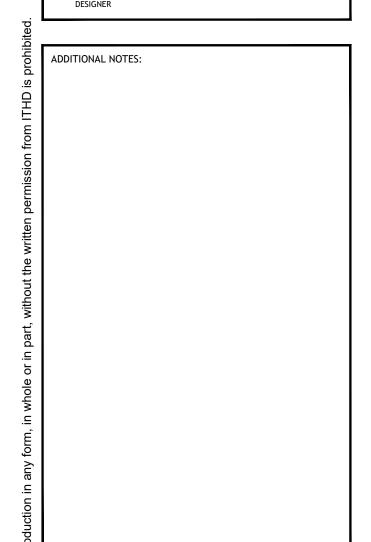
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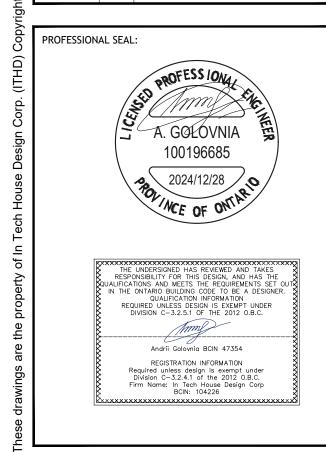
BY THE CONTRACTOR


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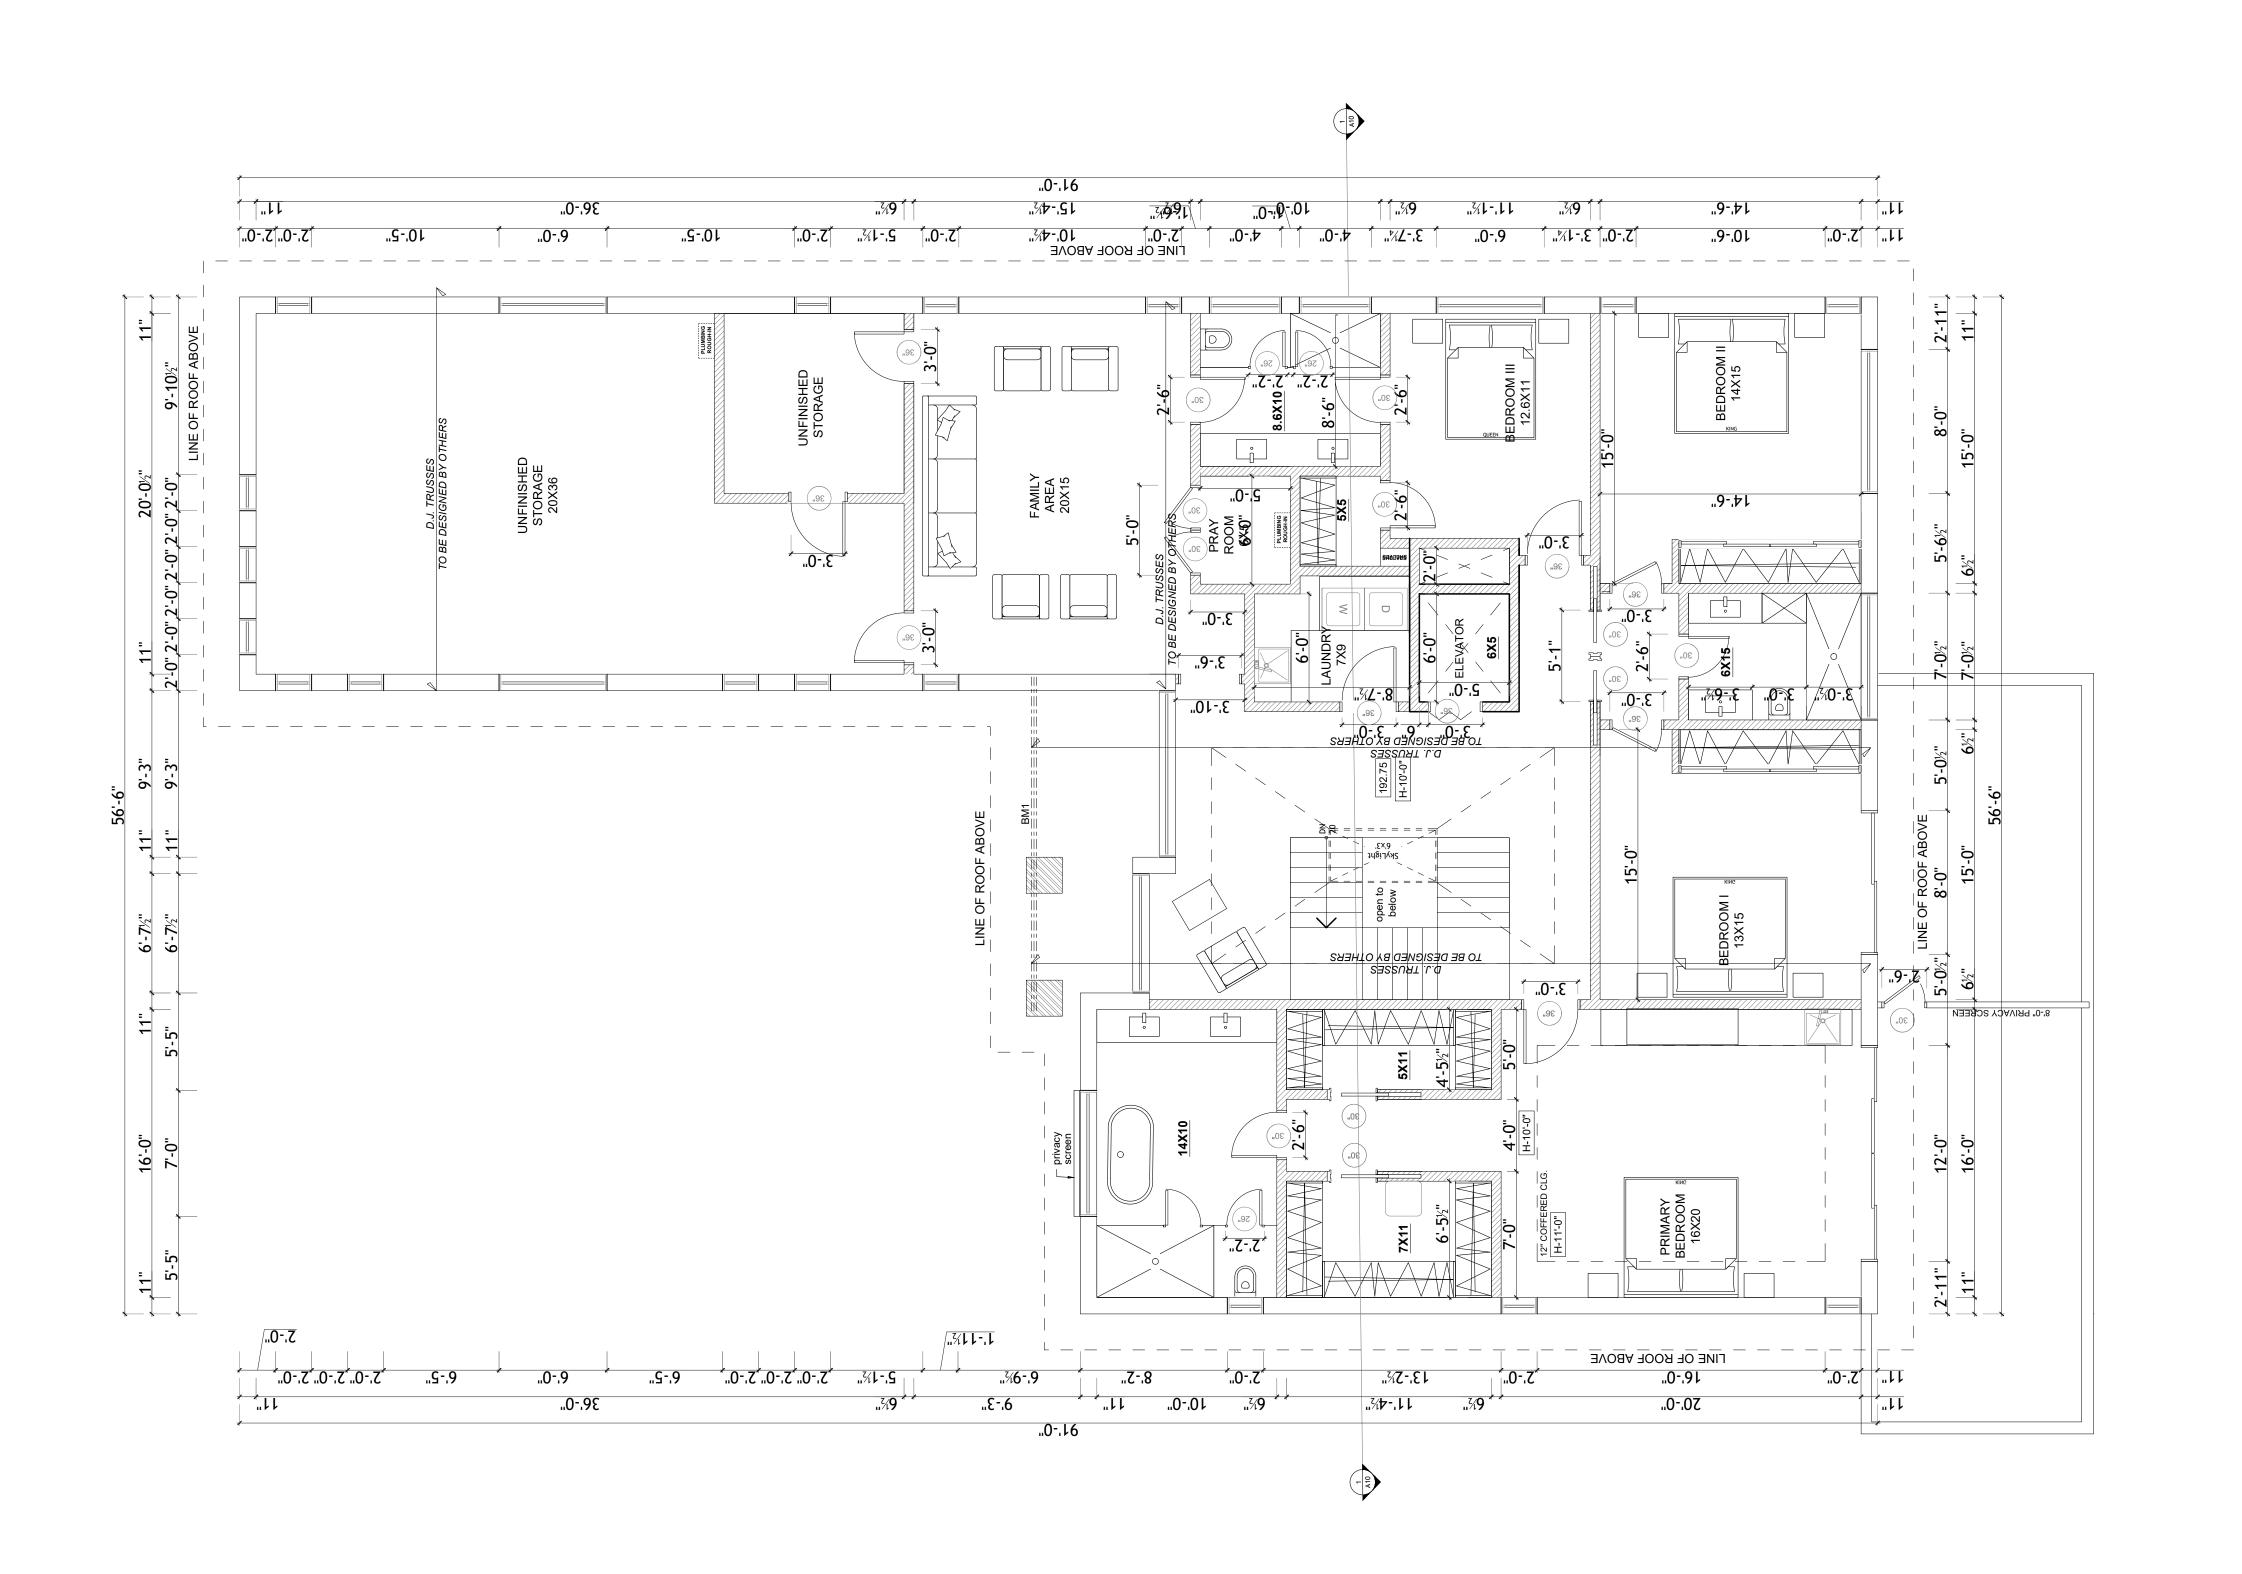
FIRST FLOOR PLAN

DESIGN BY: DRAWN BY: CHECKED BY: SCALE: ############ DATE: 2024/12/28

PROJECT №: 24-699

DRAWING №:

SIZE: ARCH D 36"X24"

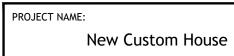



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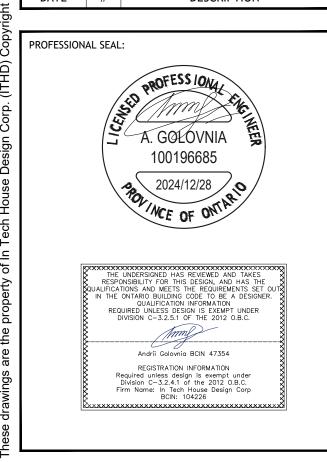
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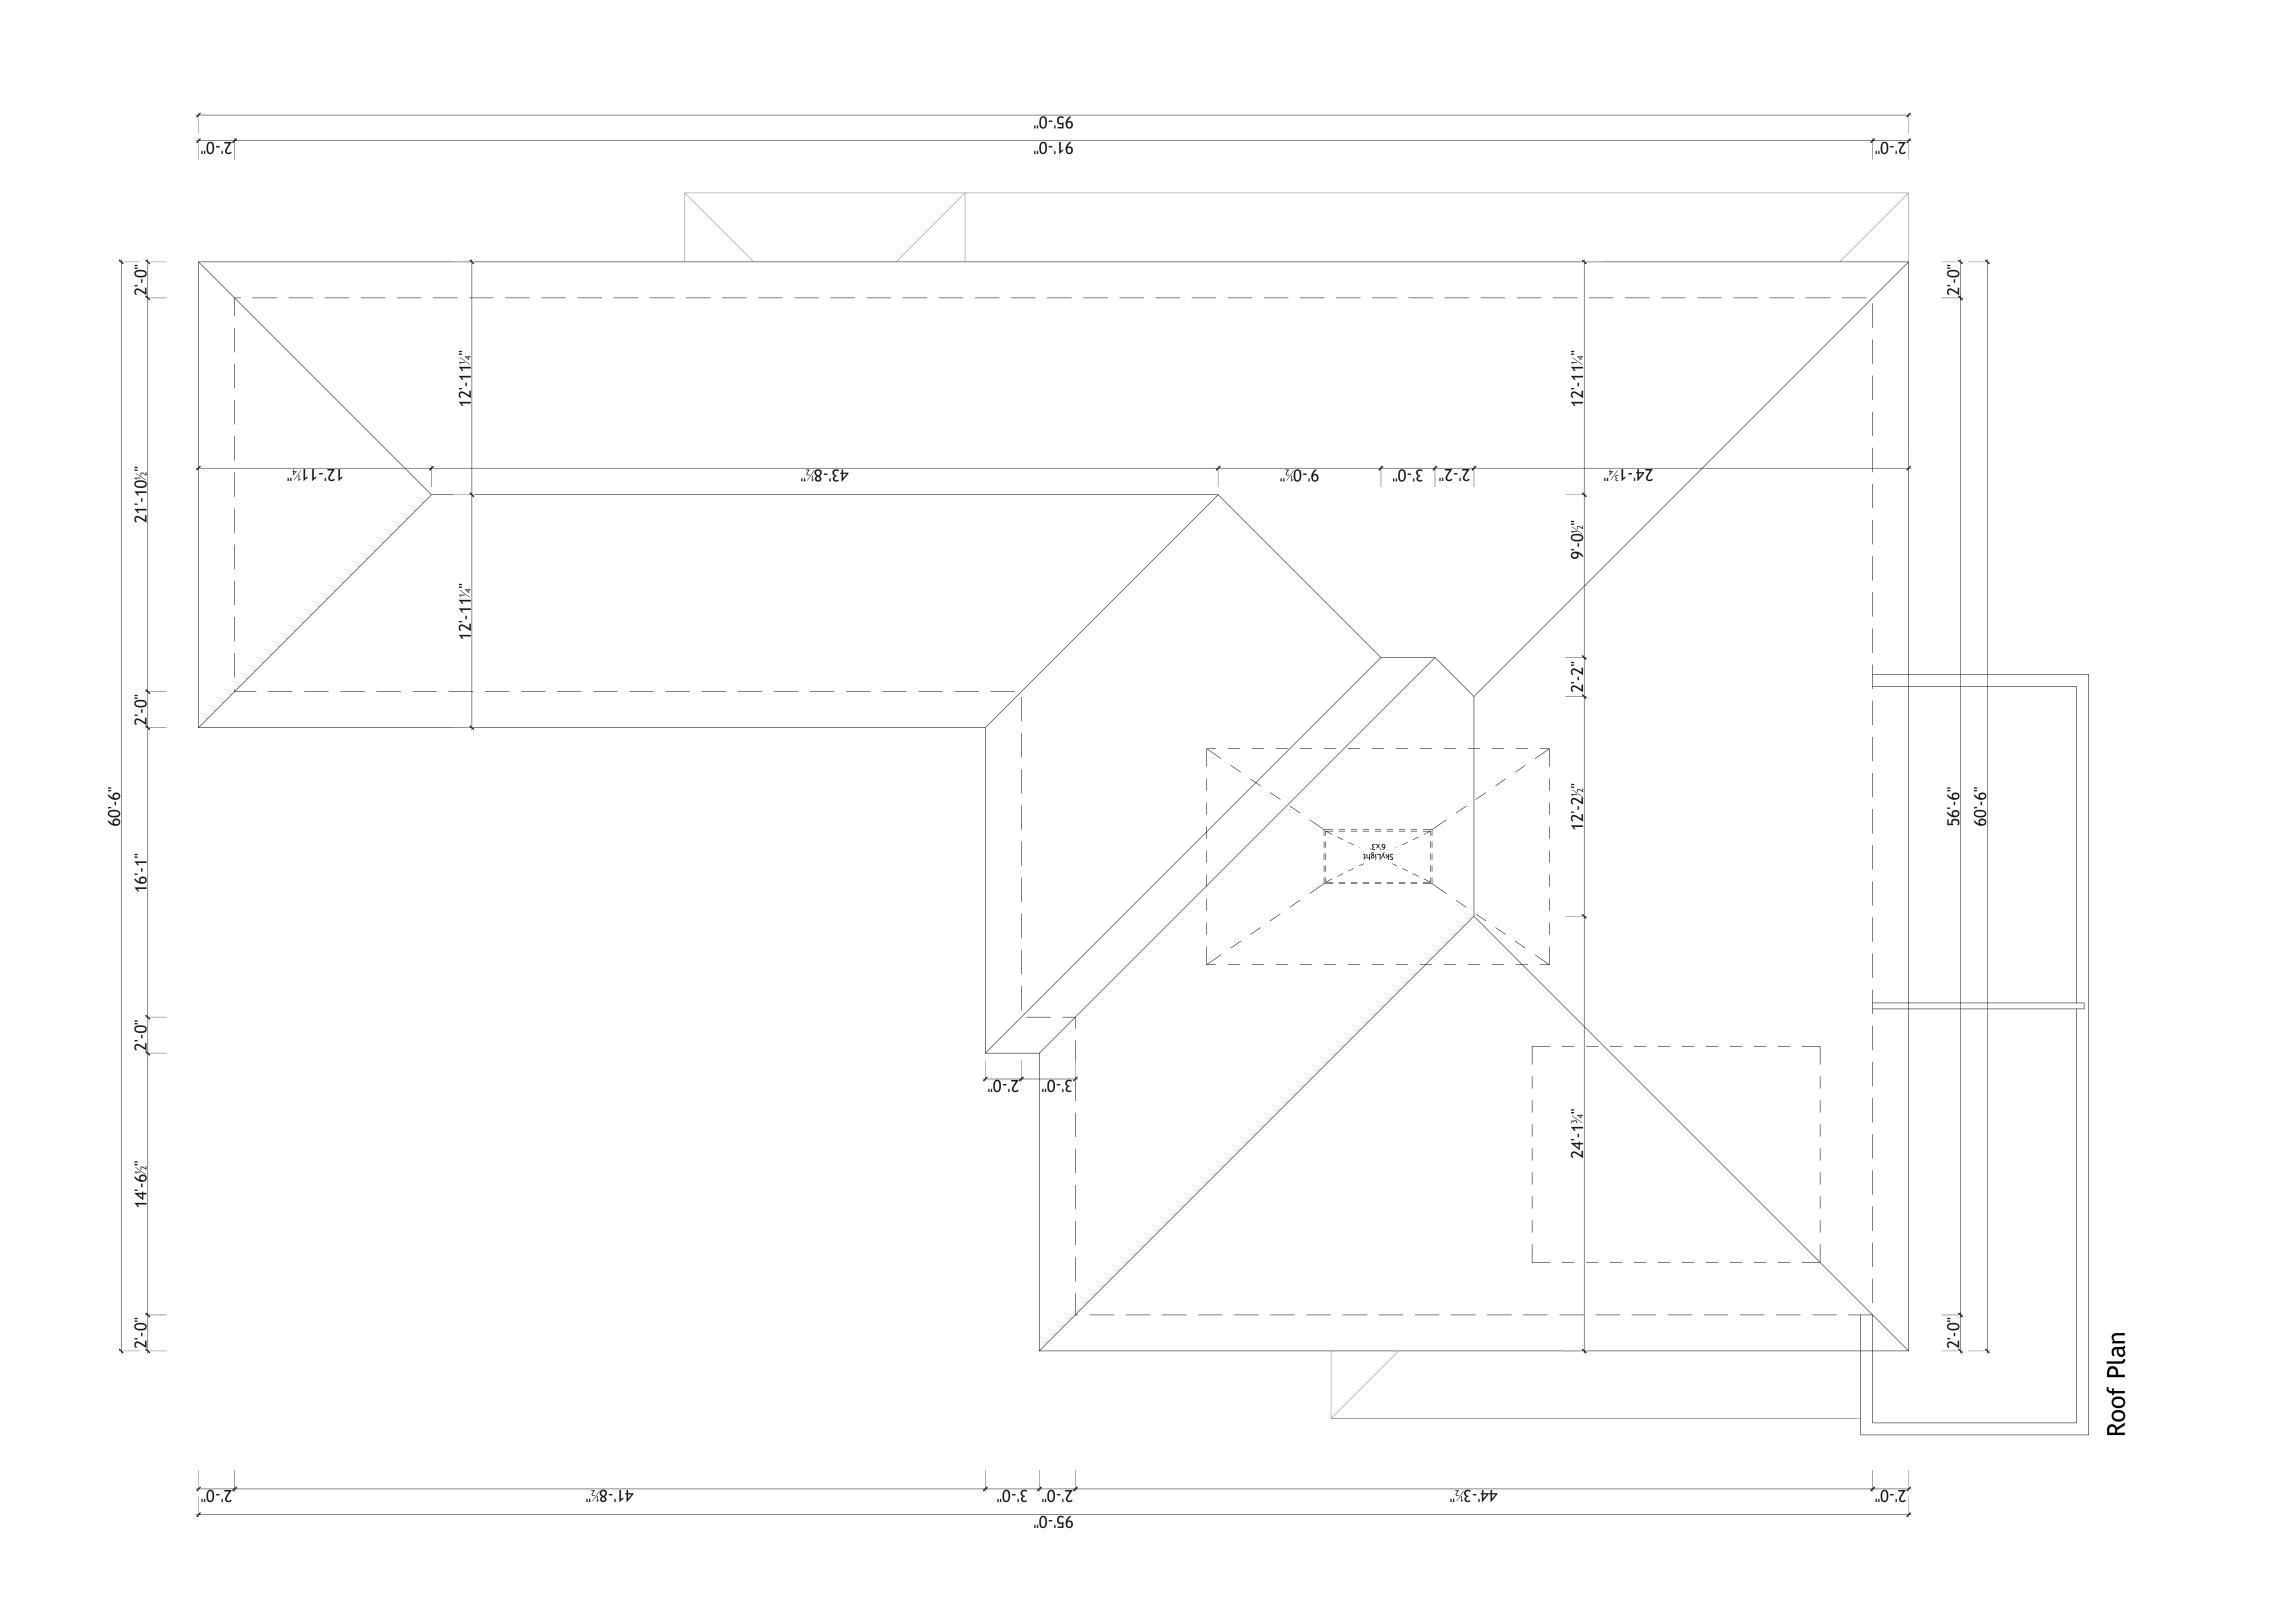


PROJECT NAME: **New Custom House** 

PROJECT ADDRESS: 2035 Embleton Rd. Brampton, ON. L6Y 0E9

SECOND FLOOR PLAN

DESIGN BY	: RH
DRAWN BY	: JT
CHECKED I	BY: AG
SCALE:	############
DATE:	2024/12/28
PROJECT N	le: 24-699





GENERAL NOTES

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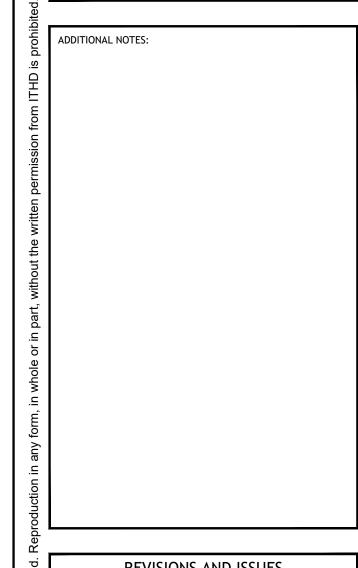
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PROFESSIONAL SEAL: THE UNDERSIGNED HAS REVIEWED AND TAKES
RESPONSIBILITY FOR THIS DESIGN, AND HAS THE
QUALIFICATIONS AND MEETS THE REQUIREMENTS SET
IN THE ONTARIO BUILDING CODE TO BE A DESIGNER
QUALIFICATION INFORMATION
REQUIRED UNLESS DESIGN IS EXEMPT UNDER
DIVISION C-3.2.5.1 OF THE 2012 O.B.C.


Andrii Golovnia BCIN 47354 REGISTRATION INFORMATION
Required unless design is exempt under
Division C-3.2.4.1 of the 2012 O.B.C.
Firm Name: In Tech House Design Corp
BCIN: 104226

PROJECT NAME: **New Custom House** 

PROJECT ADDRESS: 2035 Embleton Rd. Brampton, ON. L6Y 0E9

**ROOF PLAN** 

DESIGN BY:	ı
DRAWN BY:	
CHECKED BY:	,
SCALE:	3/16" = 1'
DATE:	2024/12/
PROJECT №:	24-6

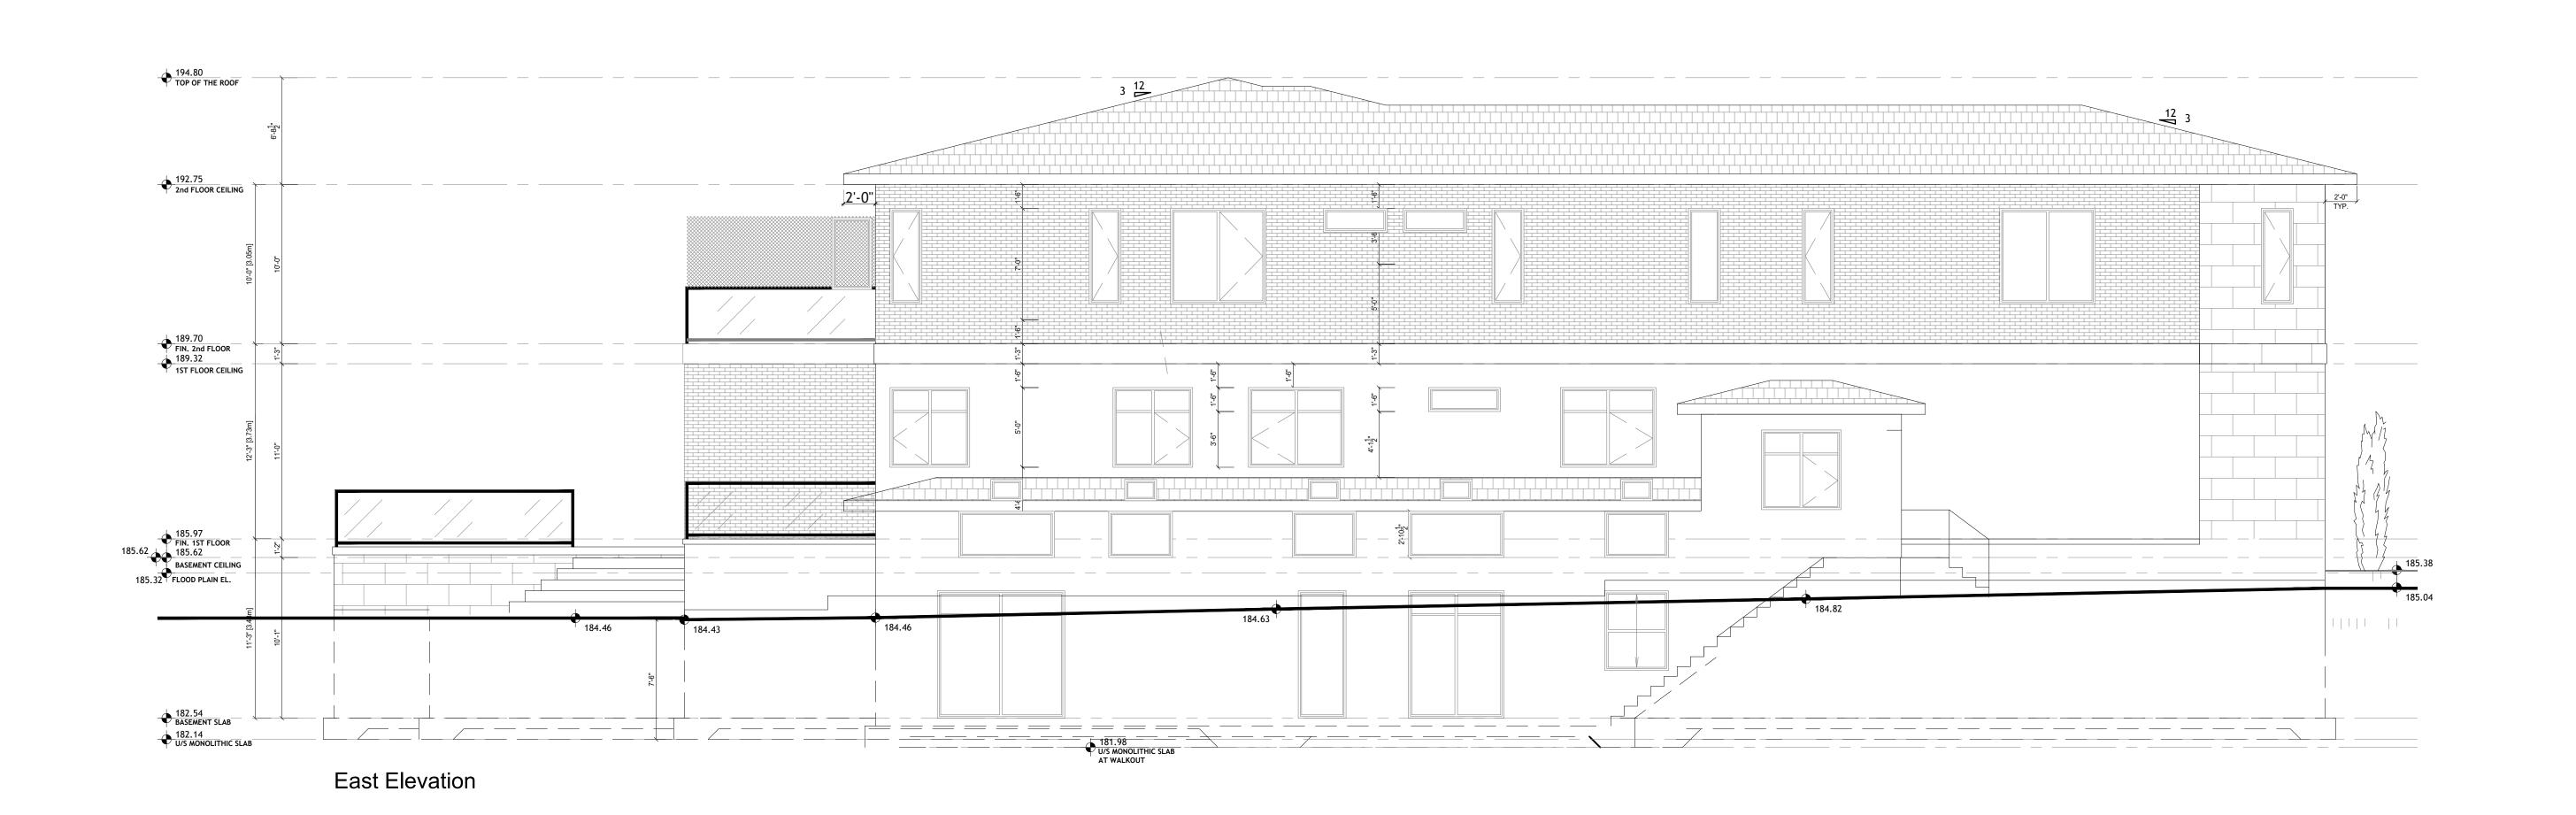





GENERAL NOTES

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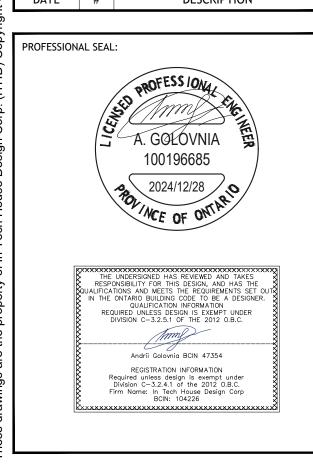
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ADDITIONAL NOTES:

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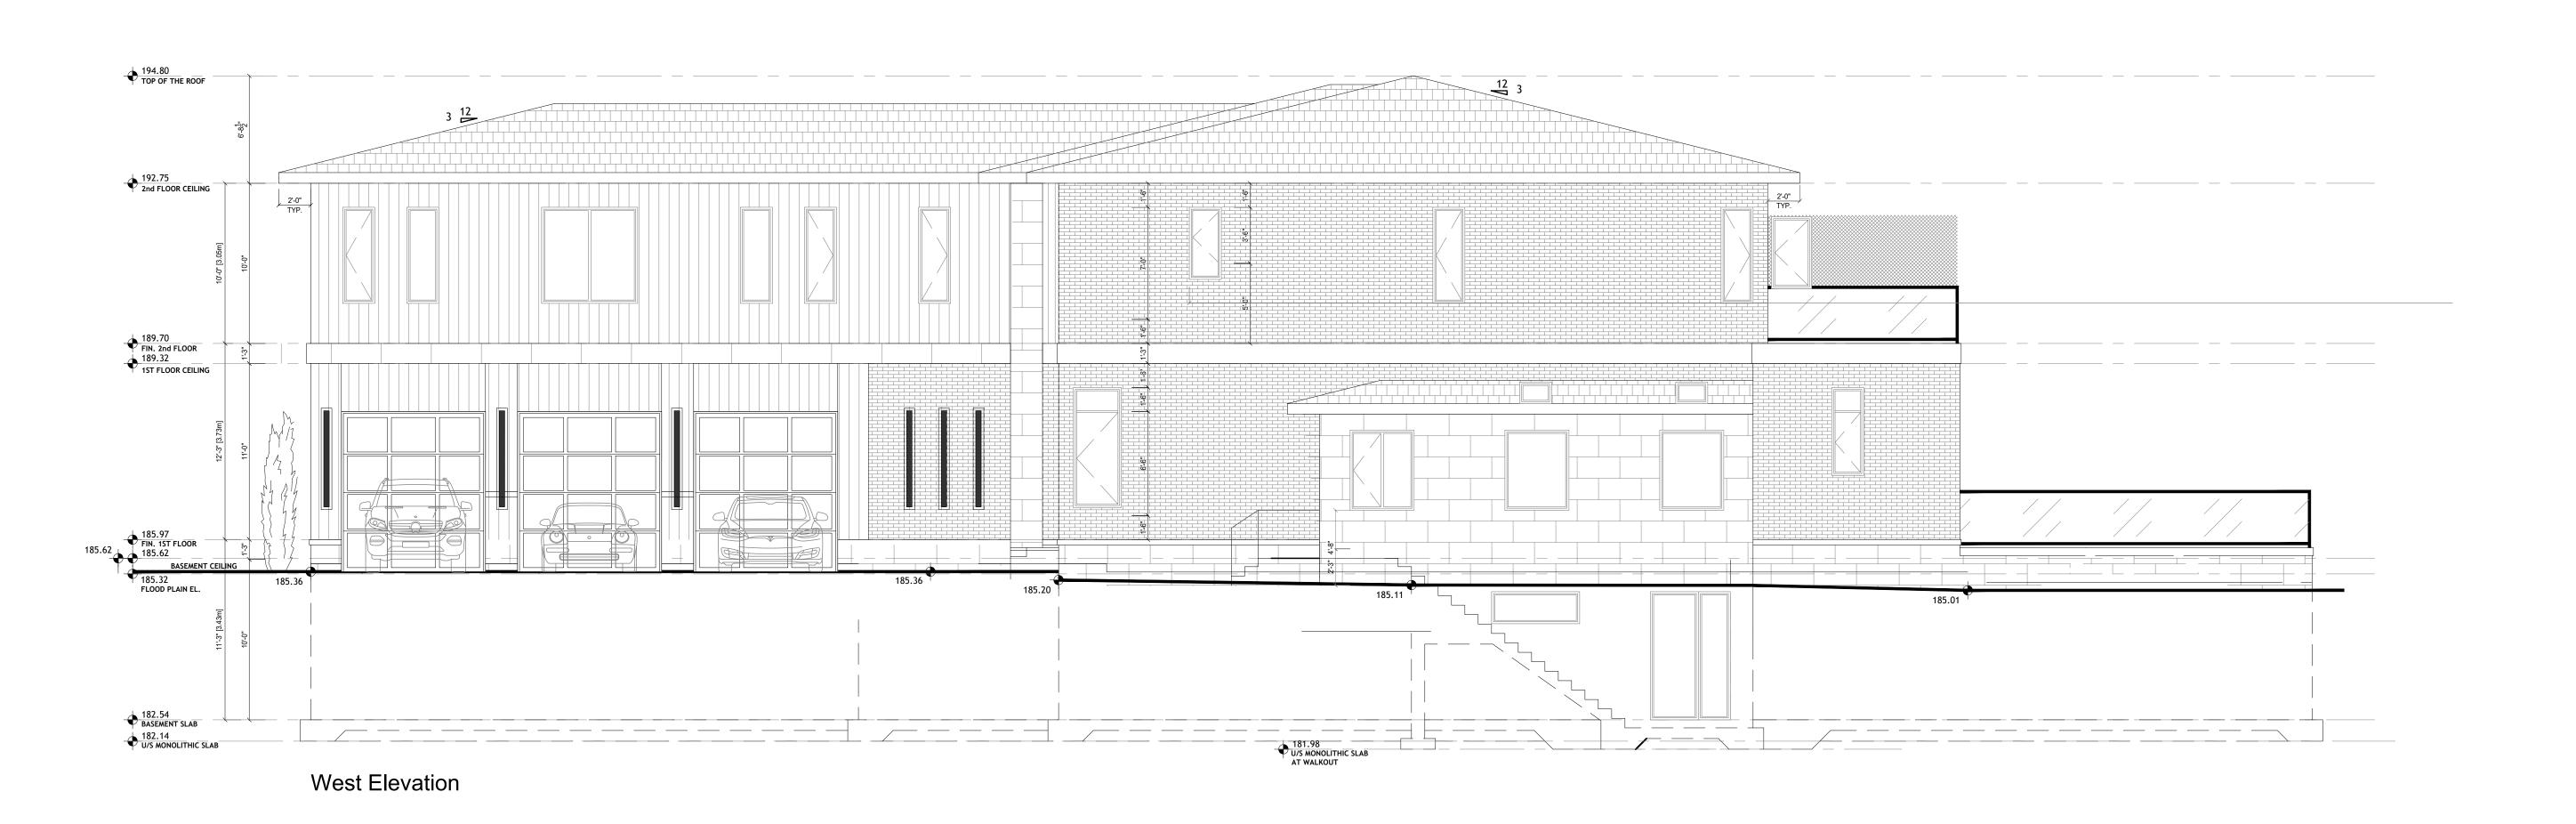



PROJECT NAME: **New Custom House** 

PROJECT ADDRESS: 2035 Embleton Rd. Brampton, ON. L6Y 0E9

FRONT & LEFT ELEVATIONS

DESIGN BY:	RH
DRAWN BY:	JT
CHECKED BY:	AG
SCALE:	3/16" = 1'-0"
DATE:	2024/12/28
PROJECT №:	24-699



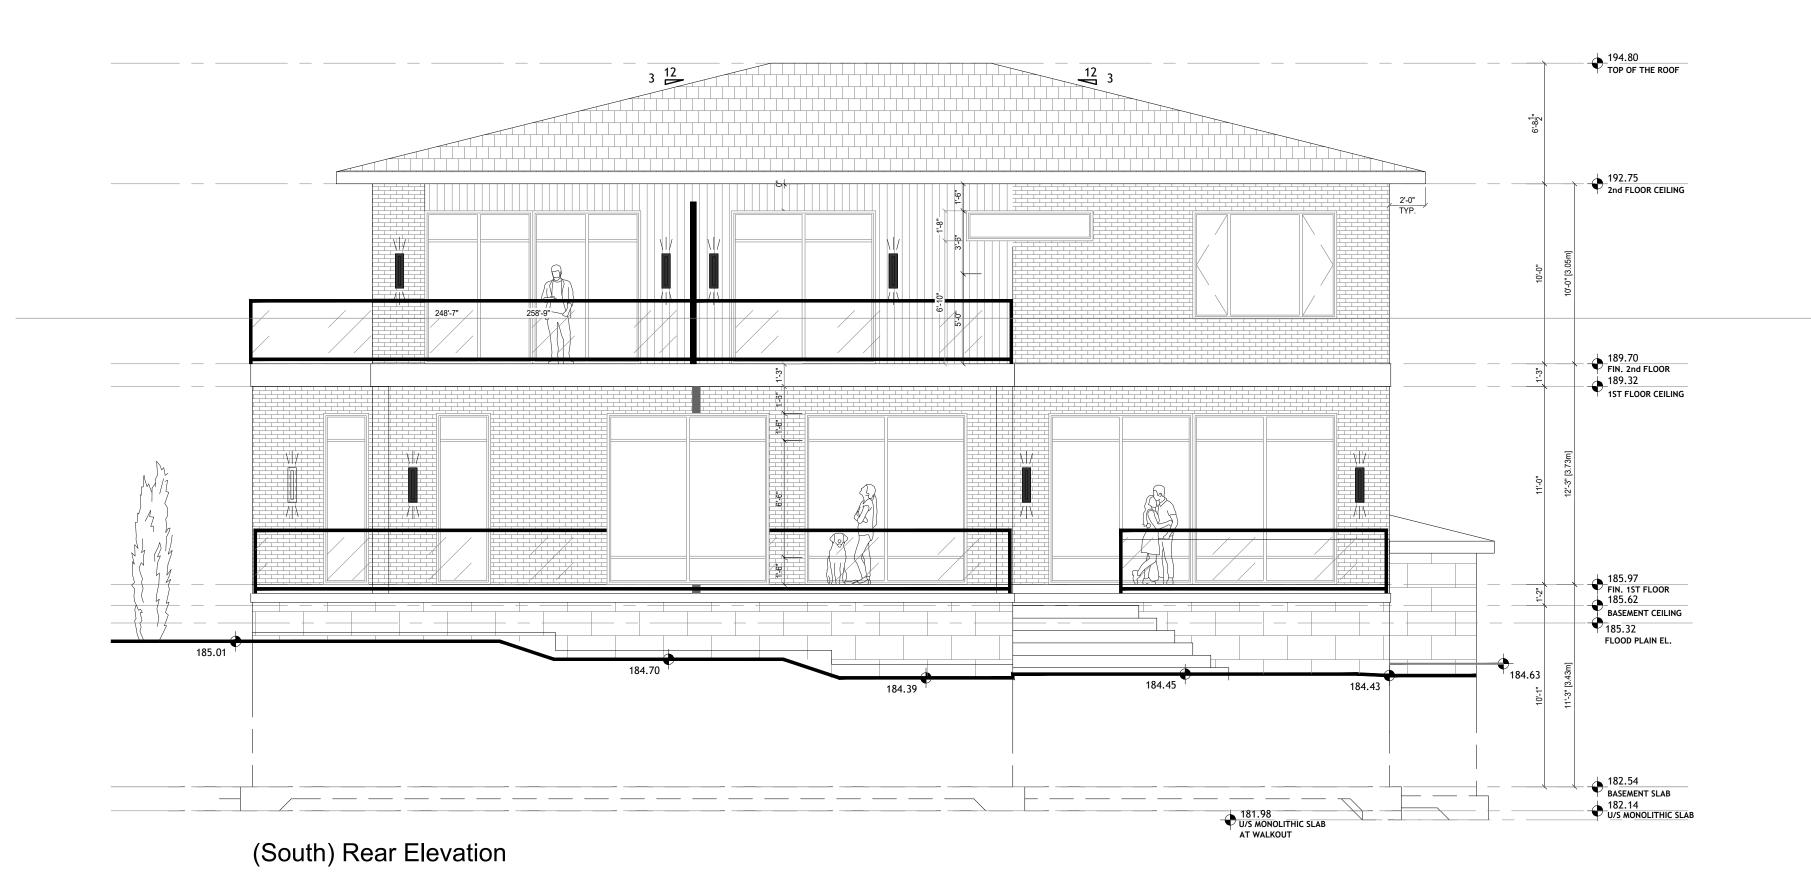



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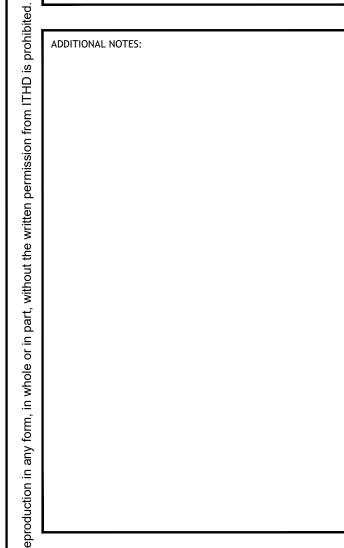
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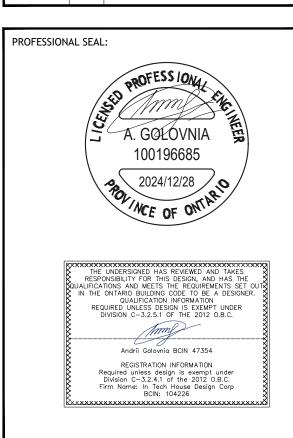
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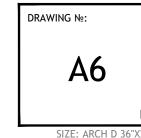





PROJECT ADDRESS: 2035 Embleton Rd. Brampton, ON. L6Y 0E9

REAR & RIGHT ELEVATIONS

DESIGN BY:	RH
DRAWN BY:	JT
CHECKED BY:	AG
SCALE:	3/16" = 1'-0"
DATE:	2024/12/28
PROJECT №:	24-699



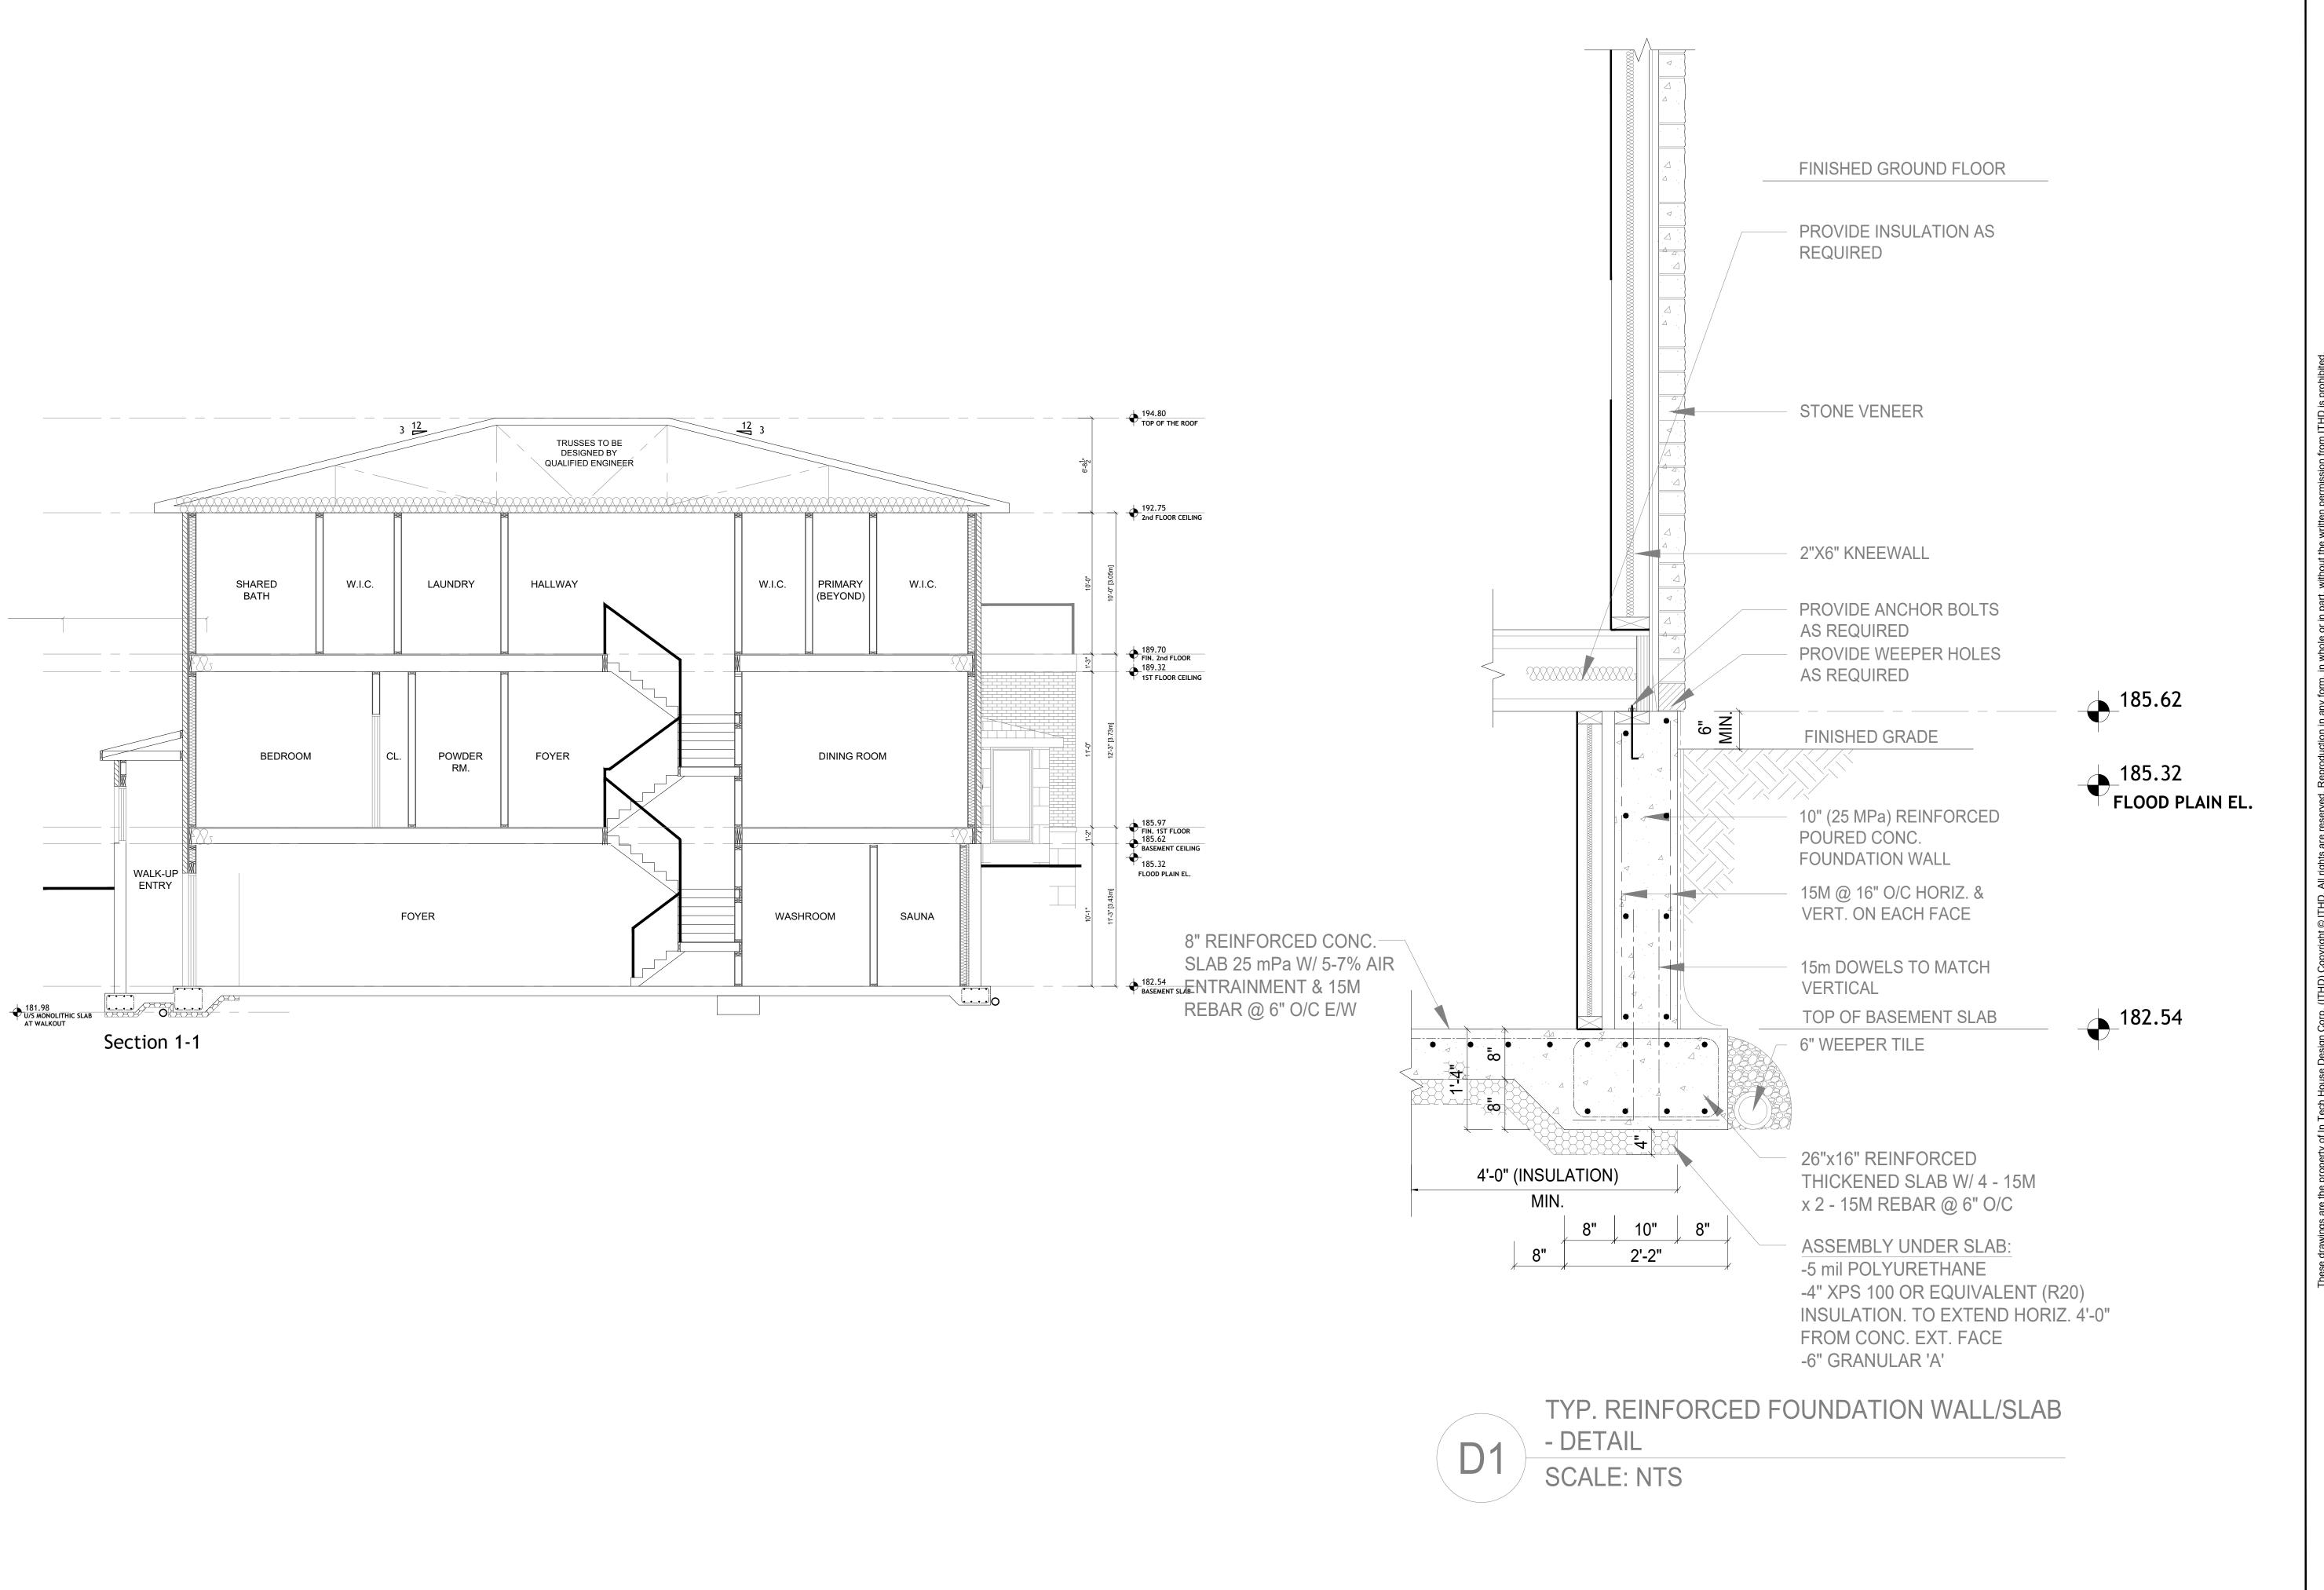



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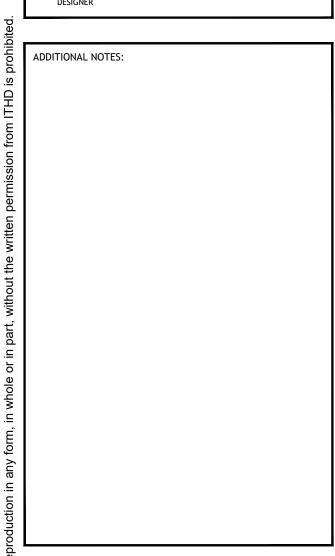
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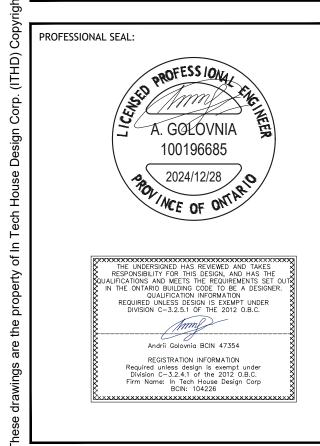
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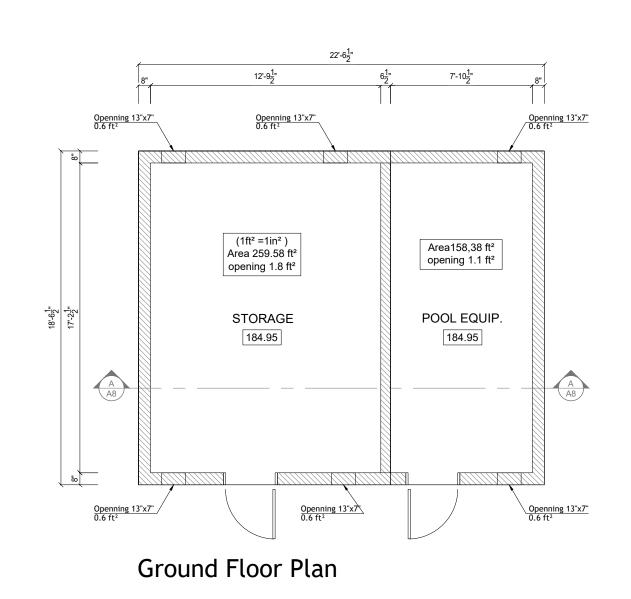



PROJECT NAME: **New Custom House** PROJECT ADDRESS: 2035 Embleton Rd. Brampton, ON. L6Y 0E9


SECTION '1-1' & DETAIL


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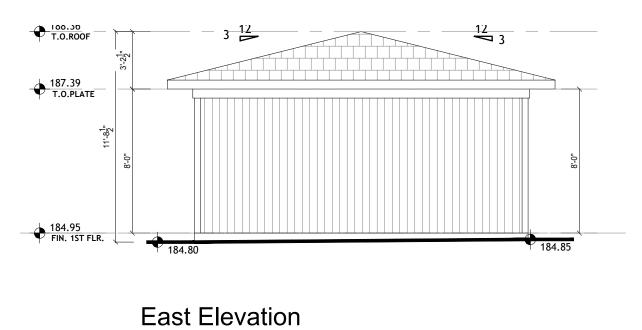







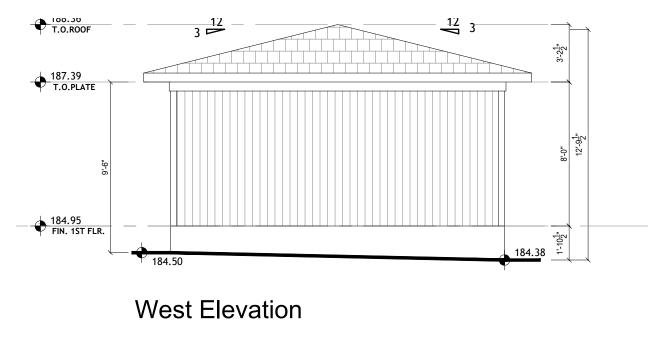


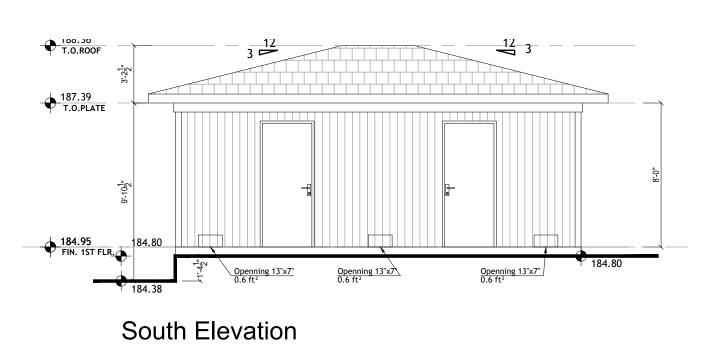Section A-A

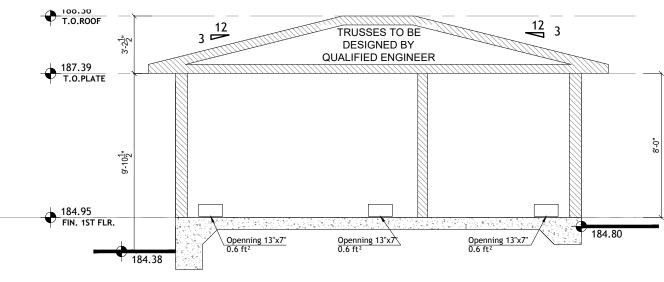

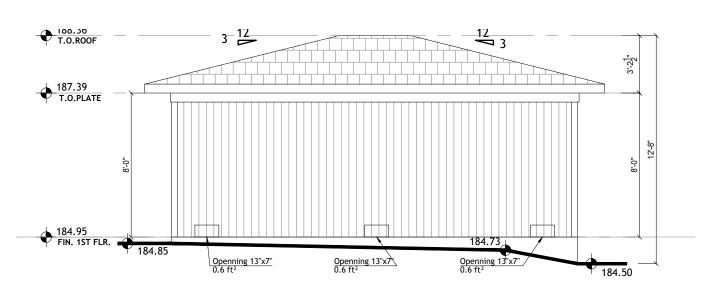

North Elevation

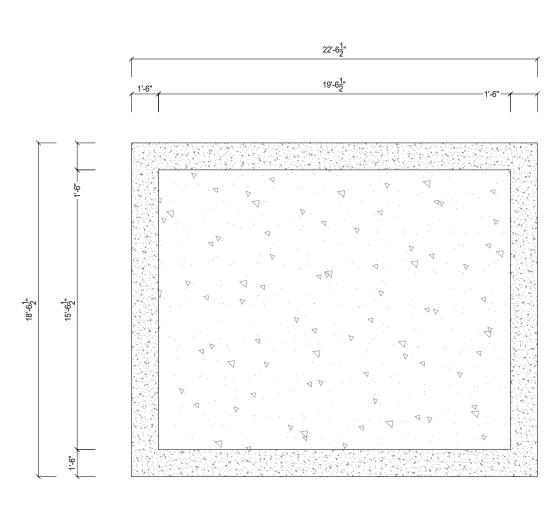

Footing Plan



STORAGE HOUSE PLAN &

DESIGN BY:	RH
DRAWN BY:	JT
CHECKED BY:	AG
SCALE:	3/16" = 1'-0"
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PROJECT №:	24-699



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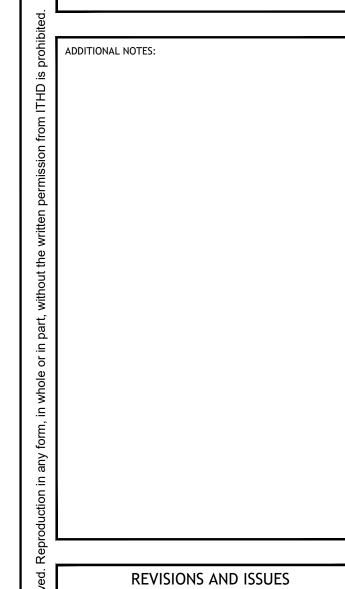
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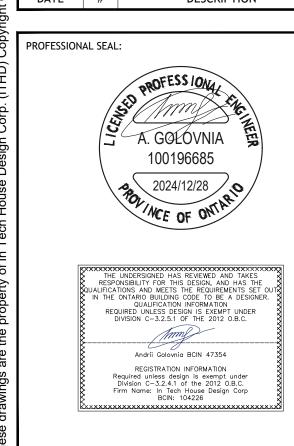
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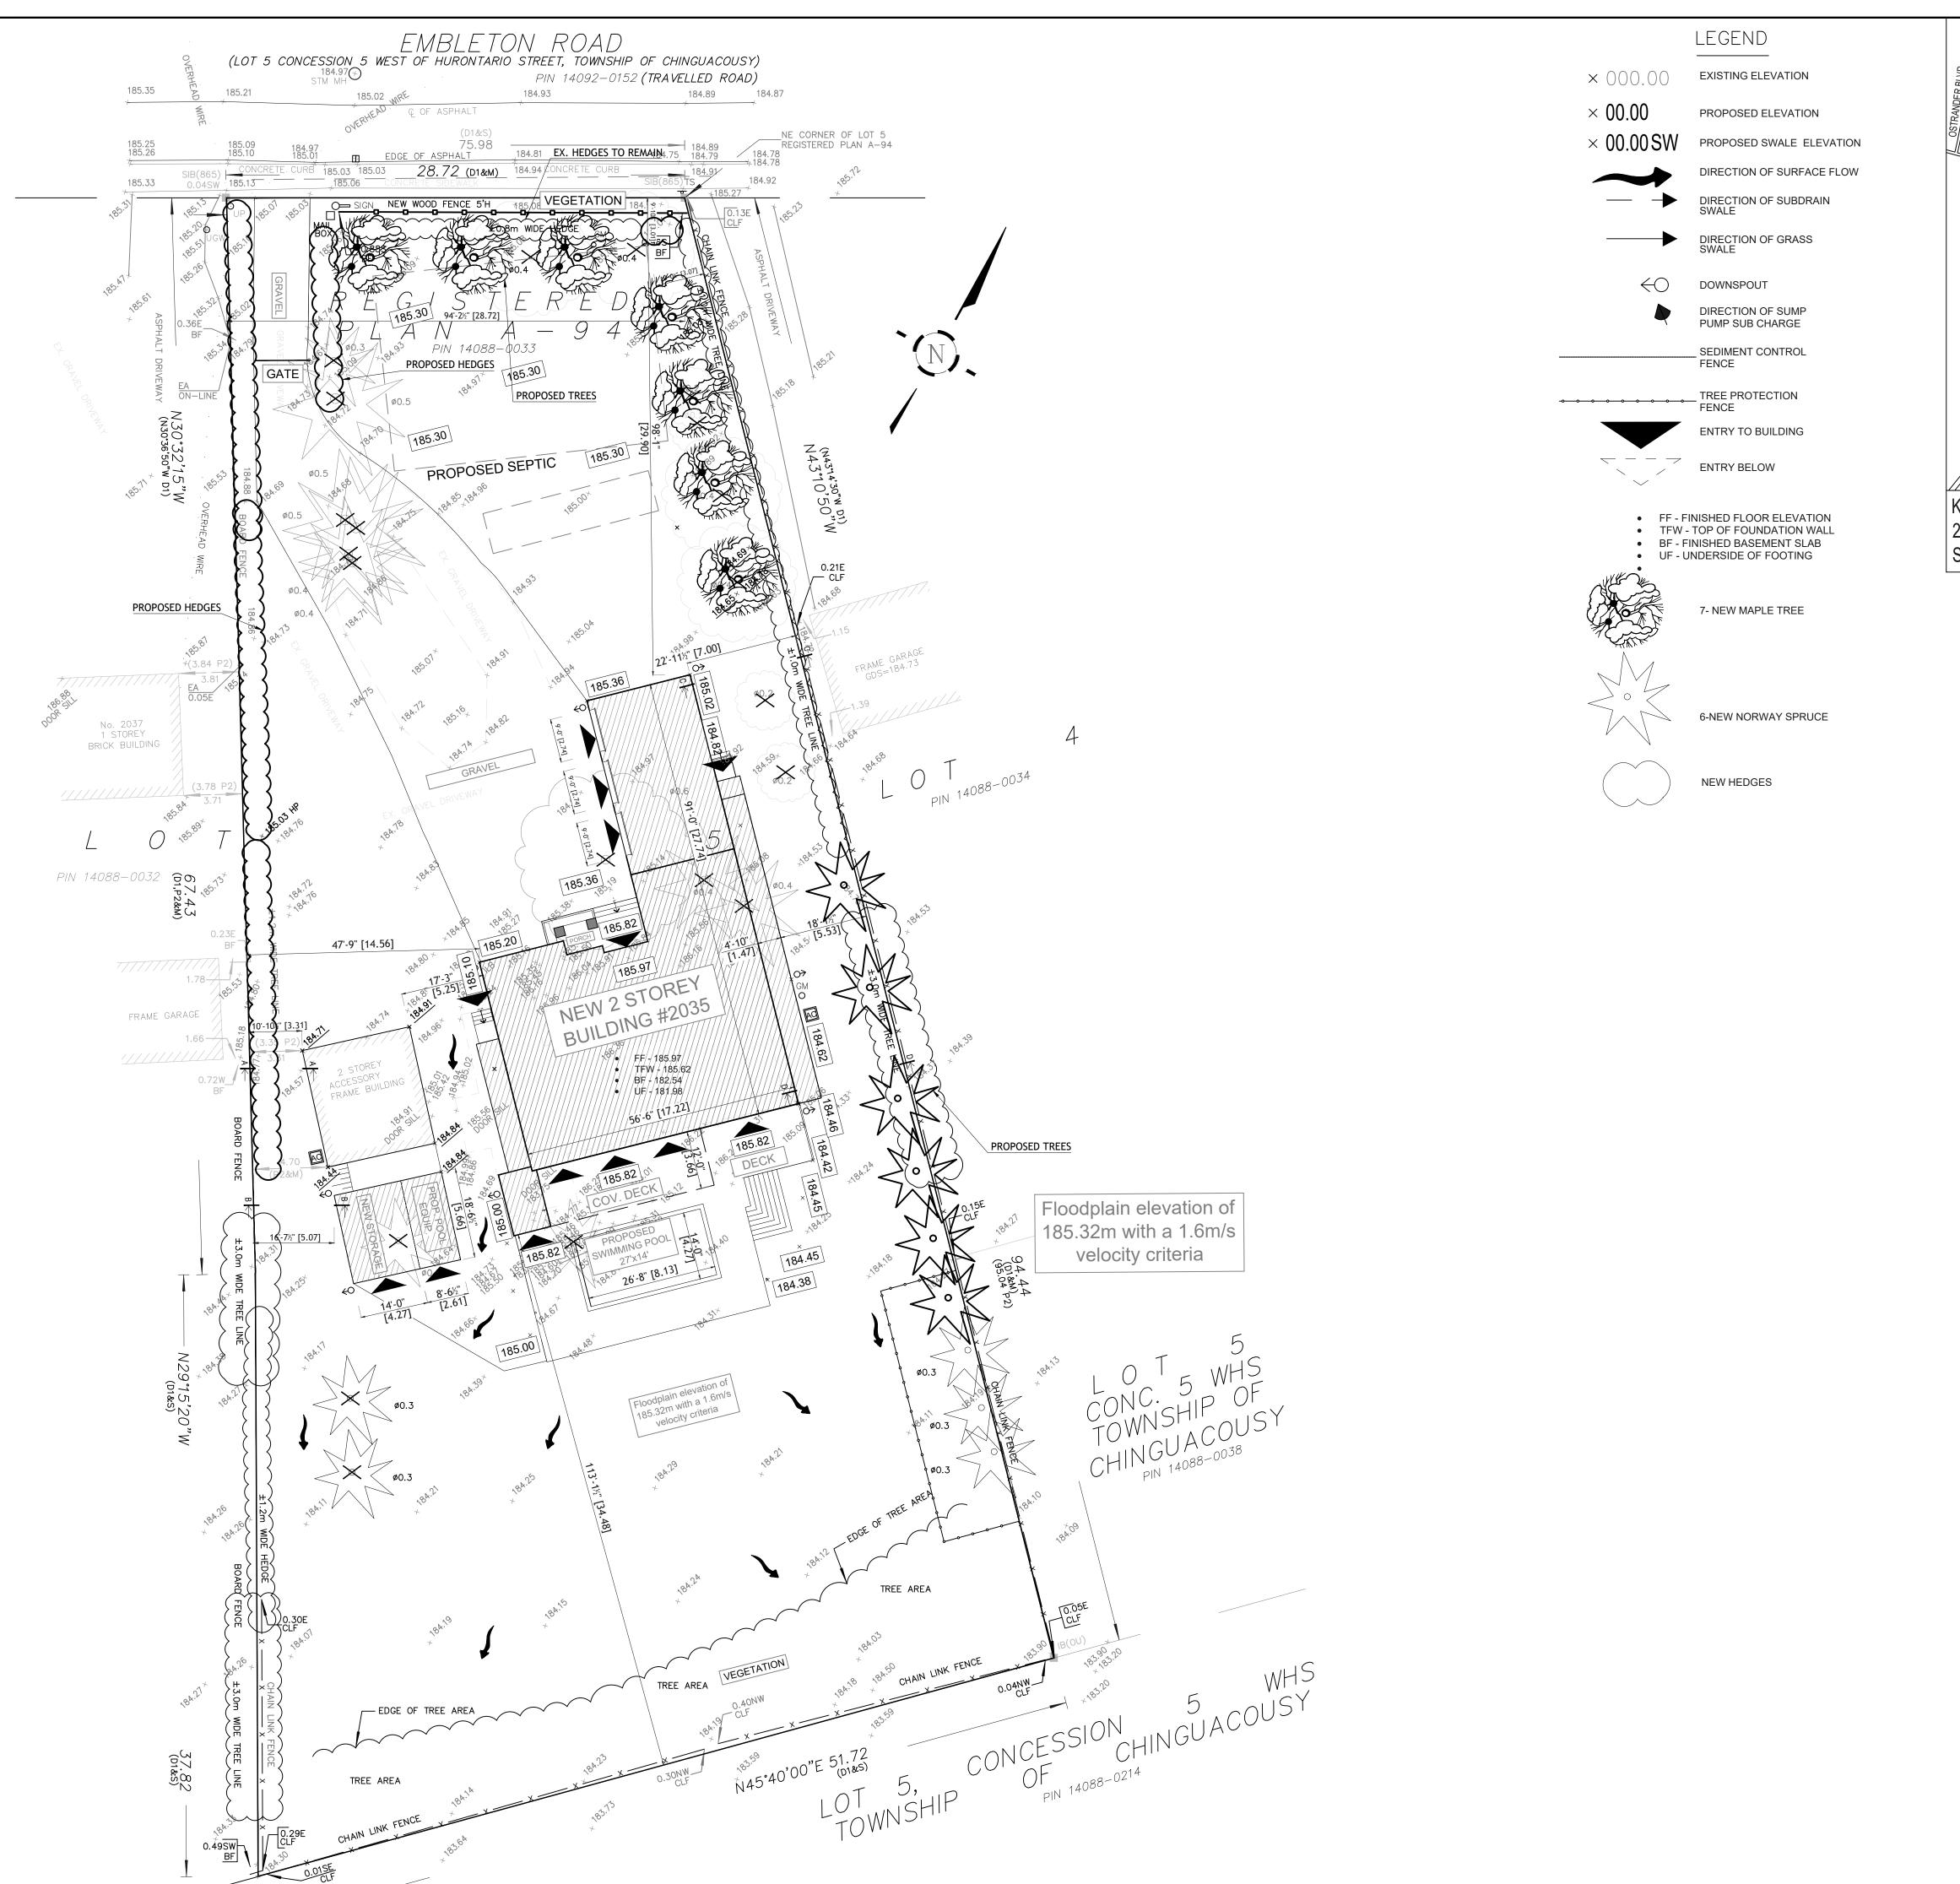





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**ELEVATIONS & SECTION A-A** 

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KEYPLAN: 2035 EMBLETON RD. ON. L6Y 0E9 SCALE: NTS

RD(f12.0;a370)(x1463)		W DWELLING		
(1.2(1.2.3,331.3)(1.1.33)	REQUI	RED	PROPO	SED
	SQ.FT	m²	SQ.FT	m²
LOT AREA			42235.75	3923.8
EX. BUILDING AREA			553.59	51.43
NEW BUILDING AREA			4002.85	371.8
NEW STORAGE AREA			259.45	24.10
NEW POOL EQUIPMENT AREA			158.50	14.73
LOT COVERAGE				11.8
GF	ROSS FLOOR	AREA		
	SQ.FT	m²	SQ.FT	m²
FIRST FLOOR	-	-	2754.50	255.9
SECOND FLOOR	-	-	2654.16	246.5
TOTAL G.F.A.	-	-	5408.66	502.4
FINISHED BASEMENT	-	-	2635.03	244.8
	FT	m	FT	m
AVERAGE ESTABLISH GRADE NORTH (FRONT)				185.
BUILDING HEIGHT NORTH		10.60	30'-11 ½"	9.43
(FRONT)		10.00	JU-11 /4	9.43
AVERAGE ESTABLISH GRADE SOUTH (REAR)				185.
BUILDING HEIGHT SOUTH		10.60	30'-11 ½"	9.43
(REAR)		10.00	JU-11/4	ə.43 ————
AVERAGE ESTABLISH GRADE EAST SIDE				185.
BUILDING HEIGHT EAST SIDE		10.60	30'-11 1/4"	9.43
AVERAGE ESTABLISH GRADE WEST SIDE				185.
BUILDING HEIGHT WEST				
SIDE		10.60	30'-11 1/4"	9.43
			4001.01	
BUILDING LENGTH			103'-0"	31.
BUILDING DEPTH  LOT FRONTAGE			103'-0" 94'-2 ½"	31. 28.
			· <u>-</u>	
	SETBACKS			
FDONT	FT	m 12.00	FT 09' 4"	m
FRONT REAR		7.50	98'-1" 113'-1 ½"	29.90
WEST SIDE		7.50	47'-9"	14.56
EAST SIDE		15	18'-1 ½"	5.53
<u></u>	LANDSCAPII		/ _	3.30
	REQUI		PROPO	SED
	SQ.FT	m²	SQ.FT	m²
FRONT YARD LANDSCAPING AREA			15061.99	1399.2
SOFT LANDSCAPE AREA			10543.56	989.5
HARD LANDSCAPE AREA	-	-	4518.43	419.7
		70%		70
REAR YARD AREA BREAK DOWN				
COVERED DECK			416.00	38.65
OWNWAND SOO!			440.00	
SWIMMING POOL			443.89	41.24

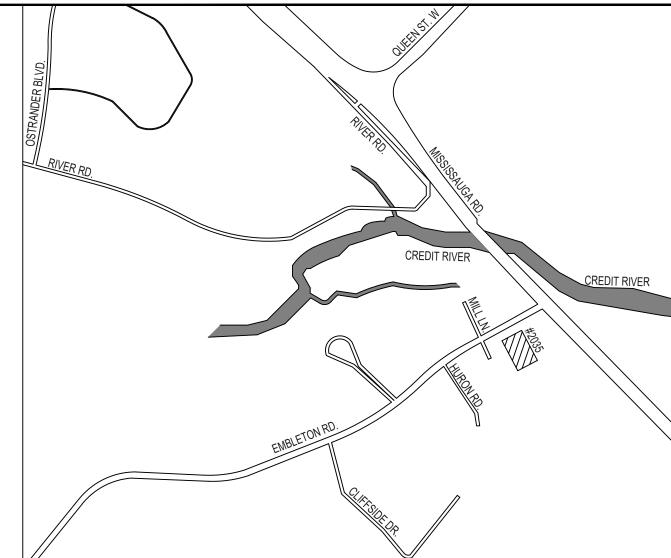

Phone: +1(647)478-5055 Toll free: +1(885)561-4161 info@ithd.ca

GENERAL NOTES

THE CONTRACTOR SHALL VERIFY ALL DIMENSIONS AT THE SITE AND REPORT ANY DISCREPANCIES TO THE CONSULTANT BEFORE PROCEEDING WITH WORK

DO NOT SCALE DRAWINGS

ALL WORKS IS TO BE CARRIED OUT ACCORDING TO THE ONTARIO BUILDING CODE 2012 AND BY-LAWS

ALL EXISTING SURFACES AND STRUCTURES ADJACENT TO THE PROPOSED WORK ARE TO BE PROTECTED DURING DEMOLITION AND CONSTRUCTION

THE CONTRACTOR AND/OR THE OWNER SHALL BE RESPONSIBLE FOR THE ARRANGEMENT OF ALL NECESSARY INSPECTIONS AND FOLLOW INSPECTION SCHEDULES

ALL TEMPORARY WORKS INCLUDING SHORING ARE TO BE PROVIDED

READ THIS DRAWING IN CONJUNCTION WITH OTHER DRAWINGS: ARCHITECT, STRUCTURAL, MECHANICAL, ELECTRICAL AND OTHER RELEVANT DRAWINGS AND SPECIFICATIONS

THESE DRAWING MUST NOT BE DUPLICATED IN ANY FORM, OR USE FOR ANY OTHER PROJECTS, WITHOUT WRITTEN CONSENT OF THE


ADDITIONAL NOTES:

REVISIONS AND ISSUES 2025/08/07 4 REVISED PER CITY COMMENTS 2024/12/28 3 REVISED PER CITY COMMENTS 2024/11/07 2 REVISED PER CITY COMMENTS

2024/09/25 1 ISSUED FOR CVC PERMIT

DESCRIPTION

DATE #

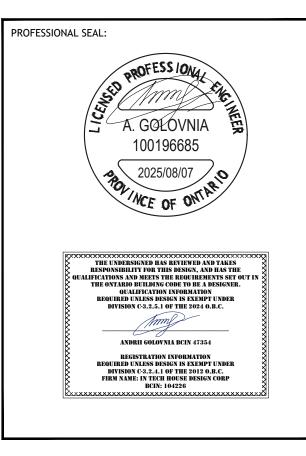

PROJECT NAME: New Custom House

PROJECT ADDRESS: 2035 Embleton Rd. Brampton, ON. L6Y 0E9

Site Plan & Key Plan

DESIGN BY: DRAWN BY: CHECKED BY: 1:200 2025.08.05

PROJECT №:

DRAWING №: SP-1

# Stage 1 and 2 Archaeological Assessment

2035 Embleton Road, Part of Lot 5, Registered Plan A-94 (Formerly Part of Lot 5, Concession 5 West of Centre Road, Geographic Township of Chinguacousy [South], Peel County), Now in the City of Brampton, Regional Municipality of Peel, Ontario

Prepared by



2-Jul-25

MCM Archaeological Consulting License # P1034 (Dr. Sheryl Spigelski) MCM P.I.F. # P1034-0024-2025

**Original Report** 

#### **EXECUTIVE SUMMARY**

**AS&G** Archaeological Consulting Inc. (AS&G) was contracted to conduct a Stage 1 and 2 Archaeological Assessment of 2035 Embleton Road, Part of Lot 5, Registered Plan A-94 (Formerly Part of Lot 5, Concession 5 West of Centre Road, Geographic Township of Chinguacousy [South], Peel County), Now in the City of Brampton, Regional Municipality of Peel, Ontario. The development project was triggered by the *Planning Act* and the Archaeological Assessment was done in advance of the construction of a new two-storey dwelling, detached two-storey garage and associated gravel driveway, driveway gate, backyard deck, septic system, swimming pool, pool equipment storage shed, and landscaping.

A Stage 1 Background Study of the property was conducted to provide information about the property's geography, history, previous archaeological fieldwork, and current land condition, in order to evaluate and document in detail the property's archaeological potential and to recommend appropriate strategies for Stage 2 Survey. The Stage 1 Background Stduy established that the Study Area retained archaeological potential.

A Stage 2 Property Assessment was conducted to document all archaeological resources on the property, to determine whether the property contains archaeological resources requiring further assessment, and to recommend next steps. The characteristics of the Study Area dictated that the Stage 2 Assessment be performed by a test-pitting survey at standardized five metre intervals throughout the Study Area.

The Stage 1 Background Study found that the Study Area exhibits potential for the recovery of archaeological resources of cultural heritage value and concluded that the Study Area requires a Stage 2 Assessment. The Stage 2 Property Assessment, which consisted of a test-pit survey performed at standardized five metre intervals, did not result in the identification of archaeological resources within the property. The report recommends that no further Archaeological Assessment of the Study Area (Map 6) is required.



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#### **PROJECT PERSONNEL**

Project Manager: Dr. Sheryl Spigelski (P1034)

Project Director: Mr. Norbert Stanchly (R149)

Field Director: Mr. Norbert Stanchly

Field Archaeologists: Mr. Peter Zubrzycki (A1301)

Report Preparation: Dr. Rhan-Ju Song (P1345)

Mr. Norbert Stanchly

Mr. Pete Demarte (R1073)

Dr. Sheryl Spigelski

Graphics: Mr. Pete Demarte

Mr. Norbert Stanchly



#### INTRODUCTION

The Ontario Heritage Act, R.S.O. 1990 c. O.18, requires anyone wishing to carry out archaeological fieldwork in Ontario to have a license from the Ministry of Citizenship and Multiculturalism (MCM). All licensees are to file a report with the MCM containing details of the fieldwork that has been done for each project. Following standards and guidelines set out by the MCM is a condition of a licence to conduct archaeological fieldwork in Ontario. **AS&G Archaeological Consulting Inc. (AS&G)** confirms that this report meets ministry report requirements as set out in the 2011 Standards and Guidelines for Consultant Archaeologists and is filed in fulfillment of the terms and conditions an archaeological license.

#### 1.0 PROJECT CONTEXT

This section of the report will provide the context for the archaeological fieldwork, including the development context, the historical context, and the archaeological context.

#### 1.1 Development Context

**AS&G** was contracted to conduct a Stage 1 and 2 Archaeological Assessment of 2035 Embleton Road, Part of Lot 5, Registered Plan A-94 (Formerly Part of Lot 5, Concession 5 West of Centre Road, Geographic Township of Chinguacousy [South], Peel County), Now in the City of Brampton, Regional Municipality of Peel, Ontario. The subject area is a trapezoid-shaped property approximately 0.40 hectares in size, measuring approximately 52 metres east-west by 105 metres north-south. It is bound by Embleton Road to the north, farm fields to the south, and residential properties to the east and west.

The Study Area is comprised of a single residential property with detached garage, associated gravel driveways, grass lawns, bushes, and trees. The development project was triggered by the *Planning Act* and the Archaeological Assessment was done in advance of the construction of a new two-storey dwelling, detached two-storey garage and associated gravel driveway, driveway gate, backyard deck, septic system, swimming pool, pool equipment storage shed, and landscaping.

Permission to access the property to conduct all required archaeological fieldwork activities, including the recovery of artifacts was given by the landowner and their representative.



#### 1.2 Historical Context

In advance of the Stage 2 Assessment, a Stage 1 Background Study of the property was conducted in order to document the Study Area's archaeological and land use history and present condition. Several sources were referenced to determine if features or characteristics indicating archaeological potential for Pre-Contact and Post-Contact resources exist within the property. These included information about the property's geography, history, previous archaeological fieldwork, current land condition, and contemporary satellite imagery, and historic atlas maps.

In Ontario, the framework for determining the presence of archaeological potential is taken from the *Standards and Guidelines for Consultant Archaeologists* (MCM 2011, Sections 1.3.1 & 1.3.2). Characteristics indicating archaeological potential include the near-by presence of previously identified archaeological sites, primary and secondary water sources, features indicating past water sources, accessible or inaccessible shoreline, pockets of well-drained sandy soil, distinctive land formations that might have special or spiritual places (such as waterfalls, rock outcrops, caverns, mounds, promontories and their bases, as well as resource areas that include food or medicinal plants, or scarce raw materials), early Euro-Canadian industry, areas of early Euro-Canadian settlement, early historical transportation routes, properties listed on a municipal register or designated under the *Ontario Heritage Act* as a federal, provincial, or municipal historic landmark or site; as well as properties that local histories or informants have identified as important locations for historical events, activities, and/or occupations.

Archaeological potential can be determined not to be present for either the entire property or a part of it when the area under consideration has been subject to extensive and deep land alterations that have severely damaged the integrity of any archaeological resources. This is commonly referred to as 'disturbed' or 'disturbance', and may include: quarrying, major landscaping involving grading below topsoil, building footprints, and sewage and infrastructure development. Archaeological potential is not removed where there is documented potential for deeply buried intact archaeological resources beneath land alterations, or where it cannot be clearly demonstrated through background research and property inspection that there has been complete and intensive disturbance of an area. Where complete disturbance cannot be demonstrated in Stage 1, it will be necessary to undertake Stage 2 Assessment.

The Background Study determined that the following features or characteristics indicate archaeological potential for the property:



- There are twenty-eight (28) known archaeological sites within a one-kilometre radius of the property limits.
- There are four (4) known archaeological sites within a 300 metre radius of the property limits.
- The subject property is located less than 100 metres from the Credit River, as well as a tributary of the Credit River.
- The current property limits and Study Area are adjacent to an early Euro-Canadian transportation route (present-day Embleton Road).
- The property is situated within the Peel Plain physiographic region. The Peel Plain is a level-to-undulating area of clay soil that covers an area of approximately 77,700 hectares across the central portions of the Regional Municipalities of York, Peel, and Halton (Chapman and Putnam 1984). The Peel Plain has a general elevation of between 500 and 750 feet above sea level with a gradual uniform slope towards Lake Ontario. The Peel Plain is sectioned by the Credit, Humber, Don, and Rouge Rivers with deep valleys, as well as a number of other streams such as the Bronte, Oakville, and Etobicoke Creeks. These valleys are in places bordered by trains of sandy alluvium. The region is devoid of large undrained depressions, swamps, and bogs, though nevertheless, the dominant soil possesses imperfect drainage (Chapman and Putnam 1984).

In summary there are areas of archaeological potential within the property. The Stage 1 Background Study identified that the property retains archaeological potential. The Stage 1 Background Study did not identify any areas of previously disturbed lands within the property that have severely damaged the integrity of archaeological resources and have removed archaeological potential, with the exception of the existing residential structures.

## 1.2.1 Indigenous Historical Context

The property is situated in an area of Ontario that has a rich and diverse cultural history that extends back at least 11,000 years ago. To provide context for this report, the settlement history is summarized below.

# 1.2.1.1 Pre-Contact Indigenous Period

Drawn from Ellis and Ferris (1990), Table 1 provides a general outline of the preand post-contact cultural history. The Study Area is situated in an area of Ontario that has evidence of extended periods of human settlement, dating back at least 11,000 years.



Table 1: General Archaeological Chronology for South-Central Ontario

Period	Archeological/Material Culture	Date Range	Comments				
PALEO	PALEO						
Early	Gainey, Barnes, Crowfield, Fluted Points	11,000-10,500 BP	Big game hunters, i.e., caribou				
Late	Holcombe, Hi-Lo, Lanceolate	10,500-9,500 BP	Paleo Point Technology				
ARCHAIC							
Early	Bifurcate-base, Nettling, Side Notched	9,800-8,000 BP	Nomadic hunters/gathers				
Middle	Stanley, Kirk, Brewerton, Laurentian	8,000-4,000 BP	Focused seasonal resource areas				
Late	Lamoka, Genesee, Innes, Crawford Knoll	4,500-2,500 BP	Polished/ground stone tools				
	Hind	3,000-2,600 BP	Burial ceremonialism				
WOODLA	AND						
Early	Meadowood, Middlesex	2,800-2,000 BP	Introduction of pottery, elaborate burials				
Middle	Princess Point, Saugeen, Point Peninsula	2,000-950 BP	Long-distance trade, burial mounds, horticulture				
Late	Pickering, Uren, Middleport (Anishinabek/Iroquois), Algonkian-Wendat Alliance	950-300 BP	Emergence of agricultural villages Large, palisaded villages Trade, alliances, and warfare				
HISTORIC	HISTORIC						
	Huron, Neutral, Petun, Odawa, Ojibwa Six Nations Iroquois, Ojibwa, Mississauga	350 BP-Present	Mission villages and Reserves				
	Euro-Canadian		European settlement				

#### 1.2.1.2 Paleo

Archaeological evidence demonstrates that people inhabited South-central Ontario just after the end of the Wisconsin Glacial Period, approximately 11,000 years ago. This early settlement period is known as the Paleo Period (Ellis and Deller 1990, Jackson 1998, 2019). Based upon current archaeological knowledge, Indigenous groups originally living south of the Great Lakes migrated to the area. Small family groups, i.e., less than 35 individuals, used fluted and lanceolate points. These groups are believed to have maintained a seasonal pattern of mobility over vast territories, ranging up to 200 km annually (Ellis and Deller 1990, Jackson 1998, 2019).

These Early Paleo sites are typically located in elevated locations, with well-drained loamy soils. Many known sites found on former beach ridges, associated with glacial lakes (Ellis and Deller 1990). These sites were likely formed when they were occupied for short increments, over the course of many years, possibly as



communal hunting camps. Their locations appear conducive to hunting migratory mammals, such as caribou (Ellis and Deller 1990).

During the Late Paleo Period (10,500-9,500 BP), the south-central Ontario environment started to become dominated by closed coniferous forests, with only some minor deciduous elements. The hunting landscape had also changed, as many of the large game species that had been hunted in the early part of the Paleo Period either migrated further north, or in some cases, had become extinct, i.e., mastodons and mammoths (Ellis and Deller 1990).

#### 1.2.1.3 Archaic Period

During the Early Archaic Period (9,800-8,000 BP), the jack and red pine forests that characterized the Late Paleo environment, were replaced by forests of white pine, with a few correlated deciduous trees (Ellis et al. 1990). Based on material culture, the Early Archaic Period is recognized by the shift to side and cornernotched projectile points (Ellis et al. 1990). Other notable innovations, include the introduction of ground stone tools such as celts and axes. These tools suggest that there was a woodworking industry. Additionally, the presence of these, often large and not easily portable tools, suggests that there may have been a reduction in seasonal movement. However, the current understanding of the Period suspects that population densities were still low, and seasonal territories were still large (Ellis et al. 1990).

During the Middle Archaic Period (8,000-4,000 BP), it is speculated that there was an increase in regional population growth, which precipitated a decrease in overall seasonal migration territory. Additionally, as a consequence of population growth, a shift in subsistence patterns occurred, as more people needed to be supported from the resources contained within the smaller area (Ellis et al 1990). Thus, the Middle Archaic is characterized by the diversification of toolkits and diets, with the introduction of net-sinkers and bannerstones, as well as stone tools specifically designed for the preparation of wild plant foods. The appearance of net-sinkers suggests that fishing was becoming an important aspect of the subsistence economy. In contrast, bannerstones were carefully crafted ground stone devices that served as a counterbalance for atlatls or spear-throwers, used in hunting game (Ellis et al 1990).

Another characteristic of the Middle Archaic Period is an increased reliance on local, often poor-quality chert resources, for the manufacturing of projectile points. Unlike earlier periods, when nomadic groups occupied vast territories, at least once in their seasonal migration it was possible for them to visit a primary outcrop of high-quality chert. However, during the Middle Archaic Period, groups inhabited smaller territories, which usually did not contain a source of high-quality raw material, and were forced to use the locally sourced, poorer quality resources



(Ellis et al. 1990). It was also during the latter part of the Middle Archaic Period, that long-distance trade routes began to develop, which spanned the northeastern part of the continent. For instance, copper tools, which were manufactured from a source located northwest of Lake Superior, were being widely traded (Ellis et al. 1990).

The trend towards a decreasing territory size and a broadening subsistence economy continued during the Late Archaic Period (4,500-2,500 BP). Similarly, archaeologically Late Archaic sites are more numerous than Early or Middle Archaic sites, which is correlated to an increasing population (Ellis et al. 1990). With the trend towards larger groups, the first cemeteries have also been dated to the Late Archaic Period. Prior to this, individuals were interred close to the location where they died. Furthermore, during the Late Archaic Period, if an individual died while away from their home territory, the bones would be kept until they could be placed in the group cemetery. Therefore, it is not unusual to find disarticulated skeletons, and/or skeletons lacking minor elements, i.e., fingers, toes and/or ribs (Ellis et al. 1990).

The appearance of cemeteries during the Late Archaic Period has been interpreted as a response to increased population densities. The increased populations also demonstrated evidence of regionalized variation in Late Archaic projectile point styles (Ellis et al. 1990). The differences were likely indicative of the different relationships the people had to the land and waters they inhabited. Additionally, trade networks established during the Middle Archaic continued to flourish. For instance, copper native to northern Ontario and marine shell artifacts from as far away as the Mid-Atlantic coast, are frequently encountered as grave goods. Other artifacts such as polished stone pipes and banded slate gorgets, also appear on Late Archaic sites. One of the more unusual and interesting of the Late Archaic artifacts is the birdstone. Birdstones are small, bird-like effigies usually manufactured from green banded slate (Ellis et al. 1990).

#### 1.2.1.4 Woodland Period

For archaeologists, the Early Woodland Period (2,000-2,000 BP) is distinguished from the Late Archaic Period primarily by the addition of ceramic technology. The first pots were crudely constructed, had undecorated thick walls, and were friable. Spence et al. (1990) suggests they were used in the processing of nut oils, which required boiling crushed nut fragments in water and skimming off the oil. As these vessels were not easily portable, individual pots were likely not used for extended periods of time. Additionally, as there are many Early Woodland sites where no pottery was recovered, it has been suggested that these poorly constructed vessels were not utilized by all Early Woodland peoples (Spence et al. 1990).



Other than the limited use of ceramics, there were other subtle differences between the Late Archaic and the Early Woodland Periods. For example, 'popeyes', a protrusion from the side of the head, was added to birdstones. Similarly, a slight modification was made to the thin, well-made projectile points made during the Archaic Period, i.e. Early Woodland variants were side-notched rather than corner-notched (Spence et al. 1990). The trade networks which were established in the Middle and Late Archaic Periods, continued to flourish; however, there appeared to be a decrease in the trade of marine shell during the Early Woodland Period. Projectile points crafted from high quality American Midwest materials, began to be found on southwestern Ontario sites, dated towards the end of the Early Woodland Period (Spence et al. 1990).

The Middle Woodland (2,000-950 BP) is characterized by rich, densely occupied sites, which are usually found bordering major rivers and lakes. While these locations were inhabited periodically by earlier peoples, Middle Woodland sites are significant as they represent long periods of continuous occupations, i.e., hundreds of years (Spence et al. 1990). The shift in settlement pattern created large deposits of artifacts, as the sites appear to have functioned as home bases that were occupied throughout the year. Numerous smaller Middle Woodland sites have been found inland, and likely functioned as specialized camps, for the exploitation of local resources (Spence et al. 1990).

The shift to a more sedentary lifestyle also resulted in a shift in subsistence patterns, comparable to the Early Woodland Period. Although they still relied on hunting and gathering, fish became a predominant diet staple, to meet their growing subsistence needs (Spence et al. 1990). Additionally, the people of the Middle Woodland relied more on ceramic technology, with many being heavily decorated with impressed designs covering the entire exterior surface, and the upper portion of the interior of vessels (Spence at al. 1990).

Material culture changes that occurred in the early portion of the Late Woodland (950-300 BP), include the appearance of triangular projectile point styles, first seen with the Levanna form, and a change to more intricate design patterns on ceramics. Designs included cord-wrapped stick decorated ceramics, which were created using the paddle and anvil forming technique (Bursey 1995; Ferris and Spence 1995; Spence et al. 1990; Williamson 1990).

The Late Woodland Period is marked by two major subsistence innovations, harvesting of wild rice (*Zizania palustris*) throughout south-central and northen Ontario (Jackson et al. 2022), and a reliance on corn (*Zea mays*) horticulture (Crawford et al. 1997; Fox 1990; Martin 2004; Smith 1990; Williamson 1990). Although corn was possibly introduced into southwestern Ontario from the American Midwest as early as 2,500 BP, it was not considered a dietary staple until at three to four hundred years later. From there, corn cultivation gradually spread



into south-central and southeastern Ontario. Thus, the Late Woodland Period is widely accepted as the beginning of a reliance on agriculture, for subsistence. Researchers have suggested that a warming trend, which increased the number of frost-free days, was likely a catalyst for the spread of maize into southern Ontario (Stothers and Yarnell 1977). Additionally, sites have been identified in a wider variety of environments, including riverine, lacustrine and wetlands (Dieterman 2001).

## 1.2.1.5 Post-Contact History

At the end of the 17th and beginning of the 18th century, the dispersal of several lroquoian-speaking peoples by the New York State Iroquois, coupled with the return of the Algonkian-speaking groups from Northern Ontario, formed the post-contact Indigenous occupation landscape of southern Ontario (Schmalz 1991). As European settlers encroached on traditional Indigenous territories, settlement sizes, populations, and material culture shifted. Despite this shift, there remains a continuity from ancient Indigenous groups to the communities written about in historical accounts (Ferris and Spence 2009). Thus, it should be noted that the Indigenous peoples of southern Ontario have deposited archaeologically significant resources throughout the province, demonstrating a shared traditional and continuing history, regardless of whether their presence is recorded in historic Euro-Canadian documents.

The Study Area is located within the lands included in the Head of the Lake Purchase, also known as Treaty 14. A day after the Toronto Purchase was signed on August 1, 1805 by representatives of the Crown and certain Mississauga peoples (Government of Canada 1805), a provisional agreement was reached to sell the lands immediately west of the lands included in the Toronto Purchase (MCFN 2020). Treaty 14, officially signed on September 5, 1806, covered 85,000 acres of land, which commenced:

...at the eastern bank of the mouth of the River Etobicoke, being on the limit of the western boundary line of the Toronto purchase in the year of Our Lord, one thousand seven hundred and eighty-seven; then north twenty-two degrees west six miles; then south thirty-eight degrees west twenty-six miles, more or less, until it intersects a line on a course north forty-five degrees west produced from the outlet at Burlington Bay being the north-eastern boundary line of the Township of Flamborough East, and of the purchase in the year of Our Lord one thousand seven hundred and ninety two; then along the said line south forty-five degrees east two hundred and thirty-three chains and fifty-eight links, more or less, to the lands granted to Captain Joseph Brant; then north forty-five degrees east one hundred and twenty-seven chains, to the northerly angle of said lands; then south-forty five degrees east two hundred and ninety-three chains, more or less, to



Lake Ontario; then north-easterly along the water's edge of said lake to the eastern bank of the River Etobicoke...

(Government of Canada 1806)

In return for these lands, the Mississaugas were to receive £1,000 of trade goods and sole fishing rights along the Credit River, Etobicoke River, Twelve Mile Creek, and Sixteen Mile Creek (MCFN 2020).

The Williams Treaties also had broad implications for the First Nation Communities in Ontario. The Treaties were signed on October 31 and November 15, 1923, by: Commissioner Angus Seymour Williams, representing the Dominion of Canada; Robert Victor Sinclair and Uriah McFadden, representing the Province of Ontario; the Anishinaabe Chippewa of Simcoe (First Nation Communities of Beausoleil, Georgina Island, and Rama); and the Anishinaabe Michi Saagig of the north shore of Lake Ontario (First Nation Communities of Alderville, Curve Lake, Hiawatha, and Scugog Island) (Government of Canada 1923). The two treaties encompass 12,944,400 acres of land, separated into three distinct tracts. Tract 1 is between the Etobicoke and Trent Rivers, bounded by Lake Ontario's Northern Shore, which then extends north to Lake Simcoe to create Tract 2. Tract 3 includes the area between the Ottawa River and Lake Huron, which is delineated in the North by the Mattawa River-Lake Nipissing and French Line (Government of Canada 1923; Manners 2022). The Williams Treaties were the culmination of almost sixty years of the Chippewa and Mississauga (Michi Saagig) lobbying the Ontario and Canadian governments for protection and respect of their rights to harvest, hunt, fish, and trap on their traditional lands (Manners 2022).

The Williams Treaties were originally designed by the Crown to quell the complaints put forth by the various First Nation communities regarding settlers interfering and encroaching on their traditional lands. Instead, the Williams Treaties effectively obtained large tracts of unceded lands held by the First Nation communities, and removed their rights to harvest, hunt, fish, and trap outside of Reserve lands. Thus, the Treaties led to long-standing disputes between the First Nation Communities and the government, regarding compensation, land, harvesting, and access to traditional lands used for hunting, fishing, and trapping (Government of Canada 2018ab). In 1992, the Chippewa and the Mississaugas filed a lawsuit against the Crown, under the claim that the Crown had not met their financial and legal obligations set forth in the Williams Treaties (Manners 2022). The matter would remain before the courts until 2018, when the Canadian and Ontario Governments formally settled the matter with the First Nation Communities, by including a billion dollars in compensation, the ability to add up to 11,000 acres to their respective reserve land base(s), and the recognition of the First Nation Communities to hunt, fish, harvest, and trap on their traditional lands. Additionally, the Honourable Carolyn Bennett, Minister of Crown-Indigenous Relations, issued a formal apology on behalf of the Government of Canda, in



recognition of the negative impacts the Williams Treaties had on the Chippewas and the Mississaugas (Government of Canada 2018ab; Manners 2022).

## 1.2.2 Oral History

The traditional homelands of the Michi Saagiig (Mississauga Anishinaabeg) encompass a vast area of what is now known as southern Ontario. The Michi Saagiig are known as "the people of the big river mouths" and were also known as the "Salmon People" who occupied and fished the north shore of Lake Ontario where the various tributaries emptied into the lake. Their territories extended north into and beyond the Kawarthas as winter hunting grounds on which they would break off into smaller social groups for the season, hunting and trapping on these lands, then returning to the lakeshore in spring for the summer months.

The Michi Saagiig were a highly mobile people, traveling vast distances to procure subsistence for their people. They were also known as the "Peacekeepers" among Indigenous nations. The Michi Saagiig homelands were located directly between two very powerful Confederacies: The Three Fires Confederacy to the north and the Haudenosaunee Confederacy to the south. The Michi Saagiig were the negotiators, the messengers, the diplomats, and they successfully mediated peace throughout this area of Ontario for countless generations.

Michi Saagiig oral histories speak to their people being in this area of Ontario for thousands of years. These stories recount the "Old Ones" who spoke an ancient Algonquian dialect. The histories explain that the current Ojibwa phonology is the 5<sup>th</sup> transformation of this language, demonstrating a linguistic connection that spans back into deep time. The Michi Saagiig of today are the descendants of the ancient peoples who lived in Ontario during the Archaic and Paleo periods. They are the original inhabitants of southern Ontario, and they are still here today.

The traditional territories of the Michi Saagiig span from Gananoque in the east, all along the north shore of Lake Ontario, and west to the north shore of Lake Erie at Long Point. The territory spreads as far north as the tributaries that flow into these lakes, from Bancroft and north of the Haliburton highlands. This also includes all the tributaries that flow from the height of land north of Toronto like the Oak Ridges Moraine, and all of the rivers that flow into Lake Ontario (the Rideau, the Salmon, the Ganaraska, the Moira, the Trent, the Don, the Rouge, the Etobicoke, the Humber, and the Credit, as well as Wilmot and 16 Mile Creeks) through Burlington Bay and the Niagara region including the Welland and Niagara Rivers, and beyond. The western side of the Michi Saagiig Nation was located around the Grand River which was used as a portage route as the Niagara portage was too dangerous. The Michi Saagiig would portage from present-day Burlington to the Grand River and travel south to the open water on Lake Erie.



Michi Saagiig oral histories also speak to the occurrence of people coming into their territories sometime between 500-1000 A.D. seeking to establish villages and a corn growing economy – these newcomers included peoples that would later be known as the Huron-Wendat, Neutral, Petun/Tobacco Nations. The Michi Saagiig made Treaties with these newcomers and granted them permission to stay with the understanding that they were visitors in these lands. Wampum was made to record these contracts, ceremonies would have bound each nation to their respective responsibilities within the political relationship, and these contracts would have been renewed annually (see Gitiga Migizi and Kapyrka 2015). These visitors were extremely successful as their corn economy grew as well as their populations. However, it was understood by all nations involved that this area of Ontario were the homeland territories of the Michi Saagiig.

The Odawa Nation worked with the Michi Saagiig to meet with the Huron-Wendat, the Petun, and Neutral Nations to continue the amicable political and economic relationship that existed – a symbiotic relationship that was mainly policed and enforced by the Odawa people.

Problems arose for the Michi Saagiig in the 1600s when the European way of life was introduced into southern Ontario. Also, around the same time, the Haudenosaunee were given firearms by the colonial governments in New York and Albany which ultimately made an expansion possible for them into Michi Saagiig territories. There began skirmishes with the various nations living in Ontario at the time. The Haudenosaunee engaged in fighting with the Huron-Wendat and between that and the onslaught of European diseases, the Iroquoian-speaking peoples in Ontario were decimated.

The onset of colonial settlement and missionary involvement severely disrupted the original relationships between these Indigenous nations. Disease and warfare had a devastating impact on the Indigenous peoples of Ontario, especially the large sedentary villages, which mostly included Iroquoian-speaking peoples. The Michi Saagiig were largely able to avoid the devastation caused by these processes by retreating to their wintering grounds to the north, essentially waiting for the smoke to clear.

Michi Saagiig Elder Gitiga Migizi (2017) recounts:

"We weren't affected as much as the larger villages because we learned to paddle away for several years until everything settled down. And we came back and tried to bury the bones of the Huron but it was overwhelming, it was all over, there were bones all over – that is our story.

There is a misnomer here, that this area of Ontario is not our traditional territory and that we came in here after the Huron-Wendat left or were defeated, but that



is not true. That is a big misconception of our history that needs to be corrected. We are the traditional people; we are the ones that signed treaties with the Crown. We are recognized as the ones who signed these treaties, and we are the ones to be dealt with officially in any matters concerning territory in southern Ontario.

We had peacemakers go to the Haudenosaunee and live amongst them in order to change their ways. We had also diplomatically dealt with some of the strong chiefs to the north and tried to make peace as much as possible. So, we are very important in terms of keeping the balance of relationships in harmony.

Some of the old leaders recognized that it became increasingly difficult to keep the peace after the Europeans introduced guns. But we still continued to meet, and we still continued to have some wampum, which doesn't mean we negated our territory or gave up our territory – we did not do that. We still consider ourselves a sovereign nation despite legal challenges against that. We still view ourselves as a nation and the government must negotiate from that basis."

Oftentimes, southern Ontario is described as being "vacant" after the dispersal of the Huron-Wendat peoples in 1649 (who fled east to Quebec and south to the United States). This is misleading as these territories remained the homelands of the Michi Saagiig Nation. The Michi Saagiig participated in eighteen treaties from 1781 to 1923 to allow the growing number of European settlers to establish in Ontario. Pressures from increased settlement forced the Michi Saagiig to slowly move into small family groups around the present-day communities: Curve Lake First Nation, Hiawatha First Nation, Alderville First Nation, Scugog Island First Nation, New Credit First Nation, and Mississauga First Nation. The Michi Saagiig have been in Ontario for thousands of years, and they remain here to this day.

\*\*This historical context was prepared by Gitiga Migizi, a respected Elder and Knowledge Keeper of the Michi Saagiig Nation\*\*

# 1.2.3 Post-Contact History of Peel County and the Township of Chinguacousy

The County of Peel was formed out of the Home District in 1851, and was named after Sir Robert Peel, a former Home Secretary and Prime Minister of the United Kingdom, who served in office several times between 1822 and 1846. Upon its creation, the County of Peel consisted of the townships of Toronto, Toronto Gore, Chinguacousy, Albion, and Caledon. Within the Home District, Ontario County separated from York and Peel in 1854, and by 1867 Peel County officially separated from York as well, having established its own administrative buildings (PAMA 2023). The county is comprised of several townships and villages and the most notable municipalities are Brampton, Mississauga, and Caledon (Wikipedia 2023). In 1973, the County of Peel was reorganized and renamed as the Regional Municipality of Peel by the government of Ontario.



The Township of Chinguacousy was part of the 'Second Purchase of the Mississauga Tract' in 1818. It was surveyed by Richard Bristol in 1819 and divided into west and east halves on either side of Hurontario Street (also known as Centre Road). The first settlers arrived from New Brunswick and the Maritimes, as well as the United States, namely the children of United Empire Loyalists. The name of Chinguacousy was given by Sir Peregrine Maitland, who allegedly named it after the Mississauga First Nations' name for the Credit River (Mika and Mika 1977). It has also been argued that it was named for the Ottawa Chief Shinguacose, who was largely responsible for the capture of Fort Michilimackinac from the Americans at the beginning of the War of 1812 (Mika and Mika 1977: 416; Rayburn 1997: 68).

Unlike other parts of Peel County, Chinguacousy's early economy was heavily agricultural and did not depend as heavily on mills. According to A History of Peel County to Mark Its Centenary (Corporation of the County of Peel 1967), Chinguacousy Township, along with the Gore of Toronto, produced the greatest amount of wheat in Upper Canada. The wheat was sent south to Port Credit on Lake Ontario to be shipped domestically, as well as for export. Important transport services at the time included the Grand Trunk Railway (1856), Hamilton & North Western Railway (1877), and the Credit Valley Railway (1878/79).

In 1849, the district system of organization was abolished, and the Township became part of Peel County. At that time, York, Peel and Ontario Counties were united under one administration. Peel County became an independent County in 1851. In 1974, the Township was split into two segments that were absorbed by the City of Brampton and the Town of Caledon (Mika and Mika 1977: 417-418; Rayburn 1997: 68).

#### 1.2.4 Past Land Use of the Property

Historically, the property lies within part of Lot 5, Concession 5 West of Centre Road, Geographic Township of Chinguacousy [South], Peel County. Tremaine's 1859 Historical Atlas Map of the County of Peel, Ontario, indicates that the portion of Lot 5, Concession 5 West of Centre Road, Geographic Township of Chinguacousy, Peel County, including the current property limits, were owned by a "Jas. P. Hutton". Significantly, the northeast corner of the subject property contains the western corner of an L-shaped structure that is associated with "Hutton's Mills". An historical road (present-day Embleton Road) is also depicted adjacent to the northern limit of the property. The map does not depict any other structures or features within the limits of the property, though a river is illustrated less than 100 metres to the north and east of the property.



The Walker & Miles 1877 Illustrated Historical Atlas of the County of Peel, Ontario, indicates that the lot remained owned by "Jas. P. Hutton". The entire northern quarter of the subject property overlaps a larger L-shaped structure (expanded to the west), presumably the same "Hutton's Mills" depicted in 1859. Similarly, the historical road (present-day Embleton Road) adjacent to the northern limit of the property, as well as the river located less than 100 metres to the north and east, are depicted in 1877. No other structures or features are depicted within the limits of the property. In this historical map, the larger lot associated with the property is labelled "Huttonville".

In discussing 19th century mapping, it must be remembered that historical county atlases were produced primarily to identify factories, offices, residences, and landholdings of subscribers and were funded by subscription fees. Landowners who did not subscribe were not always listed on the maps. As such, all structures were not necessarily depicted or placed accurately. Regardless of these limitations, the property as depicted on these maps was in close proximity to both historic settlement and transportation features.

Therefore, the Stage 1 Background Study indicates that there is potential for the recovery of Pre-Contact and Post-Contact Euro-Canadian archaeological resources within the property. As it cannot be clearly demonstrated through the Background Study that there has been complete and intensive disturbance of the area, archaeological potential is not removed.

#### 1.3 Archaeological Context

In Ontario, information concerning archaeological sites is stored in the Ontario Archaeological Sites Database (O.A.S.D.), an inventory of the documented archaeological record in Ontario. Summary information on the known archaeological sites in the vicinity of the property was obtained from the MCM site database. There are twenty-eight (28) known sites within a 1 km radius, four (4) of which are within 300-metres of the subject property (Table 2). None of the sites are within the property limits or within a 100-metre radius of the property.

Table 2: Known Archaeological Sites within 1-Km of the Study Area

Borden Number	Site Name	Time Period	Affinity	Site Type	Current Development Review Status
AjGw-9	Burton	Pre-Contact, Woodland, Late	Aboriginal, Iroquoian	Other tool manufacturing	
AjGw-680	Arthurs- Sutcliff	Post-Contact	Euro- Canadian	farmstead	Further CHVI



Borden Number	Site Name	Time Period	Affinity	Site Type	Current Development Review Status
AjGw-679		Archaic, Late	Aboriginal	findspot	No Further CHVI
AjGw-536	Anthony Site	Post-Contact	Euro- Canadian	farmstead	No Further CHVI
AjGw-475	Blain	Post-Contact	Euro- Canadian	homestead	
AjGw-459*	P3	Woodland, Late	Aboriginal	village	
AjGw-457	P1				
AjGw-456*	P4	Woodland, Early	Aboriginal	findspot	No Further CHVI
AjGw-455*	P3	Pre-Contact		findspot	No Further CHVI
AjGw-445		Archaic, Middle	Aboriginal	Unknown	
AjGw-444					
AjGw-443					
AjGw-442	Erin Mills B				
AjGw-441	Erin Mills A				
AjGw-440	Calder D	Post-Contact	Euro- Canadian	Unknown	
AjGw-439	Calder C	Post-Contact	Euro- Canadian	Unknown	
AjGw-437	Calder A	Post-Contact	Euro- Canadian	homestead	
AjGw-366	-	Post-Contact	Euro- Canadian	homestead	
AjGw-365	-	Post-Contact	Euro- Canadian	homestead	
AjGw-364	-	Pre-Contact	Aboriginal	scatter	
AjGw-363	-	Pre-Contact	Aboriginal	findspot	
AjGw-362	-	Archaic, Middle	Aboriginal	findspot	
AjGw-361	-	Pre-Contact	Aboriginal	findspot	
AjGw-18	Fraser	Archaic	Aboriginal	Other camp/campsite	
AjGw-16	Oldham	Woodland	Aboriginal	Other camp/campsite	



Borden Number	Site Name	Time Period	Affinity	Site Type	Current Development Review Status
AjGw-15*	Ostranger	Pre-Contact	Aboriginal	Other camp/campsite	
AjGw-11	Hutton	Woodland	Aboriginal	Other camp/campsite	
AiGw-330					

<sup>\*</sup> Site located within 300 m of the subject property.

**AS&G** is not aware of any Archaeological Assessments conducted within, immediately adjacent to or within 50 metres of the property.

#### 1.3.1 Current Conditions

The subject area is a trapezoid-shaped property, approximately 0.40 hectares in size, measuring approximately 52 metres east-west by 105 metres north-south. It is bound by Embleton Road to the north, farm fields to the south, and residential properties to the east and west. The Study Area is comprised of a single residential property with detached garage, associated gravel driveways, grass lawns, bushes, and trees. The Credit River and a tributary of the Credit River are located less than 100 metres east and south, respectively, of the property.

The property is situated within the Peel Plain physiographic region. The Peel Plain is a level-to-undulating area of clay soil that covers an area of approximately 77,700 hectares across the central portions of the Regional Municipalities of York, Peel, and Halton (Chapman and Putnam 1984). The Peel Plain has a general elevation of between 500 and 750 feet above sea level with a gradual uniform slope towards Lake Ontario. The Peel Plain is sectioned by the Credit, Humber, Don, and Rouge Rivers - with deep valleys, as well as a number of other streams such as the Bronte, Oakville, and Etobicoke Creeks. These valleys are in places bordered by trains of sandy alluvium. The region is devoid of large undrained depressions, swamps, and bogs, though nevertheless, the dominant soil possesses imperfect drainage (Chapman and Putnam 1984).

## 1.3.2 Stage 2 Archaeological Fieldwork

The archaeological fieldwork of the property was undertaken on June 10, 2025, under partly cloudy skies and warm temperatures. No rain occurred during the fieldwork. The weather did not impede the identification of any cultural features or affect the test pit strategy.



We are unaware of any previous findings and recommendations relevant to the current stage of work with the exception of those discussed above. There are no unusual physical features that may have affected fieldwork strategy decisions or the identification of artifacts or cultural features. Thus, there is no additional archaeological information that may be relevant to understanding the choice of fieldwork techniques or the recommendations of this report.

## 2.0 FIELD METHODS

This section of the report addresses Section 7.8.1 of the 2011 Standards and Guidelines for Consultant Archaeologists. It does not address Section 7.7.2 because no property inspection was done as a separate Stage 1. The entire property was surveyed. As relevant, we provide detailed and explicit descriptions addressing Standards 2a and b.

The general standards for property survey under Section 2.1 of the 2011 Standards and Guidelines for Consultant Archaeologists were addressed as follows:

- **Section 2.1, \$1:** All of the Study Area was surveyed including areas immediately adjacent to existing structures (as applicable).
- **Section 2.1, S2a** (land of no or low potential due to physical features such as permanently wet areas, exposed bedrock, and steep slopes): N/A
- **Section 2.1, \$2b** (no or low potential due to extensive and deep land alterations): Portions of the property have been subject to extensive and deep land alterations related to the development of the existing structures and their footprints, associated decks, and compact gravel driveways.
- Section 2.1, S2c (lands recommended not to require Stage 2 Assessment by a previous Stage 1 report where the Ministry has accepted that Stage 1 into the register): N/A
- **Section 2.1, S2d** (lands designated for forest management activity w/o potential for impacts to archaeological sites, as determined through Stage 1 forest management plans process): N/A
- Section 2.1, S2e (lands formally prohibited from alterations): N/A
- Section 2.1, S2f (lands confirmed to be transferred to a public land holding body, etc.) - n/a
- **Section 2.1, \$2f** (lands confirmed to be transferred to a public land holding body, etc.): N/A
- **Section 2.1, S3:** The Stage 2 survey was conducted when weather and lighting conditions permitted excellent visibility of features.
- **Section 2.1, \$4**: No GPS recordings were taken as no artifacts were found during the Stage 2 Assessment.



- **Section 2.1, \$5**: All field activities were mapped in reference to either fixed landmarks, survey stakes and development markers as appropriate. See Report Section 9.0 Maps.
- **Section 2.1, \$6:** See Report Section 8.0 Images for photo documentation of examples of field conditions encountered.

The property was subject to a systematic test pit survey appropriate to the characteristics of the property. The test pit survey of the property followed the standards within Section 2.1.2 of the 2011 Standards and Guidelines for Consultant Archaeologists. Test pit survey was only conducted where ploughing was not possible or viable, as per Standard 1. Test pits were spaced at maximum intervals of five (5) metres throughout the property. All test pits were at least 30 cm in diameter. Each test pit was excavated by hand, into at least the first 5 cm of subsoil and examined for stratigraphy, cultural features, or evidence of fill where possible. Soils were screened through 6 mm mesh. No stratigraphy, artifacts or cultural features were encountered. All test pits were backfilled.

Approximately 60% of the property was assessed by means of a systematic test pit survey. The remaining 30-35% of the property is assessed as visibly disturbed and includes the structures and their footprints, compact gravel driveway, patios and walkways. The remaining 5-10% of the property was subject to judgmental test pit survey to confirm disturbance.

#### 3.0 RECORD OF FINDS

This section documents all finds discovered as a result of the Stage 1 and 2 Archaeological Assessment of the property. No cultural resources, features or sites were identified during the Stage 2 test pitting survey.

An inventory of the documentary record generated in the field is provided in Table 3.

Table 3: Inventory of Documentary Record

Document Type	Description
Field Notes	This report constitutes the field notes for this project
Photographs	18 digital photographs
Maps	The report figures represent all of the maps generated in the field.

Information detailing exact site locations on the property is not submitted because no sites or archaeological resources were identified in the Stage 2 Assessment.



#### 4.0 ANALYSIS AND CONCLUSIONS

The entirety of the subject property was assessed, and no cultural resources, features or sites were identified during the Stage 2 Test Pitting Survey. Standard 2 is not addressed, because no archaeological sites were identified during the current Assessment.

#### 5.0 RECOMMENDATIONS

The report makes recommendations only regarding archaeological matters. The Stage 2 Archaeological Assessment, consisting of a systematic test-pitting survey performed at standardized five metre intervals throughout the limits of the property, did not identify any archaeological resources or sites requiring further assessment or mitigation of impacts. Therefore, the report recommends that no further Archaeological Assessment of the property (Map 6) is required.

#### 6.0 ADVICE ON COMPLIANCE WITH LEGISLATION

#### Section 7.5.9, Standard 1a

This report is submitted to the Minister of Citizenship and Multiculturalism as a condition of licensing in accordance with Part VI of the Ontario Heritage Act, R.S.O. 1990, c 0.18. The report is reviewed to ensure that it complies with the standards and guidelines that are issued by the Minister, and that the archaeological fieldwork and report recommendations ensure the conservation, protection and preservation of the cultural heritage of Ontario. When all matters relating to archaeological sites within the project area of a development proposal have been addressed to the satisfaction of the Ministry of Citizenship and Multiculturalism, a letter will be issued by the ministry stating that there are no further concerns with regard to alterations to archaeological sites by the proposed development.

#### Section 7.5.9, Standard 1b

It is an offence under Sections 48 and 69 of the *Ontario Heritage Act* for any party other than a licensed archaeologist to make any alteration to a known archaeological site or to remove any artifact or other physical evidence of past human use or activity from the site, until such time as a licensed archaeologist has completed archaeological fieldwork on the site, submitted a report to the Minister stating that the site has no further cultural heritage value or interest, and the report has been filed in the Ontario Public Register of Archaeological Reports referred to in Section 65.1 of the *Ontario Heritage Act*.



#### Section 7.5.9, Standard 1c

Should previously undocumented archaeological resources be discovered, they may be a new archaeological site and therefore subject to Section 48 (1) of the Ontario Heritage Act. The proponent or person discovering the archaeological resources must cease alteration of the site immediately and engage a licensed consultant archaeologist to carry

out archaeological fieldwork, in compliance with Section 48 (1) of the Ontario Heritage Act.

#### Section 7.5.9, Standard 1d

The Cemeteries Act, R.S.O, 1990 c. C.4 and the Funeral, Burial and Cremation Services Act, 2002, S.O. 2002, c.33 (when proclaimed in force) require that any person discovering human remains must notify the police or coroner and the Registrar of Cemeteries at the Ministry of Consumer Services.

#### Section 7.5.9, Standard 2

Archaeological sites recommended for further archaeological fieldwork or protection remain subject to Section 48 (1) of the *Ontario Heritage Act* and may not be altered, or have artifacts removed from them, except by a person holding an archaeological licence.



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# 8.0 IMAGES



Image 1: Shows driveway and conditions for test pit survey.



Image 2: Shows conditions for test pit survey.





Image 3: Shows conditions for test pit survey.



Image 4: Shows conditions for test pit survey and existing structure.





Image 5: Shows disturbed area adjacent to structure. Note structure has full basement.



Image 6: Shows existing structure and conditions for test pit survey.





Image 7: Shows existing structure and disturbed area in front. Note structure has full basement.



Image 8: Representative image showing disturbed test pits in areas adjacent to structure.

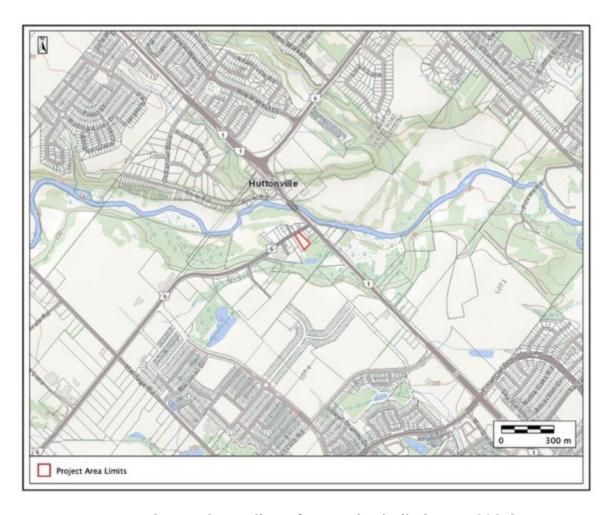




Image 9: Representative gravel fills found in test pits adjacent to structure.



# 9.0 MAPS



Map 1: General Location of Property Limits (MNRF 2025).






Map 2: Aerial Imagery of Property Limits (MNRF 2025).





Map 3: Property Limits Overlaid on 1859 Historic Atlas Map (Tremaine 1859).



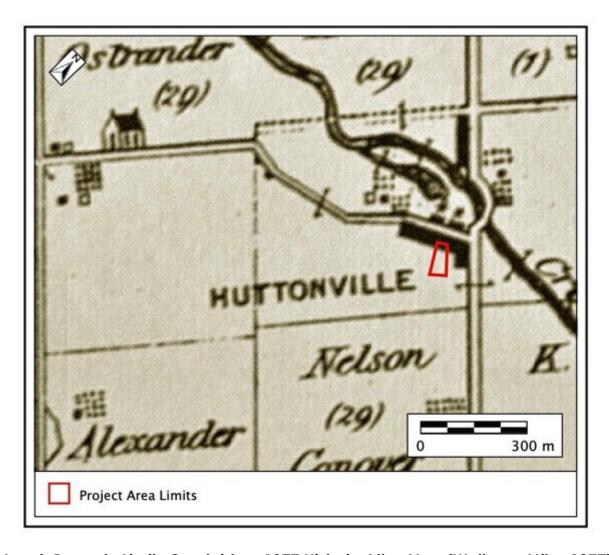


Map 4: Property Limits Overlaid on 1877 Historic Atlas Map (Walker & Miles 1877).



Map 5: Plan of Survey(Provided by Project Proponent).



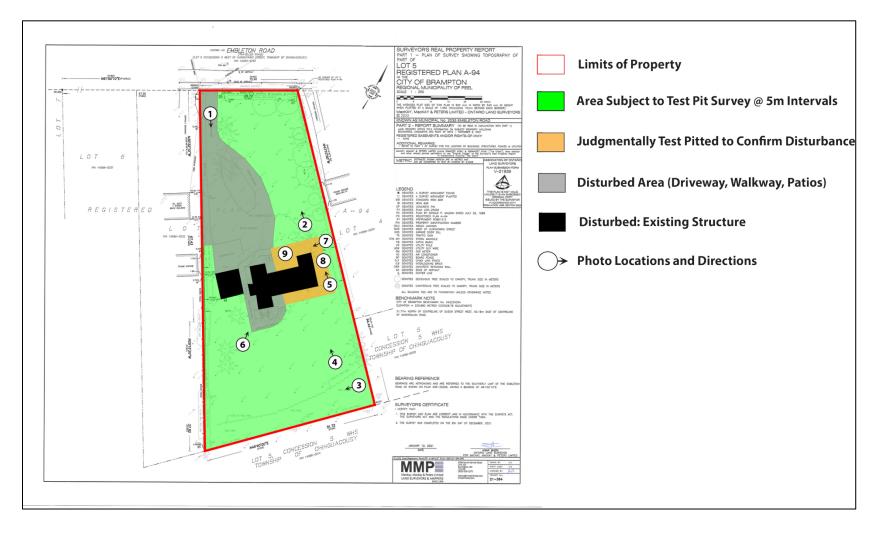

Map 6: Results of the Stage 1 and 2 Archaeological Assessment.



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Division de la citoyenneté, de l'inclusion et du patrimoine
5e étage, 400 ave. University
Toronto ON M7A 2R9

Tél.: (705) 492-1395 Email: Rebecca.Gray@Ontario.ca

Aug 9, 2025

Sheryl Spigelski (P1034) AS&GArchaeological Consulting Inc. 78 Sparta St. Thomas ON N5R 5G9

RE: Entry into the Ontario Public Register of Archaeological Reports: Archaeological Assessment Report Entitled, "Stage 1 and 2 Archaeological Assessment 2035 Embleton Road, Part of Lot 5, Registered Plan A-94 (Formerly Part of Lot 5, Concession 5 West of Centre Road, Geographic Township of Chinguacousy [South], Peel County), Now in the City of Brampton, Regional Municipality of Peel, Ontario ", Dated Jul 2, 2025, Filed with MCM on N/A, MCM Project Information Form Number P1034-0024-2025, MCM File Number 0023812

Dear Sheryl Spigelski (P1034):


The above-mentioned report, which has been submitted to this ministry as a condition of licensing in accordance with Part VI of the *Ontario Heritage Act*, R.S.O. 1990, c 0.18, has been entered into the Ontario Public Register of Archaeological Reports without technical review.<sup>1</sup>


Please note that the ministry makes no representation or warranty as to the completeness, accuracy or quality of reports in the register.

Should you require further information, please do not hesitate to send your inquiry to <a href="mailto:Archaeology@Ontario.ca">Archaeology@Ontario.ca</a>

cc. Archaeology Licensing Officer Leah Fombuena, In Tech House Design Charlton Carscallen, City of Brampton

1In no way will the ministry be liable for any harm, damages, costs, expenses, losses, claims or actions that may result: (a) if the Report(s) or its recommendations are discovered to be inaccurate, incomplete, misleading or fraudulent; or (b) from the issuance of this letter. Further measures may need to be taken in the event that additional artifacts or archaeological sites are identified or the Report(s) is otherwise found to be inaccurate, incomplete, misleading or fraudulent.

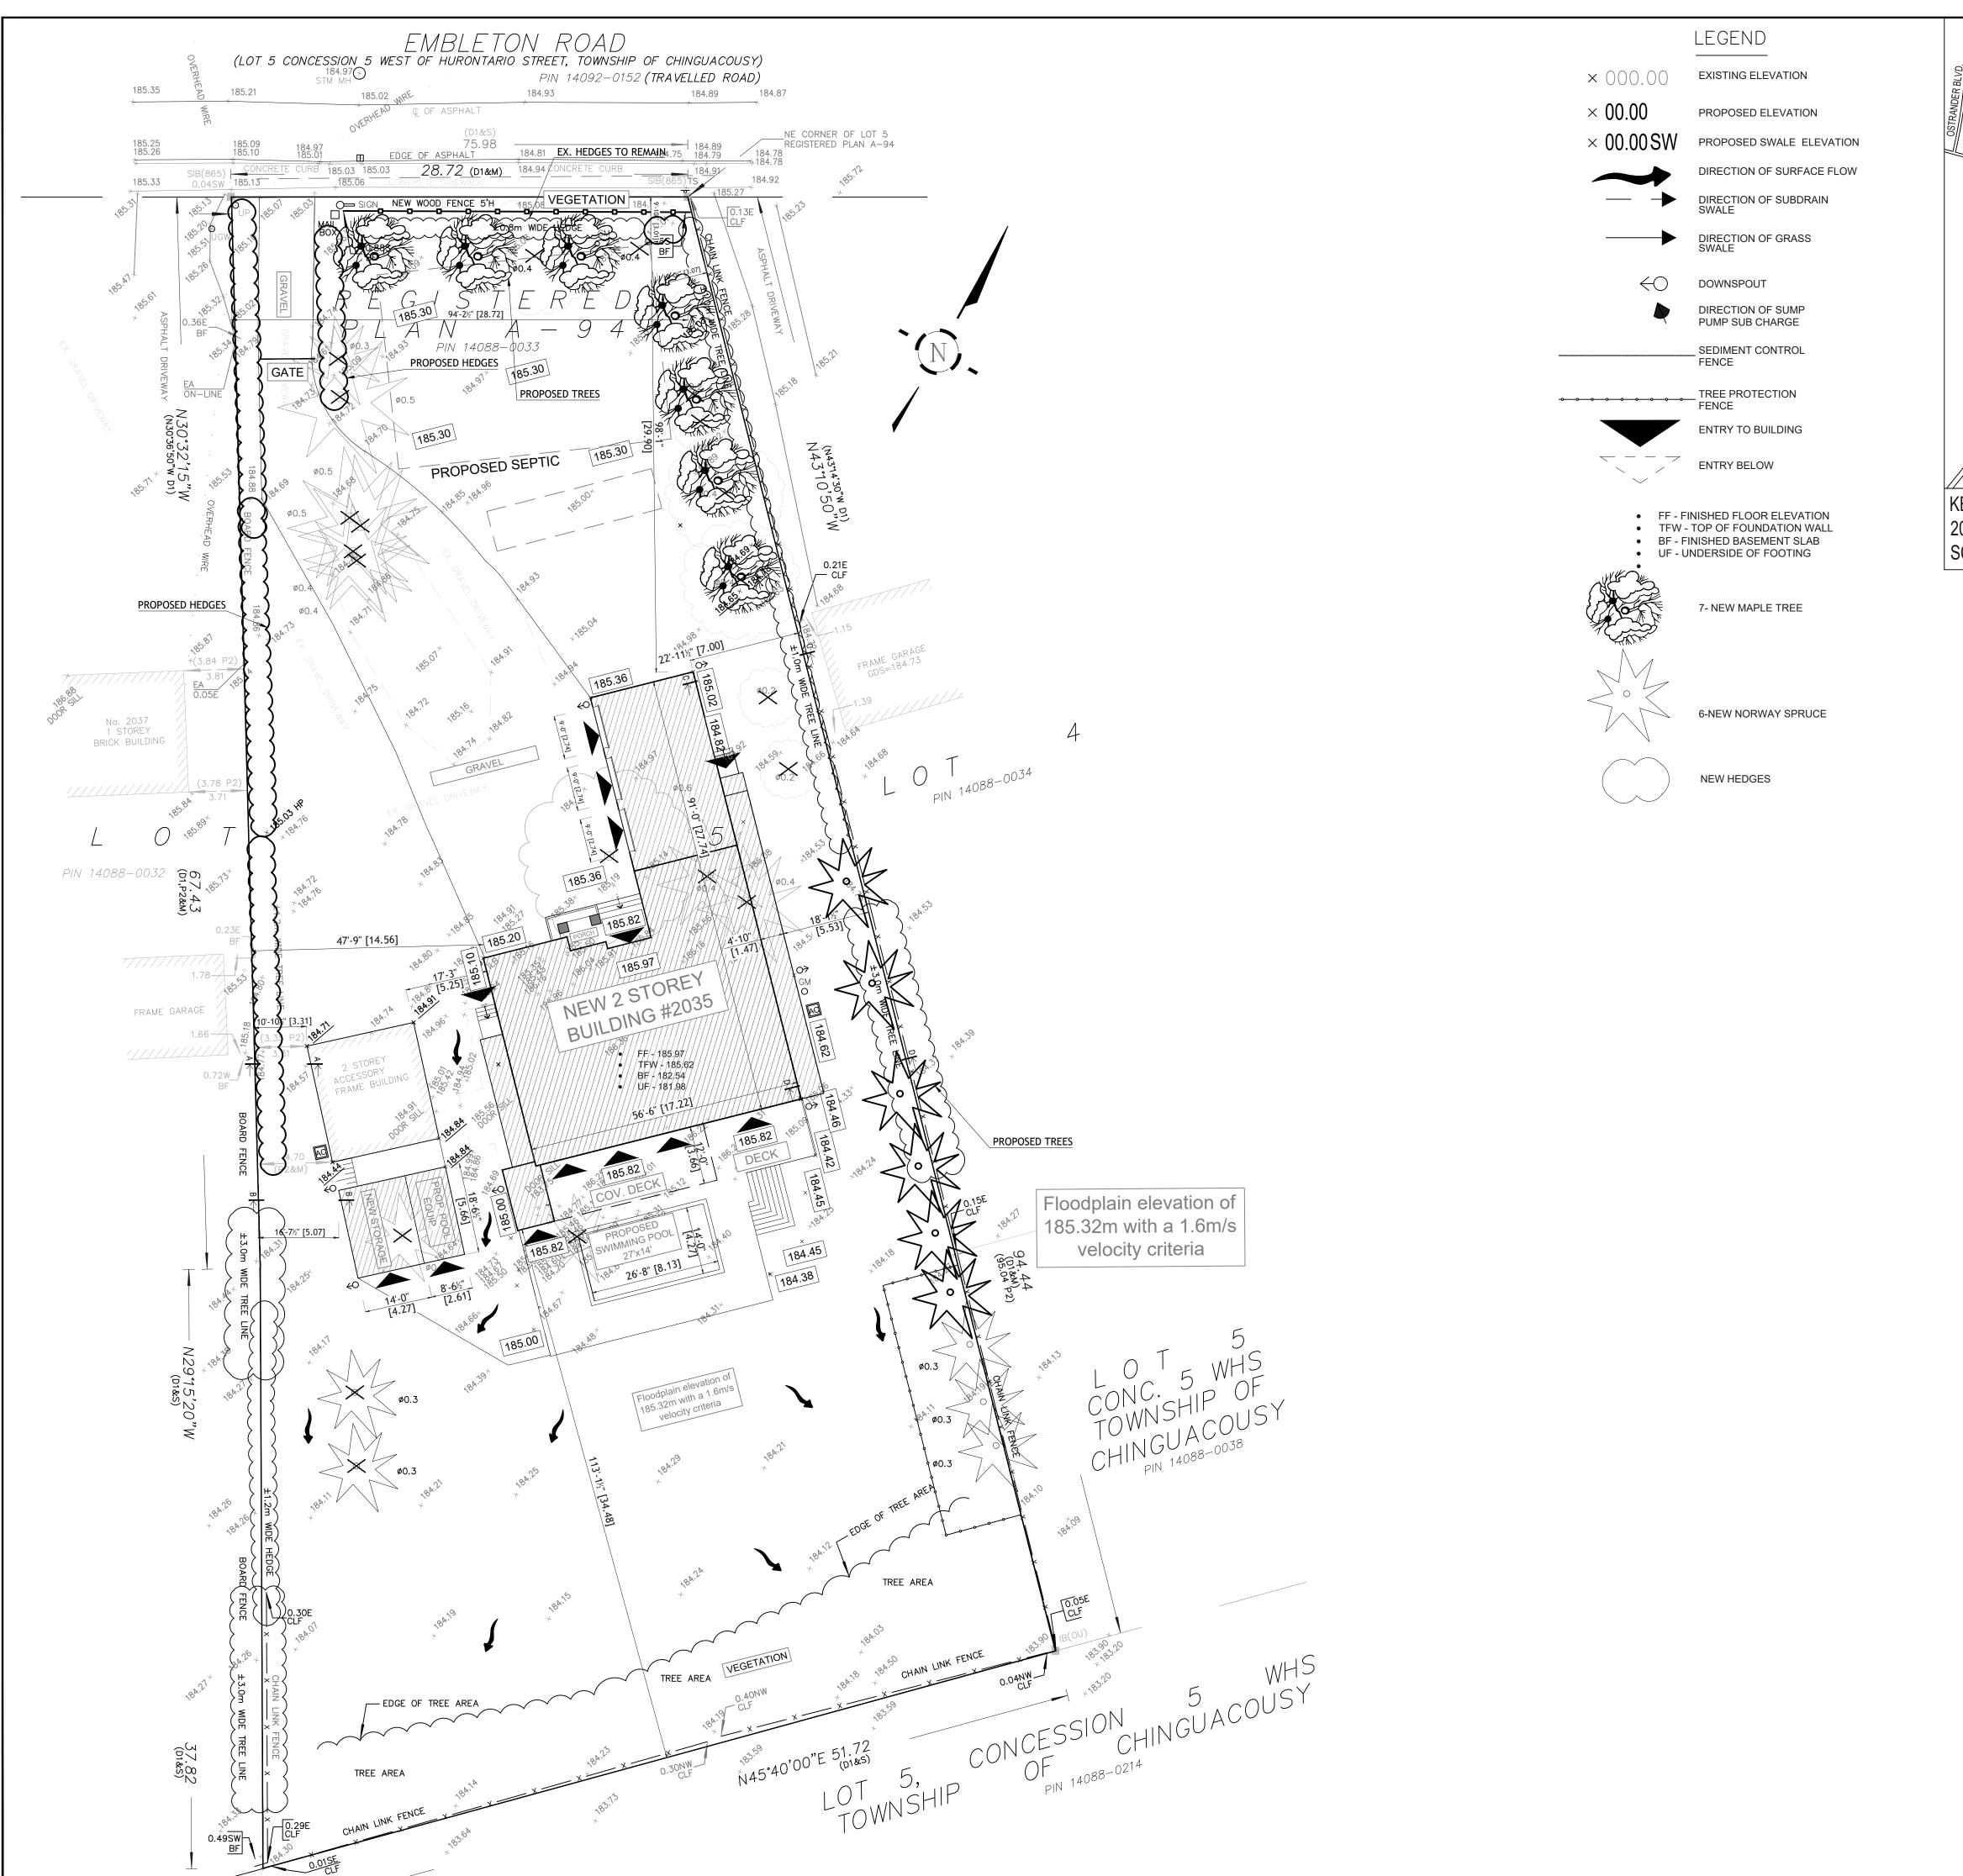

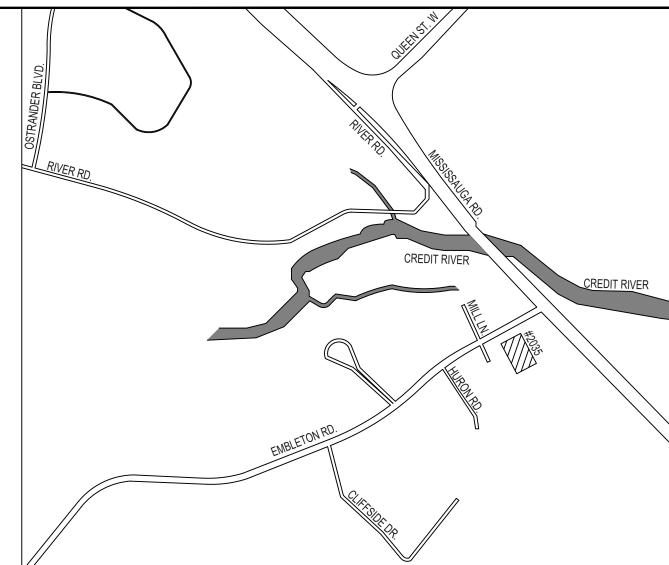

KEYPLAN: 2035 EMBLETON RD. ON. L6Y 0E9 SCALE: NTS

	ATISTICS - NE			
RD(f12.0;a370)(x1463)				
	REQU SQ.FT		PROPO:	
LOT AREA	SQ.F1	m²	42235.75	m² 3923.80
EX. BUILDING AREA			553.59	51.43
NEW BUILDING AREA			4002.85	371.87
NEW STORAGE AREA			259.45	24.10
NEW POOL EQUIPMENT AREA			158.50	14.73
LOT COVERAGE				11.8%
	ROSS FLOOR	AREA		
	SQ.FT	m²	SQ.FT	m²
FIRST FLOOR	-	-	2754.50	255.90
SECOND FLOOR	-	-	2654.16	246.58
TOTAL G.F.A.	-	-	5408.66	502.48
FINISHED BASEMENT	-	-	2635.03	244.80
	I			
	FT	m	FT	m
AVERAGE ESTABLISH GRADE NORTH (FRONT)				185.36
BUILDING HEIGHT NORTH (FRONT)		10.60	30'-11 1/4"	9.43 m
AVERAGE ESTABLISH GRADE SOUTH (REAR)				185.36
BUILDING HEIGHT SOUTH (REAR)		10.60	30'-11 1/4"	9.43 m
AVERAGE ESTABLISH GRADE EAST SIDE				185.36
BUILDING HEIGHT EAST SIDE		10.60	30'-11 1/4"	9.43 m
AVERAGE ESTABLISH GRADE WEST SIDE				185.36
BUILDING HEIGHT WEST SIDE		10.60	30'-11 1/4"	9.43 m
BUILDING LENGTH			103'-0"	31.39
BUILDING DEPTH			103'-0"	31.39
LOT FRONTAGE			94'-2 ½"	28.72
	SETBACK	 S		
	FT	m	FT	m
FRONT		12.00	98'-1"	29.90
REAR		7.50	113'-1 ½"	34.48
WEST SIDE		7.50	47'-9"	14.56
EAST SIDE		15	18'-1 ½"	5.53
	LANDSCAPI			055
	REQU		PROPO:	
FRONT YARD LANDSCAPING AREA	SQ.FT	m²	SQ.FT 15061.99	m² 1399.29
SOFT LANDSCAPE AREA			10543.56	989.52
HARD LANDSCAPE AREA	-	-	4518.43	419.77
		70%		70%
REAR YARD AREA BREAK DOWN	Ι	T	T	
COVERED DECK			416.00	38.65
SWIMMING POOL			443.89	41.24



Phone: +1(647)478-5055 Toll free: +1(885)561-4161 info@ithd.ca

GENERAL NOTES

THE CONTRACTOR SHALL VERIFY ALL DIMENSIONS AT THE SITE AND REPORT ANY DISCREPANCIES TO THE CONSULTANT BEFORE PROCEEDING WITH WORK

DO NOT SCALE DRAWINGS

ALL WORKS IS TO BE CARRIED OUT ACCORDING TO THE ONTARIO BUILDING CODE 2012 AND BY-LAWS

ALL EXISTING SURFACES AND STRUCTURES ADJACENT TO THE PROPOSED WORK ARE TO BE PROTECTED DURING DEMOLITION AND CONSTRUCTION

THE CONTRACTOR AND/OR THE OWNER SHALL BE RESPONSIBLE FOR THE ARRANGEMENT OF ALL NECESSARY INSPECTIONS AND FOLLOW INSPECTION SCHEDULES


ALL TEMPORARY WORKS INCLUDING SHORING ARE TO BE PROVIDED

READ THIS DRAWING IN CONJUNCTION WITH OTHER DRAWINGS: ARCHITECT, STRUCTURAL, MECHANICAL, ELECTRICAL AND OTHER RELEVANT DRAWINGS AND SPECIFICATIONS

THESE DRAWING MUST NOT BE DUPLICATED IN ANY FORM, OR USE FOR ANY OTHER PROJECTS, WITHOUT WRITTEN CONSENT OF THE

ADDITIONAL NOTES:

REVISIONS AND ISSUES				
25/08/07	4	REVISED PER CITY COMMENTS		
24/12/28	3	REVISED PER CITY COMMENTS		
24/11/07	2	REVISED PER CITY COMMENTS		
24/09/25	1	ISSUED FOR CVC PERMIT		
DATE	#	DESCRIPTION		

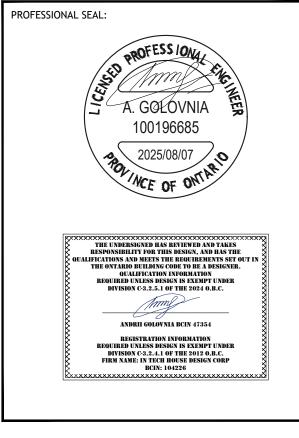

PROJECT NAME: **New Custom House** 

PROJECT ADDRESS: 2035 Embleton Rd. Brampton, ON. L6Y 0E9

Site Plan & Key Plan

DESIGN BY:	RH
DRAWN BY:	JT
CHECKED BY:	AG
SCALE:	1:200
DATE:	2025.08.05
PROJECT №:	24-699

SP-1

DRAWING №: