

Public Notice

Committee of Adjustment

APPLICATION # A-2021-0189 WARD 6

APPLICATION FOR MINOR VARIANCE

WHEREAS an application for minor variance has been made by **KISHOR GAREWAL AND SAMINA USMAN** under Section 45 of the <u>Planning Act</u>, (R.S.O. 1990 c.P.13) for relief from **By-law 270-2004**;

AND WHEREAS the property involved in this application is described as Lot 231, Plan 43M-1878 municipally known as **3 AYLESBURY DRIVE**, Brampton;

AND WHEREAS the applicants are requesting the following variance(s):

- 1. To permit a 0.65m (2.13 ft.) path of travel leading to a principle entrance for a second unit whereas the by-law requires a minimum unencumbered side yard width of 1.2m (3.94 ft.) to be provided as a path of travel from the front yard to the entrance for a second unit;
- 2. To permit a driveway width of 6.93m (22.74 ft.) whereas the by-law permits a maximum driveway width of 6.71m (22 ft.)

OTHER PLANNING APPLICATIONS:

The land which is subject of this application is the subject of an application under the Planning Act for:

Plan of Subdivision:	NO	File Number:	
Application for Consent:	NO	File Number:	
	*****	0 2004 (CA)04-2004-000-000-000-000-000-000-000-000-	

The Committee of Adjustment has appointed TUESDAY, September 14, 2021 at 9:00 A.M. by electronic meeting broadcast from the Council Chambers, 4th Floor, City Hall, 2 Wellington Street West, Brampton, for the purpose of hearing all parties interested in supporting or opposing these applications.

This notice is sent to you because you are either the applicant, a representative/agent of the applicant, a person having an interest in the property or an owner of a neighbouring property. OWNERS ARE REQUESTED TO ENSURE THAT THEIR TENANTS ARE NOTIFIED OF THIS APPLICATION. THIS NOTICE IS TO BE POSTED BY THE OWNER OF ANY LAND THAT CONTAINS SEVEN OR MORE RESIDENTIAL UNITS IN A LOCATION THAT IS VISIBLE TO ALL OF THE RESIDENTS. If you are not the applicant and you do not participate in the hearing, the Committee may proceed in your absence, and you will not be entitled to any further notice in the proceedings. WRITTEN SUBMISSIONS MAY BE SENT TO THE SECRETARY-TREASURER AT THE ADDRESS OR FAX NUMBER LISTED BELOW.

IF YOU WISH TO BE NOTIFIED OF THE DECISION OF THE COMMITTEE OF ADJUSTMENT IN RESPECT OF THIS APPLICATION, YOU MUST SUBMIT A WRITTEN REQUEST TO THE COMMITTEE OF ADJUSTMENT. This will also entitle you to be advised of a Local Planning Appeal Tribunal hearing. Even if you are the successful party, you should request a copy of the decision since the Committee of Adjustment decision may be appealed to the Local Planning Appeal Tribunal by the applicant or another member of the public.

RULES OF PROCEDURE OF THIS COMMITTEE REQUIRE REPRESENTATION OF THE APPLICATION AT THE HEARING, OTHERWISE THE APPLICATION SHALL BE DEFERRED.

PLEASE SEE ATTACHED PARTICIPATION PROCEDURES REQUIRED DURING THE COVID-19 PANDEMIC

DATED at Brampton Ontario, this 2nd day of September, 2021.

Comments may be sent to and more information about this matter may be obtained between 8:30 a.m. to 4:30 p.m. Monday - Friday from:


Jeanie Myers, Secretary-Treasurer Committee of Adjustment, City Clerk's Office, Brampton City Hall 2 Wellington Street West, Brampton, Ontario L6Y 4R2 Phone: (905)874-2117

Fax: (905)874-2119 jeanie.myers@brampton.ca



ROOM AREAS	S - Site
<u>Name</u>	Area
BASEMENT	
BEDROOM 1	129 SF
W/C	43 SF
STORAGE	104 SF
LAUNDRY	28 SF
FURNACE	37 SF
CLOSET	10 SF
CLOSET	8 SF
LIVING/DINING	240 SF
KITCHEN	161 SF
HALLWAY	137 SF
	896 SF
MAIN FLOOR	
GREATROOM	220 SF
W/C	24 S F
BREKFAST	130 SF
CLOSET	11 SF
DEN	70 SF
DINING ROOM	195 SF
GARAGE	363 SF
KITCHEN	131 SF
FOYER	107 SF
EXIT	16 SF
	1267 SF

<u>Name</u>	Area
SECOND FLOOR	
LAUNDRY	46 SF
WJC	71 S F
CLOSET	13 SF
BEDROOM 4	112 S F
MASTER BEDROOM	214 SF
W.I.C	55 SF
HALLWAY	14 SF
W.I.C	26 SF
LINEN	11 S F
W/C	27 S F
HALLWAY	37 SF
HALLWAY	145 SF
W/C	52 SF
CLOSET	9 S F
BEDROOM 3	127 S F
CLOSET	10 SF
BEDROOM 2	165 S F
	1134 SF
Total Building Area: 37	3297 SF

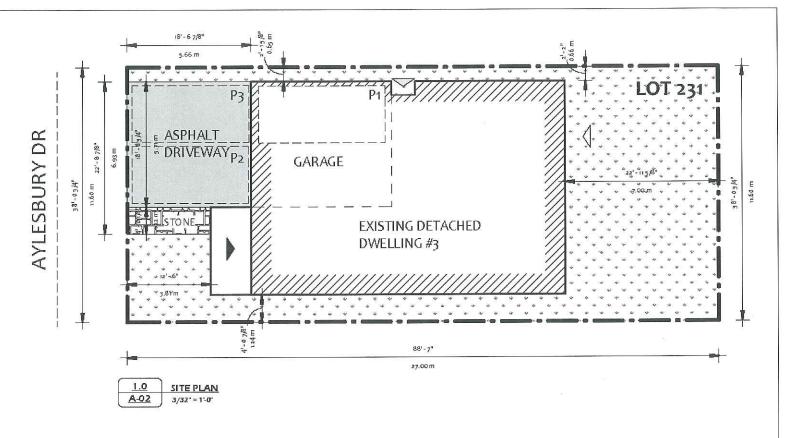

FLOOR / UNIT	AR	EA
AREA	SQFT	SQM
BASEMENT (UNIT 2)	947.68	88.04
FIRST FLOOR (UNIT 1)	949.32	88.19
FIRST FLOOR (COMMON AREA)	23.19	2.15
SECOND FLOOR (UNIT 1)	1225.66	113.86
TOTAL BUILDING AREA	3145.85	292.24

UNIT 1 MAIN ENTRANCEUNIT 1 SECONDARY ENTRANCEUNIT 2 ENTRANCE



7-250 SHEILDS CRT.

MARKHAM ON L3R 9T5
888.236.9958 I 416.483.5393
INFO@YEJSTUDIO.COM
WWW.YEJSTUDIO.COM

BASEMENT SECOND UNIT 3 AYLESBURY DR BRAMPTON, ON, L7A oV3

THE BROWN SAFED HAN REVIEW ARE FLASHED TO STRENDED TO BE THE DESIGN, AND THAT THE QUALIFICATIONS AND MEETS THE REQUIREMENTS SET OUT IN THE CONTRACTOR TO BE A REPORTED.

AND THE PERMITTANT AND THE PERMITTANT AND MEAD MEAT

OUALIFICATION INFORMATION
REQUIRED UNLESS DEBTCH IS EXCENT UNCESS DEBTCH INFORMATION
RAME
ANDROGRAM

ANDROGRAM

ANDROGRAM

ANDROGRAM

OUALIFICATION INFORMATION
OUT OF COMMERCIAL INFORMAT



CLIENT REVIEW 2021.02.23	
REVISION 2021.03.19	
ISSUED FOR FERMIT 2021.03.22	
	7

SITE PLAN		
Drawn by	H.R	A-02
Project number	21 RE 500 21	1102
Date	2 021.02.22	Scale Asindicated



Under the authority of the Emergency *Management and Civil Protection Act* and the *Municipal Act, 2001*, City Council approved Committee Meetings to be held electronically during the COVID-19 Emergency

Electronic Hearing Procedures How to get involved in the Virtual Hearing

Brampton City Hall is temporarily closed to help stop the spread of COVID-19. In-person Committee of Adjustment Hearings have been cancelled since mid-March 2020. Brampton City Council and some of its Committees are now meeting electronically during the Emergency. The Committee of Adjustment will conduct its meeting electronically until further notice.

How to Participate in the Hearing:

- All written comments (by mail or email) must be received by the Secretary-Treasurer no later than **4:30 pm, Thursday, September 9, 2021**.
- Advance registration for applicants, agents and other interested persons is required to
 participate in the electronic hearing using a computer, smartphone or tablet by emailing the
 Secretary—Treasurer at cityclerksoffice@brampton.ca or jeanie.myers@brampton.ca by
 4:30 pm Friday, September 10, 2021.
 - Persons without access to a computer, smartphone or tablet can participate in a meeting via telephone. You can register by calling 905-874-2117 and leave a message with your name, phone number and the application you wish to speak to by Friday, September 10, 2021. City staff will contact you and provide you with further details.
- All Hearings will be livestreamed on the City of Brampton YouTube account at:
 https://www.brampton.ca/EN/City-Hall/meetings-agendas/Pages/Welcome.aspx or
 http://video.isilive.ca/brampton/live.html

If holding an electronic rather than an oral hearing is likely to cause a party significant prejudice a written request may be made to have the Committee consider holding an oral hearing on an application at some future date. The request must include your name, address, contact information, and the reasons for prejudice and must be received no later than 4:30 pm the Friday prior to the hearing to cityclerksoffice@brampton.ca or jeanie.myers@brampton.ca. If a party does not submit a request and does not participate in the hearing, the Committee may proceed without a party's participation and the party will not be entitled to any further notice regarding the proceeding.

NOTE Personal information as defined in the *Municipal Freedom of Information and Protection of Privacy Act (MFIPPA)*, collected and recorded or submitted in writing or electronically as related to this planning application is collected under the authority of the *Planning Act*, and will be used by members of the Committee and City of Brampton staff in their review of this matter. Please be advised that your submissions will be part of the public record and will be made available to the public, including posting on the City's website, www.brampton.ca. By providing your information, you acknowledge that all personal information such as the telephone numbers, email addresses and signatures of individuals will be redacted by the Secretary-Treasurer on the on-line posting only. Questions regarding the collection, use and disclosure of personal information may be directed to the Secretary-Treasurer at 905-874-2117.

AMENDMENT LETTER

August 31, 2021

To: Committee of Adjustment

RE: APPLICATION FOR MINOR VARIANCE KISHOR GAREWAL & SAMINA USMAN

A-2021-0189 - 3 AYLESBURY

Please amend application A-2021-0189 to reflect the following:


- 1. To permit a driveway width of 6.93m whereas the by-law permit a maximum driveway width of 6.71m.
- 2. To permit a 0.65m (2.17 ft.) path of travel leading to a principle entrance for a second unit whereas the by-law requires a minimum unencumbered side yard width of 1.2 m (3.94 ft.) to be provided as a path of travel from the front yard to the entrance for a second unit;

Applicant/Authorized Agent



Name	Area
BASEMENT	
BEDROOM 1	129 SF
W/C	43 SF
STORAGE	104 SF
LAUNDRY	28 SF
FURNACE	37 S F
CLOSET	10 SF
CLOSET	8 SF
LIVING/DINING	240 SF
KITCHEN	161 SF
HALLWAY	137 SF
	896 SF
MAIN FLOOR	
GREATROOM	220 SF
W/C	24 S F
BREKFAST	130 SF
CLOSET	11 SF
DEN	70 SF
DINING ROOM	195 SF
GARAGE	363 SF
KITCHEN	131 SF
FOYER	107 SF
EXIT	16 SF
	1267 SF

<u>Name</u>	Area
SECOND FLOOR	
LAUNDRY	46 SF
W/C	71 S F
CLOSET	13 SF
BEDROOM 4	112 S F
MASTER BEDROOM	214 SF
W.I.C	55 SF
HALLWAY	14 SF
W.I.C	26 SF
LINEN	11 S F
W/C	27 SF
HALLWAY	37 SF
HALLWAY	145 SF
W/C	52 SF
CLOSET	9 S F
BEDROOM 3	127 S F
CLOSET	10 SF
BEDROOM 2	165 S F
	1134 SF
otal Building Area: 37	3297 SF

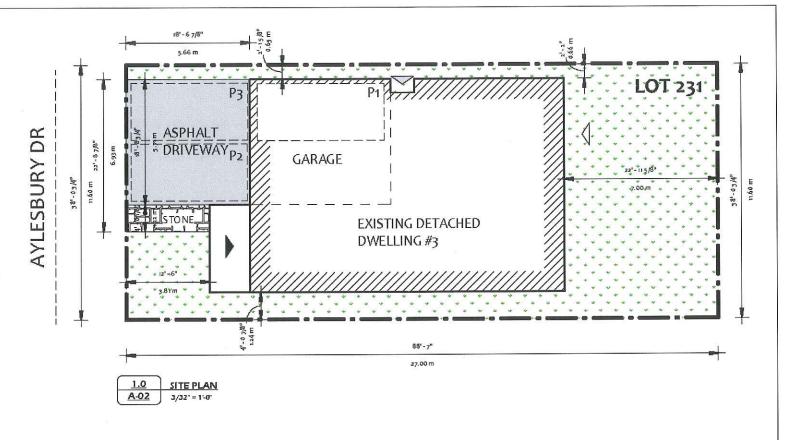

FLOOR / UNIT	AR	EA
AREA	<u>SQFT</u>	SQM
BASEMENT (UNIT 2)	947.68	88.04
FIRST FLOOR (UNIT 1)	949.32	88.19
FIRST FLOOR (COMMON AREA)	23.19	2.15
SECOND FLOOR (UNIT 1)	1225.66	113.86
TOTAL BUILDING AREA	3145.85	292.24

UNIT 1 MAIN ENTRANCE
UNIT 1 SECONDARY ENTRANCE
UNIT 2 ENTRANCE



7-250 SHEILDS CRT. MARKHAM ON L3R 9T5 888.236.9958 I 416.483.5393 INFO@YEJSTUDIO.COM WWW.YEJSTUDIO.COM

BASEMENT SECOND UNIT 3 AYLESBURY DR BRAMPTON, ON, L7A oV3

THE DIRECTION AND RECEIVABLE THAN A THE STANDARD THE PROPERTY OF THE PROPERTY

UIREN UKLESS DESKON E EKEMPY UNDER J.L., 10 LME R DORAH



	NAME OF TAXABLE PARTY.	
REVISION	2021.03.19	
SSUED FO	R PERMIT	2021.03.22

SITE PLAN		
Drawn by	H.R	A-02
Project number	21 RE 500 21	
Date	2021.02.22	Scale Asindicated



Date | 2021-07-22

City of Brampton
Planning and Development Department

A-2021-0189

Property Address: 3 Aylesbury Dr, Brampton, ON L7A 0V3 **Subject**: Minor Variance Application for 3 Aylesbury Dr

Project Description:

- The purpose of the project is to create a Second Unit in the basement of the property mentioned above.
- The main entrance of the property will be the existing side entrance built by the builder

Variances:

The Minor Variance application will have the following variance:

- TO ALLOW A SIDE ENTRANCE (EXISTING) TO A BASEMENT SECOND UNIT WITH A PATH OF TRAVEL OF 0.65m, WHEREAS THE BY-LAW REQUIRES 1.2m UNOBSTRUCTED PATH OF TRAVEL

Rationale:

- The side entrance to be used as a main entrance to the second unit is existing provided by the builder. The side yard setback is 0.65m.
- Due to the location of the stairs leading to the basement, it is not possible to provide a new side entrance.
- Providing a new entrance in the rear yard will require a excavation and foundation work to build a below grade entrance which will have a significantly high construction cost.
- The existing side entrance is the most economical and practical option to be the main entrance to the second unit.

Flower City



For Office Use Only (to be inserted by the Secretary-Treasurer after application is deemed complete)

FILE NUMBER: 4-2021-0189

The Personal Information collected on this form is collected pursuant to section 45 of the Planning Act and will be used in the processing of this application. Applicants are advised that the Committee of Adjustment is a public process and the information contained in the Committee of Adjustment files is considered public information and is available to anyone upon request and will be published on the City's website. Questions about the collection of personal information should be directed to the Secretary-Treasurer, Committee of Adjustment, City of Brampton.

APPLICATION Minor Variance or Special Permission

(Please read Instructions)

NOTE: It is required that this application be filed with the Secretary-Treasurer of the Committee of Adjustment and be accompanied by the applicable fee.

The undersigned hereby applies to the Committee of Adjustment for the City of Brampton under section 45 of the <u>Planning Act</u>, 1990, for relief as described in this application from By-Law **270-2004**.

	f Owner(s) Kishor Garewal & Samina Usman
	f Owner(s) Kishor Garewal & Samina Usman 3 Aylesbury Dr. BRAMPTON , ON L7A 0V3
Addiesa	3 AVIESDUTY DI, BRAMPTON, ON L/A 0V3
Phone #	201-724-8060 Fax #
Email	kishor2125@ gmail.com
Name of	f Agent ALHASAN ROBAH of YEJ STUDIO AND CONSULTING
Address	250 SHIELDS COURT, UNIT 7, MARKHAM ON L7A 0V3
Phone #	
Email	PERMITS@YEJSTUDIO.COM
Matrica	
	and extent of relief applied for (variances requested):
TO ALI	LOW SIDE ENTRANCE (EXISTING) TO A BASEMENT SECOND UNIT WITH A
	OF TRAVEL OF 0.65m, WHEREAS THE BY-LAW REQUIRES 1.2m
	STRUCTED PATH OF TRAVEL
1	
Why is i	t not nossible to comply with the provisions of the hydrw?
	it not possible to comply with the provisions of the by-law?
THE SI	IDE ENTRANCE IS ALREADY EXSITING (BUILT BY THE BUILDER) IN A SIDE
THE SI	
THE SI	IDE ENTRANCE IS ALREADY EXSITING (BUILT BY THE BUILDER) IN A SIDE
THE SI	IDE ENTRANCE IS ALREADY EXSITING (BUILT BY THE BUILDER) IN A SIDE
THE SI	IDE ENTRANCE IS ALREADY EXSITING (BUILT BY THE BUILDER) IN A SIDE
THE SI	IDE ENTRANCE IS ALREADY EXSITING (BUILT BY THE BUILDER) IN A SIDE
THE SI	IDE ENTRANCE IS ALREADY EXSITING (BUILT BY THE BUILDER) IN A SIDE
THE SI YARD	IDE ENTRANCE IS ALREADY EXSITING (BUILT BY THE BUILDER) IN A SIDE WITH 0.67m SETBACK TO THE PRPERTY LINE escription of the subject land:
THE SI YARD	IDE ENTRANCE IS ALREADY EXSITING (BUILT BY THE BUILDER) IN A SIDE WITH 0.67m SETBACK TO THE PRPERTY LINE escription of the subject land:
THE SI YARD	IDE ENTRANCE IS ALREADY EXSITING (BUILT BY THE BUILDER) IN A SIDE WITH 0.67m SETBACK TO THE PRPERTY LINE escription of the subject land:
THE SI YARD	IDE ENTRANCE IS ALREADY EXSITING (BUILT BY THE BUILDER) IN A SIDE WITH 0.67m SETBACK TO THE PRPERTY LINE escription of the subject land:
THE SI YARD	IDE ENTRANCE IS ALREADY EXSITING (BUILT BY THE BUILDER) IN A SIDE WITH 0.67m SETBACK TO THE PRPERTY LINE escription of the subject land: her LOT 231 mber/Concession Number M1878
Legal Do Lot Num Plan Nu Municip	IDE ENTRANCE IS ALREADY EXSITING (BUILT BY THE BUILDER) IN A SIDE WITH 0.67m SETBACK TO THE PRPERTY LINE escription of the subject land: nber LOT 231 mber/Concession Number M1878 al Address 3 Aylesbury Dr Brampton, CN L7A 0V3
Legal Do Lot Num Plan Nu Municip	IDE ENTRANCE IS ALREADY EXSITING (BUILT BY THE BUILDER) IN A SIDE WITH 0.67m SETBACK TO THE PRPERTY LINE escription of the subject land: her LOT 231 mber/Concession Number M1878 al Address 3 Aylesbury Dr Brampton, CN L7A 0V3
Legal Do Lot Num Plan Nu Municip Dimensi Frontag	IDE ENTRANCE IS ALREADY EXSITING (BUILT BY THE BUILDER) IN A SIDE WITH 0.67m SETBACK TO THE PRPERTY LINE escription of the subject land: her LOT231 mber/Concession Number M1878 al Address 3 Aylesbury Dr Brampton, CN L7A 0V3 ion of subject land (in metric units) le 11.60m
Legal Do Lot Num Plan Nu Municip Dimensi Frontag Depth	escription of the subject land: nber LOT231 mber/Concession Number plat Address 3 Aylesbury Dr Brampton, CN L7A 0V3 ion of subject land (in metric units) 11.60m 27.00m
Legal Do Lot Num Plan Nu Municip Dimensi Frontag	IDE ENTRANCE IS ALREADY EXSITING (BUILT BY THE BUILDER) IN A SIDE WITH 0.67m SETBACK TO THE PRPERTY LINE escription of the subject land: her LOT231 mber/Concession Number M1878 al Address 3 Aylesbury Dr Brampton, CN L7A 0V3 ion of subject land (in metric units) le 11.60m
Legal Do Lot Num Plan Nu Municip Dimensi Frontag Depth	escription of the subject land: nber LOT231 mber/Concession Number plat Address 3 Aylesbury Dr Brampton, CN L7A 0V3 ion of subject land (in metric units) 11.60m 27.00m
Legal Do Lot Num Plan Nu Municip Dimensi Frontag Depth Area	escription of the subject land: her LOT231 mber/Concession Number al Address 3 Aylesbury Dr Brampton, CN L7A 0V3 ion of subject land (in metric units) 1.60m 27.00m 313.2m
Legal Do Lot Num Plan Nu Municip Dimensi Frontag Depth Area	escription of the subject land: Note
Legal Do Lot Num Plan Nu Municip Dimensi Frontag Depth Area Access Provinci	DE ENTRANCE IS ALREADY EXSITING (BUILT BY THE BUILDER) IN A SIDE WITH 0.67m SETBACK TO THE PRPERTY LINE escription of the subject land: nber LOT 231 mber/Concession Number M1878 al Address 3Aylesbury Dr Brampton, CN L7A 0V3 ion of subject land (in metric units) e 11.60m 27.00m 313.2m to the subject land is by: ial Highway Seasonal Road
Legal Do Lot Num Plan Nu Municip Dimensi Frontag Depth Area Access Provinci Municip	escription of the subject land: aber LOT231 mber/Concession Number al Address 3 Aylesbury Dr Brampton, CN L7A 0V3 ion of subject land (in metric units) e 11.60m 27.00m 313.2m to the subject land is by: ial Highway al Road Maintained All Year
Legal Do Lot Num Plan Nu Municip Dimensi Frontag Depth Area Access Provinci Municip	DE ENTRANCE IS ALREADY EXSITING (BUILT BY THE BUILDER) IN A SIDE WITH 0.67m SETBACK TO THE PRPERTY LINE escription of the subject land: nber LOT 231 mber/Concession Number M1878 al Address 3Aylesbury Dr Brampton, CN L7A 0V3 ion of subject land (in metric units) e 11.60m 27.00m 313.2m to the subject land is by: ial Highway Seasonal Road

8.	land: (specify	<u>in metric units </u>	nd structures on or proposed for the subject ground floor area, gross floor area, number of etc., where possible)
	EXISTING BUILDING	SS/STRUCTURES on	the subject land: List all structures (dwelling, shed, gazebo, etc.)
	DETACHED DWE	ELLING	
	GFA: 292 SQ.M		
		NGS/STRUCTURES of	
	GFA: 292 SQ.M	MAIN UNCHANGE	ED
9.	Location of all	buildings and s	tructures on or proposed for the subject lands:
			ar and front lot lines in metric units)
	FUATILA		
	EXISTING Front yard setback	3.79m	
	Rear yard setback	7.0m	
	Side yard setback Side yard setback	0.65m 1.24m	
	olde yard semack	1.2411	THE RESIDENCE OF THE PROPERTY
	PROPOSED	EMOTELO TO DELLA	
	Front yard setback Rear yard setback	EXISTING TO REMAIN	IN
	Side yard setback	EXISTING TO REMAIN	**
	Side yard setback	EXISTING TO REMAIN	
10.	Date of Acquisition	of subject land:	2019
11.	Existing uses of sub	ject property:	Residential
12.	Proposed uses of su	ubject property:	Residential
13.	Existing uses of abu	Itting properties:	Residential
	_		
14.	Date of construction	ı of all buildings & st	ructures on subject land: 2012
15.	Length of time the e	xisting uses of the su	ubject property have been continued: Since built
16. (a)	What water supply is Municipal ✓ Well	s existing/proposed?]]	Other (specify)
(b)	What sewage disposements Municipal Septic	sal is/will be provided]]	d? Other (specify)
(c)		e system is existing/p	proposed?
	Sewers Ditches Swales		Other (specify)

17.	Is the subject property the subject subdivision or consent?	ect of an a	pplication u	nder the Planning	Act, for approval of a plan of
	Yes No 🗸				
	If answer is yes, provide details:	File#	<u> </u>		Status
18.	Has a pre-consultation application	on been fil	ed?		
	Yes 🗆 No 🗹				
19.	Has the subject property ever be	en the sub	pject of an ap	plication for mine	or variance?
	Yes No 🗸		Unknown		
	If answer is yes, provide details:				
	File # Decision File # Decision File # Decision			Relief_ Relief_ Relief	
	File # Decision			-//-(-/	710
				MOSON	yblex
					(s) or Authorized Agent
DAT	EDAT THE CITY	. OF	BRAMPTON		
THIS	A JG DAYOF A DAY	Ì	_, 20<u>26,</u>2 į		
THE SUB	APPLICATION IS SIGNED BY AN A EJECT LANDS, WRITTEN AUTHOR PLICANT IS A CORPORATION, PATION AND THE CORPORATION	THE APP	OF THE OWN	IER MUST ACCOM HALL BE SIGNE	MPANY THE APPLICATION. IF
	Samina Usman				Brampton OF WARKHAM
	Peel			IE CITY	
	REGION OF YORK		_	DECLARE THAT:	
	THE ABOVE STATEMENTS ARE T IG IT TO BE TRUE AND KNOWING				
DECLAR	ED BEFORE ME AT THE		Jeanie a Comr	Cecilia Myers nissioner, etc.,	
CI	T OF Brancton		Provinc	e of Ontario Corporation of th	
Car.	1 of Stampton	-	City of I	Brampton	е
IN THE	Keglow OF		Expires .	April 8, 2024.	
Peel	- THIS 16th DAY OF		0	la r	1
Δ,	20 21			ignature of Applica	ant or Authorized Agent
	, 20		5		nt or Authorized Agent
/	Leave My us			Submit	by Email
//	A Commissioner etc.	1			
7		FOR OF	FICE USE OF	ILY	
	Present Official Plan Designation	m:			
	Present Zoning By-law Classific	ation:		R1F -	2201
	This application has been review said review			ariances required a ached checklist.	nd the results of the
	HOTHI S.			AUGU	JST 16 2021
	Zoning Officer			S	Date
	DATE RECEIVED	Δ.,	aust 1	6,2021	
	Date Application Deemed	ı <u></u>		*	Revised 2020/01/07
	Complete by the Municipality	£1			4





INDEX					
Number	Sheet Name				
A-01	COVER PAGE				
A-02	SITE PLAN				
A-03	EXT. BASEMENT				
A-04	EXT. MAIN FLOOR				
A-05	EXT. SECOND FLOOR				
A-06	PROP. BASEMENT				
A-07	PROP. MAIN FLOOR				
A-08	PROP. SECOND FLOOR				
A-10	SOUTH ELEVATION				
A-11	SECTIONS				
A-12	SCHEDULES				
AN-01	GENERAL NOTES				
AN-02	CONSTRUCTION NOTES				
AN-03	CONSTRUCTION NOTES				

BASEMENT SECOND UNIT

KISHOR GAREWAL

3 AYLESBURY DR BRAMPTON, ON, L7A oV3



7-250 SHEILDS CRT.
MARKHAM ON L3R 9T5
888.236.9958 I 416.483.5393
INFO@YEJSTUDIO.COM
WWW.YEJSTUDIO.COM


BASEMENT SECOND UNIT 3 AYLESBURY DR BRAMPTON, ON, L7A oV3

THE TREP POSSESS AND A POSSESS AT LEASE TO A TREE THE THE THE HAND, AND THE STREED VALUE FOR THE ADMINISTRATION AND ADMINISTRATION ADMINISTRATION AND ADMINISTRATION ADMINISTRATIO



EVISION	2021.03.19
SUED FO	R PERMIT 2021.03.2

COVER PAG	GE	
Drawn by	S.D	A-01
Project number	21 RE 500 21	7101
Date	2 021.02.22	Scale

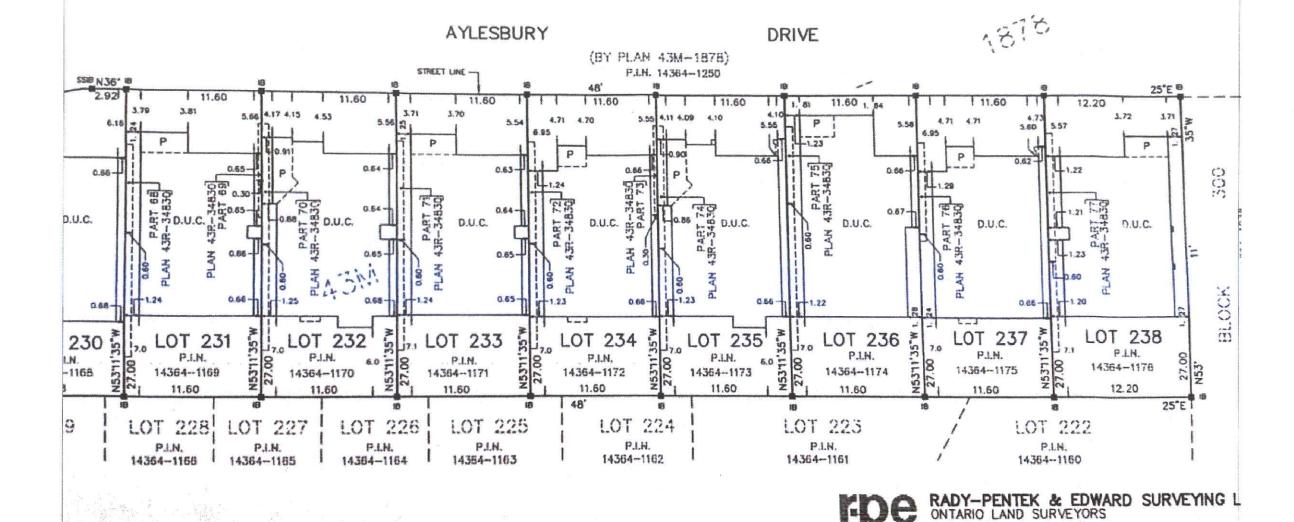


Woodbridge, Ontario L4L 8A3
Tel (416)635-5000 Fax (416)635-5001

643 Christea Road, Suite 7



ROOM AREA	
<u>Name</u>	Area
BASEMENT	
BEDROOM 1	129 SF
W/C	43 SF
STORAGE	104 SF
LAUNDRY	28 SF
FURNACE	37 S F
CLOSET	10 SF
CLOSET	8 SF
LIVING/DINING	240 SF
KITCHEN	161 SF
HALLWAY	137 SF
	896 SF
MAIN FLOOR	
GREATROOM	220 S F
W/C	24 S F
BREKFAST	130 SF
CLOSET	11 SF
DEN	70 SF
DINING ROOM	195 SF
GARAGE	363 SF
KITCHEN	131 SF
FOYER	107 SF
EXIT	16 SF
	1267 SF

<u>Name</u>	Area
SECOND FLOOR	
LAUNDRY	46 SF
W/C	71 S F
CLOSET	13 SF
BEDROOM 4	112 S F
MASTER BEDROOM	214 SF
W.I.C	55 SF
HALLWAY	14 SF
W.I.C	26 SF
LINEN	11 SF
W/C	27 S F
HALLWAY	37 SF
HALLWAY	145 SF
W/C	52 SF
CLOSET	9 5 F
BEDROOM 3	127 S F
CLOSET	10 SF
BEDROOM 2	165 SF
	1134 SF
Total Building Area: 37	3297 SF

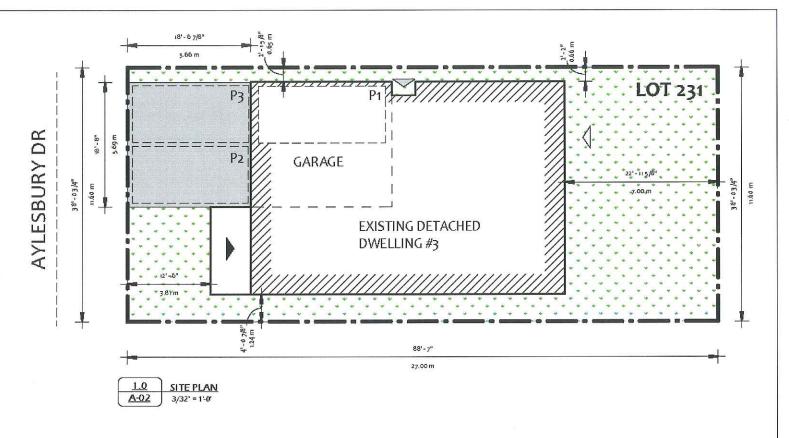

FLOOR / UNIT	AREA		
AREA	<u>SQFT</u>	<u>SQM</u>	
BASEMENT (UNIT 2)	947.68	88.04	
FIRST FLOOR (UNIT 1)	949.32	88.19	
FIRST FLOOR (COMMON AREA)	23.19	2.15	
SECOND FLOOR (UNIT 1)	1225.66	113.86	
TOTAL BUILDING AREA	3145.85	292.24	

UNIT 1 MAIN ENTRANCEUNIT 1 SECONDARY ENTRANCEUNIT 2 ENTRANCE



7-250 SHEILDS CRT. MARKHAM ON L3R 9T5 888.236.9958 I 416.483.5393 INFO@YEJSTUDIO.COM WWW.YEJSTUDIO.COM

BASEMENT SECOND UNIT 3 AYLESBURY DR BRAMPTON, ON, L7A oV3


THE TREATM OF THE WORLD WAS TAKEN THE STORM THE TREATM OF THE STORM OF


QUALIFICATION INFORMATION
BUILDES DESIGN & EXEMPT UNDER LAW OF DEVE
AME
AND CONTRACTOR OF THE CONTRACT





EVISION 2021.03.19	
SSUED FOR PERMIT 202	1.03.22


SITE PLAN	3		
Drawn by	H.R		Δ-02
Project number	21 RE 500 21		1102
Date	2021.02.22	Scale	Asindicated

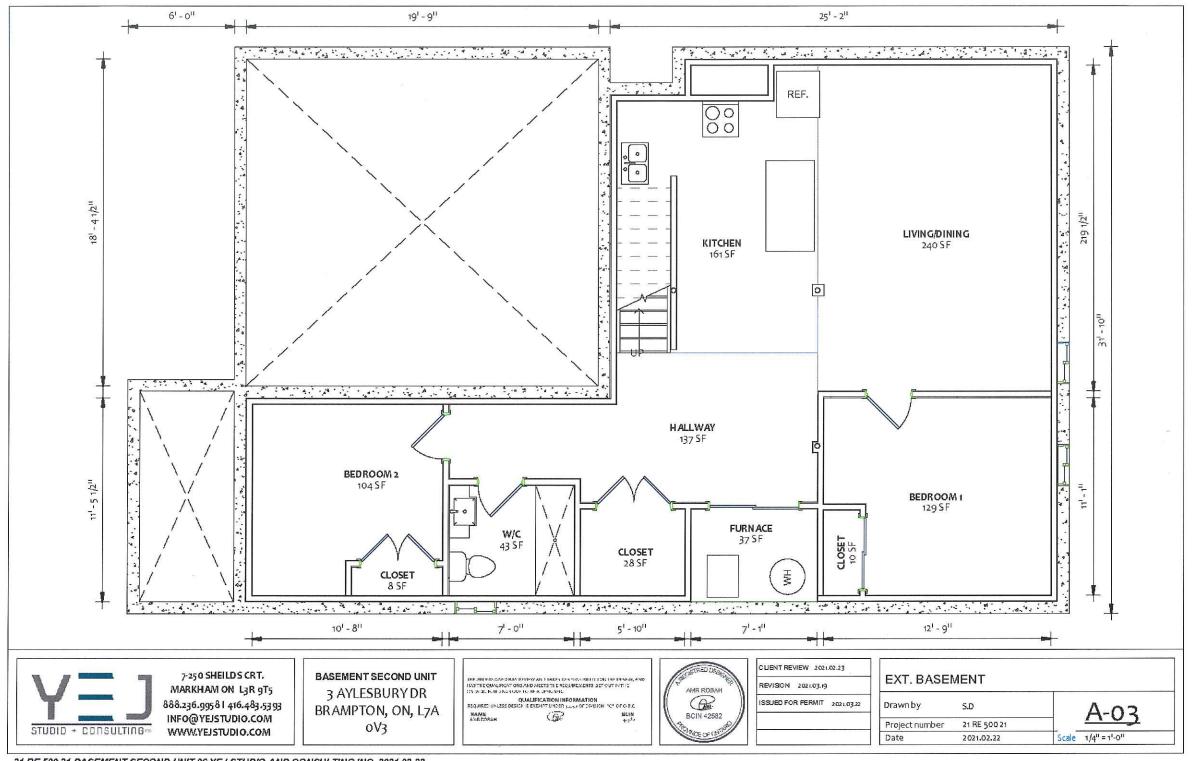


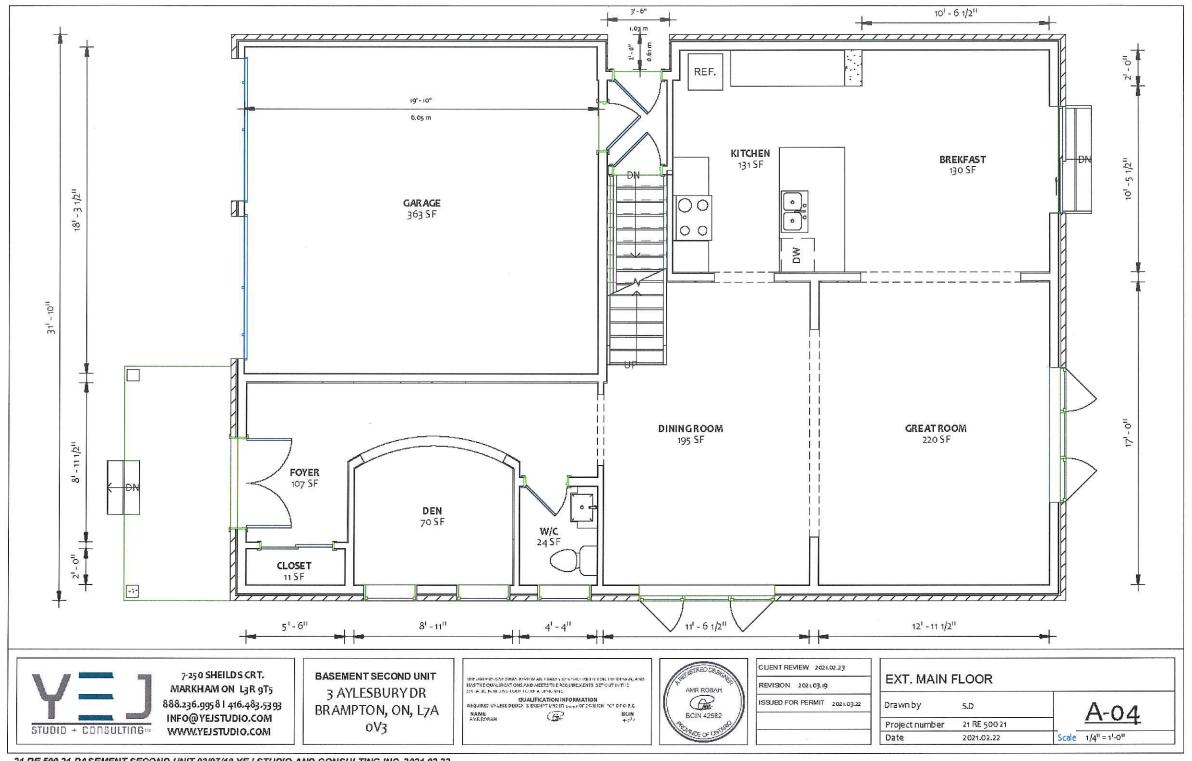

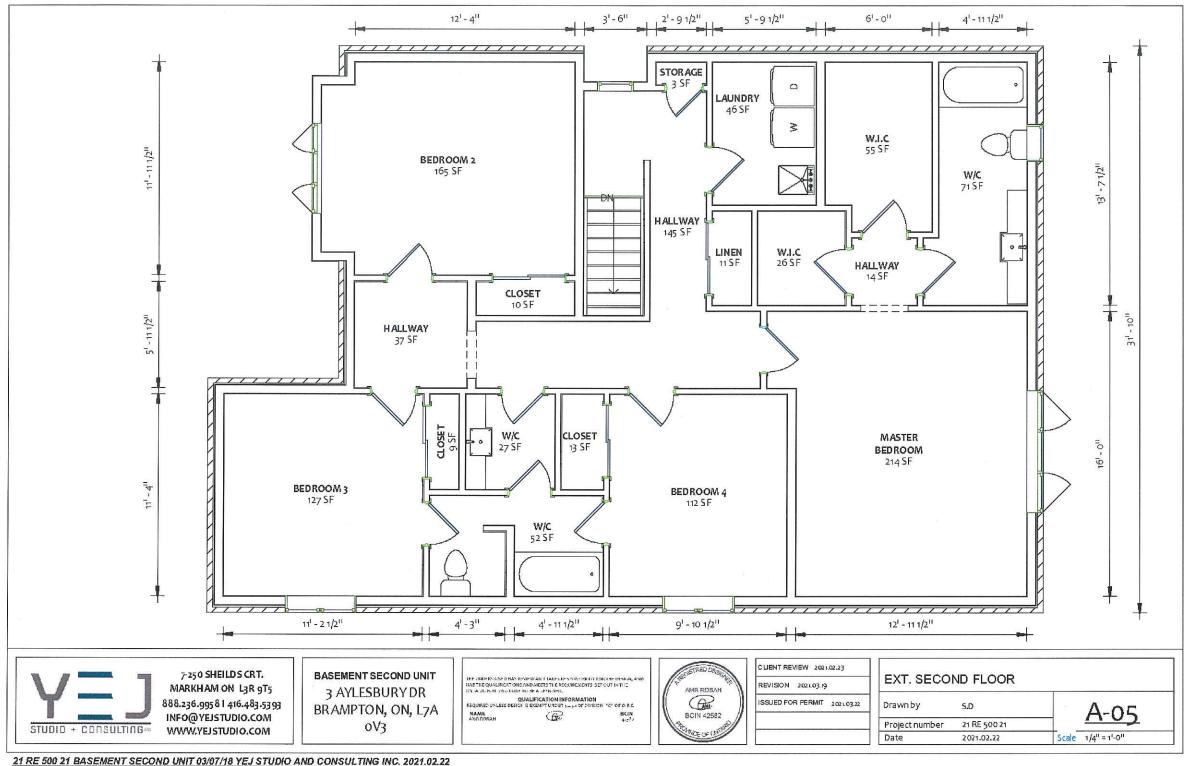

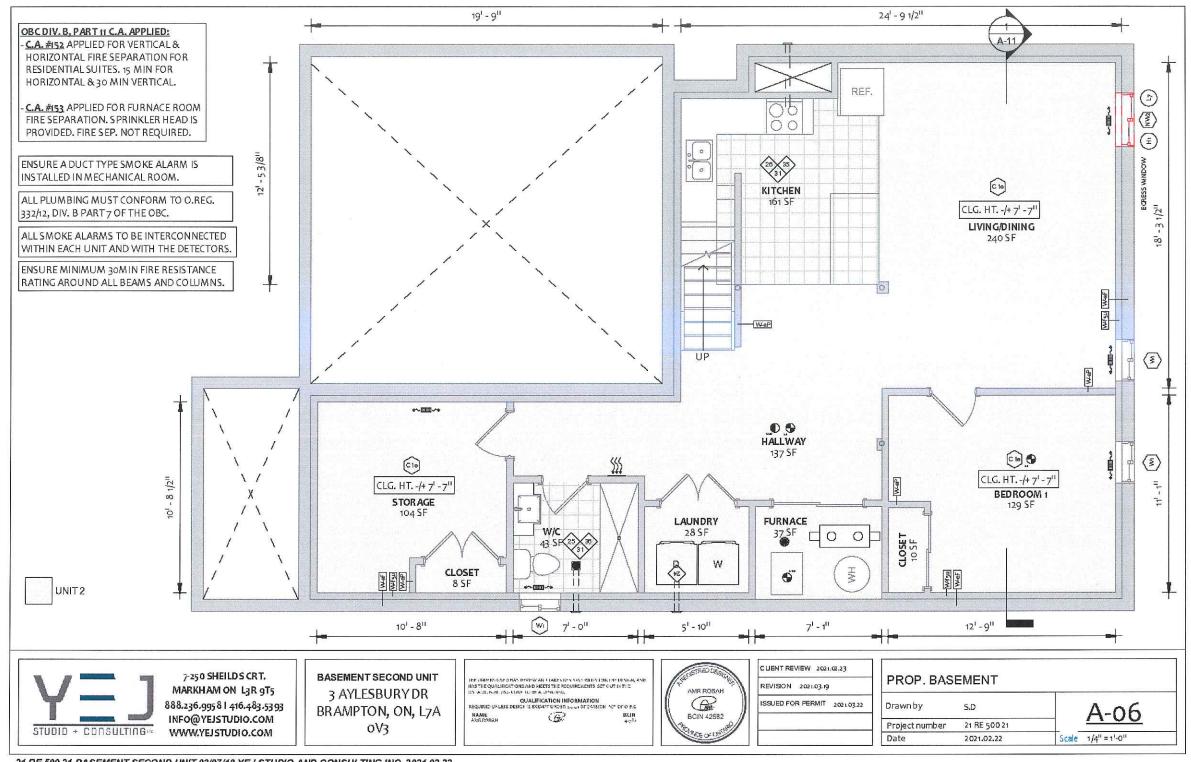

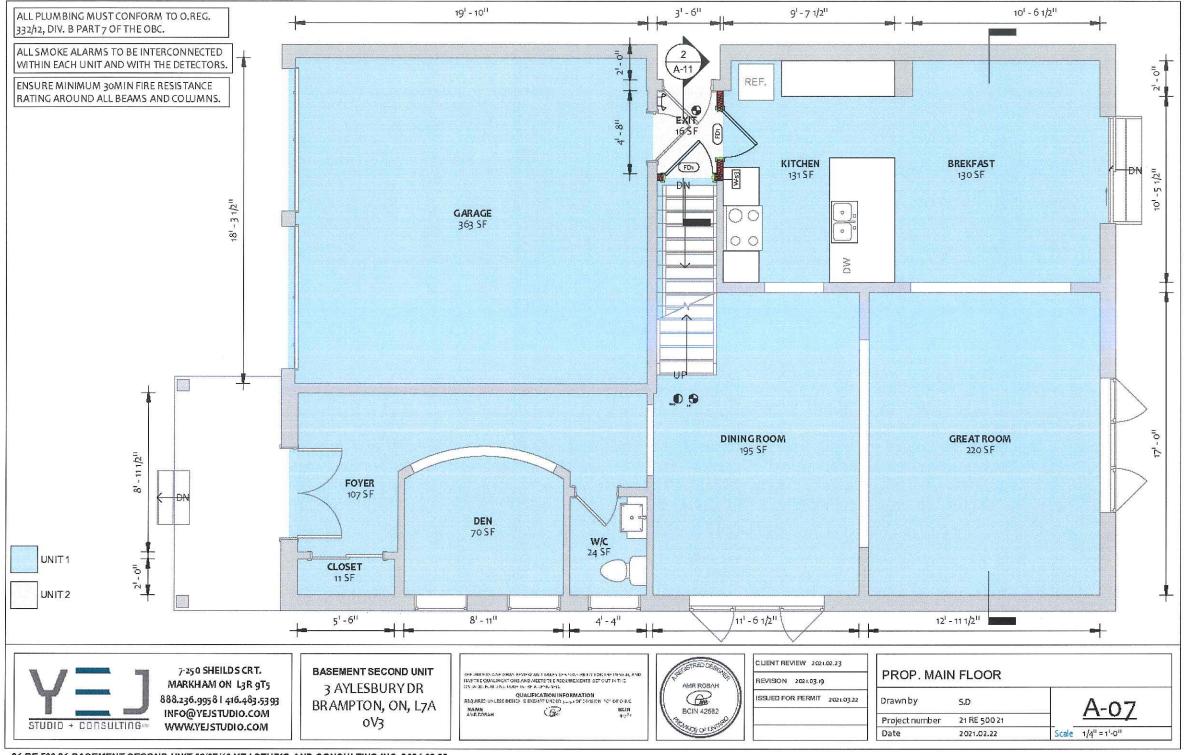

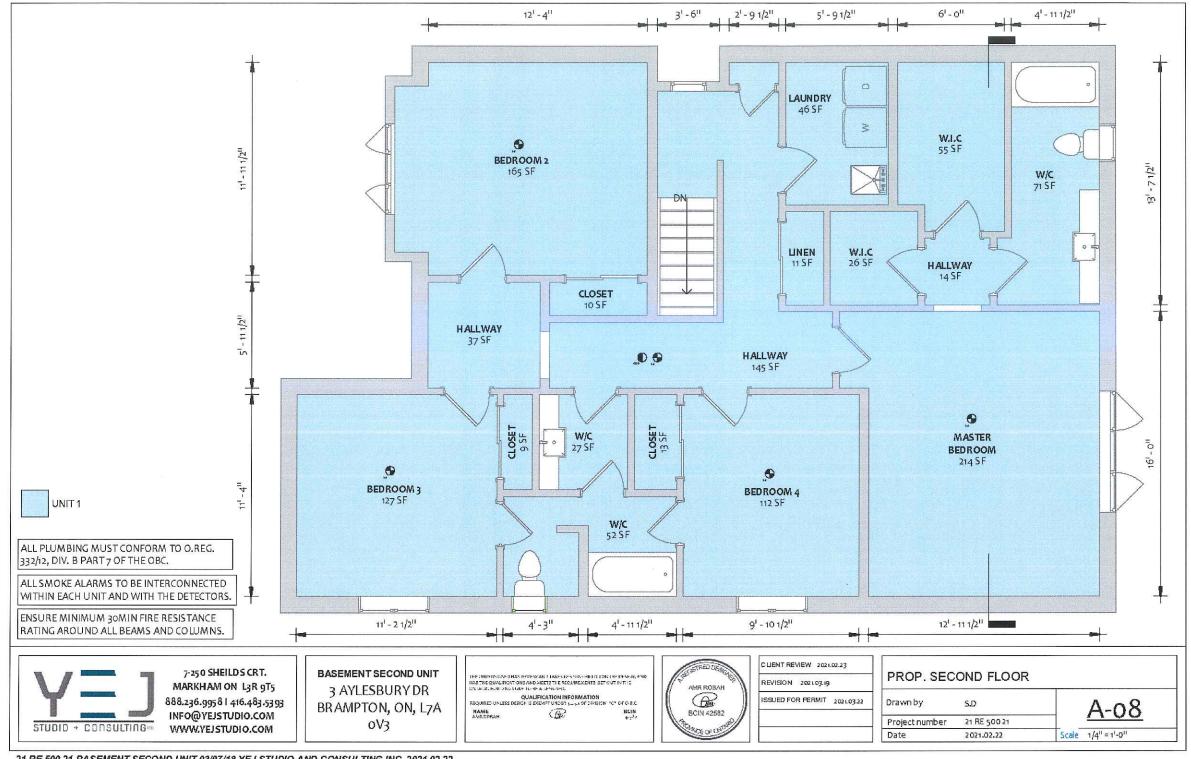





7-250 SHEILDS CRT.
MARKHAM ON L3R 9T5
888.236.9958 I 416.483.5393
INFO@YEJSTUDIO.COM
WWW.YEJSTUDIO.COM

BASEMENT SECOND UNIT 3 AYLESBURY DR BRAMPTON, ON, L7A oV3

THE THEF HAS NOTED HAS ROMEWARD THEN THE MISSING THE FOR THE PARK, AND HAS THE QUALIFICATIONS AND MEETS THE REQUIREMENTS SET OUT IN THE DISTABLE KNILL YOU COME TO SHALL SHOWNED.

QUALIFICATION INFORMATION
REQUIRES UNLESS DESIGN IS EXEMPT UNDER 122-15 OF DAMESON ICS OF O.B.C.
NAME
AND DOBAH

(70)

BC(III)



CUENT REVIEW 2021.02.23

REVISION 2021.03.19

ISSUED FOR PERMIT 2021.03.22

Date


SOUTH ELEVATION

Drawn by S.D

Project number 21 RE 500 21

2021.02.22

Scale 3/16" = 11-0"

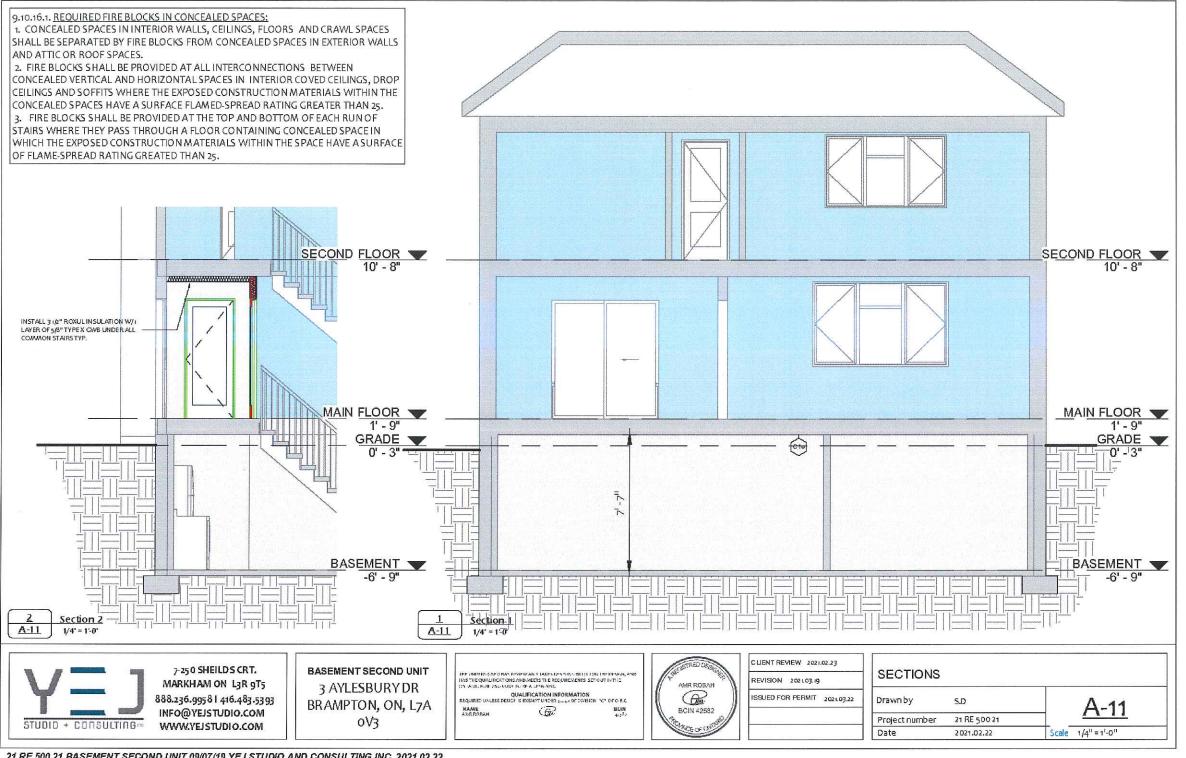

DOOR SCHEDULE Ct. Level Width Height Phase Created Type Comments FD₁ MAINFLOOR $2^{1} - 8^{11}$ 61 - 811 20 MIN FIRE RATED W/SELF New Construction CLOSING DEVICE FD₁ MAIN FLOOR $2^{1} - 8^{11}$ 61 - 811 New Construction 20 MIN FIRE RATED W/ SELF CLOSING DEVICE Grand total: 2

LIN	ITEL SCHEDULE
NO.	DESCRIPTION
H1	2-2x8
H2	3-2x8
Нз	2 - 2X10
H4	3 - 2×10
H5	2 - 2 <i>X</i> 12
Н6	3 - 2 <i>X</i> 12
L7	L-5 x 3 1/2 x 5/16
L8	L-5 x 5 x 5/16
L9	L-5 x 5 x 1/2

STRUC ELEMENTS

CEILING SCHEDULE



EXISTING CILING

-EX. FLOOR FINISH -EX FLOOR JOIST

-EXISTING | LAYER 1/2" GYPSUM BOARD

* NOTE: NO OPENINGS ARE PERMITTED

WINDOW SCHEDULE							
Туре	Ct.	<u>Level</u>	Width	Height	GLASS AREA	Phase Created	
NW2	1	BASEMENT	3'-0"	3'-0"	8.10 SF	New Construction	
W1	1	BASEMENT	21 - 411	1 - 11 11	4.03 SF	Existing	
W₁	1	BASEMENT	21 - 411	11 - 1111	4.03 SF	Existing	
W1	1	BASEMENT	21 - 411	11 - 1111	4.03 SF	Existing	

Grand total: 4

No.	Elevation	Room Name	Room Area (sqft)	Req. Win. %	Req. Win. Area (sqft)	Glass Area (sqft)
V1		BEDROOM 1	129 sqft	2.5 %	3.22 sqft	4.03 sqft
№ 1		LIVING / DINING 240 sq1 ROOM	240 sqft	5 %	12 sqft	12.12 sqft

WALL SCHEDULE

WeF EXISTING FOUNDATION WALL

WeX EXISTING EXTERIOR WALL

W-eP EXISTING STUD PARTITION WALL

W-f5u EXTERIOR - BASEMENT INSULATED STUD WALL

- I" AIR GAP

-EX. 2"x4" @ 16" o.c STUDS -EX. IN SULATION ON STUDS CAMTIES

- EX. AIR/VAPOUR BARRIER


- EX. 1/2" GYPSUM WALL BOARD

W453 NEWINTERIOR-30min FIRE SEP. (Wic)

- I LAYER IZ" RECULAR GWB

-2"x4" WOOD STUDS @16"o.c.

- ROXUL INSULATION IN CAUTIES - ILAYER I/L' REGULAR GWB

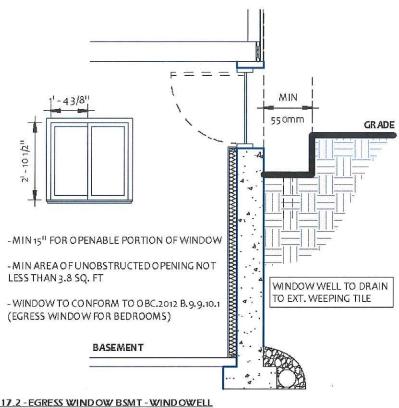

A-12 3/8" = 1'-0"

D17.2 - EGRESS WINDOW BSMT - WINDOWELL



7-250 SHEILDS CRT. MARKHAM ON L3R 9T5 888.236.99581 416.483.5393 INFO@YEJSTUDIO.COM WWW.YEJSTUDIO.COM

BASEMENT SECOND UNIT 3 AYLESBURY DR BRAMPTON, ON, L7A oV3

THE PRIMITION OF BHAN BONEY AND TAKEN FOR MAKING BY LOCK HE DESIGN, AND MAKENE QUALIFICATIONS AND ALERS THE REQUIREMENTS SET OUT IN THE DISCUSSION FOR A DEPOT OF A DESIGNATION OF A DESIGNATION

QUALIFICATION INFORMATION
REQUIRED UNLESS DESIGN IS EXEMPT UNDER 1.1.4. OF DISION INC. OF O R.C. NAME AND DORAH

Gir



CLIENT REVIEW 2021.02.23 REVISION 2021.03.19 ISSUED FOR PERMIT 2021.03.22

SCHEDULE	S	
Drawn by	S.D	Δ-12
Project number	21 RE 500 21	1112
Date	2021.02.22	Scale Asindicated

GENERAL NOTES:

I. ALL CONSTRUCTION SHALL MEET WITH THE LATEST REQUIREMENTS OF:

- AUTHORITIES HAVING JURISDICTION.
- ZONING RESTRICTIONS AND COMMITTEE OF ADJUSTMENT DECISIONS.
- ONTARIO BUILDING CODE
- ONTARIO REGULATIONS UNDER THE HEALTH AND PROMOTION ACT.
- ONTARIO FIRE CODE
- · ALL SUPPLIERS SPECIFICATIONS RE: THE TECHNICAL METHODS TO USE MATERIALS AND THE SAFEST SYSTEM TO INSTALL BREAKABLE OR HANGING MATERIALS SUCH AS GLASS OR LIGHT FIXTURES ETC.

II. CONTRACTOR SHALL:

- CONFIRM ALL DIMENSIONS ON SITE AND REPORT ANY DISCREPANCIES OR ERRORS TO THE ARCHITECT AND THE PARTIES INVOLVED.
- WORK ONLY FROM THE APPROVED PERMIT DRAWINGS AND SPECIFICATIONS THAT ARE STAMPED AND SIGNED BY THE ARCHITECT.
- RETAIN A CERTIFIED SURVEYOR TO CHALK OUT ALL PROPERTY LINES. BUILDING BOUNDARIES AND LIMITATIONS AND CONFIRM GRADES OF THE
- PRIOR TO EXCAVATION, TAKE PRECAUTION IN SUCH A MANNER TO PREVENT DAMAGE TO ADJACENT PROPERTIES, EXISTING STRUCTURE, UTILITIES, ROADS AND SIDEWALKS.
- . PRIOR TO CONSTRUCTION CHECK WITH ALL INSPECTORS OF ALL AUTHORITIES HAVING JURISDICTION ON THE PROJECT REGARDING SCHEDULES OF INSPECTIONS AND ARRANGE FOR THEIR SITE VISITS AND CALL ALL UTILITY COMPANIES (GAS, HYDRO, CABLE, WORKS DEPT ... etc.) TO CHECK ALL EXISTING LINES, PIPES, TREES,
- PROVIDE ALL REQUIRED LATERAL FRAMING SUPPORTS (TO ENSURE RIGIDITY AND STURDINESS) THAT DO NOT SHOW ON DRAWINGS
- NOT PLACE MATERIALS NOR PLACE OR OPERATE EQUIPMENT IN OR ADJACENT TO AN EXCAVATION IN A MANNER THAT MAY ENDANGER THE INTEGRITY OF THE EXCAVATION OR ITS SUPPORTS.
- NOT SCALE DRAWINGS UNLESS OTHERWISE MENTIONED
- COMPLY BY SOIL REPORT WHENEVER APPLICABLE.
- USE ONLY APPROVED SUPPLIERS & INSTALLERS

III. SHOP DRAWINGS:

- THE REVIEW OF SHOP DRAWINGS IS FOR THE SOLE PURPOSE OF ASCERTAINING CONFORMANCE WITH THE GENERAL DESIGN CONCEPT. IT SHALL NOT MEAN APPROVAL OF THE DETAIL DESIGN INHERENT IN THE SHOP DRAWING, RESPONSIBILITY FOR WHICH SHALL REMAIN WITH THE CONTRACTOR SUBMITTING SAME, AND SUCH REVIEW SHALL NOT RELIEVE THE CONTRACTOR OF HIS RESPONSIBILITY FOR MEETING ALL REQUIREMENTS OF THE CONTRACT DOCUMENTS. THE CONTRACTOR IS RESPONSIBLE FOR DIMENSIONS TO BE CONFIRMED AND CORRECTED AT THE JOB SITE, FOR INFORMATION THAT PERTAINS SOLELY TO FABRICATION, PROCESSES OR TO TECHNIQUES OF CONSTRUCTION AND INSTALLATION AND OR COORDINATION OF THE WORK OF ALL SUB-TRADES.
- ALL SHOP DRAWINGS SHALL BE STAMPED BY THE MANUFACTURER'S STRUCTURAL ENGINEER PRIOR TO SUBMITTING FOR REVIEW BY ARCHITECT.
- SEQUENCE OF SHOP DRAWINGS REVIEW: - CONTRACTOR STRUCTURAL ENGINEER - ALL OTHER INVOLVED CONSULTANTS ARCHITECT
- SHOP DRAWINGS SHALL BE PROVIDED FOR: -STEEL - PREFAB. CONC. - CANOPIES - WINDOWS - DOORS

GENERAL NOTES:

IV.RENOVATION AND ADDITION CONSTRUCTION:

- •REPAIR ALL DEFECTIVE OR DAMAGED CONDITIONS IN BUILDING AND SITE THEN FINISH THEM TO MATCH
- ALL EXISTING CONSTRUCTION SHALL BE ALL FINISHED UNLESS OTHERWISE MENTIONED, CHECK WITH ARCHITECT.

V. BONDING EXISTING TO NEW CONSTRUCTION:

- PROVIDE 1/2" DIA, X 6" LONG ANCHOR BOLTS SPACED 3'-0" O/C VERTICALLY OR HORIZONTALLY BETWEEN EXISTING AND NEW STUDS AND ROOF FRAMINGS. PROVIDE OVERLAPPED VERTICAL JOINTS BETWEEN EXISTING AND NEW MASONRY VENEERS, WALLS AND FOUNDATION.
- · SAND BLASTED AREA SHALL BE FINISHED WITH A CLEAR SEALANT.

CONSTRUCTION SPECIFICATIONS

1. WOOD

- ALL WOOD CONSTRUCTION SHALL BE IN ACCORDANCE WITH CSA 086 BEAMS AND LINTELS & JOISTS SHALL BE KILN DRIED.STAMPED SPRUCE #2. UNLESS
- OTHERWISE MENTIONED.
- · ALL WOOD MEMBERS WHICH ARE PLACED IN SOIL SHOULD BE PRESSURE TREATED WITH A WOOD PRESERVATIVE.
- ALL EXTERIOR WOOD SHALL BE STAINED OR PAINTED.

2. CONCRETE

- SHALL COMPLY WITH CSA A23 SERIES INCL. COLD WEATHER CONCRETING.
- MINIMUM COMPRESSIVE STRENGTH OF UNREINFORCED CONCRETE: 25 MPA AND 35 MPA FOR LOADING DOCK AND FOR ALL EXPOSED CONCRETE AFTER 28 DAYS WITH AIR ENTRAINMENT 6 %
- . MAXIMUM SLUMP 3"
- PROVIDE SEALANT-TOPPED EXPANSION JOINT BETWEEN EXISTING AND NEW CONCRETE FLOORS.
- REINFORCEMENT SHALL CONFORM CSA 30.12 GRADE 58

3. STEEL

- SHALL CONFORM TO CSA STANDARDS & CAN 3-G40.21 (STRUCTURAL STEEL QUALITY)
- SHALL BE TREATED ON THE OUTSIDE SURFACE WITH AT LEAST ONE COAT OF RUST INHIBIT PAINT.
- ALL EXPOSED STEEL SHALL BE GALVANIZED.
- STEEL GRADE
- I) HOLLOW SECTION: G 40.21-M 350W
- II) I BEAMS & COLUMNS: G 40.21-M 350W
- O.W.S.J.: LIVE LOAD DEFLECTION SHALL NOT EXCEED 1/360 OF SPAN. TOTAL LOAD DEFLECTION SHALL NOT EXCEED 1/300 OF SPAN.
- WELDING SHALL COMPLY WITH CSA W59 AND EXECUTED BY CERTIFIED WELDER.
- ALL BOLTS A 325 BOLTS.
- FOR ALL STEEL FABRICATION, PROVIDE SHOP DRAWINGS AND CALCULATIONS STAMPED BY P. ENG.

CONSTRUCTION SPECIFICATIONS

4. MINIMUM STRUCTURAL BEARING

(PROVIDE 2 SOLID MASONRY BLOCKS BELOW BEARING)

- WOOD JOIST: 2"
- WOOD BEAMS: 4"
- STEEL BEAM: 8"
- STEEL LINTEL: 8"
- O.W.S.J.: 6" ON MASONRY & 21/2" ON STEEL & SHALL HAVE 4" DEEP SHOES

5. MASONRY

- SHALL HAVE 1000 PSIMIN, CRUSHING STRENGTH
- PROVIDE GALVANIZED STANDARD BLOCK-LOK EACH 2ND COURSE.
- VERTICAL JOINTS SHALL BE STAGGERED & CORNERS INTERLOCKED
- PROVIDE SHOP DRAWINGS STAMPED BY P. ENG. FOR STONE VENEER & PREFAB PANELS.
- VERTICAL CRACK CONTROL JOINTS (DESIGNED TO RESIST MOISTURE PENETRATION AND KEYED TO PREVENT RELATIVE DISPLACEMENT OF THE WALL PORTIONS ADJACENT TO THE JOINT) SHALL BE PROVIDED IN FOUNDATION WALLS MORE THAN 82'-0" LONG AT INTERVALS OF 50'-0" MAX. AND FLUSH WITH OPENING JAMBS.

6. FOUNDATION

- FOOTING AND SONO TUBE FOUNDATION SHALL BEAR ON UNDISTURBED SOIL OR COMPACTED ENGINEERED FILL (TO 98 % STANDARD PROCTOR DENSITY) CAPABLE OF A BEARING OF 3000 PSF, SOIL SHALL BE CHECKED BY SOIL ENGINEER
- DEPTH OF FOOTING ARE PROVISIONAL & SUBJECT TO VERIFICATION ON SITE BY A SOIL ENGINEER.
- · ALL EXTERIOR (OR EXPOSED TO EXTERIOR) WALLS, PARTITION, COLUMNS SHALL BE PROVIDED WITH 4'-0" DEEP FOUNDATION.
- PROVIDE 5/8" DIA. X 16" LONG ANCHOR TIES (8" IN NEW CONSTRUCTION). TOP TWO COURSES OF CONCRETE BLOCKS SHALL BE FILLED WITH
- CONCRETE.
- PROVIDE MIN 8"X2'-0" WIDE STRIP FOOTING BELOW ANY INTERIOR LOAD **BEARING WALL**

7. COLUMNS

 SHALL BE SECURELY FASTENED TO CENTER OF FOUNDATIONS AND TO THE SUPPORTED MEMBERS TO PREVENT LATERAL MOVEMENT.

8. DESIGN LOADS

UN FACTORED DESIGN LOADS

- 1. SNOW LOAD = kPa (PART 4 DESIGN, Ss= 2.0 kPa, Sr = 0.4kPa)
- 2. ROOF DEAD LOAD = 0.75kPa
- 3. SECOND FLOOR DEAD LOAD=0.75kPa
- 4. MAIN FLOOR DEAD LOAD=1.0kPa
- 5. OCCUPANCY LIVE LOAD=1.9kPa
- 6. WIND PRESSURE q(1/50) = 0.44 Kpa
- 7. ASSUMED SOIL BEARING CAPACITY =75 kPa
- 8. GUARDS TO BE BUILT ACCORDING TO OBC 2012 SB-7



7-250 SHEILDS CRT. MARKHAM ON L3R 9T5 888.236.99581 416.483.5393 INFO@YEJSTUDIO.COM WWW.YEJSTUDIO.COM

BASEMENT SECOND UNIT 3 AYLESBURY DR BRAMPTON, ON, L7A oV3

THE JUDICIONATE BHAS REVIEW AND LABOR TO SUBJECT LOW THE DESIGN HAS THE QUALIFICATIONS AND MEETS THE REQUIREMENTS SET OUT BY HE DV A 3E BUILDING CODE TO SEA DESCRIBE

NAME AMBROBAH (fix






CLIENT REVIEW 2021.02.23 REVISION 2021.03.19 ISSUED FOR PERMIT 2021.03.22

GENERAL NOTES Drawn by AR Project number 21 RE 500 21 Date 2021.02.22 Scale

CONSTRUCTION NOTES

ALL CONSTRUCTION TO ADERE TO THESE PLANS AND SPECS AND TO CONFORM TO ONTARIO BUILDING CODE AND ALL OTHER APPLICABLE CODE AND AUTHORITIES HAVING JURISDICTION THES REQUIREMENTS ARE TO BE TAKEN AS MINIMUM SPECIFICATIONS ONT.REG.350/06

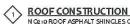

N O2 10 ROOF ASPHALT SHINGLES ON 1/8" PLYWOOD SHEATHING WITH H-CLIPS.APPROUVED WOODTRUSSES @24" O.C MAX APPROUVED EAVES PROTECTION TO EXTEND 3' FROM EDGE OF ROOF AND MIN. 12" INNER FACE OF EXTERIOR WALL . 2"X4" TRUSS BRACING @6" O.C. BOTTOM CORD.PREFIN. ALUM EAVSTROUGH, FASCIAR WL& VENTED SOFFIT, ATTIC VENTILATION

1:300 OF INSULATED EILING AREA WITH 50% AT EAVS. STONE VENEER WALL CONSTRUCTION

4" FACE STONE ,I" AIR SPACE 0.03 THICK X 7/8 WIDE GALVANIZED METALTIES INSRALLED W/GALVANIZED SPIRAL NAILS 32" O.CHORIZ,16" O.C VERT SHEATHING PAPER, LAYERS TO OVERLAP EACH OTHER ON JA" EXTERIOR TYPE SHEATHING . 2"X6" WOOD STUDS @16" O.C. R24 BATT INSULATION IN CONTINUOUS CONTACT WISHEATHING AND VAPOUR BARIER IAIR BARIOUR BOUBLE PLAT AT THET OP, SIN CLE PLATE AT THE BOTTOM

(3) STONE VANEER @ FDN. WALL

20 MM POLY FLASHING MINIMUM 6" UP BEHIND SHEATHING PAPER.WEEPING HOLES @ MIN 21-7" APART

STUCCO WALL CONSTRUCTION

COATS OF STUCCO FINISH ON STUCCO LATH ON 11/2" TAGEPS INULATION BOARD FASTENED WITH NAILS OF MIN 3.2 MM DIA. W/MIN II.I MM HEAD SAPCED @ MAX. 6" O.C VERTICALLY AND I6" O.C HORIZONTALLY OR 4" O.C VERTICALLY AND 24" HORIZONTALLY ON SHEATHING PAPER. @ NOT LESS THAN 8" ABOVE FINISHED GROUND

\(\sqrt{5} \) WOOD SIDING WALL CONSTRUCTION

FRAME WALL CONSTRUCTION FINISH WITH WINEL SIDING SIDING PAPER LAYERS TO OVERLAP EACH OTHER EXTERIOR TYPE SIDING ON 2X6 WOOD STUDS @ 16" O.C DOUBLE PLATE AT THE TOP SINGLE PLATE @ BOTT OM R24 BATT INSULATION IN CAMTIES.

6 FOUND ATTON WALLS

BITUMINOUS DAMPROOFING ON 1/4" PARGING ON 10" CONCRETE BLOCKS FDN. WALL TOP COURSE FILLED W/CONCRETE PROVIDE PARGING COVED OVER 24"X12" POURED CONCRETE FOOTING TO BEAR ON UNDISTURBED SOIL PROVIDE DRAINAGE LAVER:

- MIN 3/4" MINERAL FIBRE INSULATION W/ ADENSITY OF NOT LESSTHAN 3.6 LB/FT OR
- MIN. 4" OF FREEDRAIN AGE GRANULAR MATERIAL OR - A.B.M.E.C. APPROVED DRAIN AGE LAYER MATERIAL
- 7 REDUCTION IN FOUNDATION WALL THICKNESS

WHERE THE TOP OF FOUNDATION WALL IS REDUCED IN THICKNESS TO PERMIT THE INSTALLATION OF FLOOR JOIST, THE REDUCED SECTION SHALL BE NOT MORE 13 3/4" HIGHT AND NOT LESS THAN 3 1/2" THICK. WHERE THE TOP OF FOUNDATION WALL IS REDUCED IN THICKNESS TO PERMIT THEIN STALLATION OF A MASONRY EXTERIOR FACING. THE REDUCED SECTION SHALL BE NOT LESS 3 1/2" THICK AND TIED TO THE FACING MATERIAL WI METALTIES.

(8) INTERIOR STUD PARTITIONS (NO BEARING)

NO BEARING PATITIONS (A!" DRYWALL FINISH ON BOTH SIDES OF 2"X4" WOOD STUDS @16" O.C. 2 TOP PLATES & 1 BOTTOM PLATE PROVIDE SOUND ATTENUATION IN SULATION IN BATHROOM WALLS & WHERE INDICATED ON PLANS,

INTERIOR STUD PARTITIONS (BEARING) BEARING PATITIONS ID!" DRYWALL FINISH ON BOTH SIDES. OF 2"X6" WOOD STUDS @16" O.C. 2 TOP PLATES & 1 BOTTOM PLATE PROVIDE SOUND ATTENUATION IN SULATION IN BATHROOM WALLS & WHERE IN DICATED ON PLANS.

WALL INSULATION

MIN. R24 INSULATION BATTS TO COVER THE INTERIOR FACE OF THE EXTERIOR WALLS WITH CONTINUOUS AIR / VAPOUR BARIER

FOUNDATION INSULATION

R20 INSULATION BLANKET WITH AIR WAPOUR BARRIER FROM SUB-FLOOR TO BASEMENT SLAB. DAMPPROOF WIBLDG. PAPER BETWEEN THE FOUNDATION WALL AND IN SUL ATION UP TO CRADE LEVEL.

STUD WALL REINFORCEMENT

PROVIDE WOOD BLOCKING REINFORCEMENT TO STUD WALLS FOR FUTURE GRAB BARS IN STALATION IN MAIN BATHROOM 33"-36" A.F.F. BEHIND TOLET 33" AF.F ON THE WALL OPPOSITE THE ENTERANCE TO THE TUB AND SHOWER

2"X6" SILL PLATE FASTENED TO FOUNDATION WALL WITH MIN IA" DIA, AN CHOR BOLTS EMBEDDED MIN. 4" IN CONCRETE @ 7'-10" O.C MAX. PROMDE CAULKIN G FOR GASKET BETWEEN PLATE AND FOUNDATION WALL.

FLOOR FRAMING

5/8" T&G PLY WOOD NAILED AND QUED ON 2" X 8" I-JOIST WITH MIN. 11/2" END BEARING ON EACH SIDE WITH CROSSBRIDGING OR SOLID BLOCKING @ MAX. 61-11" O.C.

ENGINEERED FLOOR FRAMING

5/8" T&G PLY WOOD NALED AND QUED ON 2" X 10" JOIST WITH MIN. 11/2" END BEARING ON EACH SIDE WITH CROSSBRIDGING OR SOLID BLOCKING @ MAX. 64-11" O.C

BASEMENTSLAB

MIN. 3" 25 MPA CONC. SLAB ON 4" COARSE CRANULAR FILL WITH DAMP PROOFING BELOW SLAB.

STEEL BASEMENT COLUMN

MIN 3" DIA AND WALLTHIKNESS OF MIN. 3/16" WITH 4"X4"X1/4" THICK STEEL PLATE WELDED TOP AND BOTT OM AND SUPPORTED ON A 36"X36"X18" THK CONCRETE FOOTING

STEEL BEAM

W 150X22 SITTING ON STEEL COLUMN ON ONE END AND 3 1/2" END BEARING ON FOUNDATION WALL ON THE OTHER END WITH 1"X3" CONTINUS WOOD STRAPPING ON EACH SIDE OF THE BEAM

GRADE

SLOPE GRADE AWAY FROM BUILDING FACE & PROVIDE SEMI SOLID BLOCK COURSE AT OR BELOW GRADE LEVEL.

4" DIA. WEEPINGTILE W/6" CRUSHED STONE OVER AND ARROUND

CRAWL SPACE ACCESS HATCH

CRAWL SPACE CLEARANCE MIN. 24" CLEAR TO U/S OF STRUCTURE PROVIDE 1/64" POLY GROUND COVER MIN. II 13/16" OVERLEP, SEALED AT JOISTS & FUNDATIONS WALL & WEIGHTED DOWN W/MIN ACCESS OPENING OF 2" 7" X 1" 10"

ATTIC ACCESS

ATTIC ACCESSH ATCH 22"X28" WITH WEATHERSTRIPPING (MIN.3.4FT2) RSI 8.8 (R50) RIGID INSULATION BACKING

CEILING CONSTRUCTION

MIN 5/8" DRY WALL FINISH ON ALL CEILINGS. WITH CONTINUOS AIR VAPOUR BARIER WITH MIN. R40 INSULATION FOR ATTIC

DRYER VENT

CAPPED DRYER EXHAST VENTED TO EXTERIOR DUCT SHALL CONFORM TO OBC2012 DIV. B PART 6

WASHROOM EXHAUST

MECHANICAL EXHAST FAN, VENTED TO EXTERIOR, TO PROVIDE AT LEAST ONE AIR CHANGE PER HOUR PROVIDE DUCT SCREEN AS PER OBC2012 DIV. B 9.32.3.12

CABINETRY ABOVE RANGE

FRAMING FINISHES AND CABINETRY ABOVE ARANGE MUST HAVE MIN 2'-6" CLE ARANCE, UNLESS FRAMING, FINISHES AND CABINETRY ARE NON-COMBUSTABLE OR ARE PROTECTED AS PER 9,10,22,(2)(10)(1)

SMOKE ALARM O.B.C. 9.10.19

PROVIDE ON EPERFLOOR NEAR THE STAIRS CONNECTING THE FLOOR LEVEL. ALARAMTO BE CONNECTED TO AN ELECTRICAL CIRCUT AND INTERCONECTED TO ACTIVATE ALL ALARMS IF I SOUNDS, IT SHOULD BE INSTALED IN CONFORM ANCE WITH CANJULG-5553

CARBON MOMOXIDE ALARM O.B.C. 9.33.4.

PROVIDE CARBON MONOXIDE DETECTOR ADJACENT TO EACH SLEEPING

EXCAVATION AND BACKFILL

* EXCAVATION SHOULD BE UNDER TAKEN IN SUCH A MANNER SO AS TO PREVENT DAMAGE TO EXISTINF STRUCTURES ADN ADJACENT PROPERTY * THE TOPSOIL AND VEGETABLE MATTER IN UNEXCAVATED ARE AS UNDER A BUILDING SHALL BE REMOVED. THE BOTTOM OF EXCAVATIONS FOR FOUNDATIONS SHALL BE FREE OF ALL ORGANIC MATERIALS.

* IF TERMITES ARE KNOWN TO EXIST, ALL STUMPS, ROOTS AND WOOD DEBRIS SHALL BE REMOVED TO A MIN DEPTH OF 11 3/4" IN EXCAVATED AREAS UNDER A BUILDING AND THE CLEARANCE BETWEEN UNTREATED STRUCTURAL WOOD ELEMENTS AND THE GROUND SHALL BE NOT LESS THAN 173/4" * BACK FILL WITHIN 23 5/8" OF THE FOUNDATION WALLS SHALL BEFREE OF DELETERIOUS DEBRIES AND BOULDERS OVER 7,8" IN DIAMETER.

NOTCHING AND DRELLING OF TRUSSESS, JOISTS AND RAFTERS

* HOLES IN FLOORS, ROOFS AND CEILING MEMBES TO BE MAX.1/4 X ACTUAL DEPTH OF MEMBER AND NOT LESS THAN 2" FROM EDGES.

* NOTCHES IN FLOORS, ROOF, CEILING MEMBERS TO BE LOCATED ON TOP OF THE MEMBER WITHIN 1/2 THE ACTUAL DEPTH FROM THE EDGE OF BEARING AND NOT CREATER THAN IBJOIST DEPTH.

* WALL STUDS MAY BE NOT CHED OR DRILLED PROVIDE THAT NOT LESS THAN 2/3THE DEPTH OF THE STUD REMAINS, IF LOAD BEARING AND 11/2 IF NON

* ROOFTRUSS MEMBERS WHALL NOR BE NOT CHED, DRILLED, OR WEAKENED UNLESS ACCOMMODATED IN THE DESIGN.

CERAMIC TILES

WHEN CERAMIC TILES APPLIED TO A MORTAR BED WITH ADHISEVE, THE BED SHALL BE AMIN, OF IA" THICK & REINFORCED WITH GALVANIZED DIAMOND MESH LATH, APPLIED OVER POLYYETHYLENE ON SUBFLOORING ON JOISTS AT NO MORE THAN 16" O.C. WITH AT LEAST 2 ROWS CROSS BRIDGING.

2 STORY VOLUME SPACE

2 STORY HIGH (18'-0") EXTERIOR WALL STUDS TO BE 2-2"X6" CONTINUOS STUDS @12" O.C. TRIPLE UP AT EVERY THIRD DOUBLE STUDS CAN 3/8" EXTERIOR PLY WOOD SHEATHING PROVIDE SOLID WOOD BLOCKING BET WEEN WOOD STUDS @(4'-0") O.C. VERTICALY . FOR HORIZONTAL DISTANCE NOT EXCEEDING (9'-6") PROVIDE (2-2"X6") TOP PLATE AND A SINGLE BOTTOM PLATE .MIN. OF 3-2"X8" CONTINUS HEADER AT CROUND CEILING LEVEL TOE-NAILED AND QUED AT TOP, BOTTOM PLATES AND HEADERS FOR 9 HIGH GROUND/FIRST FLOOR CEILING ADD TRIPPLE HEADERS NAILED ONTOP OF FOUNDATION WALL SILL PLATE AND ADD 1-2"X6" CONTINUS BOTTOM PLATEN ALED ON TOP OF HEADERS.

FOOTING

24"X12" DEEP POURED CONCRETE 2200 PSI ON UNDISTERBED SOIL.MIN. 48" BELOW FINISHED CRADE

3-2"X4" BUILT UP POST WITH DAMPPROOFING MATERIAL WRAPPED AT END OF POST AN CHORED TO 24"X24"X12" CON C FOOTING.

(35) RANGE HOOD EXHUST

MECHANICAL EXHAST HOOD WITH MIN 100 CFM AND 6" DIM. RIGID STEEL DUCT OR EQUIVALENT TO OUTDOOR.

SHOWER AND TUB VALVES

I. ALS SHOWER VALVES SHALL CONFORM TO OBC DIV. B 7.6.5.2 2. WATERPROOF FINISH REQUIRED AT SHOWER AND TUB AREAS TO CONFIRM TO OBC DIVB 929.2

WALL REINFORCEMENT FOR FUTURE GRAB BARS

INSTALLATION IN WASHROOM SEE WASHROOM DETAIL SHEET

ATTACHED GARAGES MUST BE COMPLETELY SEALED TO PREVENT THE INFILTRATION OF CARBON MONOXIDE & GASOLINE FUMES INTO THE DWELLING.

- I. PROVIDE IA" DRYWALL W/MIN. 2 COATS OF JOINT COMPOUND AT ALL WALLS ADJACENT TODWELLING
- 2. CAULK BETWEEN GYPSUM BOARD AND OTHER SURFACES W/ ACOUSTIC SEALANT
- 3. CAULK ALL PENETRATIONS SUCH AS HOSE BIBS W/ FLEXIBLE CAULKING.
- 4 DOORS BETWEEN GARAGE & DWELLING SHALL BE TIGHT FITTING & WEATHER STRIPPED & PROVIDED W/ A SELF CLOSIN GIDEVICE, DOOR MUST NOT OPEN INTO AROOM INTENDED FOR SLEEPING.
- 5. GARAGE SLAB SHALL BE SLOPED TO DRAIN OUTDOORS. 6. UNIT MASONRY WALLS FORMING THE SEPARATION
- BETWEEN THE DWELLING ATT ACHED GARAGE SHALL BE PROVIDED W/2 COATS OF SEALER OR COVERED W/ PLASTER OR GYPSUM BOARD ON THE GARAGE SIDE

39 PRECAST STAIRS

PRECAST CONCRETE STEPS OR WOOD STEPS (PERMITTED TO A MAX. OF 3 RISERS) WHER NOT EXPOSED TO WHETHER MAX RISE 7-7/8" MIN. THREAD 9-1/2" CREATER THAN 3 RISERS WILL REQUIRE LANDING/QUARD / HANDRAIL AND FOUNDATION UNDER CONC. STEPS.

40 WOOD FRAME STAIRS

STAIRS DETAILS

= 7-7/8 MIN AVG. RUN = 8-1/4" MIN RUN = 5'-7/8" MIN TREAD = 9-1/4" RAILING MIZON XAM = 1"- 0 MIN HEADROOM = 6'-5" FINISHED RAILING ON PICKETS RAL@LANDING = 2'11' SPACED MAX. 4".

= 21-8"

RAL@STAIRS (41) INSULATION VALUES

> ABOVE GRADE WALLS BASEMENT WALLS

CONTINUOUS P-10 RIGID INSULATION + R-12 MIN BATT INSULATION

= 7-7/8"

CURVED STAIRS

INFERIOR QUARDS2'-11" MIN.

EXTERIOR GUARDS 3'-6" MIN.

CEILING WITH ATTIC SPACE CEILING WITHOUT ATTIC SPACE

MIN STAIRS WIDTH



7-250 SHEILDS CRT. MARKHAM ON L3R 9T5 888.236.99581 416.483.5393 INFO@YEJSTUDIO.COM WWW.YEJSTUDIO.COM

BASEMENT SECOND UNIT 3 AYLESBURY DR BRAMPTON, ON, L7A O₃

THE DIRECTOR DISAS REVIEW AN ITTAKEN TO NOT HELD BY LOST THE DESIGN. HAS THE QUALIFICATIONS AND MEETS THE REQUIREMENTS SET OUT INTIC ON ORDER AND LODGE TO SEE A DESIGNARY.

REQUIRED UNLESS DESIGN IS EXEMPT UNDED 12 to DEPARTOR YOU GO O.C.





CUENT REVIEW 2021.02.23 REVISION 2021.03.19 ISSUED FOR PERMIT 2021.03.22

CONSTRUCTION NOTES Drawn by AN-02 Project number 21 RE 500 21 Date 2021.02.22

42 1

WINDOWS

- WINDOWS TO BE SEALED TO THE AIR AND VAPOR BARRIER
- WINDOWS THAT SEPERATE HEATED SPACE FROM UNHEATED SPACE SHALL HAVE AN OVERALL COEFFICIENT OF HEAT TRANSFER OF 1.6 OR
- AN ENERGY RATING OF NOT LESS THAN 2 I FOR OPERABLE WINDOWS AND 3 I FOR FIXED WINDOWS
- SKYLIGHTS SHALL HAVE AN OVERALL COEFFICIENT OF HEAT TRANSFER OF 2.8W/(M2.K)



DOORS AND WINDOWS

- EVERY FLOOR LEVEL CONTAINING A BEDROOM AND NOT SERVED BY AN EXTERIOR DOOR SHALL CONTAIN AT LEAST ONE WINDOW HAVING AN UN OBSTRUCTED OPEN AREA OF 0.75 m². AND NO DIMENSION LESS THAN 380MM, WHICH IS OPEN ABLE FROM THE INSIDE WITHOUT TOOLS.
- EXTERIOR HOUSE DOORS AND WINDOWS WITHIN 2000MM FROM GRADE SHALL BE CONSTRUCTED TO RESIST FORCED ENTRY AND SHALL HAVE A DEADBOLT LOCK.
- -THE PRINCIPAL EXTRY DOOR SHALL HAVE EITHER ADOOR VIEWER, TRANSPARENT GLAZING OR A SIDELIGHT.



HVAC NOTES

- i. CONTRACT OR TO COORDINATE DUCTS INSTALLATION WITH PIPES, ELECTRICAL LIGHTING & BUILDING STRUCTURE.
- ALL MECHANICAL DUCT WORK SHALL BE CONCEALED IN ATTIC SPACE OR BULKHEADS UNLESS OTHERWISE NOTED.
- PROVIDE FLUE VENT, COMBUSTION AR AND TERMINATION KIT FOR FURNACE AND INSTALL AS PER MANUFACTURER WRITTEN IN STRUCTION.
- 4. PROVIDEBALAN ON GDAMPERS AT ALL AIR SUPPLY TAKE-OFFS:
- (A.) AT BRANCH DUCT OFF MAIN TRUNK DUCT.
- (B) IN DRY WALL AREA, PROVIDE DAMPER AT CRILLE WITH APPROVED LOCKING DEVICE TO ENGINEER'S APPROVAL.
- CUTTING FOR DUCTS SHALL BE DONE BY THIS CONTRACTOR OBT AN APPROVAL BEFORE CUTTING IN ANY WALL, STRUCTURAL BEAM, FLOOR AND ROOF.
- 6. COORDIN ATE LOCATION OF EACH S.A. CRILLE AND RETURN AIR GRILLE ON SITE BEFORE CUTTING AND ROUGHIN.
- 7. INSULATE ALL EXHAUST AIR DUCTS MIN. 150MM FROM WALLS OR ROOF.
- 8. CONNECT GAS PIPE TO EACH UNIT COMPLETE WITH SHUT OFF VALVE, ALL GAS PIPING SHALL BE CSA AND CGA APPROVED. INSTALL PIPES IN ACCORDANCE TO B 149,1 CODE.
- 9. INSULATE ALL DUCTS IN ŒILING SPACE, ATTIC SPACE AND GARACE.
- IO. TEST AND BALAN CE SYSTEM. SUBMIT BALANCING REPORT.
- III. COORDINATE ROUTING DUCTS AND LOCATION OF EACH GRILLE, FAN AND FURNACE WITH STRUCTURAL MEMBERS, PIPING CONDUITS AND LIGHTING, OFFSET AS REQUIRED AND MAINTAIN REQUIRED SERVICE ACCESS.
- 12. PROVIDE R.A. GRILLES AT HIGH AND LOW LEVELS, EACH GRILLE SHALL BE COMPLETED WITH BALAN ON GDAMFER.
- USE SPACE BETWEEN JOISTS AND WALL STUDS FOR RETURN WHERE APPLICABLE, PROMDE SHEET METAL JOISTS LINER (JL) AS REQUIRED.



MECHANICAL VENTILATION:

A MECHANICAL VENTILATION SYSTEM IS REQUIRED WITH A TOTAL CAPACITY AT LEAST EQUAL TO THE SUM OF: 10.0 L/S EACH FORB ASEMENT AND MASTER BEDROOM 5.0 L/S FOR EACH OTHER ROOM -A PRINCIPAL DWELLING EXHAUST FAN SHALL BE INSTALLED AND

APPRINCIPLO WELLING SATHOUT THAN SHALL SERIEST ALLE HAS CONTROLLED BY A CENTRALLY LOCATED SWITCH IDENTIFIED AS SUCH. -SUPPLEMENT AL EXHAUST SHALL BE INSTALLED SOTHAT THE TOTAL CAPACITY OF ALL KITCHEN, BATHROOM AND OTHER EXHAUSTS, LESS THE PRINCIPAL EXHAUST, IS NOT LESS THAN THE TOTAL REQUIRED CAPACITY

-A HEAT RECOVERY VENTILATOR MAY BE EMPLOYED IN LIEU OF EXHAUST TO PROVIDE VENTILATION, AN HRVISREQUIRED IF ANY SOLID FUEL BURNING APPLIANCES ARE INSTALLED, SUPPLY AR INTAKES SHALL BE LOCATED SO AS TO AVOID CONTAMINATION FROM EXHAUST OUTLETS.



NATURAL VENTILATION

-EVERY ROOF SPACE ABOVE AN INSULATED CEILING SHALL BE VENTIL ATED WITH UNOBSTRUCTED OPENINGS EQUAL TO NOT LESS THAN 1/300 OF THE IN SULATED ŒILING AREA

-INSULATED ROOF SPACES NOT INCORPORATING AN ATTIC SHALL BE VENTILATED WITH UNDESTRUCTED OPENINGS EQUAL TO NOT LESS THAN 1/50 OFTHEIN SULATED GEILING AREA -ROOF VENTS SHALL BE UNIFORMLY DISTRIBUTED WITH MIN. 25% AT

TOP OF THE SPACE AND 25% AT BOTTOM OF THE SPACE DESIGNED TO PREVENT THE ENTRY OF RAIN, SNOW, OR IN SECTS. -UNHEATED CRAWL SPACES SHALL BE PROVIDED WITH Q. IM



BASEMENT EGRESS WINDOW


	BTRUCTED IGSIZES
WIDTH	HEIGHT
18"	30"
19"	28.8"
20"	27.36"
21"	26.04"
22"	24.84"
23"	23.76"
24"	22.8"
25"	21.84"
26"	2)"
27"	20.16"




MINIMUN ROOM AREAS

	ONE BE	DROOM APPARTEMENT
	13.5M²	145.3ft ³
LIMN G AREA	moM²	118.4ft ² в імпелятисськиго вушинськісня
DINING AREA	7.0M?	75.3ft²
DIMINGALLA	3.25M	35. OFt ³ в синисама и соция в мустини масе
	9.8M³	105.5ft ²
I BEDROOM	8.8M ²	94.7ft
	4.2M²	45.2ft ² и не възхоживания чусник экс
	7.0M²	75.3ft²
OTHER BEDROOMS	6.0M	54.6ft Faruith Cortisponded
	4.2M	45.2ft ² із не волосы явы і часывано чусняя чыс

T	WO BED	ROOM APPARTEMENT
LIWN GAREA	13.5M²	145.3ft ³
LIUNGAREA	13.5M°	145.3ft ² в гипы алгагский инференциального
DIN IN GAREA	7.0M³	75.3ft ⁷
DINING PREA	3.25M°	35. CFt ² в иннесерсительно чустия тако

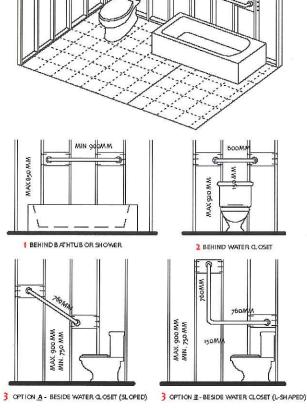

STUD WALL REINFORCEMENT

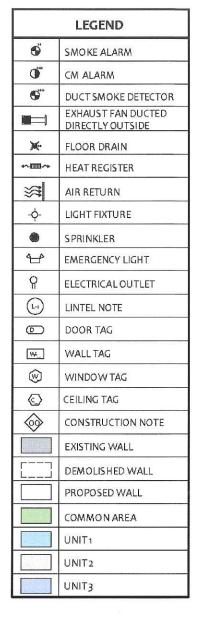



7-250 SHEILDS CRT.

MARKHAM ON L3R 9T5
888.236.9958 I 416.483.5393
INFO@YEJSTUDIO.COM
WWW.YEJSTUDIO.COM

BASEMENT SECOND UNIT 3 AYLESBURY DR BRAMPTON, ON, L7A oV3

THE CHIPPIONALD HAN DEVENY ARE LEARN 16 A GOAL SHIPLY LOCATE DESIGN, AND HAS THE QUALIFICATIONS AND MEETS THE REQUIREMENTS SET OUT IN THE ONLY ALLE, NORTH ALLE OUT IN SHIPLY DEVELOPED.


QUALIFICATION INFORMATION
REQUIRED UNLESS DESIGN IS EXEMPT UNDER 15-2-1 OF DIVISION 1CF OF O B.C
NAME
AVE DORAH

OUT OF O B.C

BC(II)

A-2-2



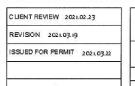

 CONSTRUCTION NOTES

 Drawn by
 AR

 Project number
 21 RE 500 21

 Date
 2021.02.22

 Scale
 Asindicated

