

Public Notice

Committee of Adjustment

APPLICATION # A-2022-0359 WARD 8

DEFERRED APPLICATION FOR MINOR VARIANCE

WHEREAS an **amended** application for minor variance has been made by **NILAM SHAH AND BHAVIN SHAH** under Section 45 of the <u>Planning Act</u>, (R.S.O. 1990 c.P.13) for relief from **By-law 270-2004**;

AND WHEREAS the property involved in this application is described as Lot 60, Plan 43M-3030 municipally known as **42 LYLE WAY**, Brampton;

AND WHEREAS the applicants are requesting the following variance(s):

- 1. To permit an accessory structure (gazebo) having a building height of 3.327m (10.92 ft.) whereas the bylaw permits a maximum building height of 3.0m (9.84 ft.) for an accessory structure;
- 2. To permit an accessory structure (gazebo) having a gross floor area of 23.78 sq. m (256 sq. ft.) whereas the by-law permits a maximum gross floor area of 15 sq. m (161.46 sq. ft.) for an individual accessory structure;
- 3. To permit an uncovered pool (hot tub) with an rear yard setback of 0.78m (2.56 ft.) whereas the by-law requires a minimum setback of 1.2m (3.94 ft.) to the nearest lot lines;
- 4. To permit a driveway width of 15.72m (51.57 ft.) whereas the by-law permits a maximum driveway width of 9.14m (30 ft.);
- 5. To permit a recreational facility (sports court) with an interior side yard setback of 0.762m (2.50 ft.) whereas the by-law requires a minimum setback of 1.2m (3.94 ft.) to the nearest lot lines

The land which is subject of this application is the subject of an application under the Planning Act for:

Plan of Subdivision:	NO	File Number:
Application for Consent:	NO	File Number:

The Committee of Adjustment has appointed TUESDAY, February 14, 2022 at 9:00 A.M. by electronic meeting broadcast from the Council Chambers, 4th Floor, City Hall, 2 Wellington Street West, Brampton, for the purpose of hearing all parties interested in supporting or opposing these applications.

This notice is sent to you because you are either the applicant, a representative/agent of the applicant, a person having an interest in the property or an owner of a neighbouring property. OWNERS ARE REQUESTED TO ENSURE THAT THEIR TENANTS ARE NOTIFIED OF THIS APPLICATION. THIS NOTICE IS TO BE POSTED BY THE OWNER OF ANY LAND THAT CONTAINS SEVEN OR MORE RESIDENTIAL UNITS IN A LOCATION THAT IS VISIBLE TO ALL OF THE RESIDENTS. If you are not the applicant and you do not participate in the hearing, the Committee may proceed in your absence, and you will not be entitled to any further notice in the proceedings. WRITTEN SUBMISSIONS MAY BE SENT TO THE SECRETARY-TREASURER AT THE ADDRESS OR FAX NUMBER LISTED BELOW.

IF YOU WISH TO BE NOTIFIED OF THE DECISION OF THE COMMITTEE OF ADJUSTMENT IN RESPECT OF THIS APPLICATION, YOU MUST SUBMIT A WRITTEN REQUEST TO THE COMMITTEE OF ADJUSTMENT. This will also entitle you to be advised of an Ontario Land Tribunal hearing. Even if you are the successful party, you should request a copy of the decision since the Committee of Adjustment decision may be appealed to the Ontario Land Tribunal by the applicant or another member of the public.

RULES OF PROCEDURE OF THIS COMMITTEE REQUIRE REPRESENTATION OF THE APPLICATION AT THE HEARING, OTHERWISE THE APPLICATION SHALL BE DEFERRED.

PLEASE SEE ATTACHED PARTICIPATION PROCEDURES REQUIRED DURING THE COVID-19 PANDEMIC


DATED at Brampton Ontario, this 3rd Day of February, 2023

Comments may be sent to and more information about this matter may be obtained between 8:30 a.m. to 4:30 p.m. Monday - Friday from:

Jeanie Myers, Secretary-Treasurer
Committee of Adjustment, City Clerk's Office,

Committee of Adjustment, City Clerk's Office, Brampton City Hall, 2 Wellington Street West, Brampton, Ontario L6Y 4R2

Phone: (905)874-2117 Fax: (905)874-2119 jeanie.myers@brampton.ca

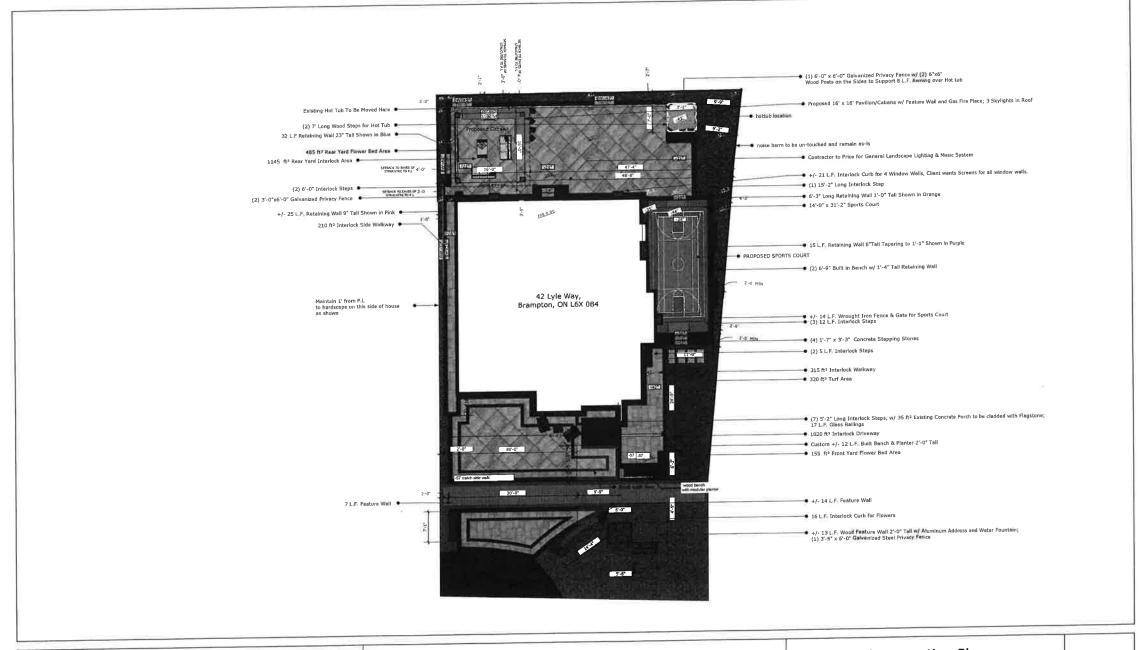

Square Design Group Contractors must verify all dimensions and conditions on the project and must report any discrepancies to the designer before proceeding with construction. Construction, Site Information and Planting Plans must only be used for budgetary pricing. The material and information is for general information and is solely to help the contractor price the concept design.

Landscape Project

42 Lyle Way, Brampton, ON L6X 0B4

Construction Plan

Scale:1:200 Date:2022/06/17



Under the authority of the Emergency *Management and Civil Protection Act* and the *Municipal Act, 2001*, City Council approved Committee Meetings to be held electronically and/or as a hybrid meeting (both inperson and electronically).

Electronic/Hybrid Hearing Procedures How to get involved in the Hybrid Hearing

As the pandemic has waned, Brampton City Hall is currently lifting in-person attendance restrictions due to the COVID pandemic. In-person attendance at Committee of Adjustment Hearings is now available at this time, along with a virtual participation option. Brampton City Council and its Committees will continue to meet electronically and in-person. For the **February 14, 2023** hearing, the Committee of Adjustment will conduct its meeting with concurrent electronic and in-person attendance.

How to Participate in the Hearing:

All written comments (by mail or email) must be received by the Secretary-Treasurer no later than **4:30 pm**, **Thursday**, **February 9**, **2023**.

- Advance registration for applicants, agents and other interested persons is required by one or two options;
 - 1. Participate remotely in the electronic hearing using a computer, smartphone or tablet by emailing the Secretary–Treasurer at cityclerksoffice@brampton.ca or jeanie.myers@brampton.ca by 4:30 pm Thursday, February 9, 2023.
 - 2. To participate in-person, please email the Secretary–Treasurer at cityclerksoffice@brampton.ca or ieanie.myers@brampton.ca by 4:30 pm Thursday, February 9, 2023.
- Persons without access to a computer, smartphone or tablet can participate in a meeting via telephone or inperson. You can register by calling 905-874-2117 and leave a message with your name, phone number and
 the application you wish to speak to by **Thursday**, **February 9**, **2023**. City staff will contact you and provide
 you with further details.

You will be contacted by the City Clerk's Office before the hearing date to confirm your attendance. Confirmation of in-person attendance will be subject to any in-person capacity limits that may be in place for Council Chambers at City Hall and prevailing public health orders and guidance.

 All Hearings will be livestreamed on the City of Brampton YouTube account at: https://www.brampton.ca/EN/City-Hall/meetings-agendas/Pages/Welcome.aspx or http://video.isilive.ca/brampton/live.html.

If holding an electronic/hybrid rather than an oral hearing is likely to cause a party significant prejudice a written request may be made to have the Committee consider holding an oral hearing on an application at some future date. The request must include your name, address, contact information, and the reasons for prejudice and must be received no later than 4:30 pm the Friday prior to the hearing to cityclerksoffice@brampton.ca or jeanie.myers@brampton.ca. If a party does not submit a request and does not participate in the hearing, the Committee may proceed without a party's participation and the party will not be entitled to any further notice regarding the proceeding.

NOTE Personal information as defined in the *Municipal Freedom of Information and Protection of Privacy Act* (*MFIPPA*), collected and recorded or submitted in writing or electronically as related to this planning application is collected under the authority of the *Planning Act*, and will be used by members of the Committee and City of Brampton staff in their review of this matter. Please be advised that your submissions will be part of the public record and will be made available to the public, including posting on the City's website, www.brampton.ca. By providing your information, you acknowledge that all personal information such as the telephone numbers, email addresses and signatures of individuals will be redacted by the Secretary-Treasurer on the on-line posting only. Questions regarding the collection, use and disclosure of personal information may be directed to the Secretary-Treasurer at 905-874-2117.

AMENDMENT LETTER

February 1, 2023

To: Committee of Adjustment

RE: APPLICATION FOR MINOR VARIANCE

A-2022-0359 – 42 LYLE WAY

Please amend application A-2022-0359 to reflect the following:

- 1. To permit an accessory structure (gazebo) having a building height of 3.327m (10.92 ft.) whereas the by-law permits a maximum building height of 3.0m (9.84 ft.) for an accessory structure;
- 2. To permit an accessory structure (gazebo) having a gross floor area of 23.78 sq. m (256 sq. ft.) whereas the by-law permits a maximum gross floor area of 15 sq. m (161.46 sq. ft.) for an individual accessory structure;
- 3. To permit an uncovered pool (hot tub) with an rear yard setback of 0.78m whereas the by-law requires a minimum setback of 1.2m (3.94 ft.) to the nearest lot lines;
- 4. To permit a driveway width of 15.72m whereas the by-law permits a maximum driveway width of 9.14m (30 ft.);
- 5. To permit a recreational facility (sports court) with an interior side yard setback of 0.762m whereas the by-law requires a minimum setback of 1.2m (3.94 ft.) to the nearest lot lines

Applicant/Authorized Agent




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Landscape Project

42 Lyle Way, Brampton, ON L6X 0B4

Construction Plan

Scale:1:200 Date:2022/06/17

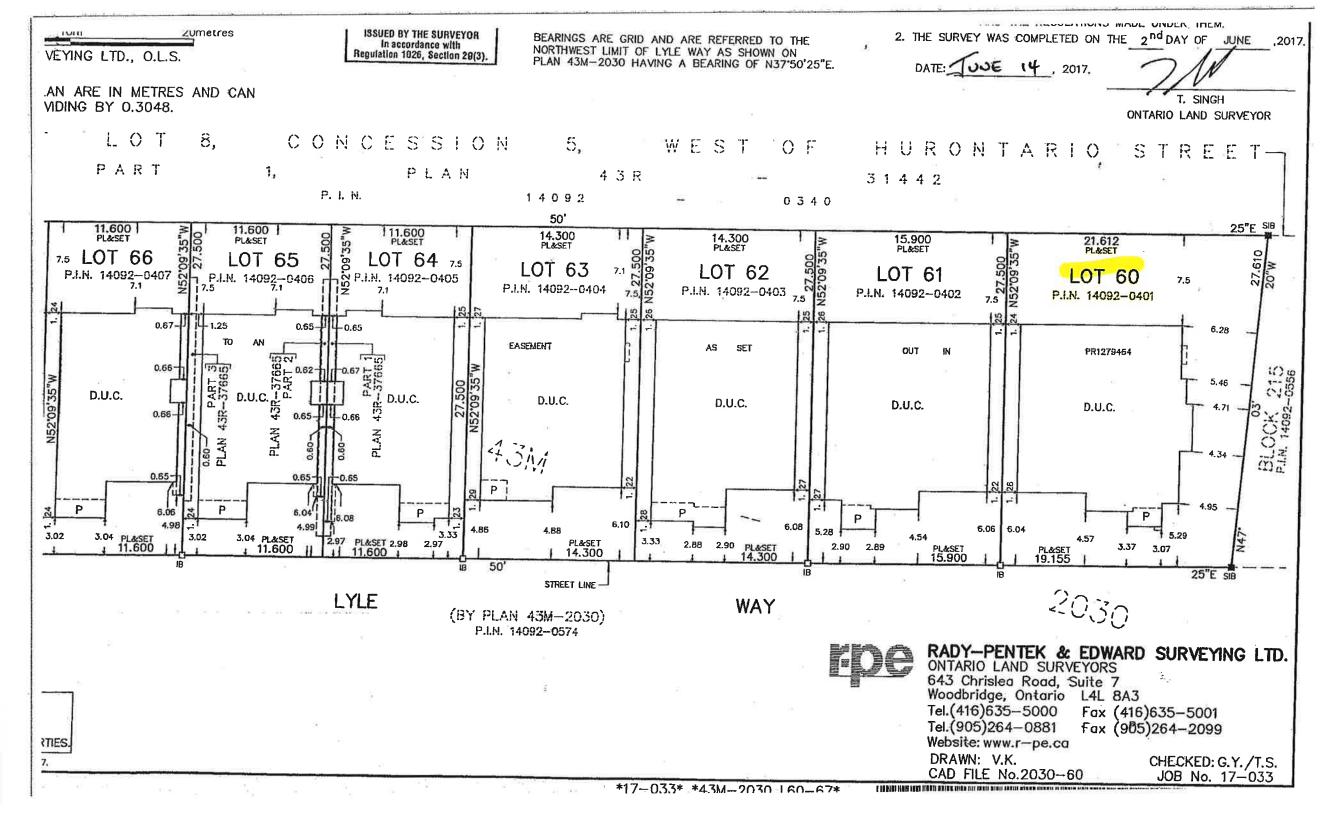

PROPOSED PAVILION 42 LYLE WY BRAMPTON, ON L6X 0B4

A00-COVER PAGE
A1-SITE PLAN
A2-FLOOR PLAN
A3-FOUNDATION PLAN
A4-ROOF PLAN
A5-ELEVATIONS
A6-ELEVATIONS
A7-ELEVATIONS
A8-ELEVATIONS

A9-DETAIL 1



Workmanship and materials shall be in accordance with part 9 of the Ontario Building Code and local regulations

- 2. See Architectural drawings for dimensions, elevations and finishes
- 3. All structural components shall be interconnected to resist code mandated live, dead and environmental loads

4. DESIGN LIVE LOADS ARE:

ROOF: SS = 1.3 KPA, Sr = 0.4 KPA FLOORS : 40 PSF WIND 1/50: 0.44 KPA BASIC EARTHQUAKE: Sa(0,2) = 0.19

5. Contractor is responsible for safe execution of work, as per osha and other applicable safety codes. a temporary shoring plan and construction sequence duly signed by an Ontario licensed professional engineer to be submitted for approval before start of any relevant work. Approved shop drawings along with approve permit drawings shall be always available at site for reference

- 1. Footings shall be placed on undisturbed soil capable of supporting
- 2 Footings excavations shall be inspected by soils engineer before concrete is placed
- 3. Footings exposed to freezing shall be placed at least 4'-0" below finished grade
- Protect footings exposed to frost action during construction by 4'-0" minimum of soil or its equivalent
- 5. The line of slope between adjacent footings or excavations or along stepped footings shall not exceed a rise of 7 in a run of 10 maximum step shall be 2'-0".
- 6. Where a foundation wall retains soil on each side, place backfill on both sides simultaneously...
- 7. Foundation walls retaining earth between slabs at different levels shall be shored until the slab at higher level is in place and has reached its required strength.

Concrete specification

- The ultimate 28 days compressive strength of concrete shall be 20.0 MPA unless noted otherwise
- 2. The ultimate 28 days compressive strength of concrete exposed to freezing and thawing (exterior slabs, garage floor slab, side walks, curbs, retaining walls, etc.) shall be 32 MPA with minimum air entrainment content of 5%-8% and maximum water/cement ratio by mass of 0.45
- Do not use calcium chloride or other salts in concrete 4. Reinforcing steel shall be deformed bars to CSA G30.18 with a minimum
- yield strength of 400 MPA. 5. Welded wire mesh shall conform to CSA G30.5, welded steel wire fabric for concrete reinforcement.
- 6. Detail reinforcing in accordance with reinforcing steel manual of standard practice prepared by RSIO
- 7. Only ready mix concrete is permitted on this job, the concrete supplier shall be responsible for concrete mix design.
- 8. Supply and install concrete, reinforcing steel and formwork including placing, finishing and curring as shown on the drawings in accordance with CSA A23 and CSA G 30
- 9 Non-shrink, non-metallic grout shall be used by Sika Canada inc. or an approved equal.


- 1. Structural steel shall be as follows W, S, HP, WWF SHAPES CAN/CSA G40.21-350W HSS CAN/CSA G40,21-350W, CLASS C CAN/CSA G40.21-300W
- 2. Obtain field measurements as required
- Provide holes where required for attachment of other work to steel, place holes so as not to cause any appreciable reduction in strength of the member.
- Fabricate, supply and erect structural steel work in accordance with the following standards:

Design, fabrication and erection CSA-S16.1 Welding CSA-W47 SSPC-SP3-63

ASTM-325-80A Bolts 3/4" Ø U.N.O CGSB-1_40-M89 Paint (1 shop coat + field touch up)

- 5. Design connections for the reactions produced by the loading conditions
- 6. No splices in new beams and columns shall be allowed unless approved by the engineer,
- 7. All steel lintels bearing on masonry to have minimum 6" bearing

- 1. All wood construction to be in accordance with CSA standard CAN3-086-01
- 2. All lumber to be grade stamped and shall be dry spruce #1 or #2 conforming to CSA-086-01 u/n otherwise.
- Lumber for stud walls shall be spruce stud grade uin otherwise.
- 4. Trus joists, LSL and PSL beams shall be as manufactured by Trus Joist Canada IId, or an approved equal, the supplier shall be responsible for design of all connections and shall submit shop drawings bearing a stamp of P. Eng. responsible for the design.
- 5. All connections, unless noted otherwise, to be in accordance with O.B.C. 2012
- 6. All load bearing stud walls shall have one row of solid blocking at mid height unless noted otherwise.
- 7. Bridging for trus joists shall be as recommended by the manufacturer, however, spacing of bridging shall not exceed 12 feet
- 8. Metal hangers shall be made from light gauge galvanized metal and shall have allowable load capacity (as per manufacturer's data) greater than reactions produced by loading conditions. Use Simpson Strong-tie or equal.
- 9. Protect lumber in direct contact with concrete or mortar with 10 mil. polyethylene sheet
- 10. Provide adequate temporary bracing for all stud walls during
- 11. Double up studs at each end of an opening unless noted otherwise.
- 12. Plywood as per CSA O 86.1

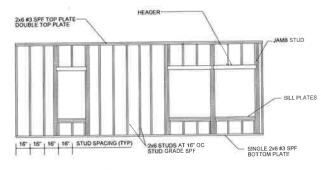

TYP. WALL


TOP AND BOTTOM PLATE TO STUD WITH (3) 131x3" P.D. NAILS WALL TO FLOOR #8x3" SREW 16" O.C. AND (2) 131x3" P.D.

WALL TO WALL AND CEILING #8x3" SCREW 16" O.C.

PLUMBING PIPE FROST PROTECTION DETAIL

WATER PIPES FROST PROTECTION DETAIL

DETAIL TO COMPLY WITH 7.3.5.4(1) O.B.C.

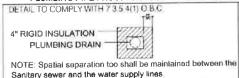

Plumbing to have winterizing shut off Installed in the basemen All drains to be winterized to prevent freezing during winter months. Plumbing to be blow out and filled with Anti-Freeze as

4" RIGID INSULATION WATER PIPES NOTE: Spatial separation too shall be maintained between the Sanitary sewer and the water supply lines.

Plumbing to have winterizing shut off installed in the basement. All drains to be winterized to prevent freezing during winter months. Plumbing to be blow out and filled with Anti-Freeze as

STEEL LINTEL SCHEDULE

L1	Up to 4'-6" Opening	L 3 1/2" x 3 1/2" x 5/16"
L2	Up to 5'-6" Opening	L 4" x 3 1/2" x 5/16"
L3	Up to 6'-6" Opening	L 5" x 3 1/2" x 5/16"
L4	Up to 7'-6" Opening	L 5" x 3 1/2" x 3/8"
L5	Up to 9'-10" Opening	L 6" x 4" x 3/8"
L6	Up to 11'-0" Opening	L 7" x 4" x 3/8"
L7	Up to 19'-0" Opening	(I-BEAM) W8x15 BEARING ON BRICK

WOOD LINTEL SCHEDULE

3 - 2" x 6" 3 - 2" x 8"
3 - 2" x 8"
0 L X 0
3 - 2" x 10"
3 - 2" x 12"

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REV:	DESCRIPTION:	BX;	DATE:

GENERAL NOTES

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NOTES

CONTRACTORS MUST CHECK AND VERIFY ALL DIMENSIONS AND CONDITIONS ON THE PROJECT AND MUST REPORT ANY DISCREPANCIES TO THE DESIGNER BEFORE PROCEEDING WITH CONSTRUCTION.

THIS DRAWING MUST NOT BE USED FOR CONSTRUCTION PURPOSES UNTIL SEALED AND SIGNED BY THE DESIGNER.

PROJECT NAME:

DRAWN BY:

42 Lyle Wy Brampton, ON L6X 0B4

DRAWING TITLE

CONSTRUCTION NOTES

CHECKED BY:


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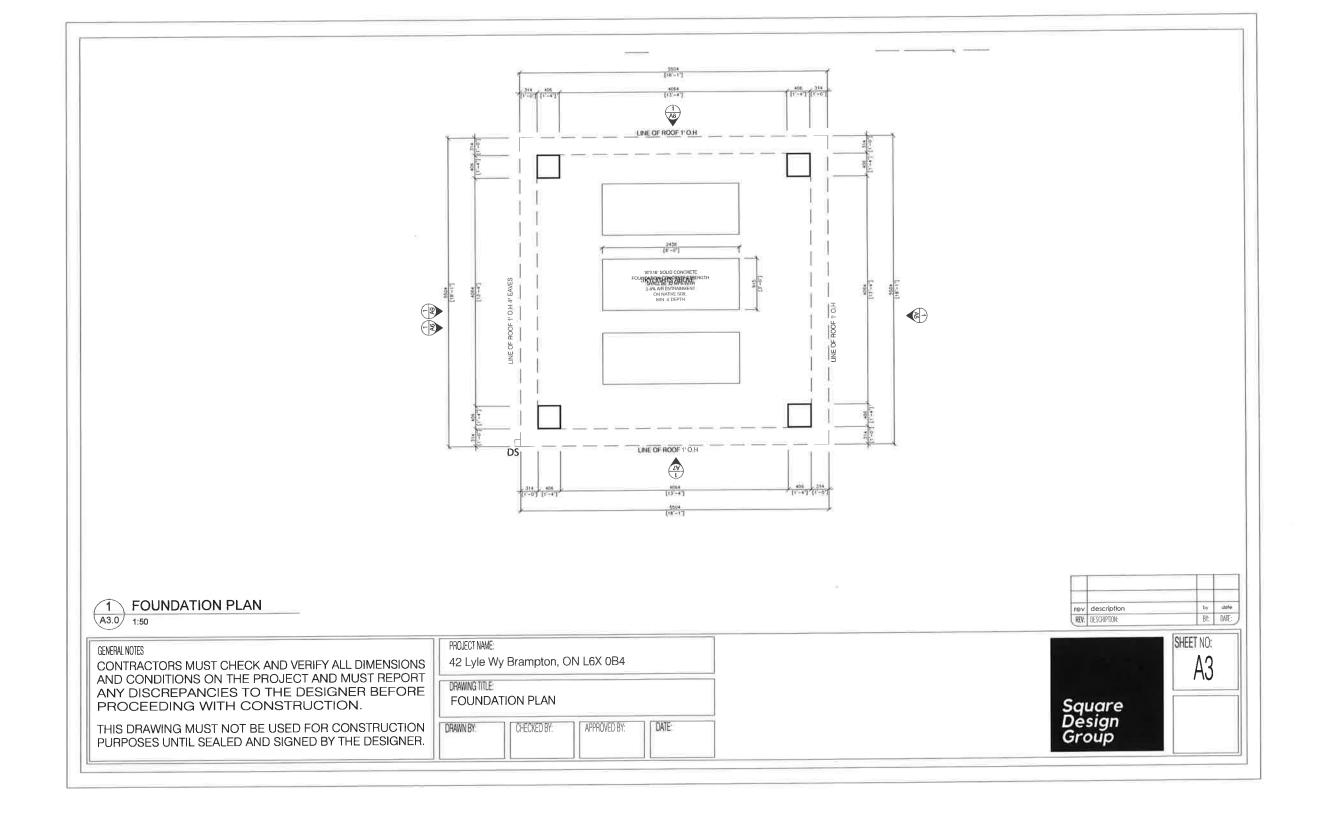





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GENERAL NOTES





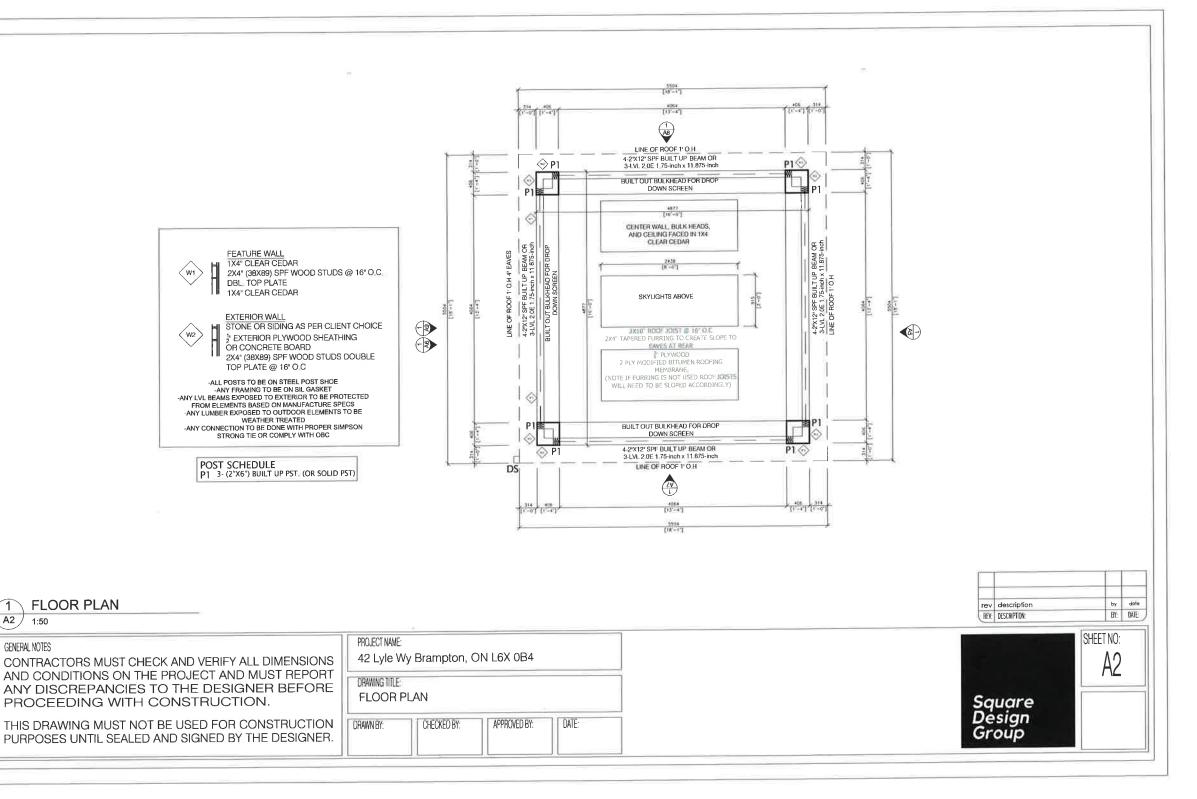

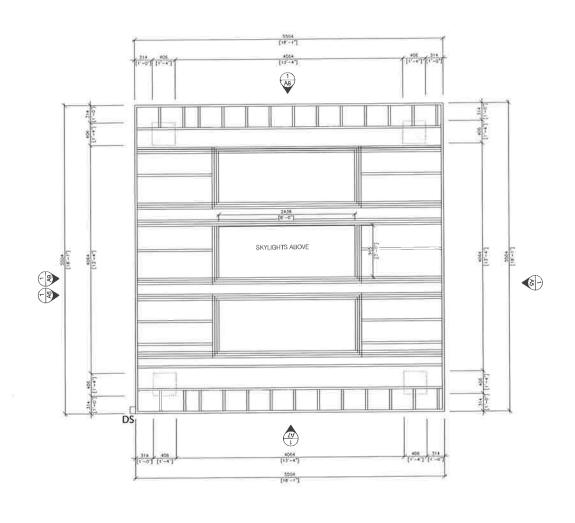ROOF FRAMING PLAN

GENERAL NOTES

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42 Lyle Wy Brampton, ON L6X 0B4

DRAWING TITLE:

ROOF FRAMING PLAN

DRAWN BY:


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APPROVED BY:

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Square Design Group





ROOF DRAINAGE PLAN
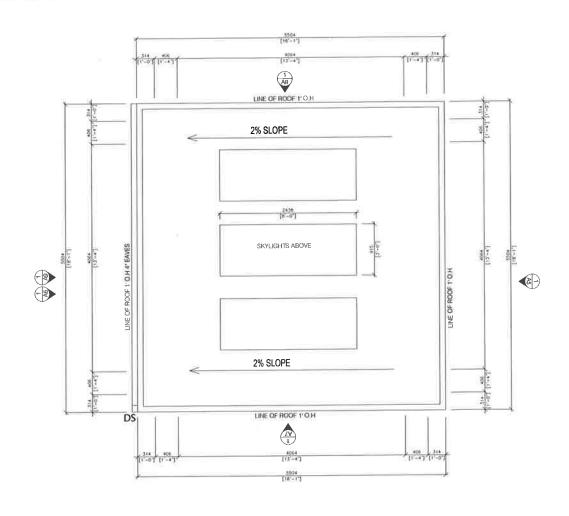
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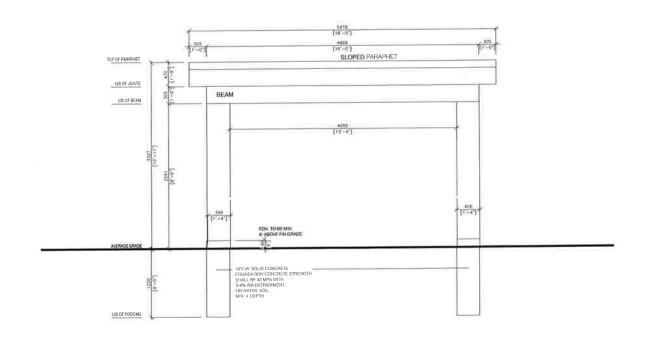
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SHEET NO: Square Design Group





ELEVATION A

GENERAL NOTES

PROJECT NAME:	
42 Lyle Wy Brampton, ON L6X 0B4	
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THIS DRAWING MUST NOT BE USED FOR CONSTRUCTION PURPOSES UNTIL SEALED AND SIGNED BY THE DESIGNER.

PROCEEDING WITH CONSTRUCTION.


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ANY DISCREPANCIES TO THE DESIGNER BEFORE

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ELEVATION B

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GENERAL NOTES

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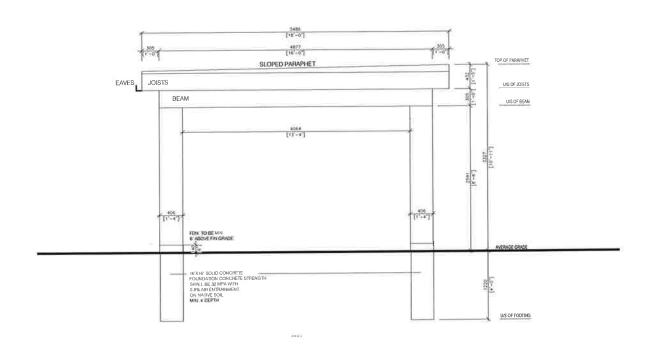
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ELEVATION C

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PROJECT NAME:

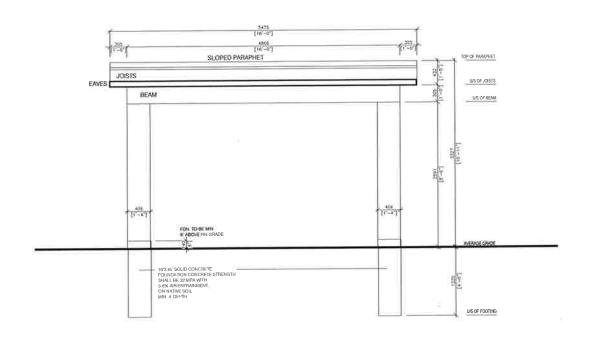42 Lyle Wy Brampton, ON L6X 0B4

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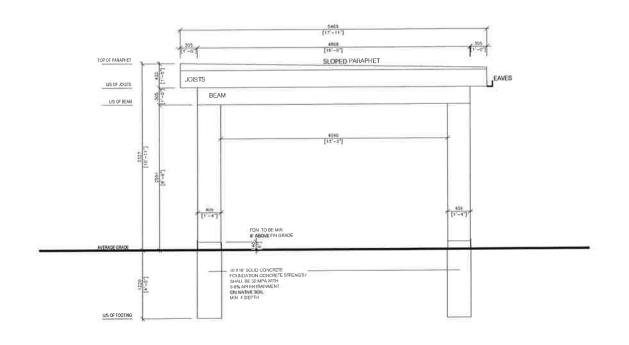
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Square Design Group



1 ELEVATION D

A8.0 1:50

GENERAL NOTES

PROJECT NAME:

42 Lyle Wy Brampton, ON L6X 0B4

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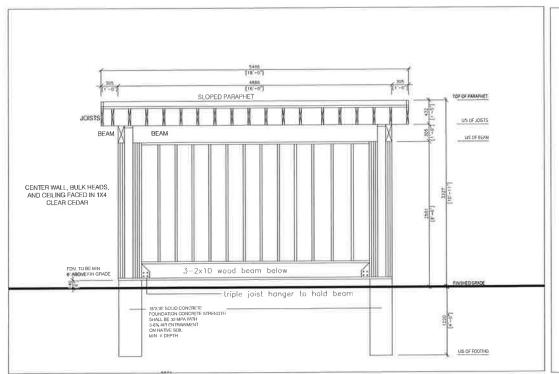
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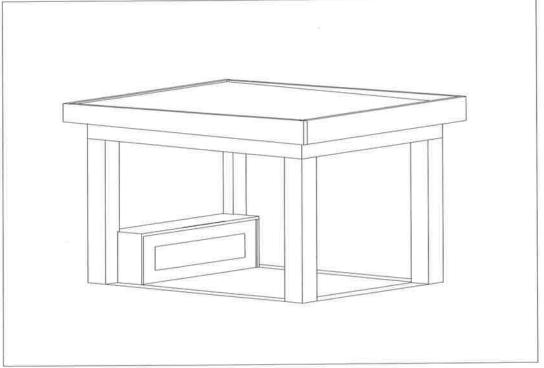
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SHEET NO:

Square Design Group SHEET NO: A8.0





DETAIL 1

A9.0 1:50

DETAIL 2 A9.0 1:50

by date rev description REV: DESCRIPTION:

GENERAL NOTES

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PROJECT NAME: 42 Lyle Wy Brampton, ON L6X 0B4 DRAWING TITLE: **ELEVATION** DATE: DRAWN BY:

APPROVED BY: CHECKED BY:

Flower City



For Office Use Only (to be inserted by the Secretary-Treasurer after application is deemed complete)

FILE NUMBER: A = 2022-0359

		APPLICATION					
		Minor Variance or Special Permission					
		(Please read Instructions)					
NOTE:	II in popula	ed that this application be filed with the Secretary-Treasurer of the Committee of Adjustment and be					
HOIL	accompan	hied by the applicable fee.					
		rsigned hereby applies to the Committee of Adjustment for the City of Brampton under section 45 of ing Act, 1990, for relief as described in this application from By-Law 270-2004.					
1.	Name of C	DWNer(s) Bhavin Shah / NILAM SHAH					
		42 Lyle Way, Brampton, ON L6X 0B4					
	Phone # Email	bhavinshahls@gmal.com					
	Cilian						
2.	Name of						
	Address	1204 Hill Street, Innisfil, ON, L9S 1X8					
	Phone #	Fax #					
	Email	squandesigngroup@outlook.com					
	IN NOTICE OF THE PARTY.						
3.		nd extent of relief applied for (variances requested):					
	The man	it height for an accessory structure of 3.327 m is proposed. kimum permitted gross floor area proposed is 22.67m2					
		it a hot tub setback of 0.66m to the rear and 0.58m to the side yard.					
		nit a flot tob seeback of 0.56th to the fear and 0.56th to the side yard.					
	To perm	nit a diveway width of 10.20m (maximum permitted is 5.14m) nit a 0.0m permeable landscaping strip abutting the property line (minimum o f0.6m					
	is required)						
		nit a recreational facility (hot tub) to be located within a required interior side yard					
	resulting	g in a setback of 0.782m (minimum required is 1.2m)]				
4.		not possible to comply with the provisions of the by-law?	٦.				
	Can not	comply with the allowable gross floor area of one accessory structure of 15m2.					
	Can not	comply with the maximum permitted height of 3meters. comply with the setbacks to the hot tub.	i.				
	500-00-000 P		1				
		ot comply with the allowable driveway width of 9.14m.	20 : : :				
	Can no	ot comply with the permeable landscaping strip abutting the property line (minimum of	J.om is required				
		and the state of t					
5.	Legal De: Lot Numb	scription of the subject land:					
	Plan Nun	nber/Concession Number 43M-2030	_ :				
		Address 42 Lyle Wy, Brampton, ON L6X 084	=				
6.	Dimensio	on of subject land (<u>in metric units</u>)					
٠,	Frontage		_				
	Depth	27.810m					
	Area	628 AM2					
7.		the subject land is by:					
	Provincia	Il Highway Seasonal Road Seasonal Road Other Public Road					
		Ight-of-Way Water					

	land: (specify in storeys, width, it	<u>n metric units</u> gr length, helght, etc	round floor area, gross floor area, number of c., where possible)
	• •	_	no subject land: List all structures (dwelling, shed, gazebo, etc.)
	Existing 2 storey d	lweliina	
	- Touse Touping	-	
	PROPOSED BUILDIN Proposed cabana Cabana Height; 3.3	NGS/STRUCTURES on footprint; 24.6m2	n the subject land:
	Cabana neight.		
9.			ructures on or proposed for the subject lands:
	(specify distance	ce from side, rea	r and front lot lines in <u>metric units</u>)
	EXISTING	2.07	
	Front yard setback Rear yard setback	3.07m 7.5m	
	Side yard setback Side yard setback	1.24m 4.34m	
	PROPOSED		
	Front yard setback Rear yard setback	N/A 1,260m2	
	Side yard setback	1.103m2 N/A	
	Side yard setback	NA	
	Data of Appulation	of subject land:	22-MARCH-2017
10.	Date of Acquisition	•	
10.	Date of Acquisition	•	
	Existing uses of su		Residential
11.		bject property:	Residential Residential
11. 12.	Existing uses of su	bject property: subject property:	(c <u> </u>
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11. 12. 13.	Existing uses of surproposed uses of surproposed uses of surproposed uses of about the construction. Length of time the	abject property: Subject property: Dutting properties: On of all buildings & s	Residential Residential N/A tructures on subject land: subject property have been continued:

*

17.	subdivision or cons	•	application unde	r the Planning Act, 10	or approval of a plan of
	Yes	No 🔳			
	If answer is yes, pro	ovide details: File	e#	_ State	us
18.	Has a pre-consultat	ion application been	filed?		
	Yes	No 🔳			
19.	Has the subject pro	perty ever been the s	subject of an applic	cation for minor varia	ance?
	Yes	No 🔳	Uпknown]	
	If answer is yes, pro	ovide details:			
	File # File #	Decision Decision		Relief	
	File#	Decision		Relief	ĭ
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	0.5		Signat	ure of Applicant(s) or	Authorized Agent
DAT	ED AT THE BE	AMPTON OF - Novembe	ON	<u>J.</u>	_
THIS	6_4 th DAY OI	Novembe	£, 20 22		
F THIS A	APPLICATION IS SIG	NED BY AN AGENT,	SOLICITOR OR A	NY PERSON OTHER	THAN THE OWNER OF
HE APP	PLICANT IS A COR	PORATION, THE AF RPORATION'S SEAL	PPLICATION SHAP	LL BE SIGNED BY	THE APPLICATION. IF AN OFFICER OF THE
CORPOR					2000 0001
i(I		SHAH	, OF THE	OF OF	BRAMPTON.
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ALL OF T BELIEVIN DATH.	THE ABOVE STATEN NG IT TO BE TRUE A	MENTS ARE TRUE AI ND KNOWING THAT	ND I MAKE THIS S IT IS OF THE SAM	SOLEMN DECLARAT IE FORCE AND EFFE	ION CONSCIENTIOUSLY ECT AS IF MADE UNDER
DECLAR	ED BEFORE ME AT 1	THE /	a Commission	Opor ot-	
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NIHE	Region	of Of	Expires April	8, 2024.	311
Lee	LIHIS LA	DAY OF			(,
W	0 √ . , 20 <u>2</u>	2	Sign	ature of Applicant or A	Authorized Agent
	1	M. Cers.			
	A Commissioner e	tc.			
($\overline{}$	FOR	OFFICE USE ONLY	<i>(</i>	
	Present Official Pl	an Designation:		:	
	Present Zoning By	y-law Classification:		:	
	This application h	as been reviewed with said review are o	respect to the varia utlined on the attach	nces required and the ned checklist.	results of the
	Zor	ning Officer		Dat	e
		k	Carban	4 2022	_

DATE RECEIVED _

Revised 2020/01/07



<u>Legend</u>

0 Existing Grades
0 Proposed Grades


Square Design Group Contractors must verify all dimensions and conditions on the project and must report any discrepancies to the designer before proceeding with construction. Construction, Site Information and Planting Plans must only be used for budgetary pricing. The material and information is for general information and is solely to help the contractor price the concept design.

Landscape Project

42 Lyle Way, Brampton, ON L6X 0B4

Construction Plan

Scale:1:200 Date:2022/06/17

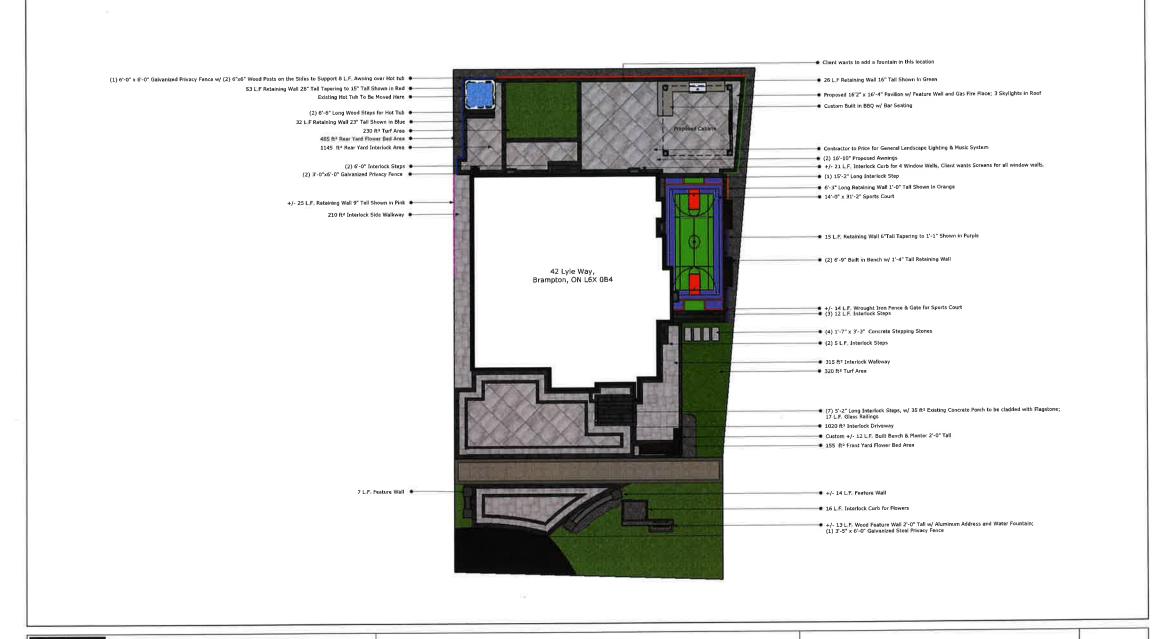


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Landscape Project

42 Lyle Way, Brampton, ON L6X 0B4

Site Information Plan

Scale:1:200 Date:2022/06/17

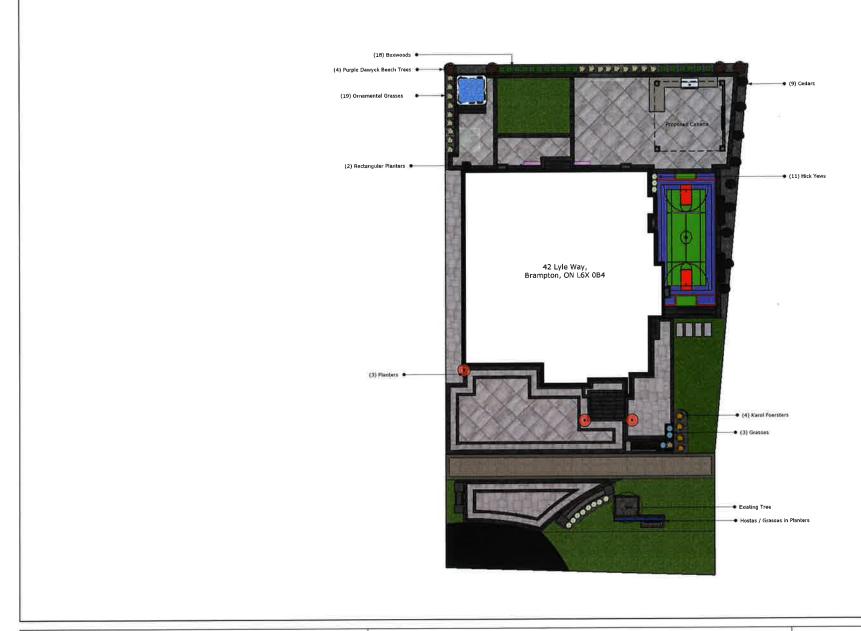

Square Design Group Contractors must verify all dimensions and conditions on the project and must report any discrepancies to the designer before proceeding with construction. Construction, Site Information and Planting Plans must only be used for budgetary pricing. The material and information is for general information and is solely to help the contractor price the concept design.

Landscape Project

42 Lyle Way, Brampton, ON L6X 0B4

Planting Plan

Scale:1:200 Date:2022/06/17

ISSUED BY THE SURVEYOR
In accordance with zumetres 2. THE SURVEY WAS COMPLETED ON THE 2 nd DAY OF JUNE BEARINGS ARE GRID AND ARE REFERRED TO THE NORTHWEST LIMIT OF LYLE WAY AS SHOWN ON VEYING LTD., O.L.S. Regulation 1026, Section 28(3). PLAN 43M-2030 HAVING A BEARING OF N37'50'25"E. DATE: JUNE 14 , 2017. .AN ARE IN METRES AND CAN VIDING BY 0.3048. ONTARIO LAND SURVEYOR CONCESSION WEST HURONTARIO STREET-PART PLAN 4 3 R 3 1 4 4 2 P. I. N. 14092 0 3 4 0 50' 25"E SIB 11.600 PL&SET 11.600 111.600 | PL&SET | PL 111.600 PL&SET 14.300 PL&SET 15,900 PL&SET 14.300 PL&SET 21.612 PL&SET PL&SET 7.5 LOT 66 LOT 65 LOT 63 LOT 62 LOT 61 P.J.N. 14092-0407 P.I.N. 14092-0406 LOT 60 7.5 P.I.N. 14092-0403 7.5 P.I.N. 14092--0404 P.I.N. 14092-0402 P.I.N. 14092-0401 0.67 6.28 EASEMENT AS SET OUT PR1279464 D.U.C. D.U.C. D.U.C. D.U.C. D.U.C. D.U.C. 0.66 0.65 0.65 6.10 6.06 6.04 5.28 3.04 PL&SET 1 11.600 3.04 PL&SET 11.600 3,02 2.97 PL&SET 2.98 2.97 PL&SET 14.300 3.33 2.90 2.89 PL&SET PL&SET 15.900 PL&SET 19.155 50' STREET LINE -LYLE WAY (BY PLAN 43M-2030) P.I.N. 14092-0574 RADY-PENTEK & EDWARD SURVEYING LTD. ONTARIO LAND SURVEYORS 643 Chrislea Road, Suite 7 Woodbridge, Ontario L4L 8A3 Tel.(416)635-5000 Fax (416)635-5001 Tel. (905)264-0881 Fax (905)264-2099 Website: www.r-pe.ca RTIES. DRAWN: V.K. CHECKED: G.Y./T.S. CAD FILE No.2030-60 JOB No. 17-033 *17-033* *43M-2030 L60-67*

PROPOSED PAVILION 42 LYLE WY BRAMPTON, ON L6X 0B4

A00-COVER PAGE
A1-SITE PLAN
A2-FLOOR PLAN
A3-FOUNDATION PLAN
A4-ROOF PLAN
A5-ELEVATIONS
A6-ELEVATIONS
A7-ELEVATIONS
A8-ELEVATIONS
A9-DETAIL 1



STRUCTURAL NOTES:

1. Workmenship and materials shall be in accordance with part 9

of the Ontario Building Code and local regulations

2. See Architectural drawings for dimensions, elevations and finishes. 3. All structural components shall be interconnected to resist code mandated live,

dead and environmental loads 4. DESIGN LIVE LOADS ARE

ROOF : SS = 1.3 KPA, Sr = 0.4 KPA FLOORS: 40 PSF

WIND 1/50: 0.44 KPA BASIC EARTHQUAKE : Sa(0,2) = 0,19

5. Contractor is responsible for safe execution of work, as per osha and other applicable safety codes: a temporary shoring plan and construction sequence duly signed by an Ontario licensed professional engineer to be submitted for approval before start of any relevant work. Approved shop drawings along with approve permit drawings shall be always available at site for reference

- 1/ Footings shall be placed on undisturbed soil capable of supporting
- 2. Footings excavations shall be inspected by soils engineer before concrete is placed.
- 3. Footings exposed to freezing shall be placed at least 4'-0" below finished grade.
- 4. Protect footings exposed to frost action during construction by 4'-0" minimum of soil or its equivalent.
- 5. The line of slope between adjacent footings or excavations or along stepped footings shall not exceed a rise of 7 in a run of 10. maximum step shall be 2'-0"
- 6. Where a foundation wall retains soil on each side, place backfill on both sides simultaneously...
- 7. Foundation walls retaining earth between slabs at different levels shall be shored until the slab at higher level is in place and has reached its required strength.

Concrete specification

- The ultimate 28 days compressive strength of concrete shall be 20.0 MPA unless noted otherwise.
- 2. The ultimate 28 days compressive strength of concrete exposed to freezing and thawing (exterior slabs, garage floor slab, side walks, curbs, retaining walls, etc.) shall be 32 MPA with minimum air entrainment content of 5%-8% and maximum water/cement ratio by mass of 0.45 3. Do not use calcium chloride or other salts in concrete
- 4. Reinforcing steel shall be deformed bars to CSA G30.18 with a minimum yield strength of 400 MPA.
- 5. Welded wire mesh shall conform to CSA G30.5, welded steel wire tabric for concrete reinforcement.
- 6. Detail reinforcing in accordance with reinforcing steel manual of standard practice prepared by RSIO.

including placing, finishing and curring as shown on the drawings

- 7. Only ready mix concrete is permitted on this job, the concrete supplier shall be responsible for concrete mix design 8. Supply and install concrete, reinforcing steel and formwork
- in accordance with CSA A23 and CSA G 30. 9. Non-shrink, non-metallic grout shall be used by Sika Canada inc. or an approved equal.

Structural Steel

1. Structural steel shall be as follows W, S, HP, WWF SHAPES CAN/CSA G40,21-350W, CAN/CSA G40 21-350W CLASS C CAN/CSA G40,21-300W

Obtain field measurements as required.

Provide holes where required for attachment of other work to steel, place holes so as not to cause any appreciable reduction in strength of the member

Fabricate, supply and erect structural steel work in accordance with the following standards:


Design, fabrication and erection CSA-S16_1 CSA-W47 Welding Cleaning SSPC-SP3-63 Bolts 3/4" Ø U.N.O ASTM-325-80A

Paint (1 shop coat + field touch up) CGSB-1,40-M89 5 Design connections for the reactions produced by the loading

conditions. 6. No splices in new beams and columns shall be allowed unless approved by the engineer

7. All steel lintels bearing on masonry to have minimum 6" bearing

- 1. All wood construction to be in accordance with CSA standard CAN3-086-01.
- 2. All lumber to be grade stamped and shall be dry spruce #1 or #2 conforming to CSA-086-01 u/n otherwise
- Lumber for stud walls shall be spruce stud grade u/n otherwise.
- 4. Trus joists, LSL and PSL beams shall be as manufactured by Trus Joist Canada (Id. or an approved equal, the supplier shall be responsible for design of all connections and shall submit shop drawings bearing a stamp of P. Eng. responsible for the design.
- 5. All connections, unless noted otherwise, to be in accordance with O.B.C. 2012
- 6. All load bearing stud walls shall have one row of solid blocking at mid height unless noted otherwise,
- 7. Bridging for trus joists shall be as recommended by the manufacturer, however, spacing of bridging shall not exceed 12 feet
- 8. Metal hangers shall be made from light gauge galvanized metal and shall have allowable load capacity (as per manufacturer's data) greater than reactions produced by loading conditions. Use Simpson Strong-tie or equal.
- 9. Protect lumber in direct contact with concrete or mortar with 10 mit polvethylene sheet
- 10. Provide adequate temporary bracing for all stud walls during construction
- 11. Double up studs at each end of an opening unless noted otherwise.
- 12 Plywood as per CSA O 86 1

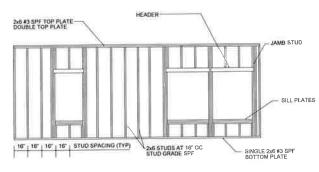

TYP: WALL

TOP AND BOTTOM PLATE TO STUD WITH (3), 131x3* P.D. NAILS WALL TO FLOOR #8x3* SREW 16* O.C. AND (2), 131x3* P.D.

WALL TO WALL AND CEILING #8x3" SCREW 16" Q.C.


PLUMBING PIPE FROST PROTECTION DETAIL

DETAIL TO COMPLY WITH 7 3 5 4(1) O.B.C.

4" RIGID INSULATION PLUMBING DRAIN

NOTE: Spatial separation too shall be maintained between the Sanitary sewer and the water supply lines

Plumbing to have winterizing shut off installed in the basement All drains to be winterized to prevent freezing during winter months, Plumbing to be blow out and filled with Anti-Freeze as WATER PIPES FROST PROTECTION DETAIL

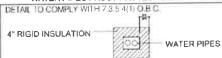

NOTE: Spatial separation loo shall be maintained between the Sanitary sewer and the water supply lines.

Plumbing to have winterizing shut off installed in the basement All drains to be winterlzed to prevent freezing during winter months. Plumbing to be blow out and filled with Anti-Freeze as ren.

STEEL LINTEL SCHEDULE

L1	Up to 4'-6" Opening	L 3 1/2" x 3 1/2" x 5/16"
L2	Up to 5'-6" Opening	L 4" x 3 1/2" x 5/16"
L3	Up to 6'-6" Opening	L 5" x 3 1/2" x 5/16"
L4	Up to 7'-6" Opening	L 5" x 3 1/2" x 3/8"
L5	Up to 9'-10" Opening	L 6" x 4" x 3/8"
L6	Up to 11'-0" Opening	L 7" x 4" x 3/8"
L7	Up to 19'-0" Opening	(I-BEAM) W8x15 BEARING ON BRIC

WOOD LINTEL SCHEDULE

WB1	Up to 3'-6" Opening	3 - 2" x 6"
WB2	Up to 5'-6" Opening	3 - 2" x 8"
WB3	Up to 6'-6" Opening	3 - 2" x 10"
WB4	Up to 7'-6" Opening	3 - 2" x 12"

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GENERAL NOTES

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NOTES

CONTRACTORS MUST CHECK AND VERIFY ALL DIMENSIONS AND CONDITIONS ON THE PROJECT AND MUST REPORT ANY DISCREPANCIES TO THE DESIGNER BEFORE PROCEEDING WITH CONSTRUCTION.

THIS DRAWING MUST NOT BE USED FOR CONSTRUCTION PURPOSES UNTIL SEALED AND SIGNED BY THE DESIGNER.

PROJECT NAME:

42 Lyle Wy Brampton, ON L6X 0B4

DRAWING TITLE:

CONSTRUCTION NOTES

DRAWN BY:


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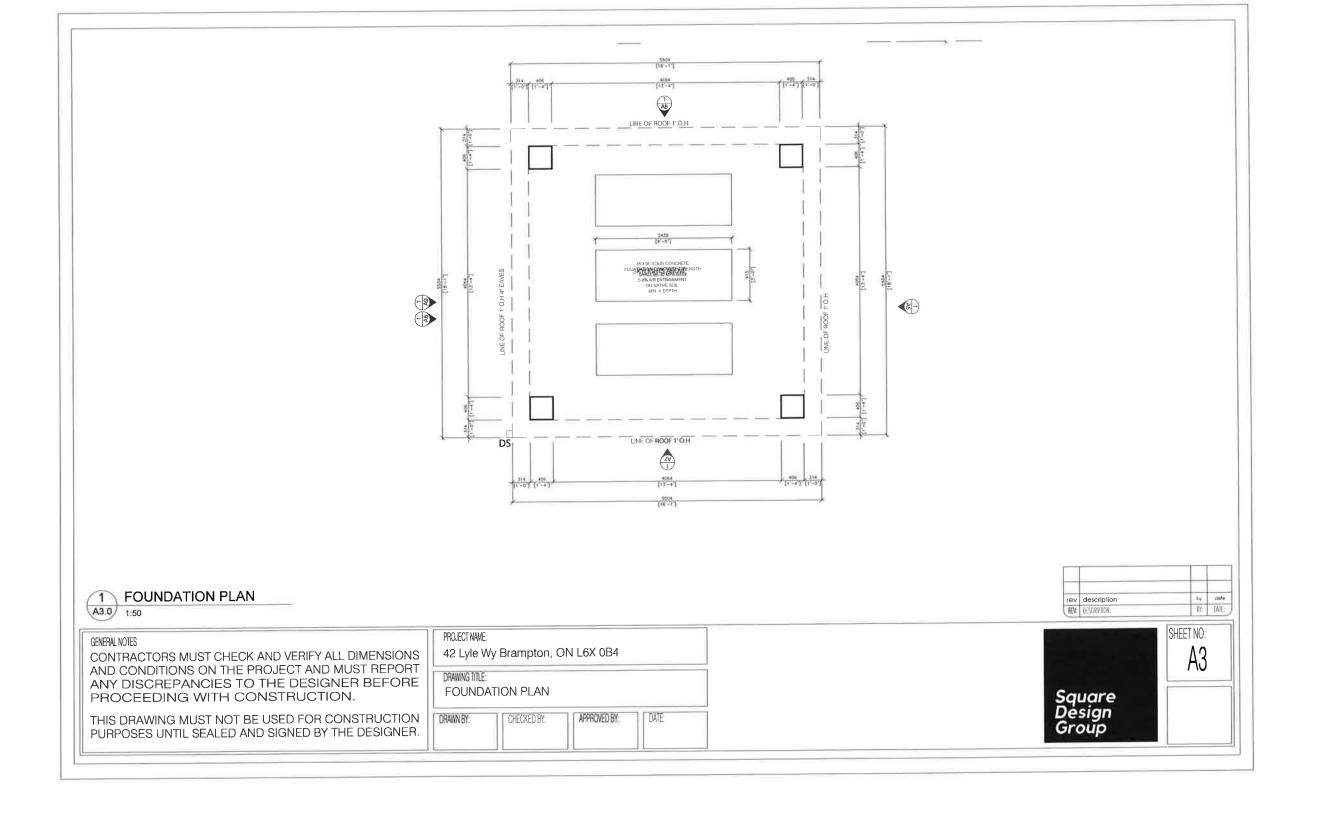
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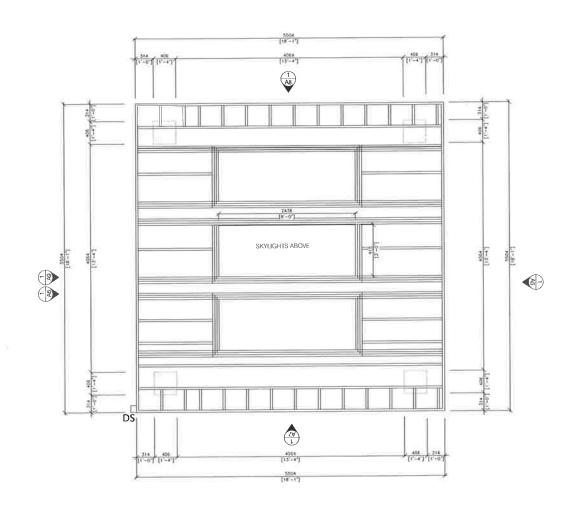
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ROOF FRAMING PLAN

A4.0 1:50

GENERAL NOTES

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ROOF FRAMING PLAN

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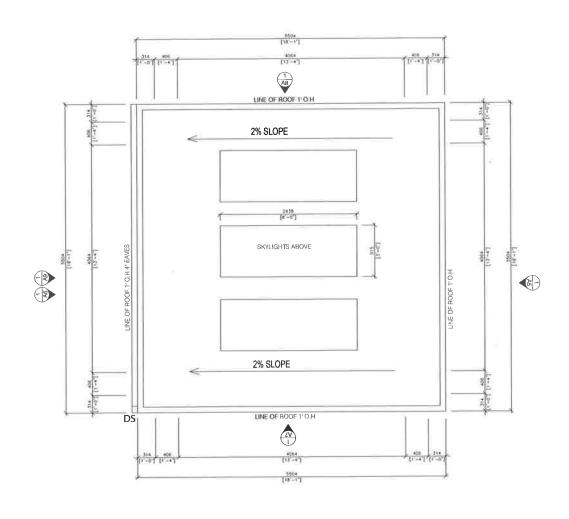
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Square Design Group

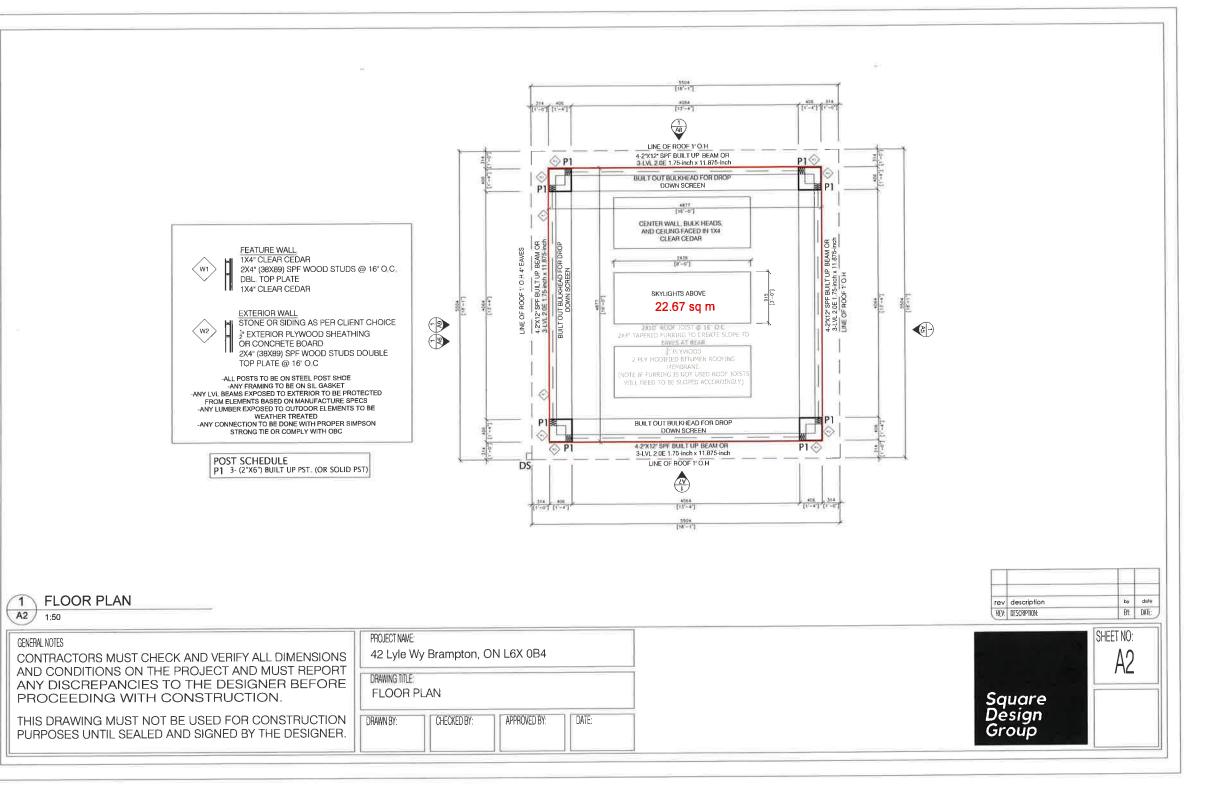

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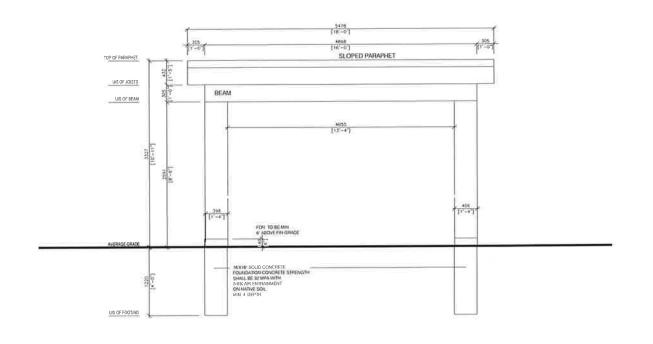
GENERAL NOTES

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ELEVATION A

GENERAL NOTES

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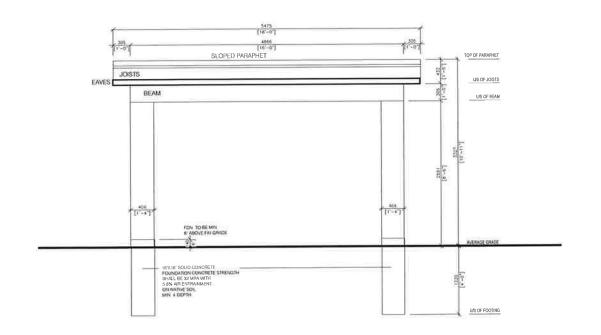
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SHEET NO: A5.0

Square Design Group





ELEVATION B

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GENERAL NOTES

CONTRACTORS MUST CHECK AND VERIFY ALL DIMENSIONS AND CONDITIONS ON THE PROJECT AND MUST REPORT ANY DISCREPANCIES TO THE DESIGNER BEFORE PROCEEDING WITH CONSTRUCTION.

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42 Lyle Wy Brampton, ON L6X 0B4

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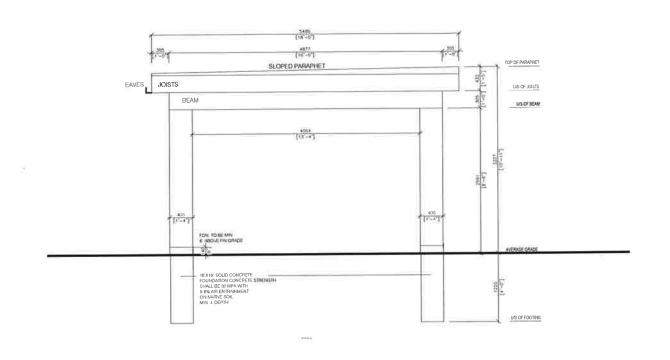
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Square Design Group





ELEVATION C

GENERAL NOTES	
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CONTRACTORS MUST CHECK AND VERIFY ALL DIMENSIONS AND CONDITIONS ON THE PROJECT AND MUST REPORT ANY DISCREPANCIES TO THE DESIGNER BEFORE PROCEEDING WITH CONSTRUCTION.

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42 Lyle Wy Brampton, ON L6X 0B4

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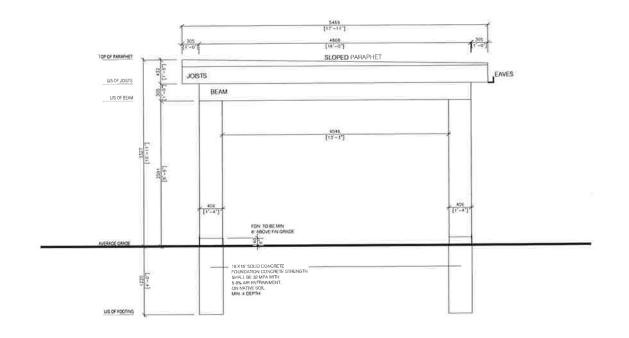
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Square Design Group





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GENERAL NOTES

CONTRACTORS MUST CHECK AND VERIFY ALL DIMENSIONS AND CONDITIONS ON THE PROJECT AND MUST REPORT ANY DISCREPANCIES TO THE DESIGNER BEFORE PROCEEDING WITH CONSTRUCTION.


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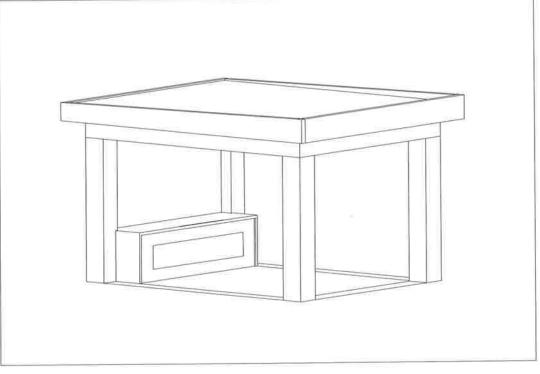
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Square Design Group





1 DETAIL 1

1 DETAIL 2 A9.0 1:50 rey description by date
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GENERAL NOTES
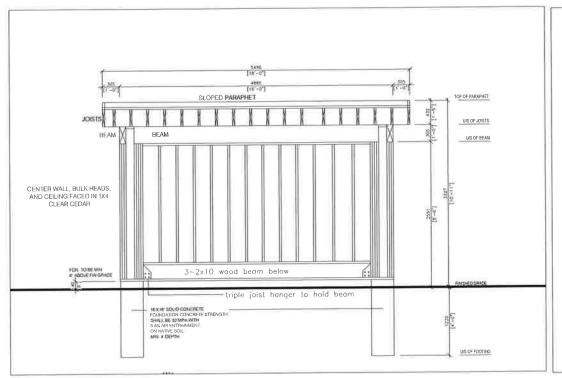
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