## **BASEMENT FLOOR PLAN CHANGES:**

- -LIVING, DINING AND BEDROOM AREA REVISED.
- -ADDED TWO(D01a) DOORS IN HALLWAY.
- -BEDROOM WILL BE USED AS A COMMON ROOM (BF-03).
- -THERE WILL BE A COMMON LAUNDRY AND

FURNACE(BF-04).

## **FIRST FLOOR PLAN CHANGES:**

- -KITCHEN POSITION CHANGED.
- -STACKED LAUNDRY ADDED.

### **SECOND FLOOR PLAN CHANGES:**

- -WE HAVE INTERCHANGED THE POSITION OF
- LIVING/DINING WITH BEDROOM (SF-06 & SF-07)
- AREAS ARE ALSO REVISED ACCORDINGLY.
- -W.I.C ADDED TO BEDROOM (SF-07).
- -COMMON ROOM CHANGED TO BEDROOM (SF-10) + window added at the 2nd floor
- -ADDED CLOSET IN THE HALLWAY (SF-09)
- -BEDROOM (SF-03) AREA CHANGED AND W.I.C AND
- WASHROOM POSITION IS INTERCHANGED.
- -PROPOSED SPACE FOR STACKED LAUNDRY

BETWEEN BEDROOM AND LIVING SPACE.

ATTIC FLOOR PLAN TO REMAIN AS IS.



## LIST OF ARCHITECTURAL DRAWINGS

A00	COVER SHEET + LIST OF DRAWINGS + KEY PLAN
A01	GENERAL NOTES.
A02	O.B.C MATRIX.
A03	PROPOSED BASEMENT PLAN
A04	PROPOSED FIRST FLOOR PLAN
A05	PROPOSED SECOND FLOOR PLAN
A06	PROPOSED ATTIC FLOOR PLAN
A07	PROPOSED BASEMENT REFLECTED CEILING PLAN
A08	PROPOSED FIRST FLOOR REFLECTED CEILING PLAN
A09	PROPOSED SECOND FLOOR REFLECTED CEILING PLAN
A10	PROPOSED ATTIC FLOOR REFLECTED CEILING PLAN
A11	PROPOSED BASEMENT FIRE AND LIFE SAFETY PLAN
A12	PROPOSED FIRST FLOOR FIRE AND LIFE SAFETY PLAN
A13	PROPOSED SECOND FLOOR FIRE AND LIFE SAFETY PLAN
A14	PROPOSED ATTIC FLOOR FIRE AND LIFE SAFETY PLAN
A15	PROPOSED REAR ELEVATION
A16	SECTION A1

### SCOPE OF WORK

PROPOSED CHANGE OF USE AND INTERIOR
ALTERATIONS OF EXISTING RESIDENTIAL BUILDING TO
MULTI-APARTMENT (5 NOS.) BUILDING AT,
249 MAIN STREET N, BRAMPTON, ON CANADA.





PROPOSED CHANGE OF USE AND INTERIOR ALTERATIONS OF EXISTING RESIDENTIAL BUILDING TO MULTI-APARTMENT (5 NOS.) BUILDING AT 249 MAIN STREET N, BRAMPTON, ON, CANADA

ALL WORK SHALL CONFORM TO THE ONTARIO BUILDING CODE O.REG.332/12 AS AMENDED



technoarch

Unit 214 - 2550 Matheson Blvd East Mississauga, Ontario, Canada L4W 4Z1 Email: hbhons@technoarch.ca Tel: +1-905-792-0038 Cell: +1-416-729-9454 www.technoarch.ca

## NOTE:

CONTRACTOR TO CAREFULLY READ THESE NOTES AND FOLLOW DURING CONSTRUCTION. CHANGES/SUBSTITUTION WILL NOT BE ACCEPTABLE WITHOUT ARCHITECTS APPROVAL. ENSURE COMPLIANCE WITH ALL THE NOTES.

DO NOT SCALE DRAWING. CONCLUSIONS DERIVED BY SCALING OF DRAWINGS WILL NOT BE ACCEPTED. PLEASE VERIFY INFORMATION WITH THE ARCHITECT OF RECORD.

## **GENERAL NOTES:**

- 01. CONTRACTOR SHALL CHECK AND VERIFY ALL DIMENSIONS AND CONDITIONS ON SITE AND REPORT ANY DISCREPANCIES TO THE ARCHITECT PRIOR TO PROCEEDING WITH OFFICE LAYOUT AND DESIGN WORK.
- 02. ALL FLOORS TO BE LEVEL THROUGHOUT AND HAVE SMOOTH FINISH
- 03. CONTRACTOR TO CO-ORDINATE WITH MECH. AND ELECT. CONTRACTORS FOR LOCATION AND SIZES OF ALL WALLS, FLOORS & CEILING OPENINGS, EQUIPMENT ETC.
- 04. THE CONTRACTOR SHALL LOCATE AND VERIFY ALL EXISTING SERVICES (EXPOSED AND CONCEALED) PRIOR TO ANY DEMOLITION, CUTTING DRILLING OR DIGGING. SERVICES CUT OR DAMAGED AND ANY RESULTING DAMAGE TO PREMISES CAUSED FROM FAILURE TO DO SO WILL BE THE RESPONSIBILITY OF THE CONTRACTOR. CONTRACTOR TO INVESTIGATE ALL POSSIBLE LOCATIONS FOR CORING AT FLOOR SLABS AND WALLS TO INSTALL X-RAY MACHINES TO AVOID INTERRUPTION OF EXISTING SERVICES.
- $_{05.}$  ANY EXISTING SPRAYED FIREPROOFING DAMAGED OR REMOVED IS TO BE REPAIRED AND ITS REPAIR APPROVED BY THE ARCHITECT.
- 06. FOR FINISHES SPECIFICATIONS, COORDINATE WITH TENANT.
- 07. STUD WALL DESIGN SHOULD ACCOMMODATE ANY EXPECTED DEFLECTION OF THE EXISTING FLOOR STRUCTURE AS REQUIRED.
- 08. SECURE STRUCTURAL STUDS TOP AND BOTTOM TO THE EXISTING STRUCTURE. BRACE STUDS ADEQUATELY TO THE EXISTING STRUCTURE.
- 09. ALL EXPOSED GYPSUM BOARD CORNER CONDITIONS TO HAVE CORNER BEAD (TYP.)
- 10. ALL DOOR HARDWARE MUST HAVE A SHAPE THAT IS EASY TO GRASP WITH ONE HAND AND DOES NOT REQUIRE TIGHT GRASPING, TIGHT PINCHING, OR TWISTING OF THE WRIST TO OPERATE.

- 11. ALL ELECTRICAL WORK SHALL BE PERFORMED BY SKILLED LICENSED ELECTRICIANS IN ACCORDANCE WITH THE BEST PRACTICES OF THE TRADE, MEETING THE REQUIREMENT OF THE LATEST EDITION OF THE NATIONAL ELECTRICAL CODE, APPLICABLE FEDERAL PROVINCIAL & LOCAL CODES.
- 12. BUILDING SERVICE CONTROLS I.E SWITCHES,
  THERMOSTATS, ETC, SHALL BE MOUNTED BETWEEN 900MM AND 1200MM ABOVE FINISH
  FLOOR. REF# 3.8.1.5.(1). OF DIV B.
- 13. BUILDING SERVICES PENETRATING ALL FIRE SEPARATION SHALL BE COMPLETED WITH FIRE STOPPING MEASURES IN CONFORMANCE WITH 'DIVISION B' SUB SECTION 3.1.9. OF THE ONTARIO BUILDING CODE 2012. MAINTAIN ALL EXISTING FIRE SEPARATION C/W REQUIRED FIRE RESISTANCE RATING.
- 14. ALL INTERIOR FINISHES TO HAVE A MAXIMUM 150 FLAME SPREAD RATING AS PER 3.1.13.2 OF DIVISION B. FLOOR FINISHES SHALL BE TIGHT, SMOOTH AND NON ABSORBENT
- 15. FOR FINISHES SPECIFICATIONS, COORDINATE WITH TENANT.
- 16. ALL DOORS AND FRAMES TO BE PAINTED
- 17. ALL EXISTING SURFACES TO REMAIN ARE TO BE PROTECTED THROUGHOUT DEMOLITION AND CONSTRUCTION.
- 18. PORTABLE FIRE EXTINGUISHER PER NFPA-10 INSTALLED BY GC ON SITE AND SUBJECT TO LOCAL JURISDICTION APPROVAL. 10LBS IN KITCHEN, 5LBS ELSEWHERE.
- 19. COORDINATE WITH OWNER FOR LOCATION OF ANY SHELVING IF REQUIRED AND PROVIDE BLOCKING ACCORDINGLY.

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REV	ISSUED FOR	DATE

PROJECT NAME AND ADDRESS:

PROPOSED CHANGE OF USE AND INTERIOR ALTERATIONS OF EXISTING RESIDENTIAL BUILDING TO MULTI-APARTMENT (5 NOS.) BUILDING AT

249 MAIN STREET NORTH BRAMPTON,ON L6X 1N3

LEAD CONSULTANT :



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STRUCTURAL CONSULTANT: DEBAJ TECH INC. 16 SOUTHCREST COURT, BRAMPTON, ON L6P 1T6 email: syed.jaffry@gmail.com Tel: 905-454-7499

MEP CONSULTANT:
MAGH ENGINEERING INC.
23 - 6033 SHAWSON DR,
MISSISSAUGA, L5T 1H8, ON.
email: info@magh.ca
Tel: 905-564-1112
DRAWING TITLE:
GENERAL NOTES

DRAWN BY	PS
CHECKED BY	LJ
APPROVED BY	НВ
SCALE	SIZE
N.T.S	A3
SHEET NO	STAGE
A01	AMENDMENT
PHASE 00	REV R5
ISSUED DATE	2022-01-04

ALL WORK SHALL
CONFORM TO THE
ONTARIO BUILDING CODE
O.REG.332/12 AS AMENDED

#### REVISION NAME OF PROJECT PROPOSED CHANGE OF USE AND INTERIOR ALTERATIONS OF EXISTING RESIDENTIAL BUILDING TO MULTI-APARTMENT (5 NOS.) BUILDING AT 249 MAIN STREET NORTH, BRAMPTON, ON. LOCATION **OBC REFERENCE** ITEM ONTARIO BUILDING CODE DATA MATRIX PART 11 PART 9 PROJECT DESCRIPTION: □ PART 3 □ ADDITION 1.1.1 TO 11.4 ☐ UNIT FINISH 2.1.1 2.1.1 ✓ ALTERATION CHANGE OF USE 9.10.1.3 GROUP C 9.10.2 MAJOR OCCUPANCY(S) 3.1.2.1.(1) 3 BUILDING AREA (m) 2 EXISTING 137.539 SQ.M NEW 0 TOTAL TO REMAIN AS IS 1.1.3.2 1.1.3.2 4 EXISTING 301.07 SQ.M NEW 0 TOTAL 301.07 SQ.M 1.1.3.2 1.1.3.2 AREA OF WORK: BASEMENT: 80.73 SQM, FIRST FLOOR: 89.75 SQM, SECOND FLOOR: 90.30 SQ. M. SQM, 5 NUMBER OF STOREYS ABOVE GRADE: 2+ATTIC BELOW GRADE: 1 3.2.1.1 & 1.1.3.2 2.1.1.3 9.10.20 NUMBER OF STREET/ACCESS ROUTES 3.2.2.10 & 3.2.5.5 UNIT CLASSIFICATION GROUP 'C' ,PART 9 3.2.2.55 SPRINKLER SYSTEM ☐ EXISTING ■ ENTIRE BUILDING 3.2.2.20.-.83 9.10.8.2. INDEX INDEX ☐ BASEMENT ONLY ☐ PROPOSED MNOT REQUIRED ☐ IN LIEU OF ROOF RATING 9 STANDPIPE REQUIRED YES M NO 3.2.9 9.10.17.2 10 | FIRE ALARM REQUIRED YES M NO 3.2.4 WATER SERVICE/SUPPLY IS ADEQUATE ✓ YES ☐ NO 3.2.5.7 N/A 12 HIGH BUILDING YES M NO 3.2.6 N/A 13 PERMITTED CONSTRUCTION COMBUSTIBLE NON-COMBUSTIBLE BOTH 3.2.2.20-.83 9.10.6 3.2.2.56 14 MEZZANINE(S) AREA (M) <sup>2</sup> 3.2.1.1.(3)-(8) 9 10 4 1 N/A OCCUPANT LOAD BASED ON ☐ m<sup>2</sup>/ PERSON ☑ DESIGN OF SUITE 9.9.1.3 3.1.17 (6) LOAD 12 PERSONS TOTAL 16 BARRIER-FREE DESIGN 9.5.2 M NO (EXPLAIN) BUILDING IS YES NOT ACCESSIBLE 17 HAZARDOUS SUBSTANCES 3.3.1.2.(1)&3.3.1.19(1) 9.10.1.3 YES 18 HORIZONTAL ASSEMBLIES 3.2.2.20-.83& 3.2.1.4 9.10.8 LISTED DESIGN No. FRR (HOURS) OR DESCRIPTION (SG-2) 9.10.9 1 HR. RATING FLOORS NA HOURS **ROOF 0 HOURS** MEZZANINE 0 HOURS LISTED DESIGN No. OR DESCRIPTION (SG-2) FRR OF SUPPORTING MEMBERS FLOORS NA HOURS EXISTING TO REMAIN ROOF 0 HOURS MEZZANINE 0 HOURS 19 | SPATIAL SEPARATION-CONSTRUCTION OF EXTERIOR WALLS 3.2.3.1.D NON-COMB. WALL AREA OF PERMITTED PROPOSED FRR LISTED COMB. COMB. CONSTR. CONST. OR MAX % OF % OF DESIGN OR CONST NONC. H/L OPENINGS OPENINGS DESCRIPTION CLADDING NORTH EXISTING - NO CHANGE **EXISTING - NO CHANGE** SOUTH EAST **EXISTING - NO CHANGE** WEST NOT APPLICABLE PLUMBING FIXTURE REQUIREMENTS OCCUPANT LOAD FOR CALCULATION FOR THE # OBC REFERENCE OCCUPANT BC TABLE FIXTURES NUMBER REQUIRED OF WASHROOMS REQUIREMENTS: ☐ PART 3 ☐ PART 9 MALE/FEMALE COUNT @ 50% / 50% PROVIDED

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PROJECT NAME AND ADDRESS:

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249 MAIN STREET NORTH BRAMPTON,ON L6X 1N3 LEAD CONSULTANT :





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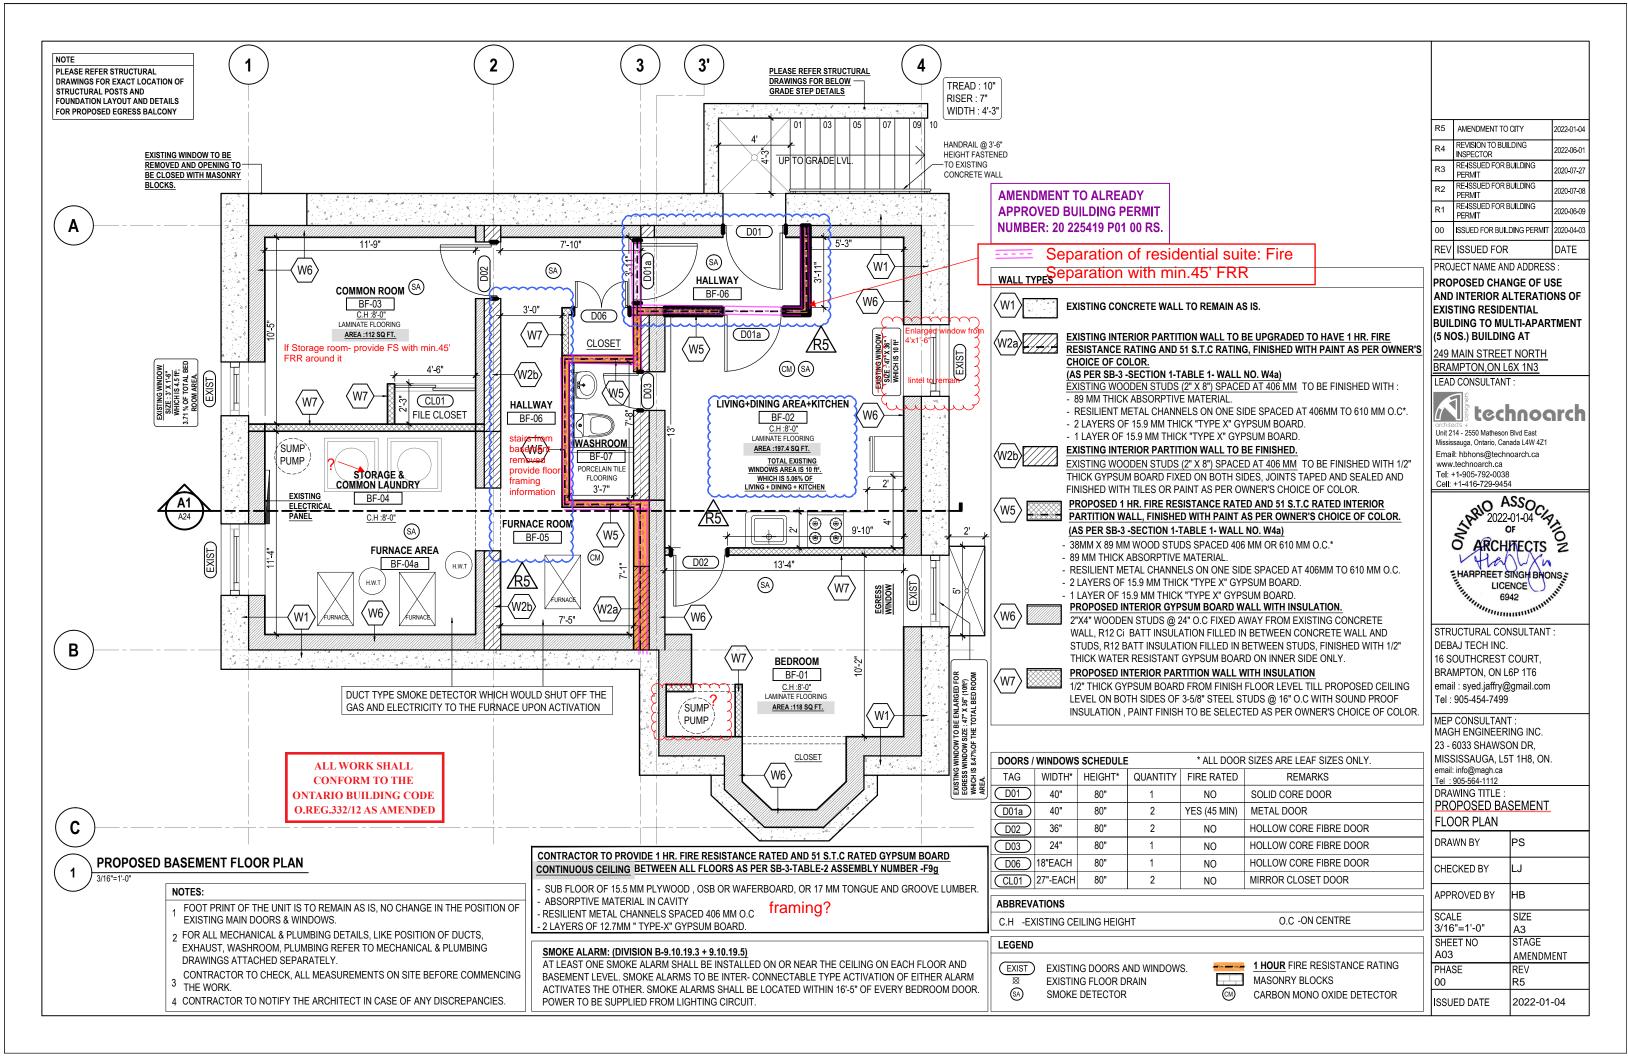



STRUCTURAL CONSULTANT: DEBAJ TECH INC. 16 SOUTHCREST COURT, BRAMPTON, ON L6P 1T6 email: syed.jaffry@gmail.com Tel: 905-454-7499

MEP CONSULTANT : MAGH ENGINEERING INC. 23 - 6033 SHAWSON DR, MISSISSAUGA, L5T 1H8, ON. email: info@magh.ca Tel: 905-564-1112 DRAWING TITLE: O.B.C MATRIX

DRAWN BY PS CHECKED BY APPROVED BY НВ SCALE SIZE N.T.S А3 SHEET NO STAGE A02 AMENDMENT PHASE REV 00 R5 2022-01-04 ISSUED DATE

ALL WORK SHALL **CONFORM TO THE** ONTARIO BUILDING CODE O.REG.332/12 AS AMENDED



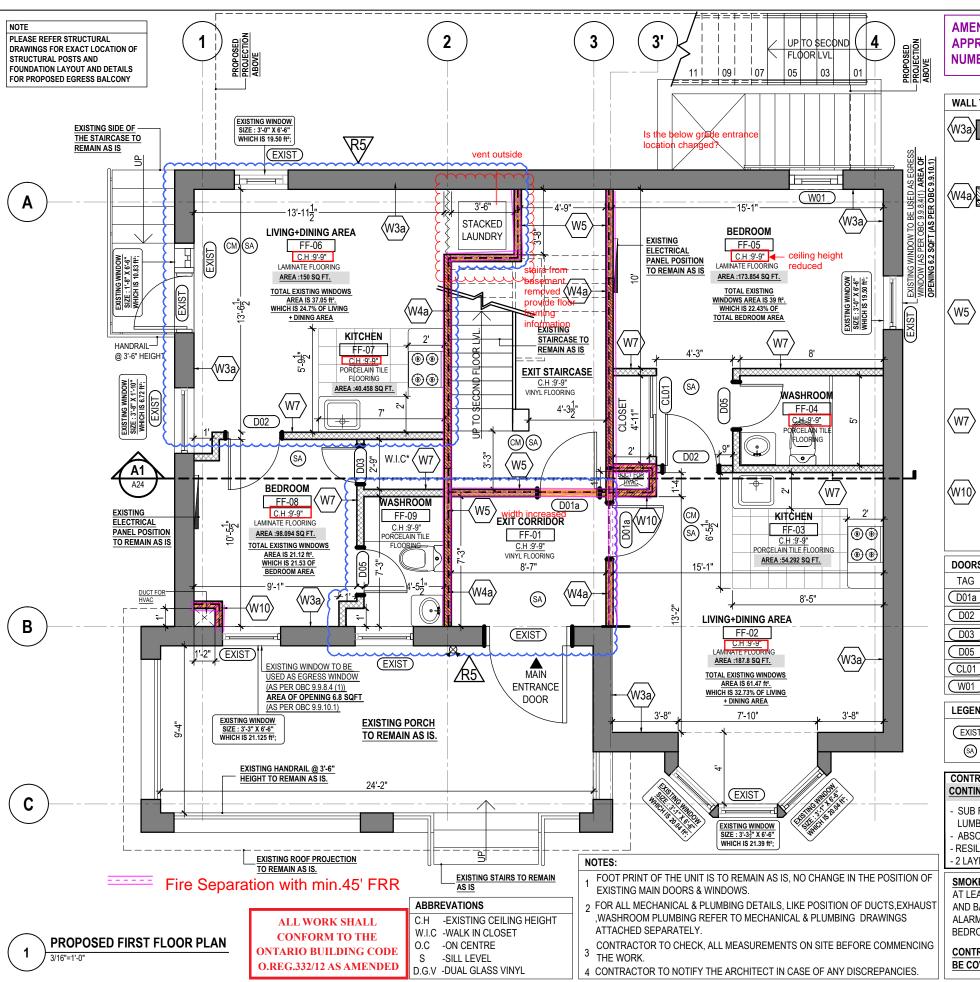

#### **WALL TYPES**



#### **EXISTING EXTERIOR WALL TO BE UPGRADED**

EXISTING EXTERIOR WALL HAVING 2"X6" WOODEN STUDS @16" O.C TO BE UPGRADED WITH R24 MINERAL FIBER INSULATION, APPLICATION OF 6 MIL POLY VAPOR BARRIER TO WARM SIDE WALL FRAMING AND 1/2" THICK GYPSUM BOARD FINISH FROM INTERIOR SIDE



EXISTING INTERIOR PARTITION WALL TO BE UPGRADED TO HAVE 1 HR. FIRE RESISTANCE RATING AND 51 S.T.C RATING, FINISHED WITH PAINT AS PER OWNER'S CHOICE OF COLOR

#### (AS PER SB-3 -SECTION 1-TABLE 1- WALL NO. W4a)

EXISTING WOODEN STUDS (2" X 8") SPACED AT 406 MM TO BE FINISHED WITH

- 89 MM THICK ABSORPTIVE MATERIAL
- RESILIENT METAL CHANNELS ON ONE SIDE SPACED AT 406MM TO 610 MM O.C\*
- 2 LAYERS OF 15.9 MM THICK "TYPE X" GYPSUM BOARD.
- 1 LAYER OF 15.9 MM THICK "TYPE X" GYPSUM BOARD



## PROPOSED 1 HR. FIRE RESISTANCE RATED AND 51 S.T.C RATED INTERIOR PARTITION WALL, FINISHED WITH PAINT AS PER OWNER'S CHOICE OF COLOR.

- (AS PER SB-3 -SECTION 1-TABLE 1- WALL NO. W4a) - 38MM X 89 MM WOOD STUDS SPACED 406 MM OR 610 MM O.C.\*
- 89 MM THICK ABSORPTIVE MATERIAL
- RESILIENT METAL CHANNELS ON ONE SIDE SPACED AT 406MM TO 610 MM O.C.
- 2 LAYERS OF 15.9 MM THICK "TYPE X" GYPSUM BOARD
- 1 LAYER OF 15.9 MM THICK "TYPE X" GYPSUM BOARD.



#### PROPOSED INTERIOR PARTITION WALL WITH INSULATION

1/2" THICK GYPSUM BOARD FROM FINISH FLOOR LEVEL TILL PROPOSED CEILING LEVEL ON BOTH SIDES OF 3-5/8" STEEL STUDS @ 16" O.C WITH SOUND PROOF INSULATION, PAINT FINISH TO BE SELECTED AS PER OWNER'S CHOICE OF





## PROPOSED 1 HR. FIRE RESISTANCE RATED SHAFT WALL, FINISHED WITH PAINT

- AS PER PAINT AS PER OWNER'S CHOICE OF COLOR (AS PER ULC W452 SYSTEM A) • 15.9 MM (5/8") CGC SHEETROCK® BRAND FIRECODE® X PANELS, JOINTS FINISHED
- 64 MM (2-1/2") CGC C-H STUDS 25 GAUGE 610 MM (24") O.C.
- 25.4 MM (1") CGC SHEETROCK® BRAND GLASS-MAT LINER PANELS

DOORS /	WINDOWS	SCHEDULE		* ALL DOOR	R SIZES ARE LEAF SIZES ONLY.
TAG	WIDTH*	HEIGHT*	QUANTITY	FIRE RATED	REMARKS
D01a	40"	80"	2	YES (45 MIN)	METAL DOOR
D02	36"	80"	2	NO	HOLLOW CORE FIBRE DOOR
D03	24"	80"	1	NO	HOLLOW CORE FIBRE DOOR
D05	30"	80"	2	NO	HOLLOW CORE FIBRE DOOR
CL01	27"-EACH	80"	1	NO	MIRROR CLOSET DOOR
(W01)	36"	78"	1	NO	D.G.V* FIXED GLASS WINDOW

#### LEGEND

(EXIST)

EXISTING DOORS AND WINDOWS.

SMOKE DETECTOR

1 HOUR FIRE RESISTANCE RATING

(CM)

CARBON MONO OXIDE DETECTOR

### CONTRACTOR TO PROVIDE 1 HR. FIRE RESISTANCE RATED AND 51 S.T.C RATED GYPSUM BOARD CONTINUOUS CEILING BETWEEN ALL FLOORS AS PER SB-3-TABLE-2 ASSEMBLY NUMBER -F9g

- $\cdot$  SUB FLOOR OF 15.5 MM PLYWOOD , OSB OR WAFERBOARD, OR 17 MM TONGUE AND GROOVE LUMBER.
- ABSORPTIVE MATERIAL IN CAVITY
- RESILIENT METAL CHANNELS SPACED 406 MM O.C
- 2 LAYERS OF 12.7MM " TYPE-X" GYPSUM BOARD.

#### SMOKE ALARM: (DIVISION B-9.10.19.3 + 9.10.19.5)

AT LEAST ONE SMOKE ALARM SHALL BE INSTALLED ON OR NEAR THE CEILING ON EACH FLOOR AND BASEMENT LEVEL. SMOKE ALARMS TO BE INTER- CONNECTABLE TYPE ACTIVATION OF EITHER ALARM ACTIVATES THE OTHER. SMOKE ALARMS SHALL BE LOCATED WITHIN 16'-5" OF EVERY BEDROOM DOOR. POWER TO BE SUPPLIED FROM LIGHTING CIRCUIT

CONTRACTOR TO ENSURE THAT EXISTING ELECTRICAL PANEL SHOULD BE COVERED WITH WOODEN SHUTTERS.

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REV	ISSUED FOR	DATE

PROJECT NAME AND ADDRESS

PROPOSED CHANGE OF USE AND INTERIOR ALTERATIONS OF EXISTING RESIDENTIAL BUILDING TO MULTI-APARTMENT (5 NOS.) BUILDING AT

249 MAIN STREET NORTH BRAMPTON, ON L6X 1N3

LEAD CONSULTANT



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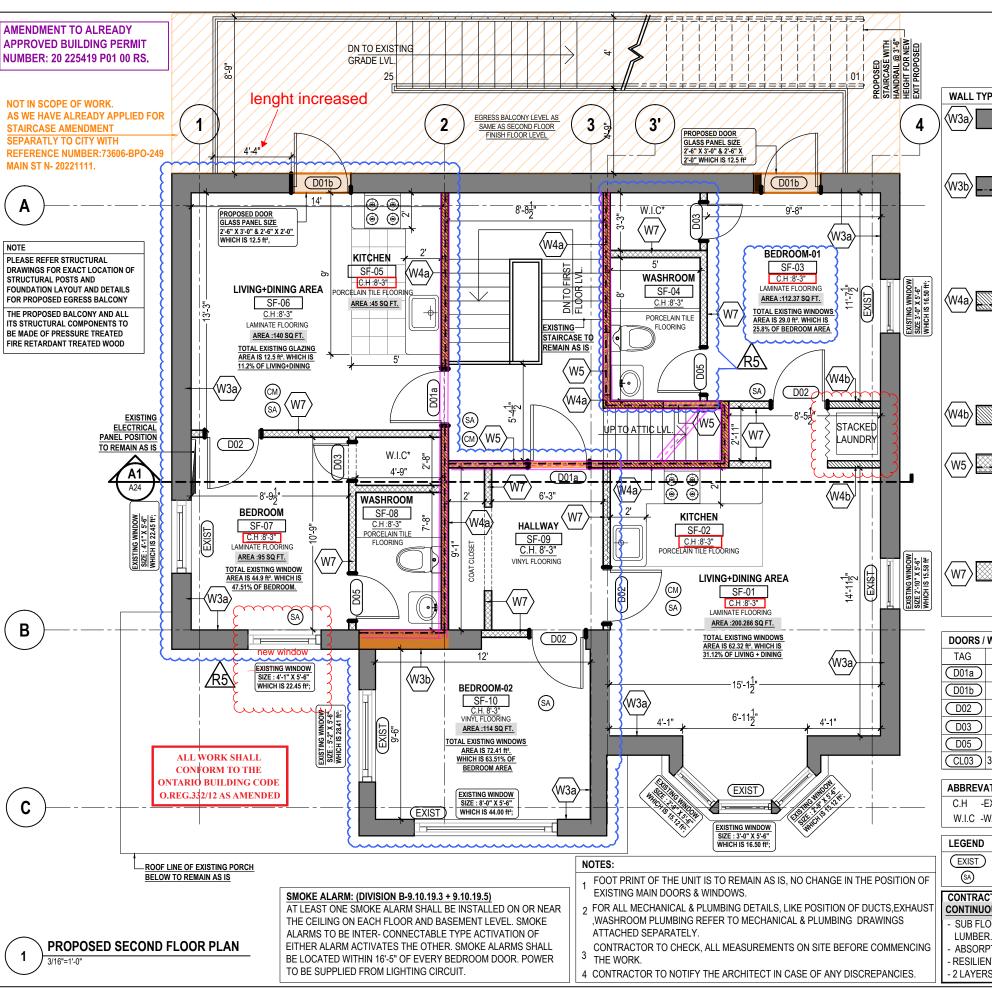
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MEP CONSULTANT: MAGH ENGINEERING INC. 23 - 6033 SHAWSON DR, MISSISSAUGA, L5T 1H8, ON. email: info@magh.ca Tel: 905-564-1112 DRAWING TITLE PROPOSED FIRST FLOOR PLAN

DRAWN BY PS CHECKED BY APPROVED BY ΗВ SCALE SIZE 3/16"=1'-0" A3 SHEET NO STAGE A04 AMENDMENT PHASE REV 00 ISSUED DATE 2022-01-04




**WALL TYPES** 



#### EXISTING EXTERIOR WALL TO BE UPGRADED

EXISTING EXTERIOR WALL HAVING 2"X6" WOODEN STUDS @16" O.C TO BE UPGRADED WITH R24 MINERAL FIBER INSULATION, APPLICATION OF 6 MIL POLY VAPOR BARRIER TO WARM SIDE WALL FRAMING AND 1/2" THICK GYPSUM BOARD FINISH FROM INTERIOR SIDE.

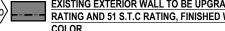


EXISTING EXTERIOR WALL TO BE UPGRADED TO HAVE 1HR. FIRE RESISTANCE RATING AND 51 S.T.C RATING, FINISHED WITH PAINT AS PER OWNER'S CHOICE OF

#### (AS PER SB-3 -SECTION 1-TABLE 1- WALL NO. W4A)

EXISTING WOODEN STUDS (2" X 6") SPACED AT 406 MM TO BE FINISHED WITH:


- 89 MM THICK ABSORPTIVE MATERIAL.
- RESILIENT METAL CHANNELS ON ONE SIDE SPACED AT 406MM TO 610 MM O.C\*.
- 2 LAYERS OF 15.9 MM THICK "TYPE X" GYPSUM BOARD.
- 1 LAYER OF 15.9 MM THICK "TYPE X" GYPSUM BOARD

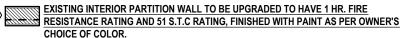

#### (AS PER SB-3 -SECTION 1-TABLE 1- WALL NO. W4a)

EXISTING WOODEN STUDS (2" X 8") SPACED AT 406 MM TO BE FINISHED WITH

- 89 MM THICK ABSORPTIVE MATERIAL.
- RESILIENT METAL CHANNELS ON ONE SIDE SPACED AT 406MM TO 610 MM O.C\*
- 2 LAYERS OF 15.9 MM THICK "TYPE X" GYPSUM BOARD.
- 1 LAYER OF 15.9 MM THICK "TYPE X" GYPSUM BOARD.

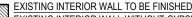

EXISTING INTERIOR WALL WITHOUT GYPSUM BOARD TO BE FINISHED WITH 1/2" THICK GYPSUM BOARD FIXED ON BOTH SIDES, JOINTS TAPED AND SEALED AND FINISHED WITH TILES OR PAINT AS PER OWNER'S CHOICE OF COLOR.



PROPOSED 1 HR. FIRE RESISTANCE RATED AND 51 S.T.C RATED INTERIOR PARTITION WALL, FINISHED WITH PAINT AS PER OWNER'S CHOICE OF COLOR.

#### (AS PER SB-3 -SECTION 1-TABLE 1- WALL NO. W4a)

- 38MM X 89 MM WOOD STUDS SPACED 406 MM OR 610 MM O.C.\*
- 89 MM THICK ABSORPTIVE MATERIAL
- RESILIENT METAL CHANNELS ON ONE SIDE SPACED AT 406MM TO 610 MM O.C.
- 2 LAYERS OF 15.9 MM THICK "TYPE X" GYPSUM BOARD.
- 1 LAYER OF 15.9 MM THICK "TYPE X" GYPSUM BOARD.

#### PROPOSED INTERIOR PARTITION WALL WITH INSULATION

1/2" THICK GYPSUM BOARD FROM FINISH FLOOR LEVEL TILL PROPOSED CEILING LEVEL ON BOTH SIDES OF 3-5/8" STEEL STUDS @ 16" O.C WITH SOUND PROOF INSULATION. PAINT FINISH TO BE SELECTED AS PER OWNER'S CHOICE OF COLOR.

	DOORS /	WINDOWS	SCHEDULE		*	ALL DOOR SIZES ARE LEAF SIZES ONLY.
	TAG	WIDTH*	HEIGHT*	QUANTITY	FIRE RATED	REMARKS
	D01a	40"	80"	2	YES (45 MIN)	METAL DOOR
	D01b	40"	80"	2	NO	GLASS DOOR WITH FRAME
	D02	36"	80"	4	NO	HOLLOW CORE FIBRE DOOR
	D03	24"	80"	2	NO	HOLLOW CORE FIBRE DOOR
Ī	D05	30"	80"	2	NO	HOLLOW CORE FIBRE DOOR
	CL03	36"-EACH	80"	1	NO	MIRROR CLOSET DOOR

#### **ABBREVATIONS**

O.C-ON CENTRE C.H -EXISTING CEILING HEIGHT D.G.V -DUAL GLASS VINYL W.I.C -WALK IN CLOSET S -SILL LEVEL

EXISTING DOORS AND WINDOWS. SMOKE DETECTOR

(CM)

1 HOUR FIRE RESISTANCE RATING CARBON MONO OXIDE DETECTOR

#### CONTRACTOR TO PROVIDE 1 HR. FIRE RESISTANCE RATED AND 51 S.T.C RATED GYPSUM BOARD CONTINUOUS CEILING BETWEEN ALL FLOORS AS PER SB-3-TABLE-2 ASSEMBLY NUMBER -F9g

- SUB FLOOR OF 15.5 MM PLYWOOD, OSB OR WAFERBOARD, OR 17 MM TONGUE AND GROOVE
- ABSORPTIVE MATERIAL IN CAVITY
- RESILIENT METAL CHANNELS SPACED 406 MM O.C.
- 2 LAYERS OF 12.7MM " TYPE-X" GYPSUM BOARD.

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REV	ISSUED FOR	DATE		
DRO IECT NAME AND ADDRESS				

ROJECT NAME AND ADDRESS

PROPOSED CHANGE OF USE AND INTERIOR ALTERATIONS OF **EXISTING RESIDENTIAL BUILDING TO MULTI-APARTMENT** (5 NOS.) BUILDING AT

249 MAIN STREET NORTH BRAMPTON, ON L6X 1N3 LEAD CONSULTANT



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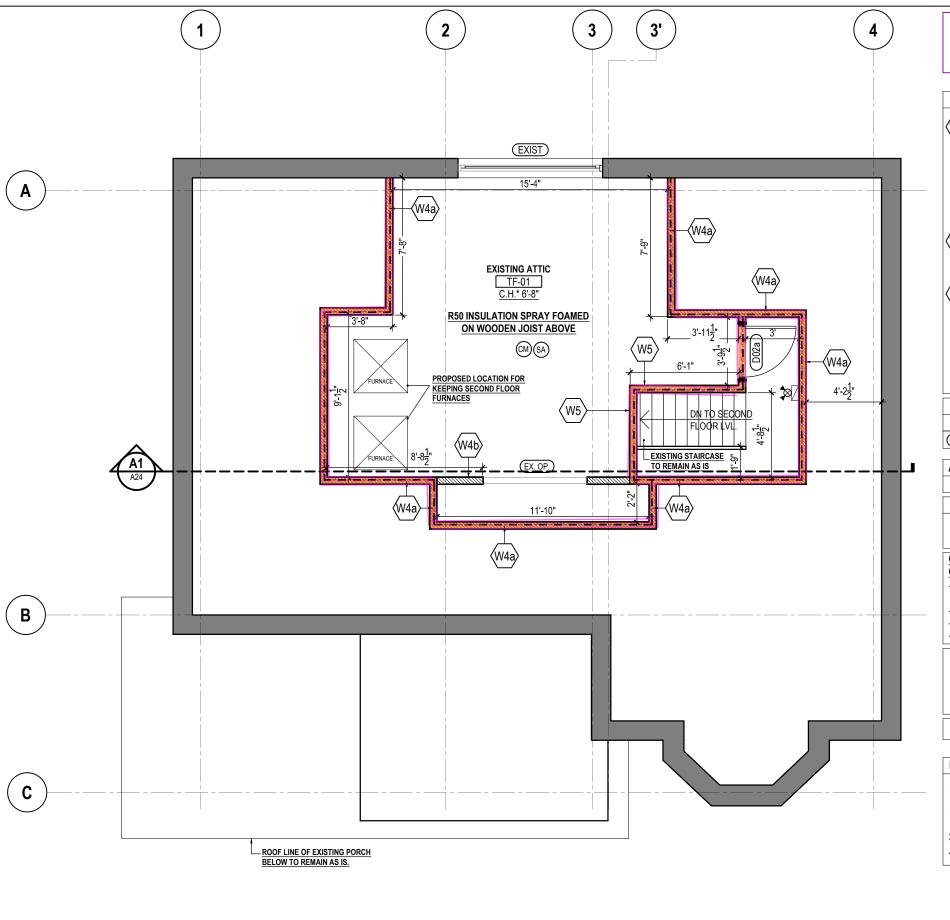


STRUCTURAL CONSULTANT DEBAJ TECH INC. 16 SOUTHCREST COURT. BRAMPTON, ON L6P 1T6 email: syed.jaffry@gmail.com Tel: 905-454-7499

MEP CONSULTANT: MAGH ENGINEERING INC. 23 - 6033 SHAWSON DR, MISSISSAUGA, L5T 1H8, ON email: info@magh.ca Tel: 905-564-1112 DRAWING TITLE

## PROPOSED SECOND FLOOR PLAN

DRAWN BY PS CHECKED BY APPROVED BY НВ SCALE SIZE 3/16"=1'-0" A3 SHEET NO STAGE A05 AMENDMENT PHASE REV 00 R5 ISSUED DATE 2022-01-04



#### **WALL TYPES**



EXISTING INTERIOR PARTITION WALL TO BE UPGRADED TO HAVE 1 HR. FIRE RESISTANCE RATING, 51 S.T.C RATING AND R24 RATING, FINISHED WITH PAINT AS PER OWNER'S CHOICE OF COLOR.

(AS PER SB-3 -SECTION 1-TABLE 1- WALL NO. W4a)

EXISTING WOODEN STUDS (2" X 8") SPACED AT 406 MM TO BE FINISHED WITH:

- 89 MM THICK ABSORPTIVE MATERIAL.
- RESILIENT METAL CHANNELS ON ONE SIDE SPACED AT 406MM TO 610 MM O.C\*.
- 2 LAYERS OF 15.9 MM THICK "TYPE X" GYPSUM BOARD.
- 1 LAYER OF 15.9 MM THICK "TYPE X" GYPSUM BOARD.



EXISTING INTERIOR WALL TO BE FINISHED

EXISTING INTERIOR WALL WITHOUT GYPSUM BOARD TO BE FINISHED WITH 1/2" THICK GYPSUM BOARD FIXED ON BOTH SIDES, JOINTS TAPED AND SEALED AND FINISHED WITH TILES OR PAINT AS PER OWNER'S CHOICE OF COLOR.



PROPOSED 1 HR. FIRE RESISTANCE RATED AND 51 S.T.C RATED INTERIOR
PARTITION WALL, FINISHED WITH PAINT AS PER OWNER'S CHOICE OF COLOR.
(AS PER SB-3 -SECTION 1-TABLE 1- WALL NO. W4a)

- 38MM X 89 MM WOOD STUDS SPACED 406 MM OR 610 MM O.C.\*
- 89 MM THICK ABSORPTIVE MATERIAL.
- RESILIENT METAL CHANNELS ON ONE SIDE SPACED AT 406MM TO 610 MM O.C.
- 2 LAYERS OF 15.9 MM THICK "TYPE X" GYPSUM BOARD.
- 1 LAYER OF 15.9 MM THICK "TYPE X" GYPSUM BOARD.

DOORS /	WINDOWS	SCHEDULE		*	ALL DOOR SIZES ARE LEAF SIZES ONLY.
TAG	WIDTH*	HEIGHT*	QUANTITY	FIRE RATED	REMARKS
(D02a)	36"	80"	1	YES (45 MIN)	METAL DOOR

#### ABBREVATIONS

C.H -EXISTING CEILING HEIGHT

O.C -ON CENTRE

#### LEGEND

EXIST EXISTING DOORS AND WINDOWS.

SA) SMOKE DETECTOR

1 HOUR FIRE RESISTANCE RATING

CARBON MONO OXIDE DETECTOR

CONTRACTOR TO PROVIDE 1 HR. FIRE RESISTANCE RATED AND 51 S.T.C RATED GYPSUM BOARD CEILING BETWEEN ALL FLOORS AS PER SB-3-TABLE-2 ASSEMBLY NUMBER -F9g

(CM)

- SUB FLOOR OF 15.5 MM PLYWOOD , OSB OR WAFERBOARD, OR 17 MM TONGUE AND GROOVE LUMBER.
- ABSORPTIVE MATERIAL IN CAVITY
- RESILIENT METAL CHANNELS SPACED 406 MM O.C
- 2 LAYERS OF 12.7MM " TYPE-X" GYPSUM BOARD.

### **SMOKE ALARM: (DIVISION B-9.10.19.3 + 9.10.19.5)**

AT LEAST ONE SMOKE ALARM SHALL BE INSTALLED ON OR NEAR THE CEILING ON EACH FLOOR AND BASEMENT LEVEL. SMOKE ALARMS TO BE INTER- CONNECTABLE TYPE ACTIVATION OF EITHER ALARM ACTIVATES THE OTHER. SMOKE ALARMS TO CONFORM TO OBC DIV. B 9.10.19

NOTE: THE ATTIC AREA WILL ONLY BE USED FOR KEEPING SERVICES.

#### NOTES:

- 1 FOOT PRINT OF THE UNIT IS TO REMAIN AS IS, NO CHANGE IN THE POSITION OF EXISTING MAIN DOORS & WINDOWS.
- 2 FOR ALL MECHANICAL & PLUMBING DETAILS, LIKE POSITION OF DUCTS, EXHAUST, WASHROOM PLUMBING REFER TO MECHANICAL & PLUMBING DRAWINGS ATTACHED SEPARATELY.
- 3 CONTRACTOR TO CHECK, ALL MEASUREMENTS ON SITE BEFORE COMMENCING THE WORK.
- 4 CONTRACTOR TO NOTIFY THE ARCHITECT IN CASE OF ANY DISCREPANCIES.

ALL WORK SHALL
CONFORM TO THE
ONTARIO BUILDING CODE
O.REG.332/12 AS AMENDED

R5	AMENDMENT TO CITY	2022-01-04
R4	REVISION TO BUILDING INSPECTOR	2022-06-01
R3	RE-ISSUED FOR BUILDING PERMIT	2020-07-27
R2	RE-ISSUED FOR BUILDING PERMIT	2020-07-08
R1	RE-ISSUED FOR BUILDING PERMIT	2020-06-09
00	ISSUED FOR BUILDING PERMIT	2020-04-03
REV	ISSUED FOR	DATE

PROJECT NAME AND ADDRESS:

PROPOSED CHANGE OF USE AND INTERIOR ALTERATIONS OF EXISTING RESIDENTIAL BUILDING TO MULTI-APARTMENT (5 NOS.) BUILDING AT

249 MAIN STREET NORTH BRAMPTON,ON L6X 1N3 LEAD CONSULTANT :



technoarch

Unit 214 - 2550 Matheson Blvd East Mississauga, Ontario, Canada L4W 4Z1 Email: hbhons@technoarch.ca www.technoarch.ca Tel: +1-905-792-0038 Cell: +1-416-729-9454





STRUCTURAL CONSULTANT:
DEBAJ TECH INC.
16 SOUTHCREST COURT,
BRAMPTON, ON L6P 1T6
email: syed.jaffry@gmail.com
Tel: 905-454-7499

MEP CONSULTANT:
MAGH ENGINEERING INC.
23 - 6033 SHAWSON DR,
MISSISSAUGA, L5T 1H8, ON.
email: info@magh.ca
Tel: 905-564-1112
DRAWING TITLE:
PROPOSED ATTIC PLAN

DRAWN BY PS CHECKED BY APPROVED BY НВ SCALE SIZE 3/16"=1'-0" STAGE SHEET NO A06 AMENDMENT PHASE REV ISSUED DATE 2022-01-04

PROPOSED ATTIC PLAN

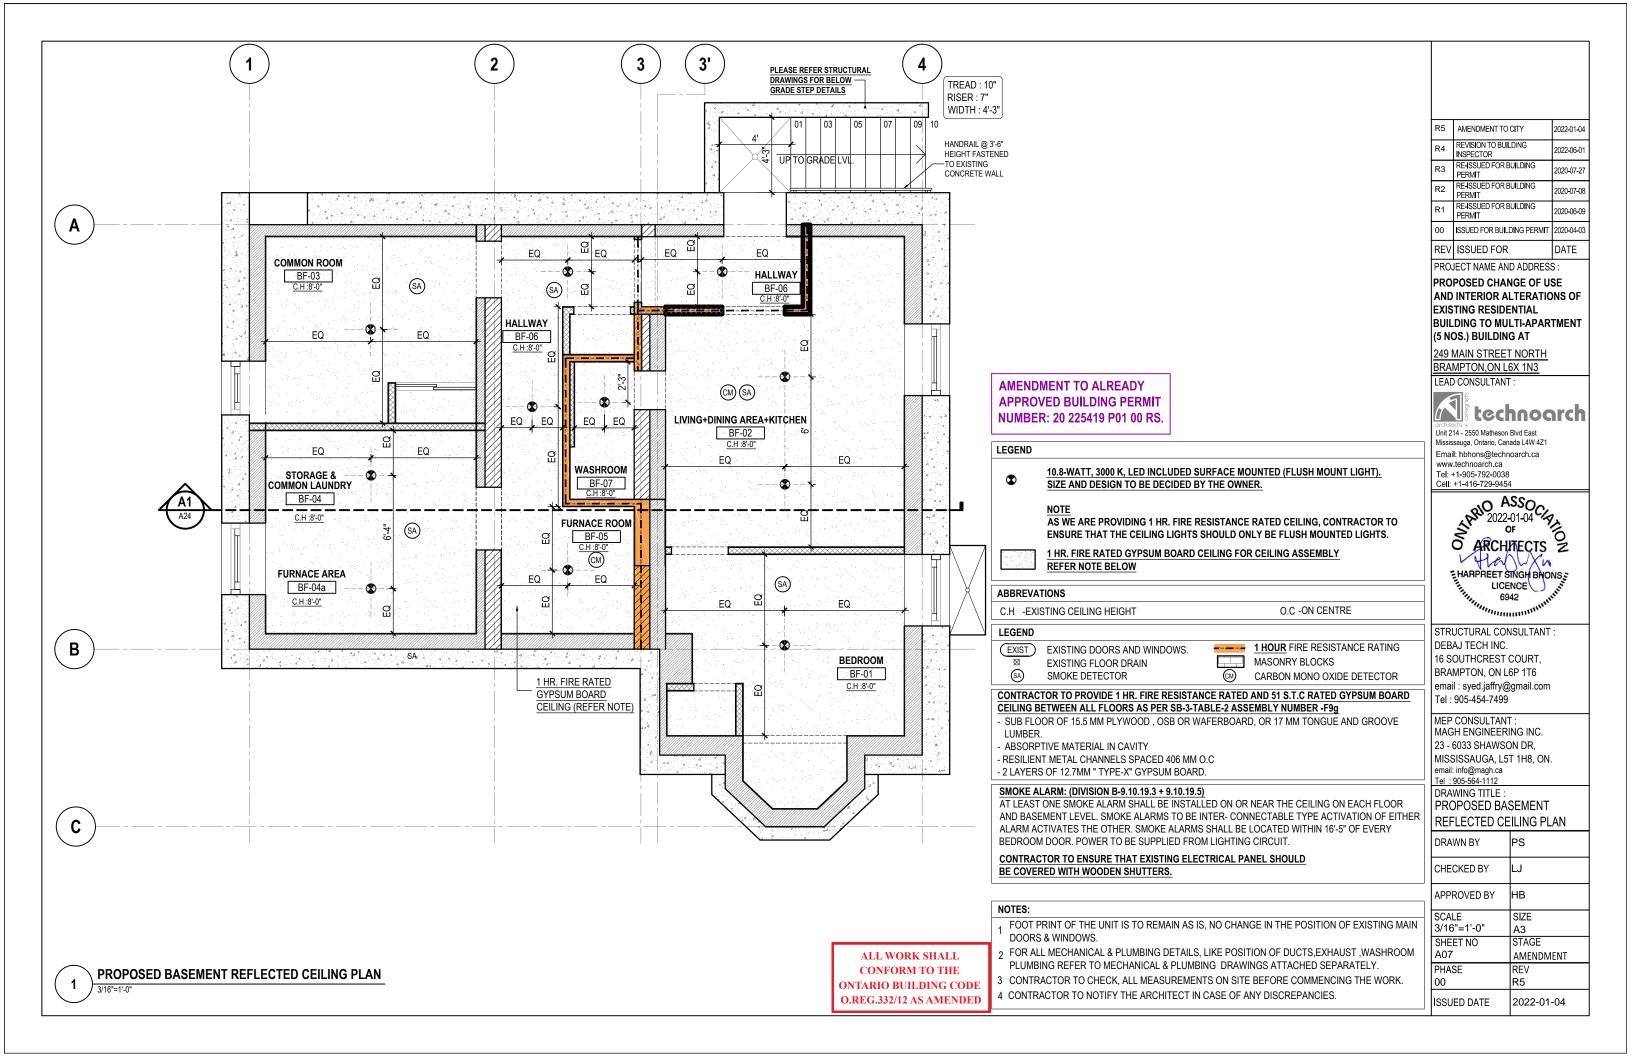

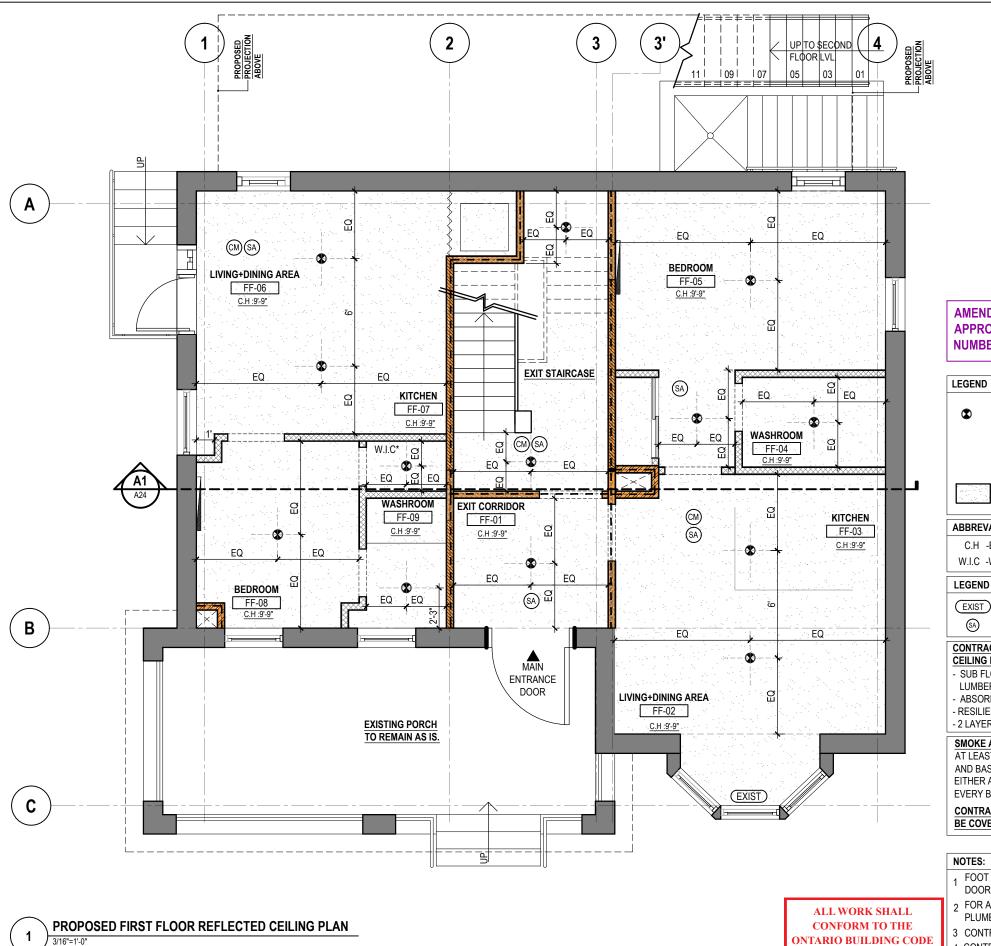

#### LEGEND

10.8-WATT, 3000 K, LED INCLUDED SURFACE MOUNTED (FLUSH MOUNT LIGHT). SIZE AND DESIGN TO BE DECIDED BY THE OWNER.

AS WE ARE PROVIDING 1 HR. FIRE RESISTANCE RATED CEILING, CONTRACTOR TO ENSURE THAT THE CEILING LIGHTS SHOULD ONLY BE FLUSH MOUNTED LIGHTS.

1 HR. FIRE RATED GYPSUM BOARD CEILING FOR CEILING ASSEMBLY REFER NOTE BELOW

#### **ABBREVATIONS**

C.H -EXISTING CEILING HEIGHT

O.C-ON CENTRE

W.I.C -WALK IN CLOSET

(EXIST) EXISTING DOORS AND WINDOWS.

SMOKE DETECTOR

1 HOUR FIRE RESISTANCE RATING CARBON MONO OXIDE DETECTOR

CONTRACTOR TO PROVIDE 1 HR. FIRE RESISTANCE RATED AND 51 S.T.C RATED GYPSUM BOARD CEILING BETWEEN ALL FLOORS AS PER SB-3-TABLE-2 ASSEMBLY NUMBER -F9g

- · SUB FLOOR OF 15.5 MM PLYWOOD , OSB OR WAFERBOARD, OR 17 MM TONGUE AND GROOVE
- ABSORPTIVE MATERIAL IN CAVITY
- RESILIENT METAL CHANNELS SPACED 406 MM O.C
- 2 LAYERS OF 12.7MM " TYPE-X" GYPSUM BOARD.

### SMOKE ALARM: (DIVISION B-9.10.19.3 + 9.10.19.5)

AT LEAST ONE SMOKE ALARM SHALL BE INSTALLED ON OR NEAR THE CEILING ON EACH FLOOR AND BASEMENT LEVEL. SMOKE ALARMS TO BE INTER- CONNECTABLE TYPE ACTIVATION OF EITHER ALARM ACTIVATES THE OTHER. SMOKE ALARMS SHALL BE LOCATED WITHIN 16'-5" OF EVERY BEDROOM DOOR. POWER TO BE SUPPLIED FROM LIGHTING CIRCUIT

CONTRACTOR TO ENSURE THAT EXISTING ELECTRICAL PANEL SHOULD BE COVERED WITH WOODEN SHUTTERS.

- FOOT PRINT OF THE UNIT IS TO REMAIN AS IS, NO CHANGE IN THE POSITION OF EXISTING MAIN
- PLUMBING REFER TO MECHANICAL & PLUMBING DRAWINGS ATTACHED SEPARATELY.
- 4 CONTRACTOR TO NOTIFY THE ARCHITECT IN CASE OF ANY DISCREPANCIES.

AMENDMENT TO CITY 2022-01-04 REVISION TO BUILDING 2022-06-01 2020-07-27 PERMIT RE-ISSUED FOR BUILDING 020-07-08 PERMIT RE-ISSUED FOR BUILDING PERMIT ISSUED FOR BUILDING PERMIT 020-04-03 REV ISSUED FOR DATE

PROJECT NAME AND ADDRESS

PROPOSED CHANGE OF USE AND INTERIOR ALTERATIONS OF **EXISTING RESIDENTIAL** BUILDING TO MULTI-APARTMENT (5 NOS.) BUILDING AT

249 MAIN STREET NORTH BRAMPTON,ON L6X 1N3



## technoarch

Mississauga, Ontario, Canada L4W 4Z1 Email: hbhons@technoarch.ca www.technoarch.ca Tel: +1-905-792-0038 Cell: +1-416-729-9454



STRUCTURAL CONSULTANT: DEBAJ TECH INC. 16 SOUTHCREST COURT, BRAMPTON, ON L6P 1T6 email: syed.jaffry@gmail.com Tel: 905-454-7499


MEP CONSULTANT: MAGH ENGINEERING INC. 23 - 6033 SHAWSON DR, MISSISSAUGA, L5T 1H8, ON. email: info@magh.ca Tel: 905-564-1112


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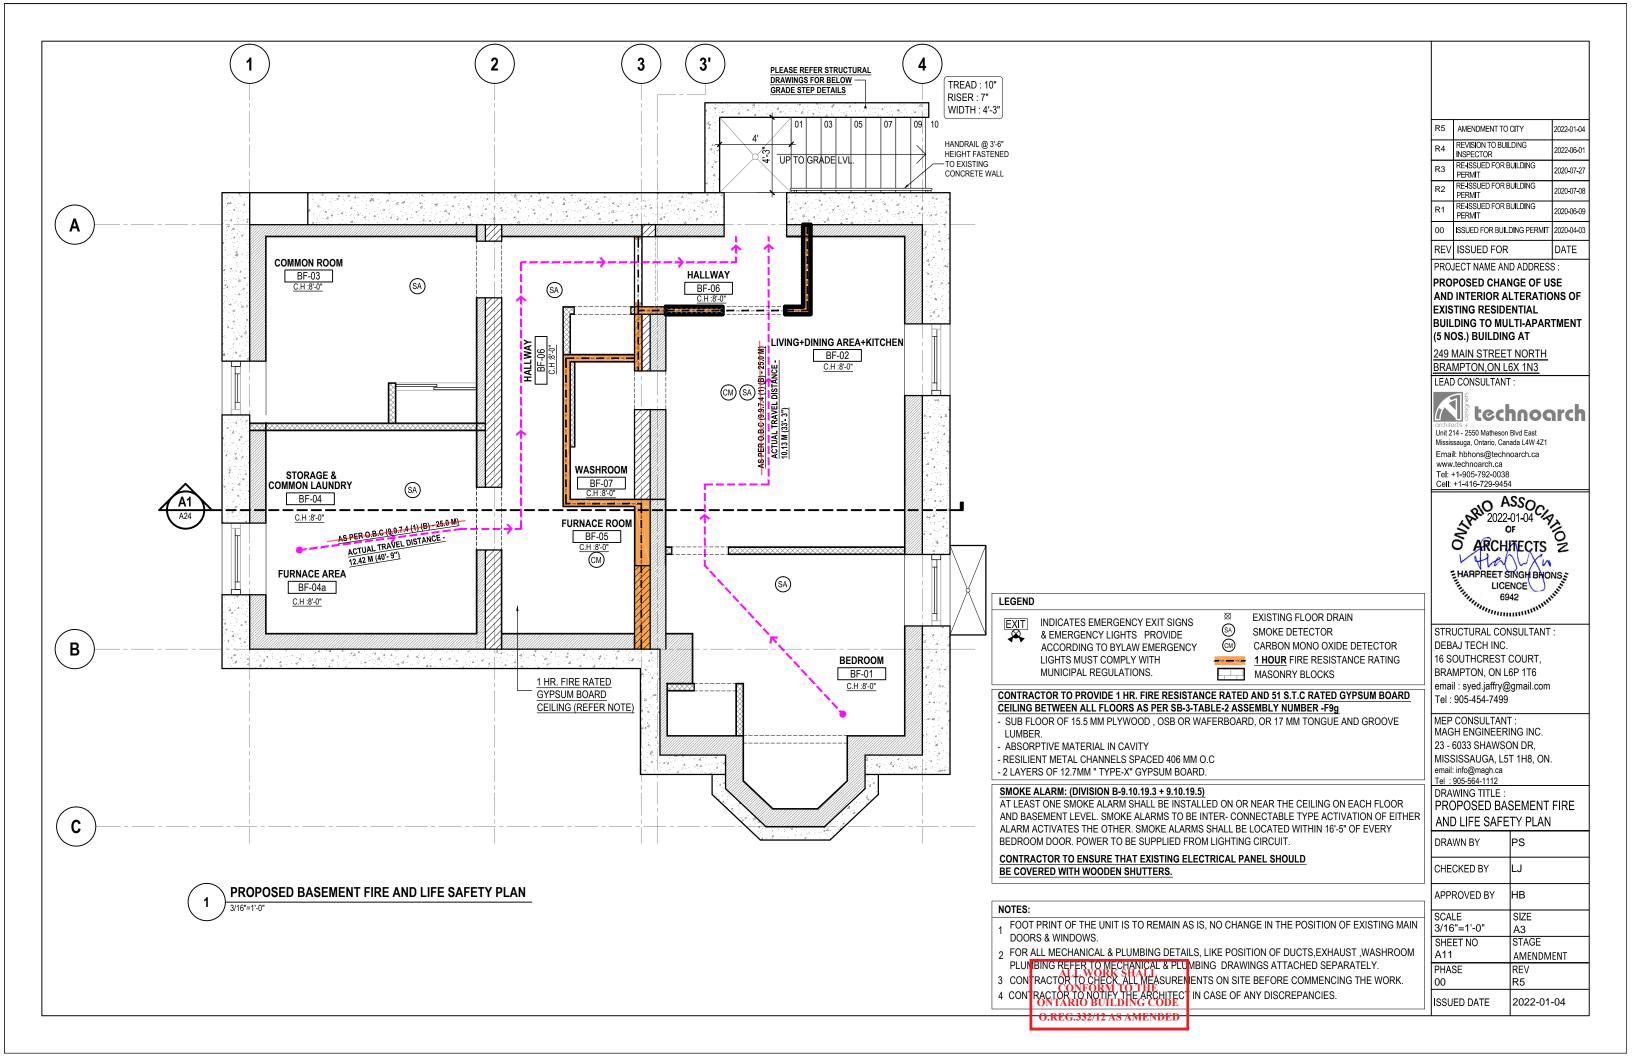
DRAWN BY	PS
CHECKED BY	LJ
APPROVED BY	НВ
SCALE	SIZE
3/16"=1'-0"	A3
SHEET NO	STAGE
A08	AMENDMENT
PHASE	REV
00	R5
ISSUED DATE	2022-01-04


O.REG.332/12 AS AMENDED

- FOR ALL MECHANICAL & PLUMBING DETAILS, LIKE POSITION OF DUCTS, EXHAUST, WASHROOM
- 3 CONTRACTOR TO CHECK, ALL MEASUREMENTS ON SITE BEFORE COMMENCING THE WORK.



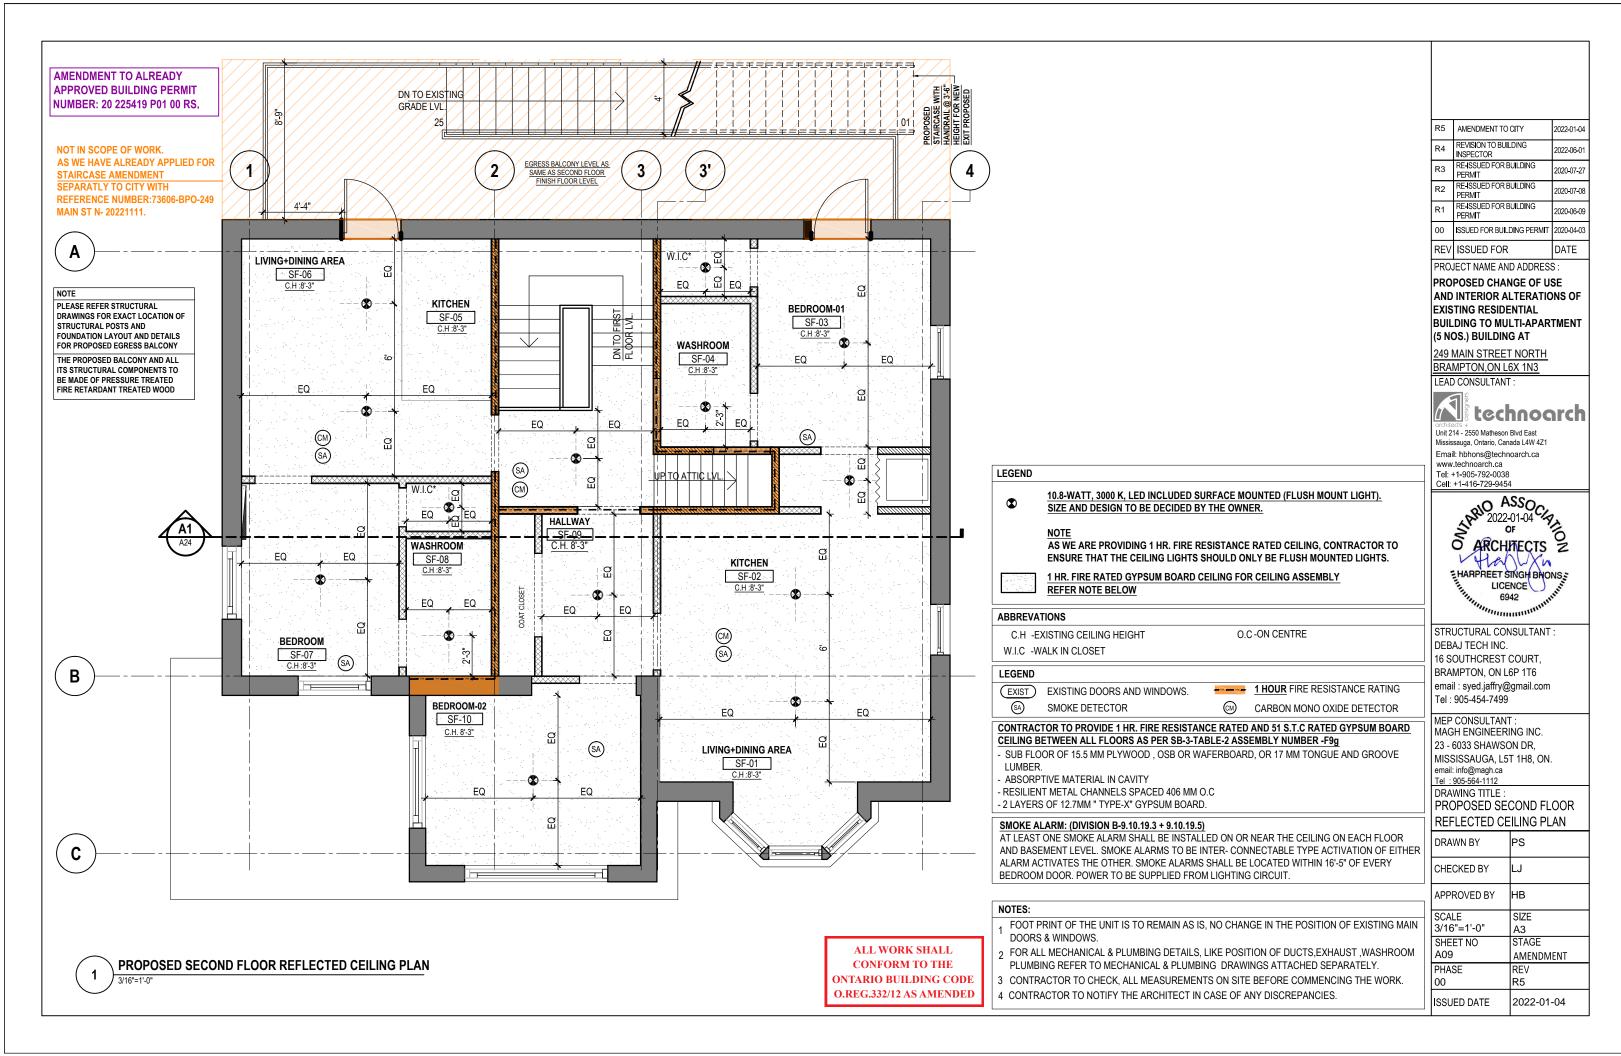

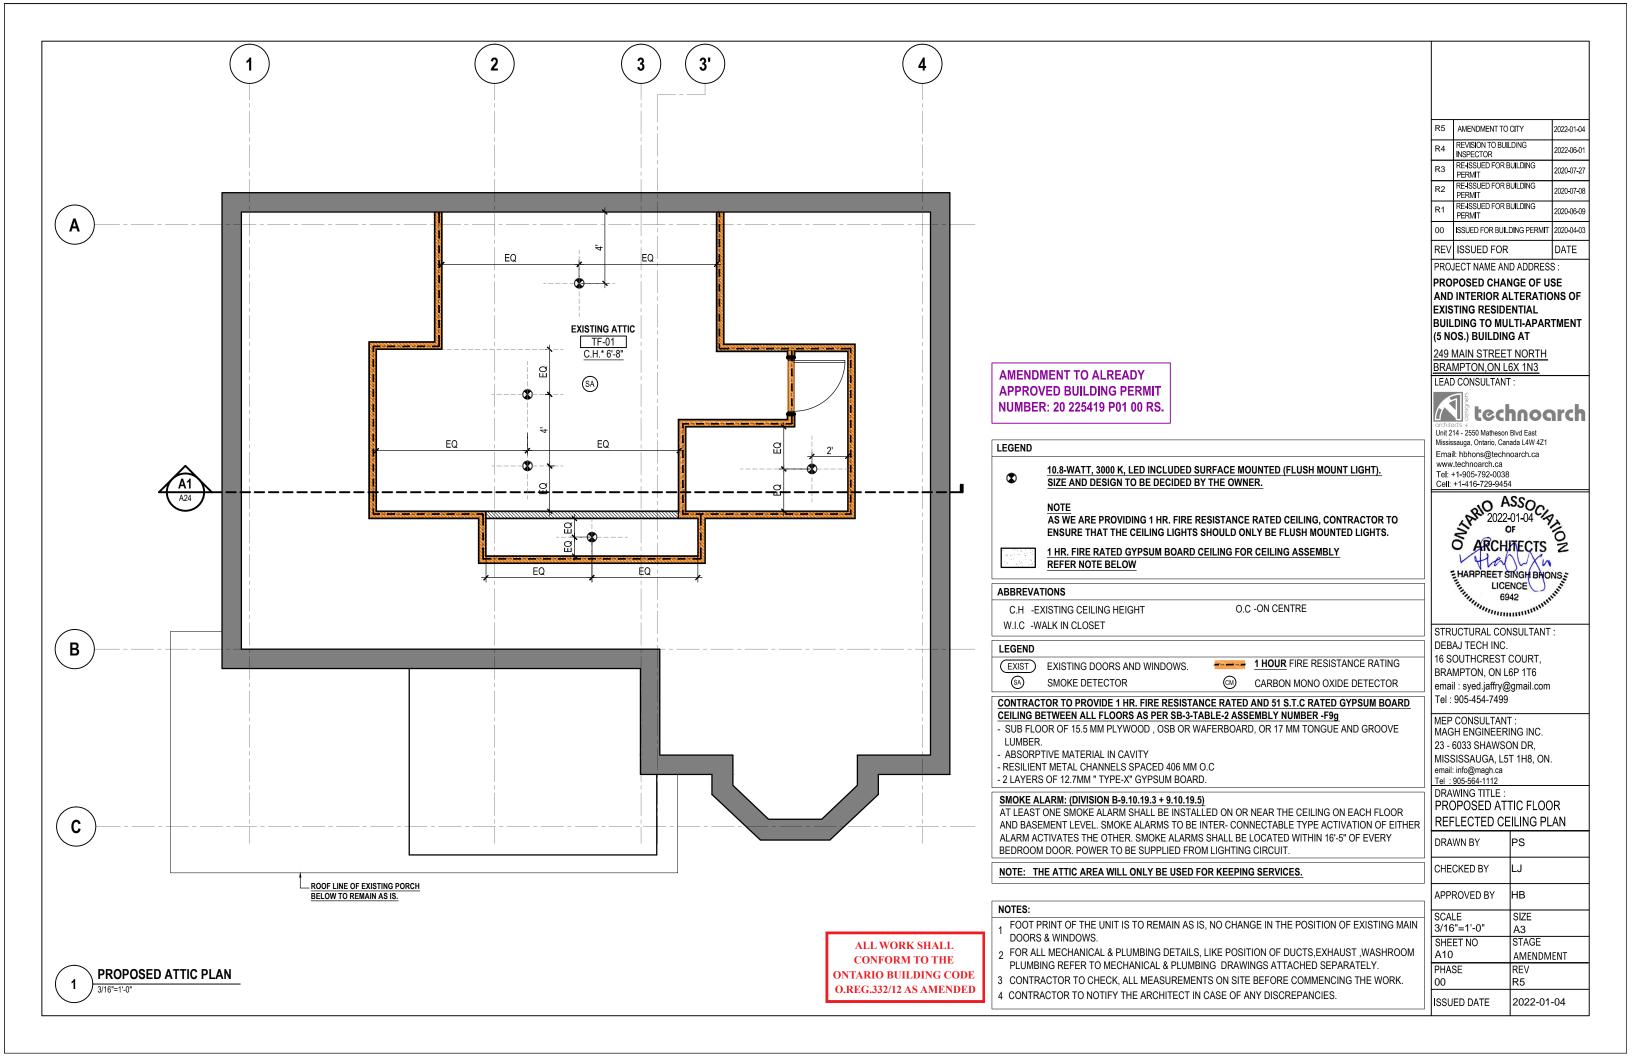

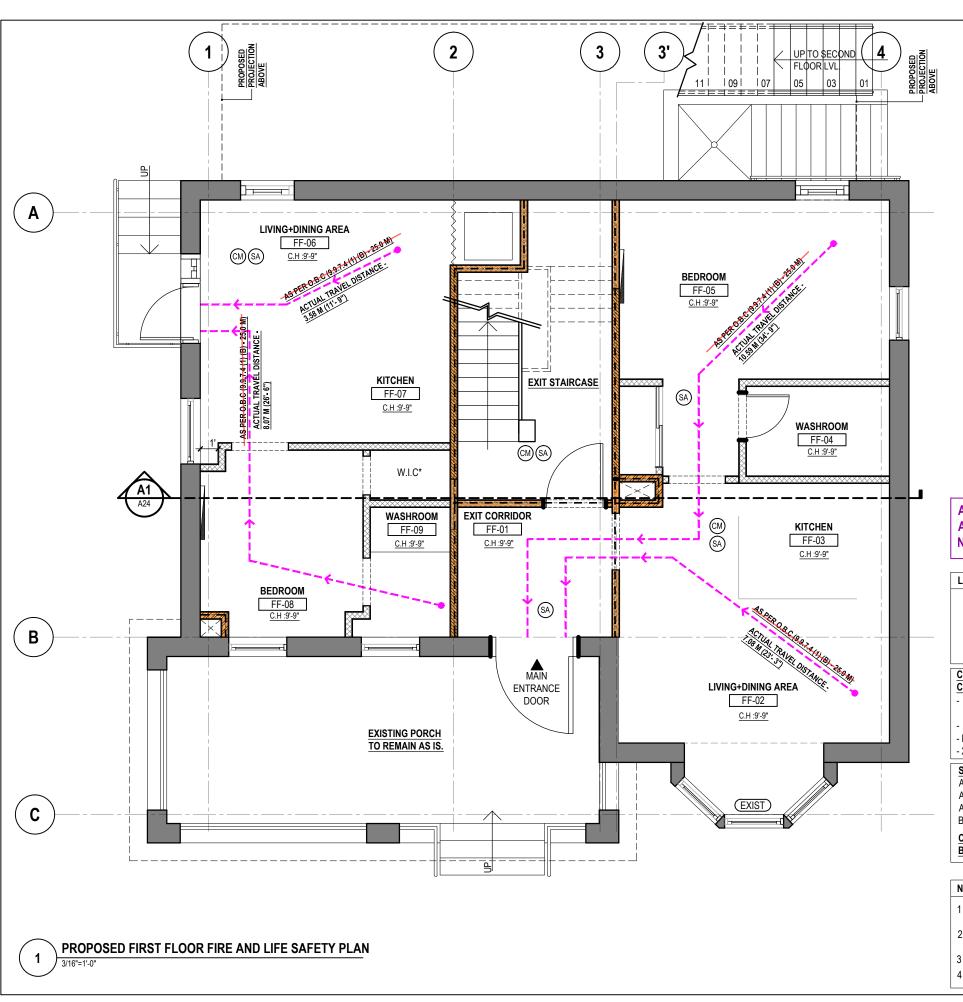

### LEGEND

INDICATES EMERGENCY EXIT SIGNS & EMERGENCY LIGHTING TO CONFORM TO O.B.C DIV B 9.9.12.3 PROVIDE ACCORDING TO BYLAW EMERGENCY LIGHTS MUST COMPLY WITH MUNICIPAL REGULATIONS. MASONRY BLOCKS

EXISTING FLOOR DRAIN SMOKE DETECTOR CARBON MONO OXIDE DETECTOR 1 HOUR FIRE RESISTANCE RATING

CONTRACTOR TO PROVIDE 1 HR. FIRE RESISTANCE RATED AND 51 S.T.C RATED GYPSUM BOARD CEILING BETWEEN ALL FLOORS AS PER SB-3-TABLE-2 ASSEMBLY NUMBER -F9g · SUB FLOOR OF 15.5 MM PLYWOOD , OSB OR WAFERBOARD, OR 17 MM TONGUE AND GROOVE

- LUMBER.
- ABSORPTIVE MATERIAL IN CAVITY
- RESILIENT METAL CHANNELS SPACED 406 MM O.C - 2 LAYERS OF 12.7MM " TYPE-X" GYPSUM BOARD.

## SMOKE ALARM: (DIVISION B-9.10.19.3 + 9.10.19.5)

AT LEAST ONE SMOKE ALARM SHALL BE INSTALLED ON OR NEAR THE CEILING ON EACH FLOOR AND BASEMENT LEVEL. SMOKE ALARMS TO BE INTER- CONNECTABLE TYPE ACTIVATION OF EITHER ALARM ACTIVATES THE OTHER. SMOKE ALARMS SHALL BE LOCATED WITHIN 16'-5" OF EVERY BEDROOM DOOR. POWER TO BE SUPPLIED FROM LIGHTING CIRCUIT.

CONTRACTOR TO ENSURE THAT EXISTING ELECTRICAL PANEL SHOULD BE COVERED WITH WOODEN SHUTTERS.

## NOTES:

- FOOT PRINT OF THE UNIT IS TO REMAIN AS IS, NO CHANGE IN THE POSITION OF EXISTING MAIN

R5 AMENDMENT TO CITY 2022-01-04 REVISION TO BUILDING 2022-06-01 2020-07-27 PERMIT RE-ISSUED FOR BUILDING 020-07-08 PERMIT RE-ISSUED FOR BUILDING PERMIT ISSUED FOR BUILDING PERMIT 020-04-03 REV ISSUED FOR DATE

PROJECT NAME AND ADDRESS

PROPOSED CHANGE OF USE AND INTERIOR ALTERATIONS OF **EXISTING RESIDENTIAL** BUILDING TO MULTI-APARTMENT (5 NOS.) BUILDING AT

249 MAIN STREET NORTH BRAMPTON,ON L6X 1N3



LEAD CONSULTANT :

## technoarch

Mississauga, Ontario, Canada L4W 4Z1 Email: hbhons@technoarch.ca www.technoarch.ca Tel: +1-905-792-0038 Cell: +1-416-729-9454



STRUCTURAL CONSULTANT: DEBAJ TECH INC. 16 SOUTHCREST COURT, BRAMPTON, ON L6P 1T6 email: syed.jaffry@gmail.com Tel: 905-454-7499

MEP CONSULTANT: MAGH ENGINEERING INC. 23 - 6033 SHAWSON DR, MISSISSAUGA, L5T 1H8, ON. email: info@magh.ca Tel: 905-564-1112 DRAWING TITLE:


PROPOSED FIRST FLOOR FIRE AND LIFE SAFETY PLAN


DRAWN BY	PS
CHECKED BY	LJ
APPROVED BY	НВ
SCALE	SIZE
3/16"=1'-0"	A3
SHEET NO	STAGE
A12	AMENDMENT
PHASE	REV
00	R5
ISSUED DATE	2022-01-04

- DOORS & WINDOWS.
- 2 FOR ALL MECHANICAL & PLUMBING DETAILS, LIKE POSITION OF DUCTS, EXHAUST, WASHROOM PLUMBING REFER TO MECHANICAL & PLUMBING DRAWINGS ATTACHED SEPARATELY.

  3 CON RACTOR TO CHECK ALL MEASUREMENTS ON SITE BEFORE COMMENCING THE WORK.

  4 CON RACTOR TO NOTIFY THE ARCHITECT IN CASE OF ANY DISCREPANCIES.

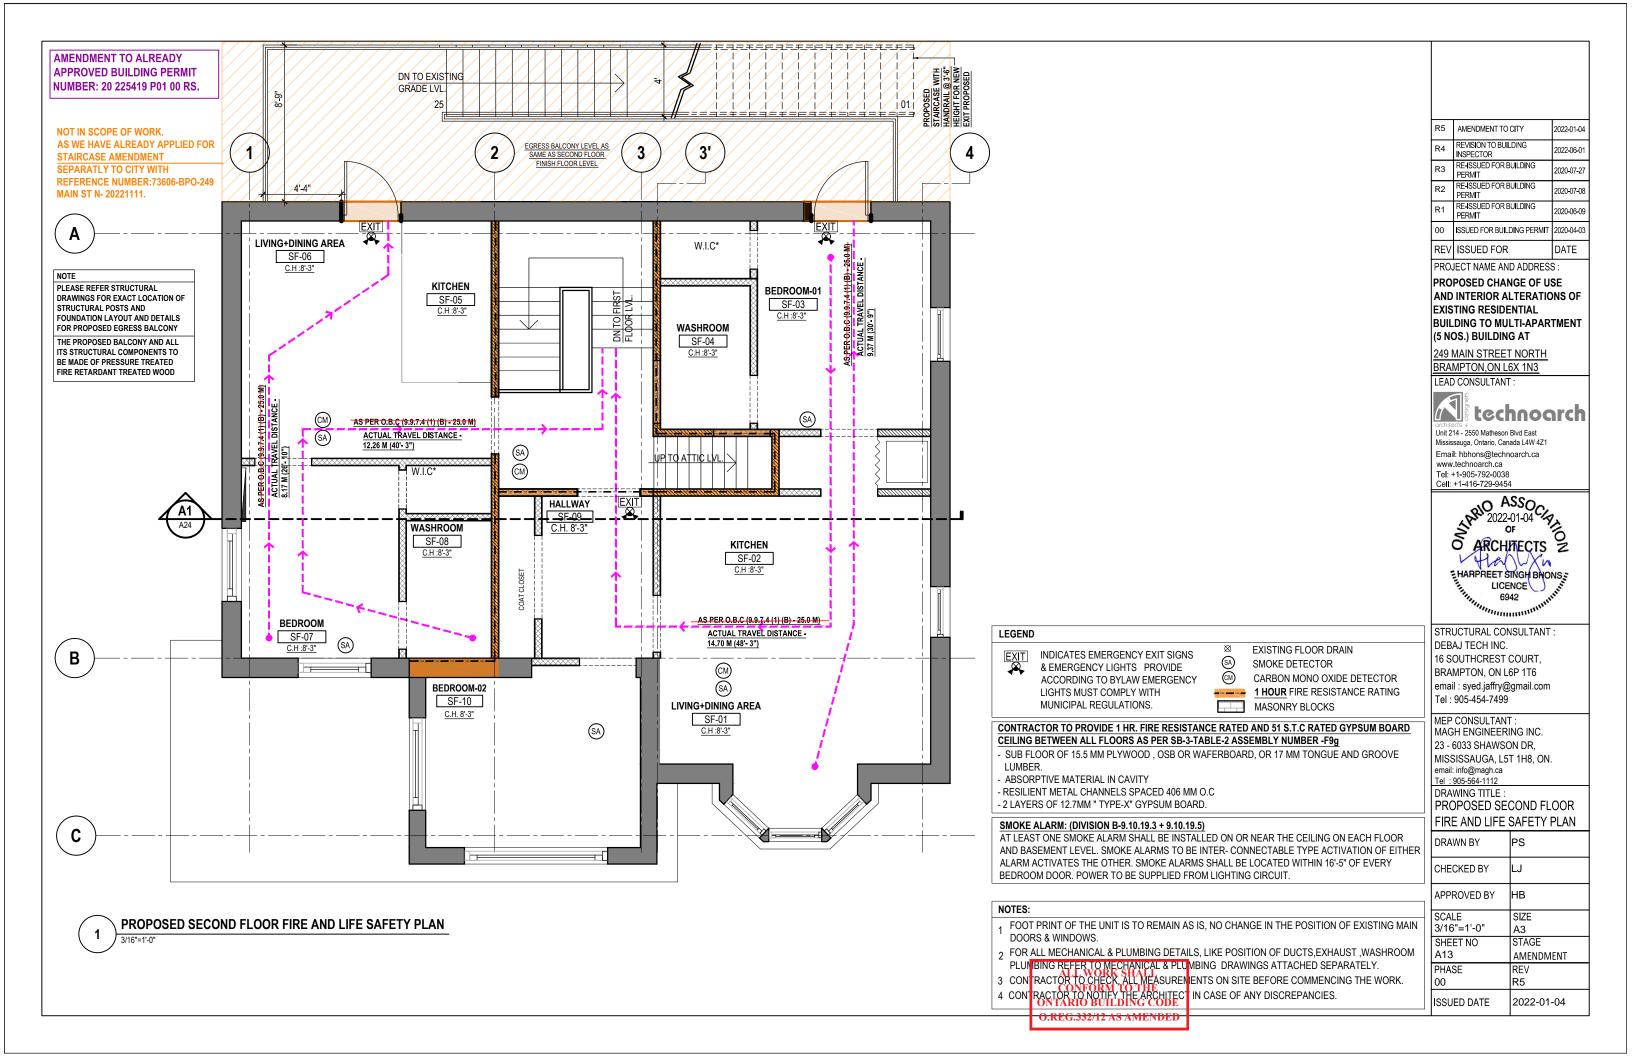

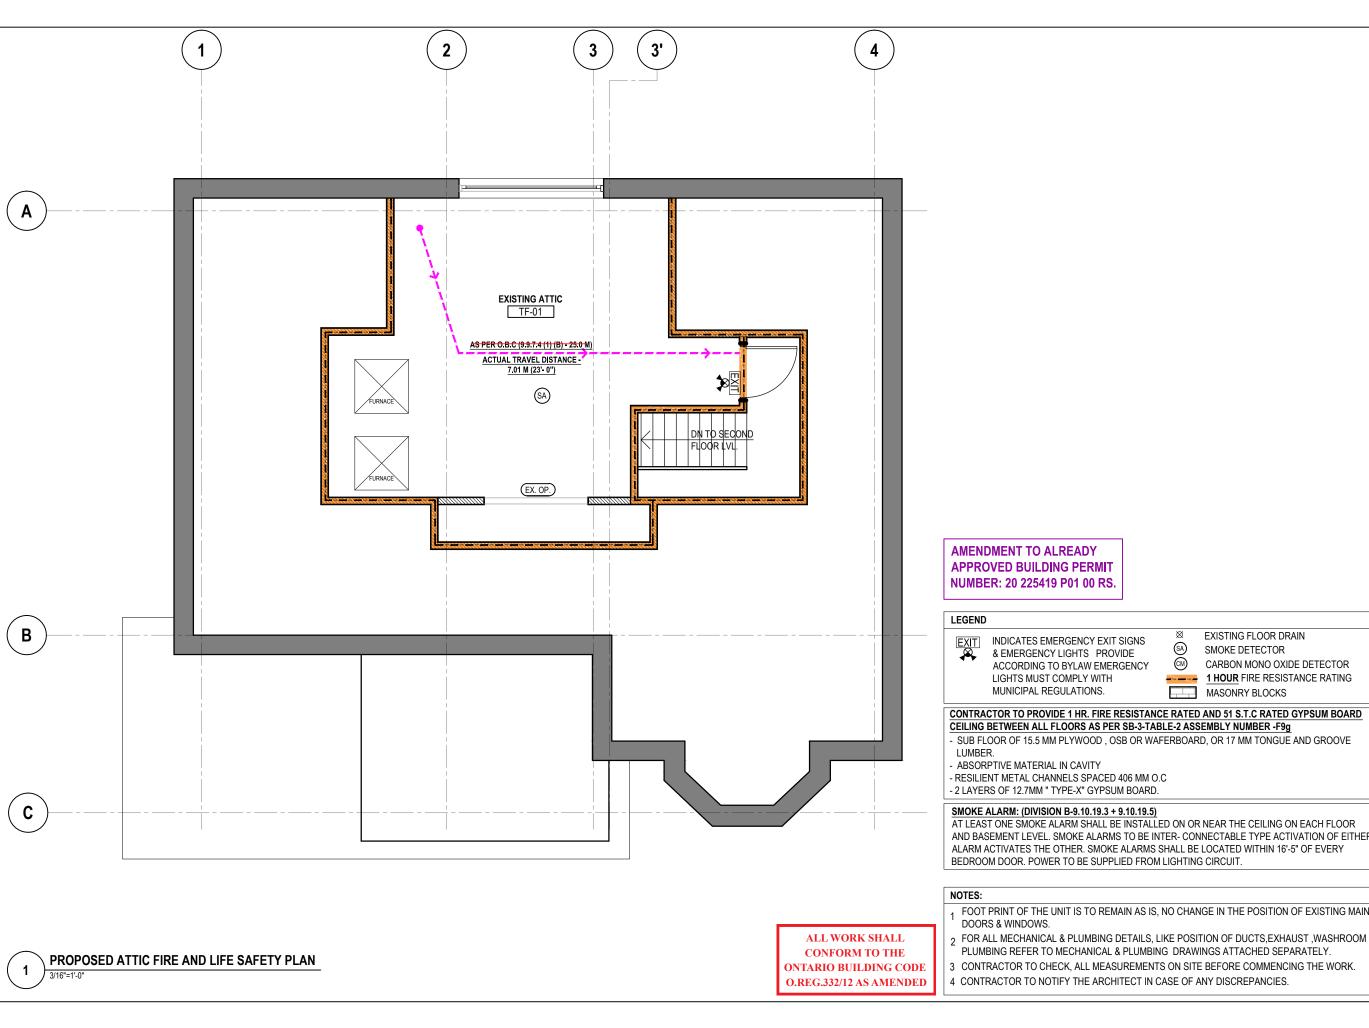

R5 | AMENDMENT TO CITY 2022-01-04 2022-06-01 2020-07-27 PERMIT RE-ISSUED FOR BUILDING R2 020-07-08 PERMIT RE-ISSUED FOR BUILDING PERMIT ISSUED FOR BUILDING PERMIT 020-04-03 REV ISSUED FOR DATE

PROJECT NAME AND ADDRESS

PROPOSED CHANGE OF USE AND INTERIOR ALTERATIONS OF **EXISTING RESIDENTIAL** BUILDING TO MULTI-APARTMENT (5 NOS.) BUILDING AT

249 MAIN STREET NORTH BRAMPTON,ON L6X 1N3





# technoarch

Mississauga, Ontario, Canada L4W 4Z1 Email: hbhons@technoarch.ca www.technoarch.ca Tel: +1-905-792-0038 Cell: +1-416-729-9454



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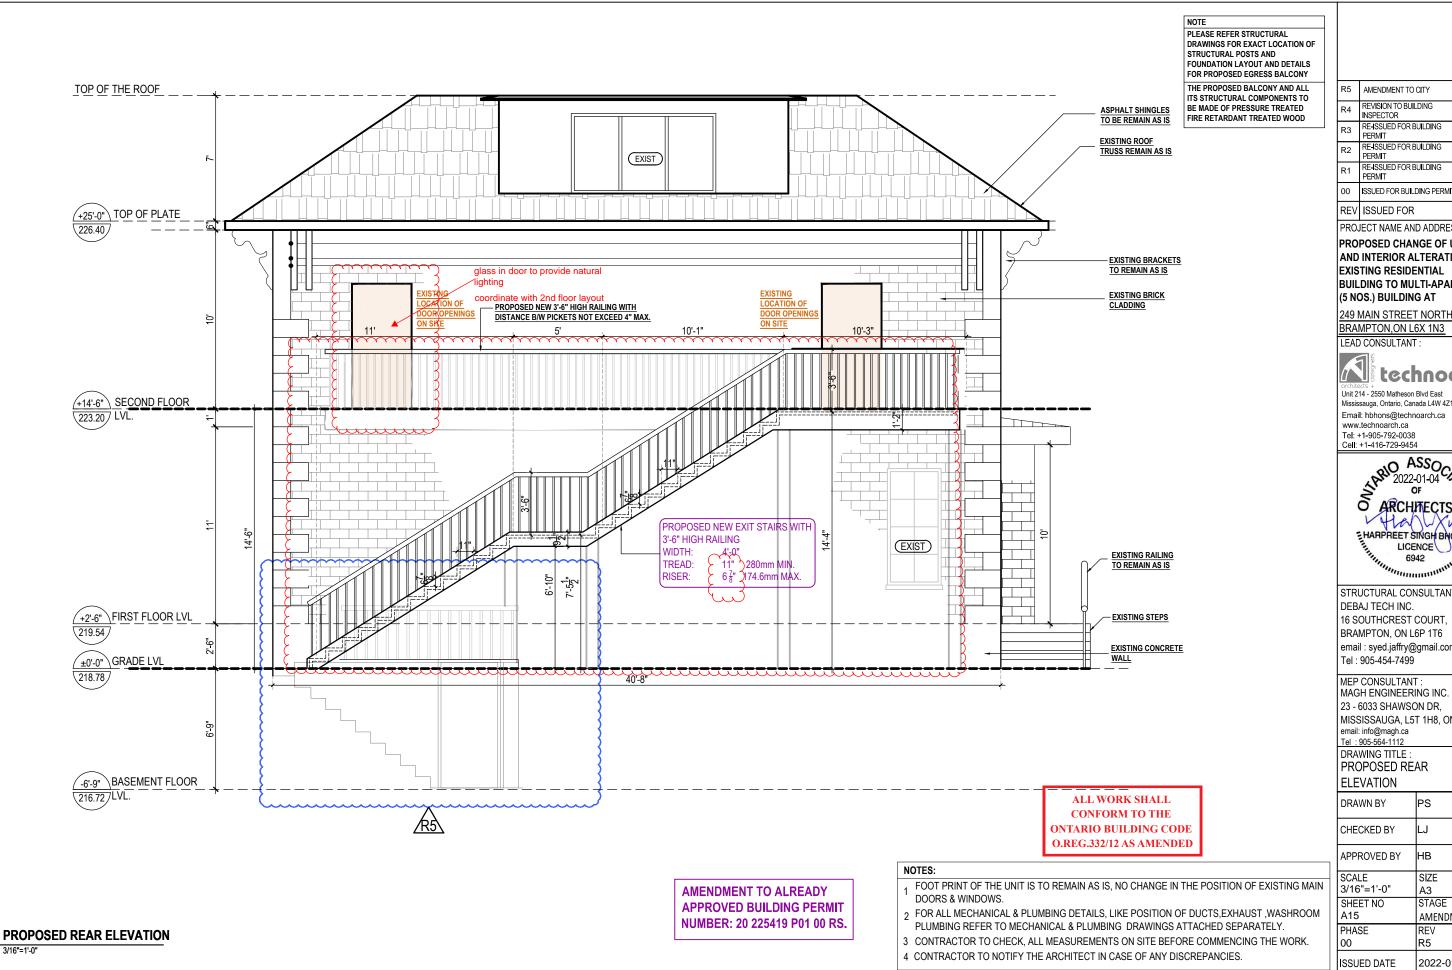
MEP CONSULTANT: MAGH ENGINEERING INC. 23 - 6033 SHAWSON DR, MISSISSAUGA, L5T 1H8, ON. email: info@magh.ca Tel: 905-564-1112 DRAWING TITLE:

PROPOSED ATTIC FLOOR FIRE AND LIFE SAFETY PLAN

DRAWN BY CHECKED BY APPROVED BY SIZE SCALE 3/16"=1'-0" STAGE SHEET NO A14 AMENDMENT PHASE REV 00 ISSUED DATE 2022-01-04

AT LEAST ONE SMOKE ALARM SHALL BE INSTALLED ON OR NEAR THE CEILING ON EACH FLOOR AND BASEMENT LEVEL. SMOKE ALARMS TO BE INTER-CONNECTABLE TYPE ACTIVATION OF EITHER ALARM ACTIVATES THE OTHER. SMOKE ALARMS SHALL BE LOCATED WITHIN 16'-5" OF EVERY

- FOOT PRINT OF THE UNIT IS TO REMAIN AS IS, NO CHANGE IN THE POSITION OF EXISTING MAIN



AMENDMENT TO CITY 2022-01-04 REVISION TO BUILDING INSPECTOR 2022-06-01 RE-ISSUED FOR BUILDING 2020-07-27 PERMIT RE-ISSUED FOR BUILDING PERMIT 020-07-08 RE-ISSUED FOR BUILDING PERMIT ISSUED FOR BUILDING PERMIT 020-04-03 REV ISSUED FOR DATE

PROJECT NAME AND ADDRESS

PROPOSED CHANGE OF USE AND INTERIOR ALTERATIONS OF **EXISTING RESIDENTIAL** BUILDING TO MULTI-APARTMENT (5 NOS.) BUILDING AT

249 MAIN STREET NORTH BRAMPTON,ON L6X 1N3



## technoarch


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23 - 6033 SHAWSON DR, MISSISSAUGA, L5T 1H8, ON. email: info@magh.ca Tel: 905-564-1112 DRAWING TITLE : PROPOSED REAR

DRAWN BY	PS
CHECKED BY	LJ
APPROVED BY	НВ
SCALE	SIZE
3/16"=1'-0"	A3
SHEET NO	STAGE
A15	AMENDMENT
PHASE	REV
00	R5
ISSUED DATE	2022-01-04



#### **WALL TYPES**

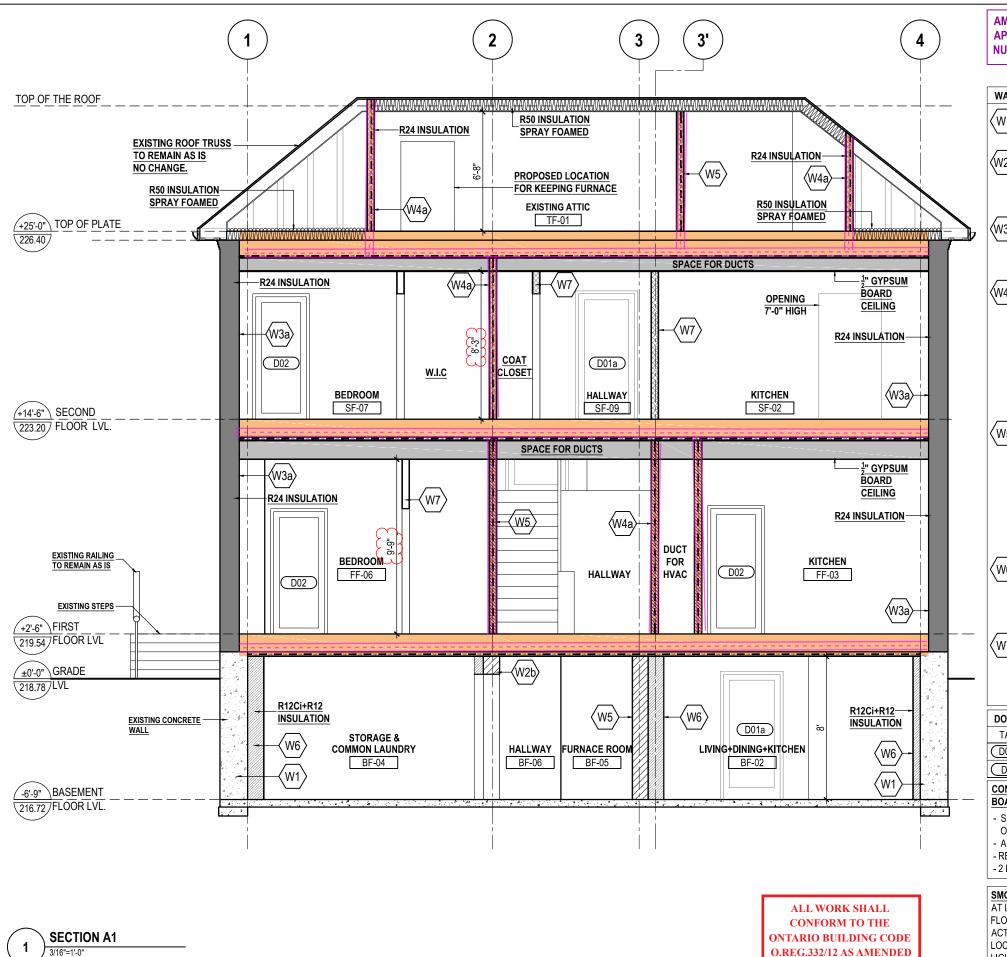

EXISTING CONCRETE WALL TO REMAIN AS IS.



#### EXISTING INTERIOR PARTITION WALL TO BE FINISHED.

EXISTING WOODEN STUDS (2" X 8") SPACED AT 406 MM TO BE FINISHED WITH 1/2" THICK GYPSUM BOARD FIXED ON BOTH SIDES, JOINTS TAPED AND SEALED AND FINISHED WITH TILES OR PAINT AS PER OWNER'S CHOICE OF COLOR.



### EXISTING EXTERIOR WALL TO BE UPGRADED

EXISTING EXTERIOR WALL HAVING 2"X6" WOODEN STUDS @16" O.C TO BE UPGRADED WITH R24 MINERAL FIBER INSULATION, APPLICATION OF 6 MIL POLY VAPOR BARRIER TO WARM SIDE WALL FRAMING AND 1/2" THICK GYPSUM BOARD FINISH FROM INTERIOR SIDE.



#### EXISTING INTERIOR PARTITION WALL TO BE UPGRADED TO HAVE 1 HR. FIRE RESISTANCE RATING AND 51 S.T.C RATING, FINISHED WITH PAINT AS PER OWNER'S CHOICE OF COLOR

(AS PER SB-3 -SECTION 1-TABLE 1- WALL NO. W4a) EXISTING WOODEN STUDS (2" X 8") SPACED AT 406 MM TO BE FINISHED

- 89 MM THICK ABSORPTIVE MATERIAL
- RESILIENT METAL CHANNELS ON ONE SIDE SPACED AT 406MM TO 610 MM
- 2 LAYERS OF 15.9 MM THICK "TYPE X" GYPSUM BOARD.
- 1 LAYER OF 15.9 MM THICK "TYPE X" GYPSUM BOARD.





PROPOSED 1 HR. FIRE RESISTANCE RATED AND 51 S.T.C RATED (W5) INTERIOR PARTITION WALL, FINISHED WITH PAINT AS PER OWNER'S CHOICE OF COLOR.

### (AS PER SB-3 -SECTION 1-TABLE 1- WALL NO. W4a)

- 38MM X 89 MM WOOD STUDS SPACED 406 MM OR 610 MM O.C.\*
- 89 MM THICK ABSORPTIVE MATERIAL.
- RESILIENT METAL CHANNELS ON ONE SIDE SPACED AT 406MM TO 610
- 2 LAYERS OF 15.9 MM THICK "TYPE X" GYPSUM BOARD.
- 1 LAYER OF 15.9 MM THICK "TYPE X" GYPSUM BOARD.





PROPOSED INTERIOR GYPSUM BOARD WALL WITH INSULATION. 2"X4" WOODEN STUDS @ 24" O.C FIXED AWAY FROM EXISTING CONCRETE WALL, R12 Ci BATT INSULATION FILLED IN BETWEEN CONCRETE WALL AND STUDS, R12 BATT INSULATION FILLED IN BETWEEN STUDS. FINISHED WITH 1/2" THICK WATER RESISTANT GYPSUM BOARD ON INNER SIDE ONLY.





#### PROPOSED INTERIOR PARTITION WALL WITH INSULATION

1/2" THICK GYPSUM BOARD FROM FINISH FLOOR LEVEL TILL PROPOSED CEILING LEVEL ON BOTH SIDES OF 3-5/8" STEEL STUDS @ 16" O.C WITH SOUND PROOF INSULATION, PAINT FINISH TO BE SELECTED AS PER OWNER'S CHOICE OF COLOR.

DOORS / WINDOWS SCHEDULE				* ALL DOOR SIZES ARE LEAF SIZES ONLY.		
TAG	WIDTH*	HEIGHT*	LINTEL	QUANTITY	FIRE RATED	REMARKS
D01a	40"	84"	84"	1	YES (45 MIN)	METAL DOOR
D02	36"	84"	84"	2	NO	HOLLOW CORE FIBRE DOOR

#### CONTRACTOR TO PROVIDE 1 HR. FIRE RESISTANCE RATED AND 51 S.T.C RATED GYPSUM BOARD CEILING BETWEEN ALL FLOORS AS PER SB-3-TABLE-2 ASSEMBLY NUMBER -F9g

- SUB FLOOR OF 15.5 MM PLYWOOD, OSB OR WAFERBOARD, OR 17 MM TONGUE AND GROOVE LUMBER.
- ABSORPTIVE MATERIAL IN CAVITY
- RESILIENT METAL CHANNELS SPACED 406 MM O.C
- 2 LAYERS OF 12.7MM " TYPE-X" GYPSUM BOARD.

#### **SMOKE ALARM: (DIVISION B-9.10.19.3 + 9.10.19.5)**

AT LEAST ONE SMOKE ALARM SHALL BE INSTALLED ON OR NEAR THE CEILING ON EACH FLOOR AND BASEMENT LEVEL. SMOKE ALARMS TO BE INTER- CONNECTABLE TYPE ACTIVATION OF EITHER ALARM ACTIVATES THE OTHER. SMOKE ALARMS SHALL BE LOCATED WITHIN 16'-5" OF EVERY BEDROOM DOOR. POWER TO BE SUPPLIED FROM LIGHTING CIRCUIT

AMENDMENT TO CITY	2022-01-04
REVISION TO BUILDING INSPECTOR	2022-06-01
RE-ISSUED FOR BUILDING PERMIT	2020-07-27
RE-ISSUED FOR BUILDING PERMIT	2020-07-08
RE-ISSUED FOR BUILDING PERMIT	2020-06-09
ISSUED FOR BUILDING PERMIT	2020-04-03
ISSUED FOR	DATE
	REVISION TO BUILDING INSPECTOR RE-ISSUED FOR BUILDING PERMIT RE-ISSUED FOR BUILDING PERMIT RE-ISSUED FOR BUILDING PERMIT ISSUED FOR BUILDING PERMIT

PROJECT NAME AND ADDRESS

PROPOSED CHANGE OF USE AND INTERIOR ALTERATIONS OF **EXISTING RESIDENTIAL** BUILDING TO MULTI-APARTMENT (5 NOS.) BUILDING AT

249 MAIN STREET NORTH BRAMPTON,ON L6X 1N3 LEAD CONSULTANT



# technoarch

Mississauga, Ontario, Canada L4W 4Z1 Email: hbhons@technoarch.ca www.technoarch.ca Tel: +1-905-792-0038 Cell: +1-416-729-9454



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MEP CONSULTANT: MAGH ENGINEERING INC. 23 - 6033 SHAWSON DR, MISSISSAUGA, L5T 1H8, ON. email: info@magh.ca Tel: 905-564-1112 DRAWING TITLE: SECTION A1

ENT
04