

Public Notice

Committee of Adjustment
APPLICATION # A-2023-0104
WARD #6

APPLICATION FOR MINOR VARIANCE

WHEREAS an application for minor variance has been made by **FARZANA BAGAM** under Section 45 of the <u>Planning Act</u>, (R.S.O. 1990 c.P.13) for relief from **By-law 270-2004**;

AND WHEREAS the property involved in this application is described as Lot 7, Plan 43M-2074 municipally known as **72 CIRCUS CRESCENT**, Brampton;

AND WHEREAS the applicant is requesting the following variance(s):

- To permit an exterior stairway leading to a proposed below grade entrance in the required interior side yard whereas the by-law does not permit exterior stairways constructed below established grade in the required interior side yard;
- 2. To permit a 0.12m (0.40 ft) side yard setback to an exterior stairway leading to a below grade entrance in the required interior side yard, with a combined side yard setback of 0.76m (2.50 ft), whereas the by-law requires a minimum side yard setback of 1.2m (3.94 ft.) on one side and 0.6m (1.97 ft) on the other side provided that the combined total for both interior lots is 1.8m (5.91 ft.).

OTHER PLANNING APPLICATIONS:

| Plan of Subdivision: Application for Consent: | NO NO | File Number: | |
|--|----------|--|---|
| • | • • • | SDAY, May 9, 2023 at 9:00 A.M. by electronic meeting | _ |

The land which is subject of this application is the subject of an application under the Planning Act for:

purpose of hearing all parties interested in supporting or opposing these applications.

This notice is sent to you because you are either the applicant, a representative/agent of the applicant, a person having an interest in the property or an owner of a neighbouring property. OWNERS ARE REQUESTED TO ENSURE THAT THEIR TENANTS ARE NOTIFIED OF THIS APPLICATION. THIS NOTICE IS TO BE POSTED BY THE OWNER OF ANY LAND THAT CONTAINS SEVEN OR MORE RESIDENTIAL UNITS IN A LOCATION THAT IS VISIBLE TO ALL OF THE RESIDENTS. If you are not the applicant and you do not participate in the hearing, the Committee may proceed in your absence, and you will not be entitled to any further notice in the proceedings. WRITTEN SUBMISSIONS MAY BE SENT TO THE SECRETARY-TREASURER AT

IF YOU WISH TO BE NOTIFIED OF THE DECISION OF THE COMMITTEE OF ADJUSTMENT IN RESPECT OF THIS APPLICATION, YOU MUST SUBMIT A WRITTEN REQUEST TO THE COMMITTEE OF ADJUSTMENT. This will also entitle you to be advised of an Ontario Land Tribunal hearing. Even if you are the successful party, you should request a copy of the decision since the Committee of Adjustment decision may be appealed to the Ontario Land Tribunal by the applicant, the Minister, a specified person or a public body.

RULES OF PROCEDURE OF THIS COMMITTEE REQUIRE REPRESENTATION OF THE APPLICATION AT THE HEARING, OTHERWISE THE APPLICATION SHALL BE DEFERRED.

PLEASE SEE ATTACHED PARTICIPATION PROCEDURES REQUIRED DURING THE COVID-19 PANDEMIC


DATED at Brampton Ontario, this this 27th Day of April, 2023.

THE ADDRESS OR FAX NUMBER LISTED BELOW.

Comments may be sent to and more information about this matter may be obtained between 8:30 a.m. to 4:30 p.m. Monday - Friday from:

Jeanie Myers, Secretary-Treasurer Committee of Adjustment, City Clerk's Office, Brampton City Hall, 2 Wellington Street West, Brampton, Ontario L6Y 4R2 Phone: (905)874-2117 Fax: (905)874-2119

jeanie.myers@brampton.ca

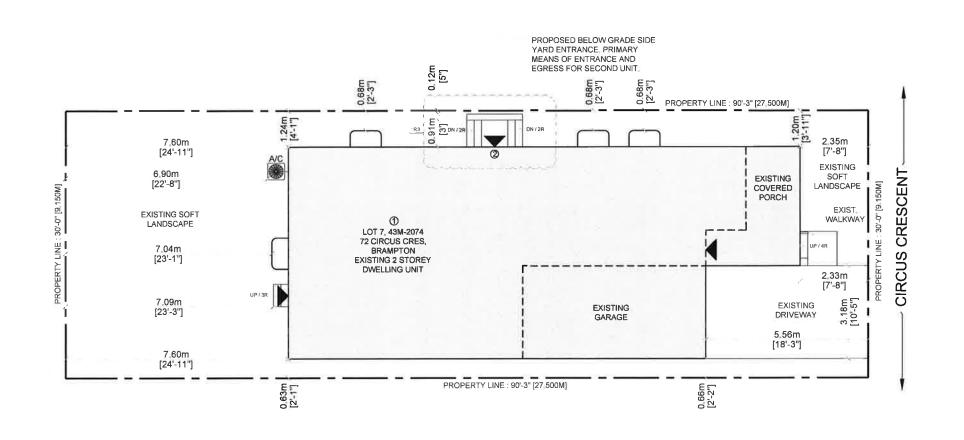



SITE PLAN SCALE : 1/8" = 1'-0"

LEGEND



PROPERTY LINE

ENTRANCE & EGRESS

PARKING SPACES PROVIDED

TWO PARKING SPACES PROVIDED (ONE OUTSIDE & ONE INSIDE THE GARAGE)

AREA STATISTICS

GROSS FLOOR AREA CALCULATIONS A - EXISTING PRINCIPAL RESIDENCE EXISTING MAIN FLOOR AREA GARAGE AREA EXISTING SECOND FLOOR AREA TOTAL ABOVE GRADE GFA B - EXISTING BASEMENT BASEMENT AREA PART OF PRICIPAL RESIDENCE = 00.00 SFT / 00.00 SM

NEW BASEMENT APARTMENT GFA FURNACE AREA TOTAL BASEMENT GFA BASEMENT APARTMENT GFA IS 37 29 % OF PRINCIPAL RESIDENCE GFA

TOTAL LOT AREA: 2708 SFT / 251.67 SM

- = 935,77 SFT / 86,96 SM = 214,40 SFT / 19,92 SM
- = 1152.22 SFT / 107.08 SM = 2,303.4 SFT / 214.07 SM
- = 880 SFT / 81,78 SM = 55.80 SFT / 5.18 SM

= 935.77 SFT / 86.96 SM

SCOPE OF WORK

- BASEMENT APARTMENT
- ② PROPOSED BELOW GRADE SIDE YARD ENTRANCE, PRIMARY MEANS OF ENTRANCE AND EGRESS FOR SECOND UNIT

SITE LOCATION

72 CIRCUS CRES,

BRAMPTON



CONTRACTOR SHALL SITE VEREY ALL DIMENSIONS AND REPORT DESCRIPANCES (F ANY) TO THE CONSULTANTS BEFORE CONSTRUCTION ALL DRAWNOS AND SPECIFICATIONS ARE THE PROPERTY OF CONSULTANTS AND BUST BE RETURNED AT THE

COPYRIGHT RESERVED

| NO | DATE | REVISION / ISSUED |
|----|--------------|--------------------|
| - | 300 0 36 | AD-DIANG LAHINT |
| = | BDDDM | PERSONALISM |
| ** | PU2501-11 | EXECUTATION |
| 17 | JR25-03.35 | chricowests |
| | minute. | PERSONAL PROVIDERS |



FARZANA BAGAM

ARCHITECT

10368 WINSTON CHURCHILL BLVD, HALTON HILLS ON L7G 4S7 c: 647.741.5917, e: info@c-archi.com



ALTERATIONS (SU)

72 CIRCUS CRES, BRAMPTON

SITE PLAN

1/8" = 1'-0" 2023.01.11

DATE: PROJECT:

22-176

DRAWING NO:



Under the authority of the Emergency *Management and Civil Protection Act* and the *Municipal Act, 2001*, City Council approved Committee Meetings to be held electronically and/or as a hybrid meeting (both inperson and electronically).

Electronic/Hybrid Hearing Procedures How to get involved in the Hybrid Hearing

As the pandemic has waned, Brampton City Hall is currently lifting in-person attendance restrictions due to the COVID pandemic. In-person attendance at Committee of Adjustment Hearings is now available at this time, along with a virtual participation option. Brampton City Council and its Committees will continue to meet electronically and in-person. For the **May 9, 2023** hearing, the Committee of Adjustment will conduct its meeting with concurrent electronic and in-person attendance.

How to Participate in the Hearing:

All written comments (by mail or email) must be received by the Secretary-Treasurer no later than **4:30 pm, Thursday, May 4, 2023.**

- Advance registration for applicants, agents and other interested persons is required by one or two options:
- Participate remotely in the electronic hearing using a computer, smartphone or tablet by emailing the Secretary-Treasurer at <u>cityclerksoffice@brampton.ca</u> or <u>jeanie.myers@brampton.ca</u> by 4:30 pm Thursday, May 4, 2023.
- 2. To participate in-person, please email the Secretary–Treasurer at <u>cityclerksoffice@brampton.ca</u> or <u>jeanie.myers@brampton.ca</u> by **4:30 pm Thursday, May 4, 2023.**
- Persons without access to a computer, smartphone or tablet can participate in a meeting via telephone or inperson. You can register by calling 905-874-2117 and leave a message with your name, phone number and
 the application you wish to speak to by **Thursday, May 4, 2023.** City staff will contact you and provide you
 with further details.

You will be contacted by the City Clerk's Office before the hearing date to confirm your attendance. Confirmation of in-person attendance will be subject to any in-person capacity limits that may be in place for Council Chambers at City Hall and prevailing public health orders and guidance.

 All Hearings will be livestreamed on the City of Brampton YouTube account at: https://www.brampton.ca/EN/City-Hall/meetings-agendas/Pages/Welcome.aspx or http://video.isilive.ca/brampton/live.html .

If holding an electronic/hybrid rather than an oral hearing is likely to cause a party significant prejudice a written request may be made to have the Committee consider holding an oral hearing on an application at some future date. The request must include your name, address, contact information, and the reasons for prejudice and must be received no later than 4:30 pm the Friday prior to the hearing to cityclerksoffice@brampton.ca or jeanie.myers@brampton.ca. If a party does not submit a request and does not participate in the hearing, the Committee may proceed without a party's participation and the party will not be entitled to any further notice regarding the proceeding.

NOTE Personal information as defined in the *Municipal Freedom of Information and Protection of Privacy Act* (*MFIPPA*), collected and recorded or submitted in writing or electronically as related to this planning application is collected under the authority of the *Planning Act*, and will be used by members of the Committee and City of Brampton staff in their review of this matter. Please be advised that your submissions will be part of the public record and will be made available to the public, including posting on the City's website, www.brampton.ca. By providing your information, you acknowledge that all personal information such as the telephone numbers, email addresses and signatures of individuals will be redacted by the Secretary-Treasurer on the on-line posting only. Questions regarding the collection, use and disclosure of personal information may be directed to the Secretary-Treasurer at 905-874-2117.

Flower City



For Office Use Only (to be inserted by the Secretary-Treasurer after application is deemed complete)

FILE NUMBER: A- 2023-0104

The Personal Information collected on this form is collected pursuant to section 45 of the Planning Act and will be used in the processing of this application. Applicants are advised that the Committee of Adjustment is a public process and the information contained in the Committee of Adjustment files is considered public information and is available to anyone upon request and will be published on the City's website. Questions about the collection of personal information should be directed to the Secretary-Treasurer, Committee of Adjustment, City of Brampton.

APPLICATION Minor Variance or Special Permission

(Please read Instructions)

NOTE: It is required that this application be filed with the Secretary-Treasurer of the Committee of Adjustment and be accompanied by the applicable fee.

The undersigned hereby applies to the Committee of Adjustment for the City of Brampton under section 45 of the <u>Planning Act</u>, 1990, for relief as described in this application from By-Law **270-2004**.

| _ | | A L FIRTUIA PLOM |
|----------|---|---|
| I. | Name of (| Owner(s) FARZANA BAGAM 72 CIRCUS CRES, BRAMPTON, ON L7A 0H1 |
| | Address | 12 CIRCUS CRES, BRAINF FON, ON LIA OFF |
| | | |
| | Phone # | 416.830.8457 Fax # |
| | Email | mortgagewithmustafa@outlook.com |
| | | |
| | | |
| 2. | Name of | |
| | Address | 10368 WINSTON CHURCHILL BLVD, HALTON HILLS ON L7G 4S7 |
| | | |
| | | |
| | Phone # | 647,741,5917 Fax # |
| | Email | arshad@c-archi com |
| | | |
| | N-4 | and automated relief annited for (variances requested): |
| • | | nd extent of relief applied for (variances requested): |
| | MINOR | VARIANCE REQUEST IN REQUIRED SETBACK FOR PROPOSED BELOW |
| | | STAIRS AS PRIMARY MEANS OF ENTRANCE AND EXIT FOR PROPSOED |
| | SECON | ID UNIT |
| | | |
| | REQUIF | RED SETBACK IS 0.3M PER ZONING BY-LAW. PROPOSED SETBACK OF 0.12 |
| | REQUIP | RES MINOR VARIANCE APPROVAL OF 0.18M. |
| | ,,,,,,,,,,,,,,,,,,,,,,,,,,,,,,,,,,,,,,, | |
| | | |
| | | |
| | | |
| | Why is it | not possible to comply with the provisions of the by-law? |
| | | NG SIDEYARD ENTRANCE REQUIRED BELOW GRADE STEPS DUE TO SITE |
| | CONDI | |
| | CONDI | |
| | 1 | |
| | 1 | |
| | | |
| | | |
| | | |
| j. | | escription of the subject land: |
| | Lot Num | |
| | | mber/Concession Number PLAN 43M-2074 |
| | Municipa | al Address 72 CIRCUS CRES, BRAMPTON, ON L7A 0H1 |
| | | |
| | Dimon- | ion of publicat land (in metric units) |
| . | | ion of subject land (<u>in metric units</u>) |
| | Frontage | 9,150 M 27,50 M |
| | Depth | 251.67 SM |
| | Area | ZOTION OIL |
| | | |
| | Accoss | to the subject land is by: |
| | | ial Highway |
| | | al Road Maintained All Year Other Public Road |
| | | Right-of-Way Water |
| | riivale | Night-of-way — |
| | | |

8.

Particulars of all buildings and structures on or proposed for the subject

| | | | the subject land: List all structures (dwelling, shed, gazebo, etc.) |
|--------|--------------------------------------|----------------------------|--|
| | MAIN RESIDENT | IAL BUILDING : 21 | 14.07 SM GFA |
| | | | |
| 7 | | | |
| | | | |
| | | | |
| | | | d |
| | PROPOSED BUILDIN | NGS/STRUCTURES C | on the subject land: |
| | NA | | |
| | | | |
| | | | |
| | | | |
| | | | |
| | | | |
| 9. | Location of all | huildings and s | tructures on or proposed for the subject lands: |
| •. | | | |
| | (specify distance | e from side, rea | ar and front lot lines in <u>metric units</u>) |
| | | | |
| | EXISTING | 0.0014 | |
| | Front yard setback Rear yard setback | 6.63 M 15.53 M | |
| | Side yard setback | 1,48 M | |
| | Side yard setback | 4,24 M | |
| | 0.20 ya. a. 00.2 |) | |
| | PROPOSED | | |
| | Front yard setback | 2,35 M | |
| | Rear yard setback | 7,60 M | |
| | Side yard setback | 0.00 M | |
| | Side yard setback | 1.24 M | |
| | | | |
| 10. | Date of Acquisition | of subject land: | 2022 |
| | | | |
| | | | RESIDENTIAL |
| 11. | Existing uses of sul | oject property: | RESIDENTIAL |
| | | | |
| 12. | Proposed uses of s | ubject property: | RESIDENTIAL |
| | | | |
| | | | |
| 13. | Existing uses of ab | utting properties: | RESIDENTIAL |
| | | | |
| 14. | Date of construction | n of all buildings & s | tructures on subject land: 2022 |
| 1-7- | pate of contraction | o, a zanag. | |
| | | | |
| 15. | Length of time the | existing uses of the s | subject property have been continued: 2 YEARS |
| | | | |
| | 08 34 | | |
| 6. (a) | What water supply Municipal | is existing/proposed ⊂l | Other (specify) NA |
| | Well | ╡ | Outer (specify) |
| | **** | _ | |
| (b) | What sewage dispo | sal is/will be provide | ed? |
| ` ' | Municipal | <u> </u> | Other (specify) NA |
| | Septic | | |
| | - | | |
| | 10.00 | | /www.aaad2 |
| (c) | What storm drainage | ge system is existing | /proposed? |
| (c) | 10.00 | ge system is existing | y/proposed? Other (specify) NA |

| 17. Is the subject property the subdivision or consent? | ibject of an application under | r the Planning Act, for approval of a plan of |
|---|---|---|
| Yes No [| ✓ | |
| If answer is yes, provide deta | ils: File# NA | Status NA |
| 18. Has a pre-consultation applic | ation been filed? | |
| Yes No [| 7 | |
| 19. Has the subject property eve | r been the subject of an applic | cation for minor variance? |
| Yes No [| ✓ Unknown □ |] |
| If answer is yes, provide deta | ils: | |
| | ion NA | Relief NA Relief NA |
| | ion NA ion NA | Relief NA |
| | | -n./ |
| | | Tolud |
| | _ | ure of Applicant(s) or Authorized Agent |
| DATED AT THECTTY | _ OF _ BRAME | но т ч |
| THIS ITH DAY OF A | PRIL , 20 23 | |
| THE SUBJECT LANDS, WRITTEN AUTH | IORIZATION OF THE OWNER N, THE APPLICATION SHAL | NY PERSON OTHER THAN THE OWNER OF MUST ACCOMPANY THE APPLICATION. IF LL BE SIGNED BY AN OFFICER OF THE ED. |
| , M. ARSHAD SIDDIQUI | , OF THE | TOWN OF HALTON HILLS |
| IN THE REGION OF HALTON | SOLEMNLY DE | ECLARE THAT: |
| ALL OF THE ABOVE STATEMENTS AF BELIEVING IT TO BE TRUE AND KNOV OATH. | E TRUE AND I MAKE THIS S ING THAT IT IS OF THE SAM | SOLEMN DECLARATION CONSCIENTIOUSLY BE FORCE AND EFFECT AS IF MADE UNDEF |
| DECLARED BEFORE ME AT THE | | Jeanie Cecilia Myers a Commissioner, etc., |
| CITY OF BRAMPTON | | Province of Ontario for the Corporation of the |
| IN THE REGION OF | | City of Brampton Expires April 8, 2024. |
| IN THE REGION OF | | Markel |
| PEEL THIS 2ND DAY | OF | 9-9/ |
| APRIL , 20 23 | Carlo | ature of Applicant or Authorized Agent |
| 1. M. | Ors | Submit by Email |
| A Commissioner etc. | | |
| /() | | |
| | FOR OFFICE USE ONLY | |
| Present Official Plan Design | ation: | |
| Present Zoning By-law Clas | sification: | R1F-9-2888 |
| This application has been re said r | viewed with respect to the varian eview are outlined on the attach | nces required and the results of the ned checklist. |
| 1.111 | | April 3, 2023 |
| Zoning Office | | Date |
| | and the | 2023 |
| DATE RECEI Date Application Dee | VED | Revised 2022/02/17 |
| Complete by the Municip | | |

PART 2 (SURVEY REPORT) SURVEYOR'S REAL PROPERTY REPORT **NOTES** REGISTERED EASEMENTS AND/OR RIGHT-OF-WAYS: NONE DENOTES MONUMENT FOUND PART 1 DENOTES MONUMENT SET THIS PLAN DOES NOT CERTIFY COMPLIANCE WITH ZONING BY-LAWS PLAN OF LOTS 2, 3, 4, 5, DENOTES IRON BAR DENOTES PLASTIC BAR SURVEYOR'S CERTIFICATE 6, 7 AND 8 SSIB DENOTES SHORT STANDARD IRON BAR DENOTES PROPERTY IDENTIFIER NUMBER P.I.N. I CERTIFY THAT: PLAN 43M-2074 DENOTES WITNESS (WIT) 1. THIS SURVEY AND PLAN ARE CORRECT AND IN ACCORDANCE DENOTES PLAN 43M-2074 WITH THE SURVEYS ACT, THE SURVEYORS ACT AND THE LAND CITY OF BRAMPTON DENOTES DWELLING UNDER CONSTRUCTION D.U.C. TITLES ACT AND THE REGULATIONS MADE UNDER THEM. DENOTES PORCH IREGIONAL MUNICIPALITY OF PEEL DENOTES TOP OF WALL ELEVATION TOW 2. THE SURVEY WAS COMPLETED ON THE 24th DAY OF SEPTEMBER ,2019. SCALE 1: 300 ALL FOUND MONUMENTS BY SCHAEFFER DZALDOV DATE NOV. 8 , 2019. BENNETT LTD., O.L.S. ALL TIES TO CONCRETE FOUNDATIONS R-PE SURVEYING LTD., O.L.S. METRIC T. SINGH DISTANCES SHOWN ON THIS PLAN ARE IN METRES AND CAN BE CONVERTED TO FEET BY DIVIDING BY 0.3048. BEARINGS ARE GRID AND ARE REFERRED TO THE ONTARIO LAND SURVEYOR NORTHWEST LIMIT OF CIRCUS CRESCENT AS SHOWN ON PLAN 43M-2074 HAVING A BEARING OF N38'22'25"E. CALLANDAR ROAD 2022 43M PLAN (BY PLAN 43M-2022) P.I.N. 14251-4131 LOT 401 | LOT 402 LOT 403 LOT 398 | LOT 399 | LOT 400 | LOT 397 BLOCK 431 P.I.N. 14251-4094 P.I.N. 14251-4095 P.I.N. 14251-4096 P.I.N. 14251-4097 P.I.N. 14251-4098 P.I.N. 14251-4099 P.I.N. 14251-4099 (0.30 RESERVE) P.I.N. 14251-4127 P.I.N. 14251-4093 18 25" E 9.150 9.150 PLAMEAS 11.600 27.500 OT 6 $\underset{\scriptscriptstyle 7.0}{\text{LOT}}\,8$ LOT 7 LOT 4 LOT 5 LOT 3 **ASSOCIATION OF ONTARIO** LOT 2 P.I.N. LAND SURVEYORS P.I.N. P.I.N. 7.5 P.I.N. P.I.N. 7.0 14251-4617 14251-4621 4251-4619 5 14251-4620 a 14251-4616 PLAN SUBMISSION FORM 14251-4618 14251-4615 ROAD 4-2074) -4961 2105689 0.62-1.21 0.65 0.65-CALLANDAR (BY PLAN 45M-P.I.N. 14251-45 1.21 0.67-3.7.E F-39172 43R-39172 PART 8 PART 5 THIS PLAN IS NOT VALID UNLESS IT IS AN EMBOSSED D.U.C. D.U.C. D.U.C. D.U.C. ORIGINAL COPY D.U.C. ISSUED BY THE SURVEYOR In accordance with Regulation 1026, Section 29(3). 0.62 0.62-0.61 SSB 6.05 5.63 5.56 5.57 2 PL&SET PLASET 1. 76 PLASET PL&SET 25"E SSIB 9.150 22 LISTREET LINE **CRESCENT CIRCUS** (DY GLAN 43M--2074) R-PE SURVEYING LTD.
ONTARIO LAND SURVEYORS DOCUMENTS RELEASED PURSUANT TO A REQUEST No. 14251-4960 Christed Road, Suite /, Woodbridge, Ontario, L4L 8A3 (1416)635-5000 TAFEKE (1416)635-5001 **UNDER THE** MUNICIPAL FREEDOM OF INFORMATION AND THIS REPORT WAS PREPARED FOR (903) 264-2088EY FEDEM (90\$) 264-2099 PROTECTION OF PRIVACY ACT R.S.O. 1990c. M56 MATTAMY HOMES Website: WWWNT-09 GIE DRAWN: EVIEWED AR WINGS CAD FILE NO. 20 AR WINGS AND THE UNDERSIGNED ACCEPTS NO CHECKED: G.Y./T.S. RESPONSIBILITY FOR USE BY OTHER PARTIES COPYRIGHT ACT R.S., 1985, c. C-42 APPLIES TO THE JOB No. 19–157 **USE AND REPRODUCTION OF THESE DOCUMENTS** (C)R-PE SURVEYING LTD., O.L.S., 2019.

PROPOSED BASEMENT RENOVATIONS

72 CIRCUS CRES, BRAMPTON

FARZANA BAGAM

ISSUED FOR: BASEMENT APARTMENT PERMIT APPLICATION

ISSUE DATE: JANUARY 11, 2023

| NAMI | E OF PROJECT PROP | OSED BASEME | NT RENOVATI | ON |
|----------|--|--|--|---------------------|
| LOCA | ATION 72 CIF | CUS CRES, BR | AMPTON | |
| тем | ONTARIO BU | ILDING CODE DATA | A MATRIX | OBC REFERENCE |
| | PROJECT DESCRIPTION: | □ NEW | ☐ PART 11 | ✓ PART |
| 1 | ☐ CHANGE OF USE | ☐ ADDITION ☑ ALTERATION | 1.1.1 TO 11.4 | 2.1.1 9.10.1.3 |
| 2 | MAJOR OCCUPANCY(S) | С | | 9 10 2 |
| 3 | BUILDING AREA (m)2 EX | ISTING 106.98 NEW 0 | TOTAL 106.98 | 1.1.3.2 |
| 4 | GROSS AREA (m) ² EX | ISTING 301 03 NEW 0 | TOTAL 301 03 | 1132 |
| 4a | AREA OF WORK (m)2 | 86.96 | | |
| 5 | NUMBER OF STOREYS | ABOVE GRADE: 2 BELOW | GRADE: 1 | 2113 |
| 6 | NUMBER OF STREET/ACCESS | ROUTES 1 | | 9.10.19 |
| 7 | BUILDING CLASSIFICATION | | | 9 10 4 |
| | | ☐ BASEMENT ☐ IN LIEU OI ☑ NOT REQU | F ROOF RATING | |
| 9 | STANDPIPE REQUIRED | ☐ YES | M NO | 9 10 17 |
| 10 | FIRE ALARM REQUIRED | ☐ YES | ₩ NO | |
| 11 | WATER SERVICE/SUPPLY IS | ADEQUATE YES | □ NO | N/A |
| 12 13 | HIGH BUILDING PERMITTED CONSTRUCTION | ☐ YES] COMBUSTIBLE ☐NON-COMBU | M NO USTIBLE MBOTH | N/A 9:10.6 |
| | ACTUAL CONSTRUCTION № | COMBUSTIBLE NON-COMBU | ISTIBLE BOTH | |
| 14 15 | MEZZANINE(S) AREA (M P OCCUPANT LOAD BASED ON BASEMENT: 1 ST. FLOOR 2 ST. FLOOR 3 ST. FLOOR | N/A m²/Person M² occupancy Occupancy occupancy Occupancy occupancy Occupancy | DESIGN OF BUILDING LOAD PERSON LOAD PERSON LOAD PERSON LOAD PERSON | 9,10.4.1 9.9,1,3 |
| 16 | BARRIER-FREE DESIGN | ☐ YES M NO (EXP | LAIN) N/A | 9.5.2 |
| 17 | HAZARDOUS SUBSTANCES | ☐ YES M NO | | 9 10 1 3 |
| 18 | REQUIRED FIRE | HORIZONTAL ASSEMBLIES | LISTED DESIGN NO | 9.10.8 |
| 10 | RESISTANCE RATING (FRR) | FRR (HOURS) | LISTED DESIGN NO OR DESCRIPTION (SG-2 | 9.10.9 |
| | | ROOF HOURS | | |
| | | MEZZANINE HOURS | | |
| | | FRR OF SUPPORTING MEMBERS | LISTED DESIGN NO OR DESCRIPTION (SG-2 |) |
| | | FLOORS N/A HOURS | | |
| | | ROOF HOURS | | |
| | | MEZZANINE HOURS | | |



647.741.5917 I WWW C-ARCHI COM

Project #:

LIST OF ARCHITECTURAL DRAWINGS

COVER SHEET & OBC MATRIX A-000 A-001 SITE PLAN A-002 **GENERAL NOTES** BASEMENT - EXISTING LAYOUT A-101 A-102 BASEMENT - PROPOSED LAYOUT A-103 MAIN FLOOR - EXISTING LAYOUT SECOND FLOOR - EXISTING LAYOUT A-104 A-201 NORTH ELEVATION A-401 EGRESS WINDOW DETAIL A-402 TYPICAL DETAILS A-403 FIRE BLOCKING DETAILS WALKOUT DETAILS A-404 WALKOUT DETAILS A-405 BASEMENT - ELECTRICAL LAYOUT F-101 BASEMENT - MECHANICAL LAYOUT M-101

PROJECT TEAM:

ARCHITECT

22-176

C-ARCHITECTURE LTD. M. ARSHAD SIDDIQUI, OAA C: 647.741.5917 E: arshad@c-archi.com

NOTES:

1, PROVIDE INTERCONNECTED SMOKE ALARMS IN BOTH DWELLING UNITS, (THROUGHOUT THE ENTIRE BUILDING) 2 HORIZONTAL FIRE SEPARATION BETWEEN TWO DWELLING UNITS SHALL COMPLY WITH O.B.C. REQUIREMENTS REFER SECTION 11.5.1.1.C (C152) WHICH PRESCRIBES IT TO BE 15 MINUTES

FIRE SEPARATION OBC910914 9.10 B.1

C152 9.10.9.14.(1) AND (3); 9.10.9.15.(1) (8) IN DETACHED HOUSES, SEMI-DETACHED HOUSES, TOWNHOUSES AND ROW HOUSES CONTAINING NOT MORE THAN TWO DWELLING UNITS, 15 MIN HORIZONTAL FIRE SEPARATION IS ACCEPTABLE WHERE,

(I) SMOKE ALARMS ARE INSTALLED IN EVERY DWELLING UNIT AND IN COMMON AREAS IN CONFORMANCE WITH SUBSECTION 9.10.19, AND

(II) SMOKE ALARMS ARE INTERCONNECTED

(C) IN DETACHED HOUSES, SEMI-DETACHED HOUSES, TOWNHOUSES AND ROW HOUSES CONTAINING NOT MORE THAN TWO DWELLING UNITS, THE FIRE RESISTANCE RATING OF THE FIRE SEPARATION IS WAIVED WHERE BUILDING IS SPRINKLERED

C147 9.10.8.1.; 9 10.8.3.; 9.10.8.8. (B) IN DETACHED HOUSES, SEMI-DETACHED HOUSES, TOWNHOUSES AND ROW HOUSES CONTAINING NOT MORE THAN TWO DWELLING UNITS, 15 MIN HORIZONTAL FIRE SEPARATION IS ACCEPTABLE WHERE,

(I) SMOKE ALARMS ARE INSTALLED IN EVERY DIVELLING UNIT AND IN COMMON AREAS IN CONFORMANCE WITH SUBSECTION 9.10.19, AND

(II) SMOKE ALARMS ARE INTERCONNECTED.

NUMBER OF EXITS: (OBC998)

C136 9 9 9. IN DETACHED HOUSES, SEMI-DETACHED HOUSES, TOWNHOUSES AND ROW HOUSES CONTAINING NOT MORE THAN TWO DWELLING UNITS, EXIT REQUIREMENTS ARE ACCEPTABLE IF AT LEAST ONE OF THE FOLLOWING CONDITIONS EXISTS:

BEDROOM WINDOWS: (A) A DOOR, INCLUDING A SLIDING DOOR, THAT OPENS DIRECTLY TO THE EXTERIOR FROM A DWELLING UNIT, SERVES ONLY THAT DWELLING UNIT AND HAS REASONABLE ACCESS TO GROUND LEVEL, AND THE DWELLING UNITS ARE EQUIPPED WITH SMOKE ALARMS INSTALLED IN CONFORMANCE WITH SUBSECTION 9.10.19.

C137 9 9:10.1: IN DETACHED HOUSES, SEMI-DETACHED HOUSES, TOWNHOUSES AND ROW

HOUSES CONTAINING NOT MORE THAN TWO DWELLING UNITS, EXISTING ACCEPTABLE, WHERE THERE IS DIRECT ACCESS TO THE EXTERIOR.

C108 9.7 EXISTING ACCEPTABLE

WINDOW SIZES: C107 9.7 2.3. (A) WHERE WINDOWS ARE NOT USED AS A MEANS OF EGRESS AND WHERE THEY DO NOT CONFLICT WITH VENTILATION REQUIREMENTS, THE MINIMUM GLASS AREAS AS SHOWN IN TABLE 9 7 2 3 MAY BE REDUCED BY 50%

TO BE OPERABLE FORM INSIDE WITHOUT USE OF ANY TOOLS UNOBSTRUCTED OPEN PORTION HAVING A MINIMUM AREA OF 0.35 SM / 3.8 SFT WITH NO DIMENSION LESS THAN 1'-3" 380MM)

DIV. B. O B C 9 10 19 99101

AN EGRESS WINDOW FROM THE BASEMENT FLOOR AREA WITH A MINIMUM OPEN AREA 3.8 FT? AND NO DIMENSION LESS THAN 15°, HARDWIRED AND INTERCONNECTED SMOKE ALARMS IN EACH

BEDROOM, AND A HARDWIRED AND INTERCONNECTED CO DETECTOR MINIMUM CFILING HEIGHTS FOR BASEMENT SPACES 5 YEARS OR GREATER IN AGE IS 6'-5" OVER THE BASEMENT AREA INCLUDING UNDER

ALL WORK SHOULD COMPLY WITH ONTARIO BUILDING CODE 2012

DIV B OBC 11511 DIV B OBC 9 33 1 1 (1)

SUPPLY AIR OUTLETS ARE REQUIRED IN EACH FINISHED ROOM OR

SPACE, PROVIDE AT LEAST ONE RETURN OUTLET PER FLOOR LEVEL. UNDERCUT DOORS TO ROOMS WHERE RETURN AIR IS NOT PROVIDED LOW WALL SUPPLY AND RETURN OUTLETS ARE RECOMMENDED.


OBC7651(1)

EACH NEW PLUMBING FIXTURE REQUIRES A MIXING VALVE TO ENSURE THAT THE MAXIMUM TEMPERATURE OF HOT WATER SUPPLIED BY FITTINGS TO THE FIXTURE DOES NOT EXCEED 49°C ALTERNATIVELY PROVIDE A MIXING VALVE ON THE HOT WATER HEATER TO ENSURE THAT THE WATER SUPPLIED TO ALL FIXTURES DOES NOT EXCEED 49°C.

OBC910161 9631(1)

INSULATION IS REQUIRED IN THE FLOOR JOISTS ABOVE WALLS SEPARATING FINISHED AND UNFINISHED PORTIONS. ENSURE THE DOOR

TO THE UTILITY ROOM IS MINIMUM 32" WIDE.

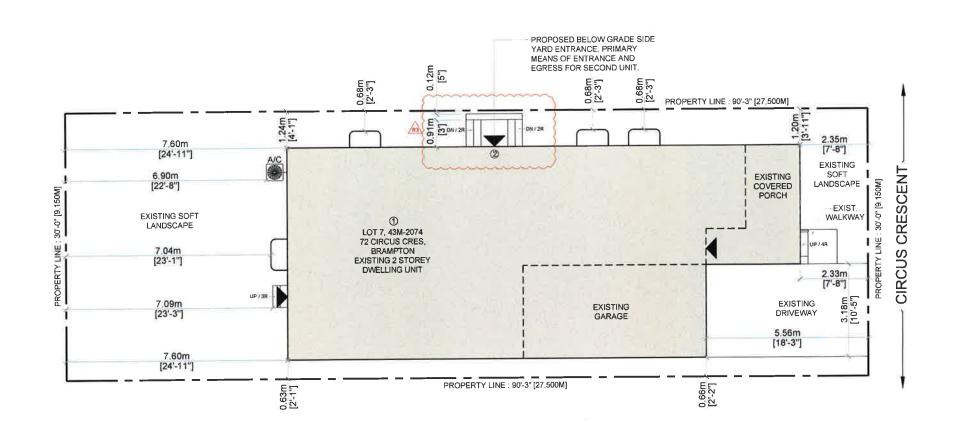



LEGEND



PROPERTY LINE



ENTRANCE & EGRESS

PARKING SPACES PROVIDED

TWO PARKING SPACES PROVIDED (ONE OUTSIDE & ONE INSIDE THE GARAGE)

AREA STATISTICS

GROSS FLOOR AREA CALCULATIONS A - EXISTING PRINCIPAL RESIDENCE EXISTING MAIN FLOOR AREA GARAGE AREA EXISTING SECOND FLOOR AREA TOTAL ABOVE GRADE GFA B - EXISTING BASEMENT BASEMENT AREA PART OF PRICIPAL RESIDENCE = 00,00 SFT / 00,00 SM

TOTAL LOT AREA: 2708 SFT / 251.67 SM

NEW BASEMENT APARTMENT GFA = 880 SFT / 81.78 SM = 55.80 SFT / 5.18 SM FURNACE AREA TOTAL BASEMENT GFA = 935.77 SFT / 86.96 SM BASEMENT APARTMENT GFA IS 37.29 % OF PRINCIPAL RESIDENCE GFA

SCOPE OF WORK

(1) BASEMENT APARTMENT


= 935,77 SFT / 86,96 SM

= 214.40 SFT / 19.92 SM

= 1152 22 SFT / 107 08 SM

= 2,303.4 SFT / 214.07 SM

② PROPOSED BELOW GRADE SIDE YARD ENTRANCE, PRIMARY MEANS OF ENTRANCE AND EGRESS FOR SECOND UNIT

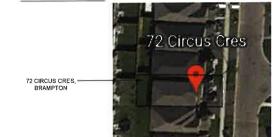

SITE LOCATION

RELEASED FOR BUILDING PERMIT

COPYRIGHT RESERVED

| NO | DATE | REVISION (ISSUED) |
|----|--------------|---------------------|
| = | 2023.12 20 | SONDWATECHNOUT |
| * | BEZZUT ÓN | PERSON APPLICATION. |
| ** | 2023.01.64 | CITY EDWARNTS |
| 11 | 20200 | CITY COMMENTS |
| ** | ज्यास्त्रकात | PERMITALVOOR |
| | | |
| | | |



FARZANA BAGAM

ARCHITECT

C-Architecture Ltd 10368 WINSTON CHURCHILL BLVD, HALTON HILLS ON L7G 4S7 c: 647,741,5917, e. info@c-archi.com



ALTERATIONS (SU)

72 CIRCUS CRES, BRAMPTON

SITE PLAN

SCALE: DATE:

½" = 1'-0" 2023.01.11

PROJECT:

22-176

DRAWING NO:

SPECIFICATION:

FOUNDATION WALL INSULATION EXISTING FOUNDATION WALL, MOISTURE BARRIER, 2 BY 4 STUDS @ 16" O.C., R12 INSULATION, 6 MIL POLYETHYLENE V.B., ½" GYPSUM DRYWALL JOINTS TAPED AND SEALED AND PAINTED.

√IA NOT USED

DATE RECEIVED: 2023/02/15

(2) INTERNAL WALLS

½" DRY WALL ON BOTH SIDES OF NEW OR EXISTING FRAMED WALL CONSISTING OF 2 BY 4 WOOD STUDS @ 16" O.C., WITH JOINTS TAPED AND SEALED. SB-3: W1 (WATER RESISTANT GWB ON BATHROOMS' WALLS).

A INTERNAL WALLS

½" TYPE X DRYWALL ON BOTH SIDES OF NEW OR EXISTING FRAMED WALL CONSISTING OF 2 BY 4 WOOD STUDS @ 16" O.C. WITH ABSORPTIVE MATERIAL (INSULATION). SB-3: W1b. FIRE RESISTANCE: 45 MIN, STC: 34

②B NOT USED


√3>> CEILING

√3Ã>> NOT USED

~3B ↑ 5%" TYPE X DRY WALL CEILING ATTACHED TO BOTTOM OF JOISTS OF FLOOR ASSEMBLY ABOVE . SB-3: F3b. FIRE RESISTANCE : 31 MIN, STC : 30.

√3C>> NOT USED

- 4 20 MIN. RATED DOOR FOR FURNACE ROOM AND BETWEEN BASEMENT APARTMENT AND BASEMENT AREA WHICH IS PART OF PRINCIPAL RESIDENCE
- (5) EXISTING DUCT WORK LOCATED IN THE CEILING SHALL BE RELOCATED SO THAT THE DIRECTION OF THE HEAT FLOW IS TOWARDS THE FLOOR
- 6 MECHANICAL VENTILATION
 5 L/S EXHAUST FANS IN KITCHEN AND WASHROOM AND 37.5 L/S FOR PRINCIPAL EXHAUST
- INTERCONNECTED AND WIRED SMOKE ALARMS AT EACH FLOOR AND EACH UNIT INCLUDING FINISHED BASEMENT AND LEGAL BASEMENT THROUGH ENTIRE HOUSE ALARM AS PER OBC 9.10.19.
- PERMANENTLY CONNECTED TO ELECTRICAL CIRCUIT CARBON MONOXIDE DETECTOR AS PER OBC 2012 B 9.33.4.3.
- 9 FOR ALL ELECTRICAL WORK AND PERMIT CONTACT ELECTRICAL SAFETY AUTHORITY
- SELF CONTAINED EMERGENCY LIGHTING UNIT CONFORMING TO CSA C22.2 NO.141, *EMERGENCY LIGHTING EQUIPMENT* AS PER OBC 9.9.12

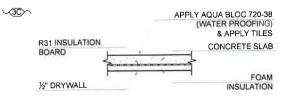

PORCH TO BE FINISHED WITH TILES

SCHEDULES

ROOM FINISH SCHEDULE

| RM. | RM | FLOOR | | BA | BASE W | | ALLS CE | | ING | HEIGHT | REMARKS |
|-------|-----------------|----------|--------|----------|--------|----------|---------|----------|--------|--------|---------|
| NO | ROOM NAME | MATERIAL | FINISH | MATERIAL | FINISH | MATERIAL | FINISH | MATERIAL | FINISH | прон | KEWAKKS |
| BASEM | ENT FLOOR | | | | | | | | | | |
| 1 | LIVING / DINING | WOOD | STAIN | VINYL | | DRYWALL | PAINT | DRYWALL | PAINT | 7'-8" | |
| 2 | KITCHEN | WOOD | STAIN | VINYL | | DRYWALL | PAINT | DRYWALL | PAINT | 7"-8" | |
| 3 | BEDROOM | WOOD | STAIN | VINYL | | DRYWALL | PAINT | DRYWALL | PAINT | 7'-8" | |
| 4 | STORAGE | WOOD | STAIN | VINYL | | DRYWALL | PAINT | DRYWALL | PAINT | 7'-8" | |
| 5 | CLOSET | WOOD | STAIN | VINYL | | DRYWALL | PAINT | DRYWALL | PAINT | 7'-8" | |
| 6 | BATH | CERAMIC | | VINYL | | DRYWALL | PAINT | DRYWALL | PAINT | 7'-3" | |

DOOR SCHEDULE

1. ALL INTERIOR DOORS ARE SLAB DOOR 1-3/8 TH. HOLLOW CORE OR SLIDING DOORS. THE SIZES ARE MENTIONED ON THE FLOOR PLAN. THE HEIGHT OF ALL DOORS ARE 80".

2. ALL FIRE RATED DOORS SHALL HAVE SELF-CLOSING DEVICES

GENERAL NOTES

 ALL WORK ACCORDING TO ONTARIO BUILDING
 CODE 2012 AND AHJ BY-LAWS AND STANDARDS

- ALL DIMENSIONS AND LOCATIONS TO BE VERIFIED ON SITE PRIOR TO CONSTRUCTION.
- ALL WOOD USED IN THE CONSTRUCTION SHALL BE SPF NO.1 OR NO.2
- MINIMUM BEARING OF STEEL LINTELS 150
 MM
- MINIMUM BEARING OF WOOD BEAM / LINTELS 90 MM
- . MINIMUM BEARING OF WOOD JOISTS 40MM
- VERIFY EXISTING SUPPORT SYSTEM, INCLUDING FOUNDATIONS, FOR LOADS IMPOSED BY THE PROPOSED CONSTRUCTION
- PROVIDE ALL BRACING, SHORING AND NEEDLING NECESSARY FOR THE SAFE EXECUTION OF THIS WORK
- INFORM CITY OF ALL INSPECTION AHEAD OF TIME AND AT EACH STAGE OF CONSTRUCTION

3 OR 4 WAY SWITCH

E EXISTING N NEW 3 DENOTES 3-WAY SWITCH SPECIFICATION GRADE WHITE, WITH WHITE COVER PLATE4 DENOTES 4-WAY SWITCHSHALL BE INSTALLED AT THEENDS OF EACH STAIRWAYS

INSTALL AT 3'-3" AFF

PLEASE SEE ATTACHED

NOTES AS THEY FORM

PART OF THE

REVIEWED DRAWING:

Ç GFI WP 15A, 120V DUPLEX RECEPTACLE SPECIFICATION GRADE, WHITE C/W WHITE COVER PLATE GFI- GROUND FAULT TYPE WP- WEATHERPROOF COVER C - ABOVE COUNTER

⊕_A

RECEPTACLE 50A, 208V, STOVE OR DRYER OUTLET.

EXHAUST FAN

 \otimes FD: FLOOR DRAIN

SPRINKLER

(10) & EMERGENCY LIGHT

SD: SMOKE ALARM W/ STROBE LIGHT

CO: CARBON MONOXID

ALARM

LIGHT

CO: CARBON MONOXID

Building Reviewed

2023/02/21

LOQUIN

ALARM

LIGHT

ALARM

ALARM

LIGHT

POT LIGHT

INSTALL DUCT TYPE SMOKE DETECTOR IN FURNACE.

NEW CEILING TO BE 45 MIN. FIRE RATED WITH ABSORPTIVE MATERIAL IN CAVITY. RESILIENT METAL CHANNELS @ 610MM O.C. WITH 2 LAYERS OF 12.7 MM TYPE X GYP. BD. ON CEILING SIDE AS PER "TABLE 2, FLOORS & CEILINGS F9h OF SB-3"

2/2x10 SPR WOOD LINTEL.

ESCAPE WINDOW:
TO BE OPERABLE FROM INSIDE
WITHOUT USE OF ANY TOOLS
UNOBSTRUCTED OPEN PORTION
HAVING A MINIMUM AREA OF
0.35M2/3.76 Sq.Ft WITH NO DIMENSION
LESS THAN 1'-3" 380MM)

BULKHEAD / STAIR CEILING 45 MIN. FIRE SEPARATION, 2 LAYERS 1/2" TYPE X GYPSUM (NOTE: NO OPENINGS PERMITTED THIS MEMBRANE ONLY FIRE SEPARATION. RELEASED FOR BUILDING PERMIT

CONTRACTOR DALL SITE VERBY ALL DAMERIONS AND REPORT DISEMPRACES (FAMT) TO THE CONSULVANTS BEFORE CONSTRUCTION ALL DIAMPRISS AND BUSS BE RETURNED AT THE OF CONSULTANTS AND BUSS BE RETURNED AT THE THIS DIAMPRIS IN CITY OF SUSED FOR CONSIDERIOR TO UNESS SOMED BY THE AMOUNT OF PAIR IF THIS DEFICE IS NOT IT IN THE A MEDICED /

COPYRIGHT RESERVED

THE CONTROLLS THE ALL RESIDUE AND BRANCES AND THE PROPERTY OF ABOUTEST REPRESENTION OF LISE FEW AND

| NO | DATE | REVISION / ISSUED |
|-----|--------------|-------------------|
| × | 2022.12.36 | DOHORAT CLAYOUT |
| * | 202) (in O6 | PERSTANCETON |
| £17 | 2023 (19.11) | CUL COMMENTS |
| 10 | 2023 07 03 | SITY COMMENTS |
| | | |
| | | |

OWNER

FARZANA BAGAM



-Architecture Ltd

10368 WINSTON CHURCHILL BLVD, HALTON HILLS ON L7G 4S7 c: 647.741.5917, e: info@c-archi.com SEAL



ALTERATIONS (SU)

72 CIRCUS CRES, BRAMPTON

GENERAL NOTES

SCALE: N.T.S DATE: 2023.01.11

PROJECT:


DRAWING NO:

A-002

22-176

RECEIVED 2023/02/15

PLEASE SEE ATTACHED NOTES AS THEY FORM PART OF THE REVIEWED DRAWINGS

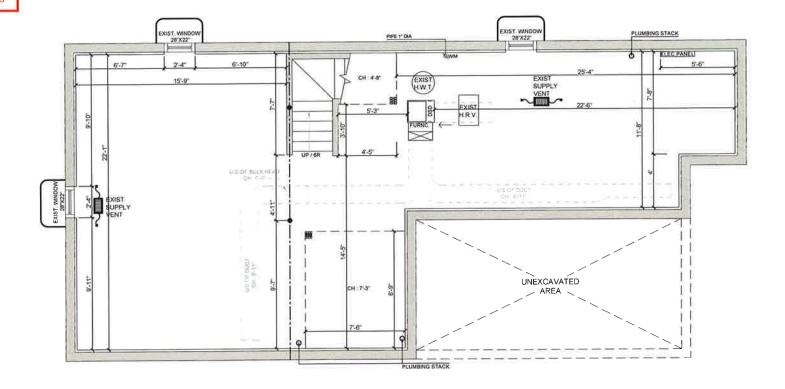



LEGEND:

EXHAUST FAN EXISTING WALLS **NEW WALLS**

FIRE RATED WALLS, REFER TO A-403 FOR DETAILS

EXISTING TO BE REMOVED

EXISTING STEEL & WOODEN POSTS HARD WIRED SMOKE DETECTOR (INTERCONNECTED)

CARBON MONOXIDE ALARM

BASEMENT - EXISTING LAYOUT

BASEMENT AREA = 935,77 SFT / 86,96 SM U/S OF DUCT CEILING HEIGHT = 6'-11" U/S OF BULK HEAD CEILING HEIGHT = 6'-7"

CEILING HEIGHT = 7'-8"

RELEASED FOR BUILDING PERMIT

ELEASED FOR BUILDING PERMIT
CONSIDERIOR SHALL BIT YEARS ALL DISTRIBUTIONS AND
SENSE CONSIDERATION OF ANY 10 THE CONSULTANTS
ALL DRAWNERS AND SECRETARY ARE THE PROPERTY
COMPACTION OF ANY 10 THE CONSULTANTS
ALL DRAWNERS OF SENSE OF THE SENSE AT THE
COMPACTION OF MOSE
THE SENSE OF THE SENSE OF THE CONTROL OF THE
COMPACTION OF THE
COMPACT

COPYRIGHT RESERVED

| NO | DATE | REVISION / ISSUED |
|----|------------|--------------------|
| × | 20221238 | SCHEMIC SHOUT |
| ic | 2023 01 GB | PERMIT APPLICATION |
| 91 | 2023-01.10 | ESTY COMMENTS |
| ** | 2023 07 00 | CITY ESWANTS |
| _ | | |



FARZANA BAGAM



C-Architecture Ltd

10368 WINSTON CHURCHILL BLVD, HALTON HILLS ON L7G 4S7 c. 647.741.5917, e. info@c-archi.com



ALTERATIONS (SU)


72 CIRCUS CRES, BRAMPTON

BASEMENT -**EXISTING** LAYOUT

3/16"=1'-0" SCALE: DATE: 2023.01.11 PROJECT: 22-176

DRAWING NO:

A-101

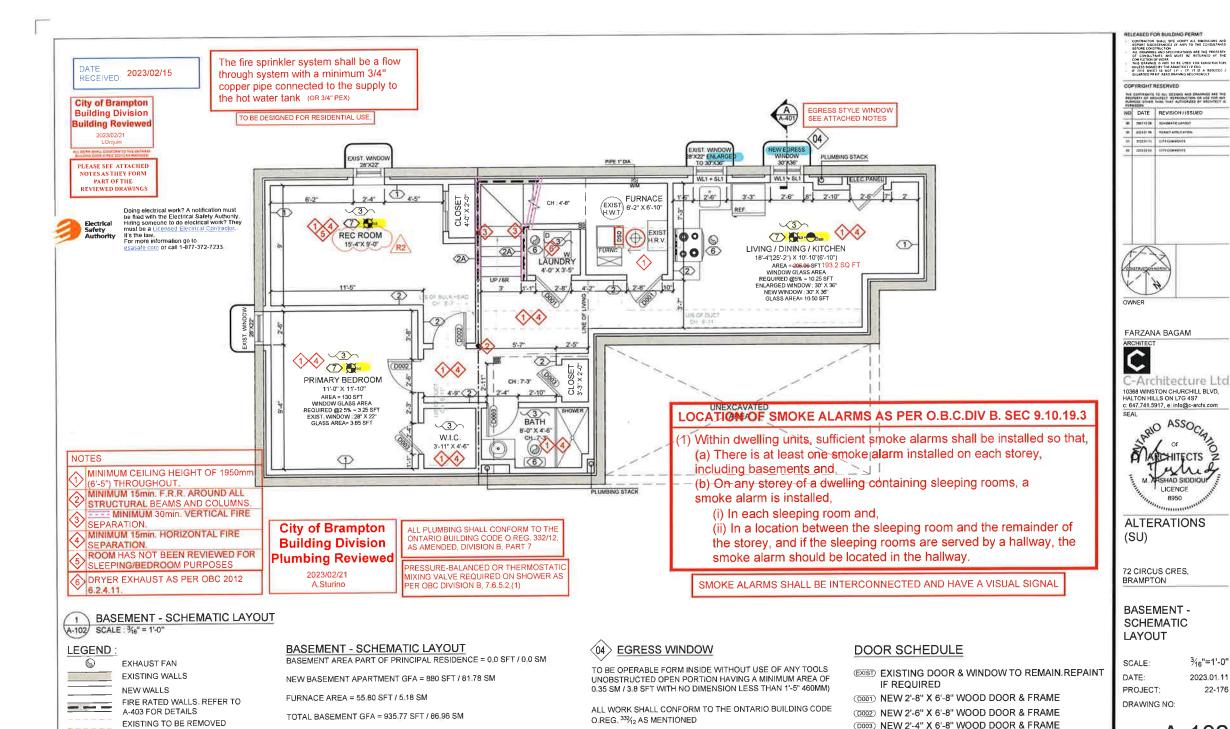

SL1: STEEL LINTEL 31/2" X 31/2" X 3/8"

WL1: WOOD LINTEL 2-2X8 SPF NO.1 OR 2

EXISTING STEEL & WOODEN POSTS

HARD WIRED SMOKE DETECTOR

(INTERCONNECTED)

CARBON MONOXIDE ALARM

U/S OF DUCT CEILING HEIGHT = 6'-11"

CEILING HEIGHT = 7'-8"

U/S OF BULK HEAD CEILING HEIGHT = 6'-7"

A-102

(D004) NEW DOUBLE DOOR

(5005) NEW 2'-8" X 6'-8", 20 MIN. FIRE RATED DOOR


3/16"=1'-0"

2023 01 11

22-176

SHAD SIDDIQUE

LICENCE

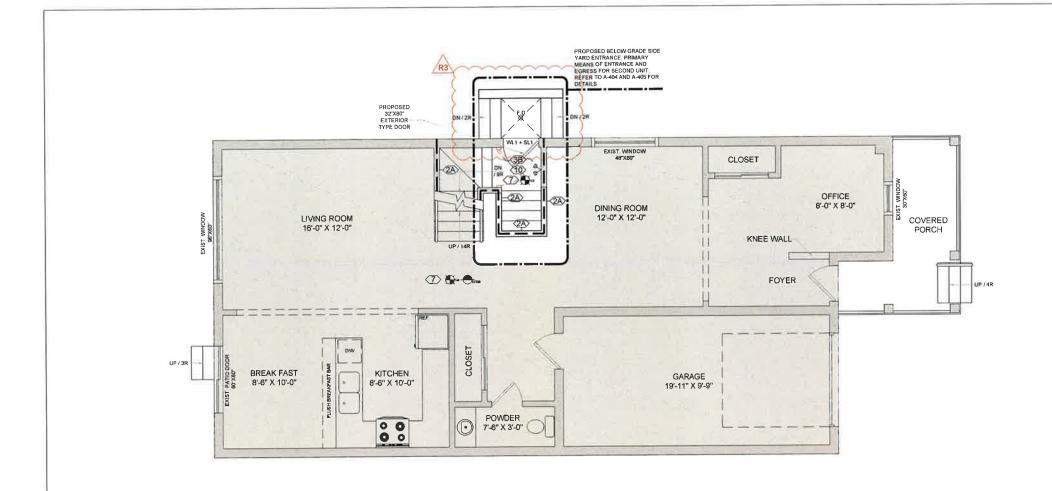



LEGEND:

6

EXHAUST FAN EXISTING WALLS

NEW WALLS FIRE RATED WALLS: REFER TO

A-403 FOR DETAILS

EXISTING TO BE REMOVED

CARBON MONOXIDE ALARM

EXISTING STEEL & WOODEN POSTS

HARD WIRED SMOKE DETECTOR (INTERCONNECTED)

MAIN FLOOR - EXISTING LAYOUT

MAIN FLOOR AREA = 935.77 SFT / 86.96 SM

GARAGE AREA = 214.40 SFT / 19.92 SM

TOTAL MAIN FLOOR AREA = 1151:18 SFT / 106.98 SM

CEILING HEIGHT = 8'-0"

RELEASED FOR BUILDING PERMIT

RELEASED FOR BUILDING PERMIT
CONTRACTOR SHALL, SITE YERRY ALL DIMPAGENTS AND
REPORT DESCRIPANCES (F. MAY) TO THE CONSULTANTS
REFORE CONSTRUCTOR AND THE CONSULTANTS
ALL DIMPAGES AND SPECIAL PROPERTY.
ALL DIMPAGES AND SPECIAL PROPERTY.
ALL DIMPAGES AND THE CONSULTANTS
AND SPECIAL PROPERTY.
HIS DIMPAGES AND THE ARCHITECT PROPERTY.
IF THE SHEET IN THE THE THE ARCHITECT PROPERTY.
IN THE SHEET IN THE SHEET PROPERTY.
IN THE SHEET SHEET SHEET SHEET SHEET SHEET SHEET SHEET SHEET SHEET.

HE SHEET SHEET.

HE SHEET SHE

COPYRIGHT RESERVED

THE COPYRIGHTS TO ALL DESIGNS AND DRAWNOS ARE THE PROPERTY OF ARCHITECT REPRODUCTION OR USE FOR ANY PURPOSE OTHER THAN THAT AUTHORIZED BY ARCHITECT IS

| 10 | DATE | REVISION / ISSUED |
|------|------------|--------------------|
| - | 2023 19 29 | SOMBARC LANGE |
| = | 20/1 to Ca | PERMIT APPLICATION |
| 11 | 2023 61.11 | CITY COMMENTS |
| iti. | 7023 G2 G5 | CITY COMMENTS |
| ** | 2025 CD (% | MERCH REVERSE |
| | | |
| | | |
| - 1 | | |



FARZANA BAGAM

C-Architecture Ltd.

10368 WINSTON CHURCHILL BLVD, HALTON HILLS ON L7G 4S7 c: 647,741,5917, e. info@c-archi com



ALTERATIONS (SU)

72 CIRCUS CRES, BRAMPTON

MAIN FLOOR -**EXISTING LAYOUT**

3/16"=1'-0" SCALE:

DATE: 2023.01.11 PROJECT: 22-176


DRAWING NO:

A-103

RECEIVED: 2023/02/15

City of Brampton **Building Division Building Reviewed**

PLEASE SEE ATTACHED NOTES AS THEY FORM PARTOFTHE REVIEWED DRAWINGS

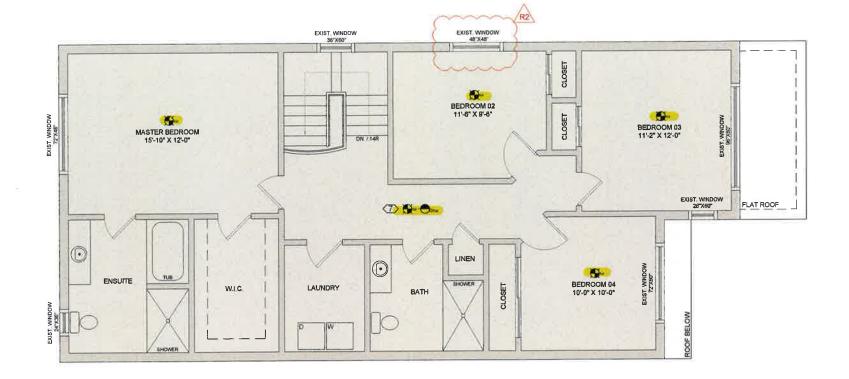



LEGEND:

6 EXHAUST FAN

EXISTING WALLS

NEW WALLS

FIRE RATED WALLS, REFER TO A-403 FOR DETAILS EXISTING TO BE REMOVED



EXISTING STEEL & WOODEN POSTS HARD WIRED SMOKE DETECTOR (INTERCONNECTED)

CARBON MONOXIDE ALARM

SECOND FLOOR - EXISTING LAYOUT

SECOND FLOOR AREA = 1152,22 SFT / 107,08 SM

CEILING HEIGHT = 8'-0"

LOCATION OF SMOKE ALARMS AS PER O.B.C.DIV B. SEC 9.10.19.3


- (1) Within dwelling units, sufficient smoke alarms shall be installed so that,
 - (a) There is at least one smoke alarm installed on each storey, including basements and,
 - (b) On any storey of a dwelling containing sleeping rooms, a smoke alarm is installed,
 - (i) In each sleeping room and,
 - (ii) In a location between the sleeping room and the remainder of the storey, and if the sleeping rooms are served by a hallway, the smoke alarm should be located in the hallway.

SMOKE ALARMS SHALL BE INTERCONNECTED AND HAVE A VISUAL SIGNAL

REPORT CONTRIBUTION

REPORT CO

| | 37777 | l . |
|------|------------|-------------------|
| - 18 | 2023 Ht 29 | SCHEMAN SATURAL |
| | 2011:is | PERMITAPPLICATION |
| 84 | 2020 24 66 | COY COMMENTS |
| . 10 | 301116 40 | CHY COMMENTS: |
| | | |

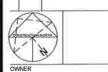

FARZANA BAGAM



C-Architecture Ltd 10368 WINSTON CHURCHILL BLVD. HALTON HILLS ON L7G 4S7 c: 647.741.5917, e: info@c-archi com



ALTERATIONS (SU)

72 CIRCUS CRES, BRAMPTON


SECOND FLOOR -EXISTING LAYOUT

3/16"=1'-0" SCALE: DATE: 2023.01.11 PROJECT: DRAWING NO:

A-104

GLAZED OPENINGS:

WALL AREA: = 1016.84 SFT / 94.50 LIMITING DISTANCE: 1.31 M WINDOW AREA PROVIDED: 62.6 SFT / 5.81 M² (6.15%) WINDOW AREA ALLOWED: 7%

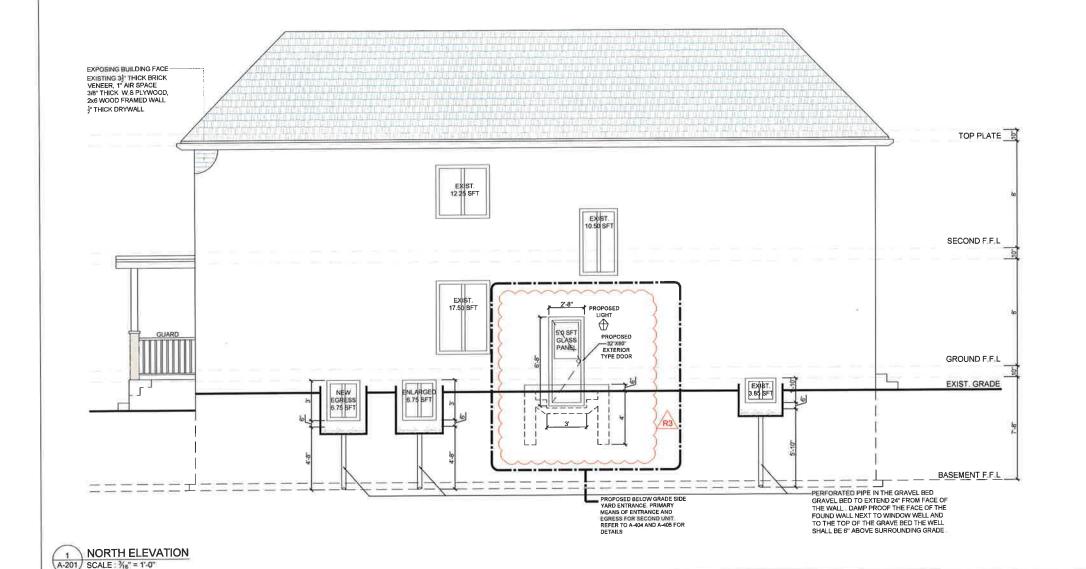

RELEASED FOR BUILDING PERMIT

CONTINCTOR SHALL SITE VERRY ALL DIMENSIONS AND REPORT DISCRIPTIONS OF ANY) TO THE CONSULTANTS BETWEE CONSTRUCTION
ALL DIAMNOS AND SPEC PRICATIONS ARE THE PROPERTY OF CONSULTANTS AND MUST BE RETURNED AT THE COMPETCING OF WORK.
THIS DIAMNOS IS NOT TO BE USED FOR CONSTRUCTION UNLESS GONES BY THE ARCHITECT OF DO.

COPYRIGHT RESERVED

the expressive to all sessoid mile deadless are the property of admitself appropriation of the for any purpose ether than that authorizes all architect to

| 2017 20 200 | NO | DATE | REVISION / ISSUED |
|---|----|------------|-------------------|
| EI 2020 III CHICEMBERTE EI 2021 III III EIFE COMMENTE | = | 2022.12 20 | TOTAL STREET |
| a amino errecovens | = | 2023.01 00 | PRINCIPAL |
| | 11 | 2023 in 11 | CHICIMPERTS |
| gs 200 to especially like | 43 | mne | EIFY CONVENTS |
| | es | 5023 to 01 | PERMIT REVISION |
| | | | |
| | | | |

OWNER

FARZANA BAGAM



C-Architecture Ltd
10388 WINSTON CHURCHILL BLVD,
HALTON HILLS ON LTG 4S7
c: 647,741.5917, e: info@c-archi.com



ALTERATIONS (SU)

72 CIRCUS CRES, BRAMPTON

NORTH ELEVATION

SCALE:

DATE: 2023.01.11 PROJECT: 22-176

DRAWING NO:

A-201

3/16"=1'-0"

GENERAL NOTES


- ALL WORK ACCORDING TO ONTARIO BUILDING CODE 2012 AND CITY OF BRMPTON BY-LAWS
- ALL WORKING ACCORDING TO GOOD CONSTRUCTION PRACTICES
- ALL FOOTINGS SHALL REST ON NATURAL UNDISTURBED SOIL OR COMPACTED GRANULAR FILL WITH A MINIMUM BEARING CAPACITY OF 75 KPA
- WHERE THE FOUNDATIONS OF A BUILDING ARE TO BE CONSTRUCTED BELOW THE LEVEL OF THE FOOTINGS OF AN ADJACENT BUILDING AND WITHIN THE ANGLE OF REPOSE OF THE SOIL, OR THE UNDERPINNING EXCEEDS 1200MM OF LATERALLY UNSUPPORTED HEIGHT OR THE SOIL IS CLAY OR SILT, THE UNDERPINNING & RELATED CONSECUTION SHALL BE DESIGNED BY A PROFESSIONAL ENGINEER.
- EXCAVATION SHALL BE UNDERTAKEN IN A MANNER SO AS TO PREVENT MOVEMENT WHICH WOULD CAUSE DAMAGE TO ADJACENT PROPERTIES, STRUCTURES, UTILITIES, ROADS & SIDEWALKS, CONTACT YOUR LOCAL UTILITIES PRIOR TO COMMENCING EXCAVATION
- SHORE & BRACE WHERE NECESSARY TO ENSURE THE SAFETY & STABILITY OF THE EXISTING STRUCTURE DURING UNDERPINNING

CONCRETE

- 1: MINIMUM COMPRESSIVE STRENGTH OF CONCRETE 32MPA @ 28 DAYS W/5% TO 8% AIR ENTRAINMENT.
- 2. MINIMUM YIELD STRENGTH OF STEEL 60 KSI

1. EXTERIOR DOOR

EXTERIOR TYPE DOOR (42MM INSULATED STEEL DOOR) SIZE 2'-8"x6'-8", W/ DEADBOLT AS PER OBC 9 6 5 & 9 6 8 TO RESIST FORCED ENTRY. PROVIDE LINTEL. AS FOLLOWS: SL1: STEEL LINTEL 3 1 X 31 X 31 X 31 WL1: WOOD LINTEL 2-2 X 8 SPF NO 1 OR 2

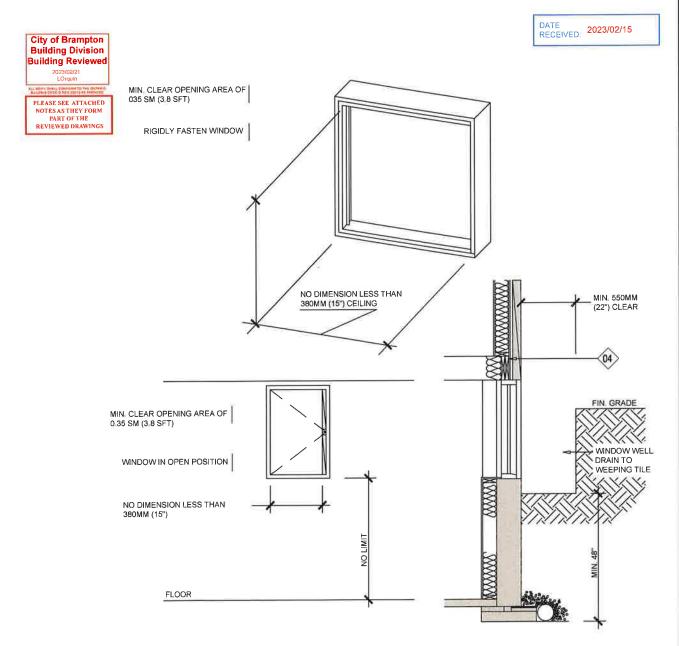



RELEASED FOR BUILDING PERMIT CONTRACTOR SHALL SITE VERIFY ALL DIMENSIONS AND REPORT DISCREPANCIES (F ANY) TO THE CONSULTANTS REPORT CONSTRUCTION

REPORT DISCREPANCES (P. MAT), M. THE PROPERTY ALL DRAWMASS, MIG. SPECIAL CLASS ARE THE PROPERTY ALL DRAWMASS, MIG. SPECIAL CLASS ARE THE PROPERTY AND ALL THE COMPLETE OF WORK.
THIS DRAWMAD IS MICH TO BE USED FOR LOCATIONATION MILESS SONGES OF THE ADMINISTER OF THE MICH.
IF THIS DRIES IS NOT IF IT IT, THE PROPERTY OF THE PROPERTY PROPERTY OF THE PROPERTY OF THE MICH.

FOR THE OFFICE IS NOT IF IT IT, THE PROPERTY OF THE MICH.

FOR THE OFFICE IS NOT IF IT IT, THE OFFICE IS NOT IT IN IT.

FOR THE OFFICE IS NOT IN I

COPYRIGHT RESERVED

THE COPPERATE TO HE SERONS AND ERANNESS ARE THE HOMESTY OF ARCHITECT REPRODUCTION OR USE YOR AND

| NO | DATE | REVISION/ISSUED |
|-----|------------|--------------------|
| * | 2022.12 20 | SCHEMATIC UNDERT |
| ** | 2023.01.00 | PERSON APPLICATION |
| ** | 2023.0(11 | DITY COMMENTS. |
| .11 | 202.00 | DITCOMMENTS |
| | | |
| | | |
| | | |
| | | |
| | | |
| | | |
| | | |

FARZANA BAGAM

ARCHITECT

OWNER

C-Architecture Ltd

10368 WINSTON CHURCHILL BLVD, HALTON HILLS ON L7G 4S7 c: 647.741.5917, e: info@c-archi com



ALTERATIONS (SU)

72 CIRCUS CRES, BRAMPTON

EGRESS WINDOW DETAIL

SCALE: 3/4" = 1'-0" DATE: 2023.01.11 PROJECT: 22-176 DRAWING NO:

RECEIVED: 2023/02/15



2023/02/21 LOrquin

PLEASE SEE ATTACHED NOTES AS THEY FORM PART OF THE REVIEWED DRAWINGS




2" X 4" WOOD FRAMING 2 LAYERS TYPE 'X' GYPSUM BOARD RATING PER BUILDING CONDITION

STEEL BEAM SEPERATION 1 A-402


> FIRE SEPARATION CEILING ABOVE 2" X 4" WOOD STUDS 1/2" GYPSUM BOARD

2" X 4" WOOD FRAMING 2 LAYERS TYPE 'X' GYPSUM BOARD RATING PER BUILDING CONDITION

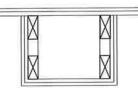

BULKHEAD BELOW FIRE SEPERATION A-402

A-402

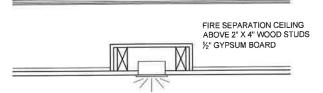

4 A-402 STEEL COLUMN SEPERATION

> 2" X 4" WOOD STUDS TO SUPPORT CEILING SOUND INSULATION (OPTIONAL) 2 LAYERS TYPE 'X' GYPSÚM BOARD RATING PER **BUILDING CONDITION**

POT LIGHT FIRE SEPERATION



UNDERSIDE OF STAIR FIRE SEPERATION

RELEASED FOR BUILDING PERMIT

COPYRIGHT RESERVED

THE COPTRICHTS TO ALL DESIGNS AND DRAWNGS ARE THE

| 140 | DATE | REVISION / ISSUED |
|-----|------------|-------------------|
| - | 6022.10 M | EHRHELFER |
| * | 2023.01.08 | PERMITANGE TON |
| 81 | 2020111 | CHYCOMPINE |
| 10 | 200.00 | ESTY COMPLETE |
| | | |

OWNER

FARZANA BAGAM



C-Architecture Ltd

10388 WINSTON CHURCHILL BLVD,
HALTON HILLS ON L7G 4S7
c: 647.741.5917, e: info@c-archi com




ALTERATIONS (SU)

72 CIRCUS CRES, BRAMPTON

TYPICAL DETAILS

3/8"= 1'-0" SCALE: DATE: 2023 01 11 PROJECT: 22-176

DRAWING NO:

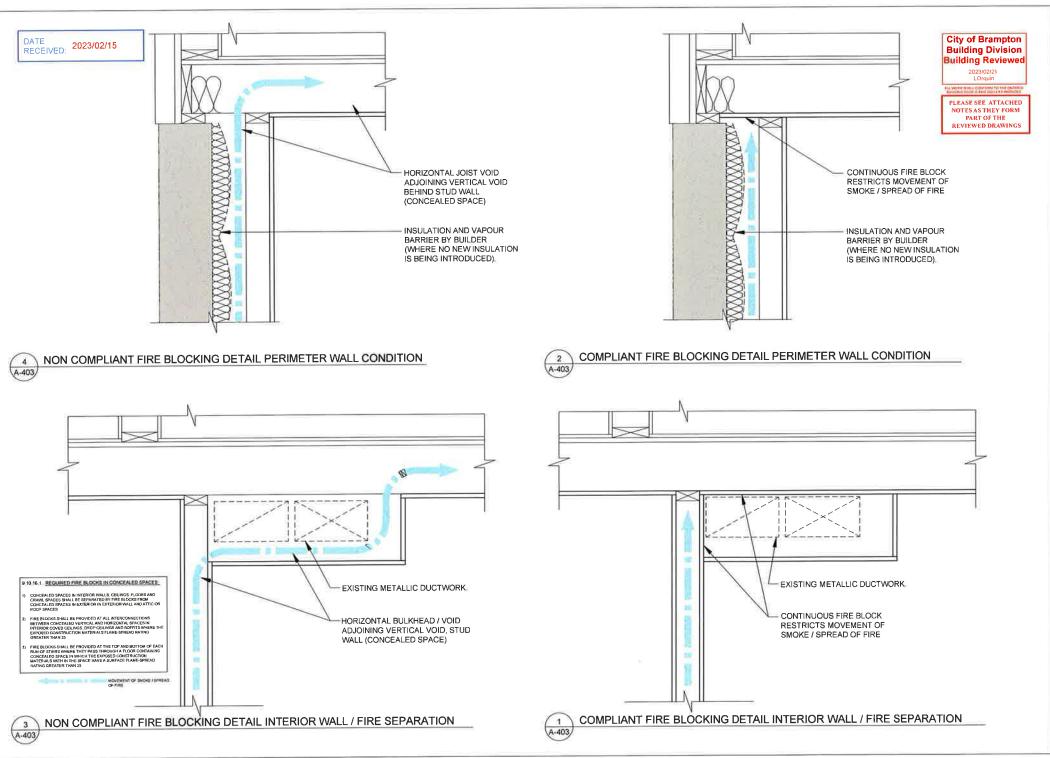

RELEASED FOR BUILDING PERMIT

CONTACTOR SALESTE VERY ALL DESCRIPTION OF A CONTACTOR SALESTE VERY ALL DESCRIPTION OF A CONTACTOR SECONDARY OF A CONTACTOR SECONDARY OF A CONTACTOR OF A CON

COPYRIGHT RESERVED

| NO | DATE | REVISION I ISSUED |
|-----|-------------|-------------------|
| in | 7922.12.20 | SCHORATE LATON |
| = | 2023-01-08 | PERMITARY, CATEN |
| 90 | 2023.01 (1) | data complete |
| 62 | ann o | CHY COMMENTS |
| | | |
| - 1 | | |

OWNER

FARZANA BAGAM



C-Architecture Ltd 10368 WINSTON CHURCHILL BLVD, HALTON HILLS ON L7G 4S7 c: 647,741,5917, e: info@c-archi.com



ALTERATIONS (SU)

72 CIRCUS CRES, BRAMPTON


FIRE BLOCKING **DETAILS**

SCALE: DATE:


2023.01.11 PROJECT: 22-176

DRAWING NO:

3/6" = 1'-0"

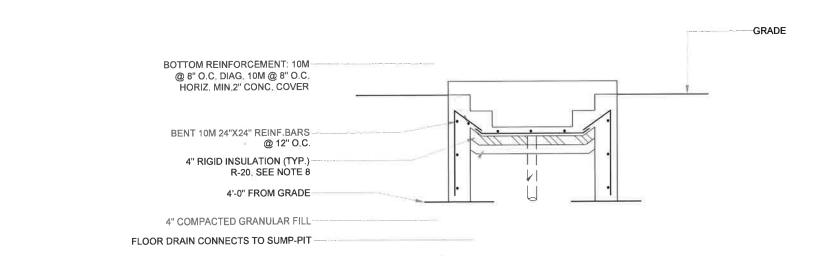



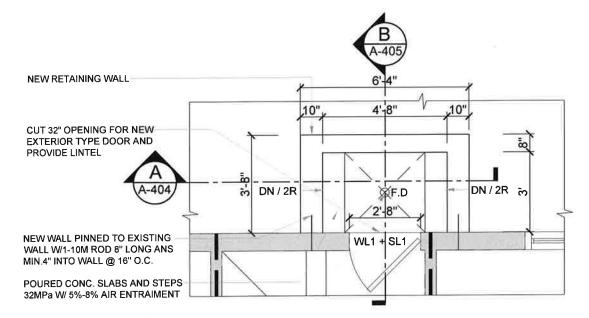

FLOOR DRAIN CONNECTS TO SUMP-PIT



RELEASED FOR BUILDING PERMIT

THIS DRAWNO IS NOT TO BE USED FOR CONSTRUCT
UNCESS SENEO BY THE ARCHTECT / PLOS
IF THIS SHEET IS NOT III I I'. I'. I' IS A REDUCE
EVEN OF THE PROPERTY OF AVAILABLE OF THE PROPERTY.

COPYRIGHT RESERVED

THE COTTENENTS TO ALL DESCRIPS AND SPARANGE ARE THE PROPERTY OF ARCHITECT REPRODUCTION OF USE FOR ANY AUTOCO OTHER DIGHT AUTHORIZED AT ARCHITECT IS

| NO | DATE | REVISION / ISSUED |
|-----|------------|--------------------|
| ac | mm.1220 | DOVEMBER CAROUT |
| 101 | 2023.01 (6 | PERMIT APPLICATION |
| 41 | 202101.00 | City Children 1 |
| * | mann | ETY COMMENTS |
| n | 202.00 | FPW1147001 |
| | | |
| | | |

OWNER

FARZANA BAGAM



C-Architecture Ltd 10368 WINSTON CHURCHILL BLVD, HALTON HILLS ON LTG 4S7 c. 647.741.5917, e: info@c-archi.com

SEAL



ALTERATIONS (SU)

72 CIRCUS CRES, BRAMPTON

WALKOUT DETAILS

SCALE: %" = 1'-0"
DATE: 2023,01,11
PROJECT: 22-176

DRAWING NO:

A-404

GENERAL NOTES

FOOTING

FOOTINGS SHALL REST ON NATURAL UNDISTURBED SOIL OR COMPACTED GRANULAR FILL WITH A MINIMUM SOIL BEARING CAPACITY OF 75 KPa

2. HANDRAILS

HANDRAILS SHOUD BE BETWEEN 34 TO 38 ABOVE THE TREAD AT THE LEADING EDGE LINE 2 IN CLEARANCE FROM THE WALL IS REQUIRED

START AND END POINT OF HANDRAILS MUST NOT OBSTRUCT PEDESTRIAN TRAFFIC OR CREATE A HAZARD BOTH SIDE HANDRAILS REQUIRED IF STAIRS ARE 43 IN OR WINDER

EXTERIOR

7 %" RISER MAXIMUM 4 %" MINIMUM 10" RUN MINIMUM 14" MAXIMUM 10" TREAD MINIMUM 14" MAXIMUM

4: RETAINING WALL

10" POURED CONCRETE WALL DOES NOT REQUIRED REBAR IF BACKFILL HEIGHT DOES NOT EXCEED 4'-7", PROVIDE 10M REBAR @12" O.C. EACH WAY FIR BACKFILL HEIGHTS EXCEEDING 4'-7"

GUARDS (PRE-ENGINEERED)

42 INCH HIGH WHERE DISTANCE FROM GRADE TO BOTTOM OF WALKOUT EXCEEDS 5'-11" 36" FOR LESSER HEIGHTS, MAMIUM 4" BETWEEN VERTICAL PICKETS

LIGHT

ELECTRIC FEED FOR THE LIGHT TO BE SEPARATE FROM ANY OTHER SWITCHED CIRCUIT

7. EXTERNAL DOOR

EXTERIOR DOOR GENERAL PERFORMANCE CRITERIA AND THERMAL RESISTANCE TO COMPLY WITH OBC 9,7,3 INSTALLATION OF MANUFACTURED AND PRE - ASSEMEBED DOOR SHALL CONFORM TO THE MANUFACTURERS INSTRUCTIONS

ALL UN FINISHED PORTIONS OF THE GRAME AND OTHER COMPONENTS OF DOORS IN CONTACT WITH THE EDGES OF MANSORY OR CONCRETE SHALL BE PROTECTED WITH CAULKING

INSULATION DETAILS


RIGID INSULATION TO HAVE FOLLOWING SPECFICATION

- STYROFOAM BRAND SM EXTRUDED POLYSTYRENE FOAM INSULATION
- RSI VALUE 0.87/25MM [R-5 PER 1 INCH]
- BOARD SIZE: AS INDICATED ON DRAWINGS]
- COMPRESSIVE STRENGTH: 210 KPa
- DRAINING CAPAICTY > 0.72 M3/ HR/ M

9. INSULATION FINISHING

INSTALL RIGID INSULATION ON EXISTING FOUNDATION WALL MIN 4FT ABOVE FOOTING INSULATION TO BE INSTALLED ON EXPOSED FOUNDATION WALL ONLY STARTING FROM GRANULAR FILL UNDER STEPS COVER INSULATION WITH 1/2" CEMENT BOARD INSTAL 21 %" GALVANIZED J TRACK ON SECURE AND PROTECT ALL EXPOSED EDGES ALL JOINTS TO THE EXISTING WALL NEW STEPS MUST BE CAULKED APPLY SEAL GUARD TO ALL JOINTS ON CEMET BOARD PARGE CEMENT BOARD OR APPLY ACRYLIC FINISH

> SECTION - B A-405/ SCALE : 3/" = 1'-0"

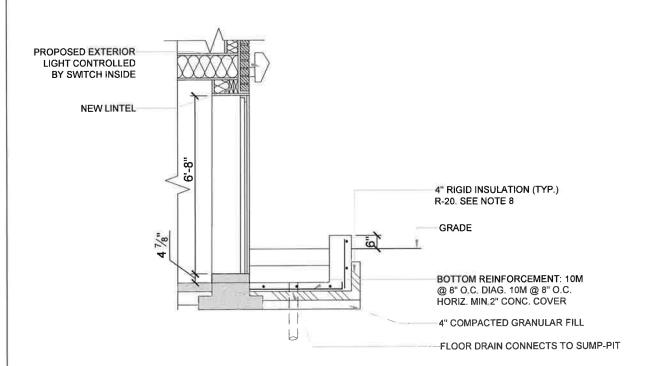



CTOR SHALL SITE VERBY ALL DIMENSIONS AND DISCREPANCIES OF ANY) TO THE CONSULTANTS CONSTRUCTION

RELEASED FOR BUILDING PERMIT

COPYRIGHT RESERVED

THE CONTROL TO ALL DESIGNS AND SANABUS ARE THE MOSTALL OF ADDITION OF ADDITION

| NO | DATE | REVISION / ISSUED |
|-----|------------|--------------------|
| = | 2023,12.00 | SCHEMIC CHOOK |
| * | 2023.01 68 | FERRIT APPLICATION |
| 41 | 2022.01 ## | city convexts |
| #¢ | 200.00 | CITY COMMENTE |
| .55 | 2023-02-08 | MANUALITATION |
| | | |
| _ | | |

OWNER

FARZANA BAGAM

C-Architecture Ltd 10368 WINSTON CHURCHILL BLVD, HALTON HILLS ON L7G 4S7 c: 647.741.5917, e: info@c-archi com



ALTERATIONS (SU)

72 CIRCUS CRES, BRAMPTON

WALKOUT **DETAILS**

SCALE:

3/6" = 1'-0" DATE: 2023 01 11

PROJECT:

22-176

DRAWING NO:

RECEIVED: 2023/02/15


City of Brampton **Building Division Building Reviewed**

PLEASE SEE ATTACHED NOTES AS THEY FORM PART OF THE REVIEWED DRAWINGS



Doing electrical work? A notification must be filed with the Electrical Safety Authority. Hiring someone to do electrical work? They must be a Licensed Electrical Contractor. It's the law.

For more information go to esasafe.com or call 1-877-372-7233.

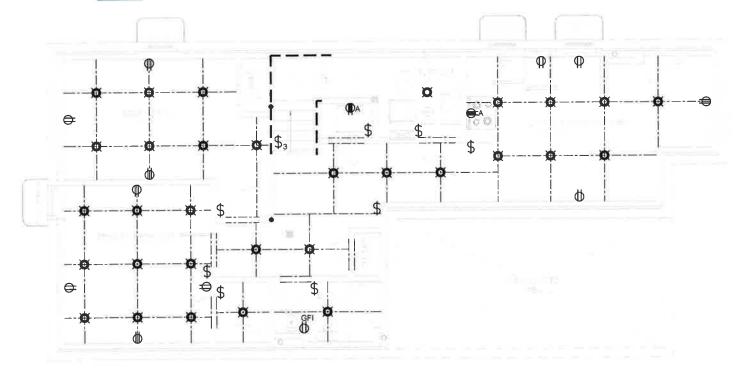

BASEMENT - ELECTRICAL LAYOUT E-101 SCALE : 16" = 1'-0"

ELECTRICAL SYMBOL:

3 OR 4 WAY SWITCH E EXISTING

15A, 120V DUPLEX RECEPTACLE SPECIFICATION GRADE, WHITE C/W WHITE COVER PLATE GFI- GROUND FAULT TYPE WP- WEATHERPROOF COVER C - ABOVE COUNTER

ELECTRICAL SYMBOL

RECEPTACLE 50A, 208V, STOVE OR DRYER OUTLET.

EXHAUST FAN 6

FD: FLOOR DRAIN

 \oplus SPRINKLER

0

EMERGENCY LIGHT (10)

SD: SMOKE ALARM W/ STROBE LIGHT CO: CARBON MONOXIDE ALARM

Ø POT LIGHT

ELECTRICAL NOTES

LOCATIONS OF ELECTRICAL ITEMS ARE APPROXIMATE, ACTUAL LOCATION MAY VARY AS PER SITE CONDITIONS

WHERE PENETRATING FIRE SEPARATION FOR POT LIGHT FIXTURES, USE FIRE RATED POT LIGHTS OR PROVIDE FIRE RATED ENCLOSURE BEHIND LIGHT FIXTURE TO ENSURE CONTINUITY OF FIRE SEPARATION

CONTRACTOR SHALL STE VISITE ALL DEDUCTIONS AND CONTRACTOR SHALL STE VISITE ALL DEDUCTIONS AND CONTRACTOR SHALL SHA

COPYRIGHT RESERVED

COPYRIGHTS TO ALL DESIGNS AND DRAWINGS ARE T

| NO | DATE | REVISION / ISSUED |
|-----|---------------|--------------------|
| = | 7072 12 36 | BOHBANC (AVOUT |
| * | 2023 01 06 | PERMIT APPLICATION |
| 81 | 2023 (1.11 | Dire COMMENSE |
| 111 | 2023 Cz (III) | dire connects |
| | | |
| | | |

OWNER

FARZANA BAGAM



C-Architecture Ltd 10368 WINSTON CHURCHILL BLVD, HALTON HILLS ON L7G 4S7 c: 647 741 5917, e: info@c-archi.com



ALTERATIONS (SU)

72 CIRCUS CRES, BRAMPTON

BASEMENT-ELECTRICAL LAYOUT

SCALE:

3/16" = 1'-0"

DATE:

2023 01 11 22-176

PROJECT:

DRAWING NO:


E-101

RECEIVED: 2023/02/15

City of Brampton **Building Division Building Reviewed**

2023/02/21 LOrquin

PLEASE SEE ATTACHED PART OF THE REVIEWED DRAWINGS

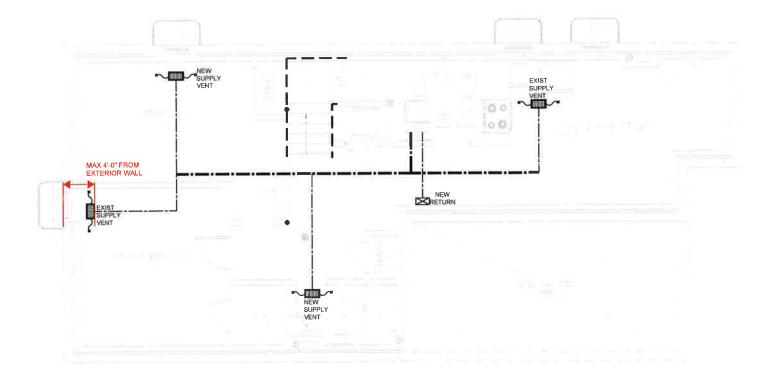



BASEMENT - MECHANICAL LAYOUT

M-101 SCALE 3/6" = 1'-0"

MECHANIAL NOTES

LOCATIONS OF MECHANICAL ITEMS ARE APPROXIMATE, ACTUAL LOCATION MAY VARY AS PER SITE CONDITIONS

DUCT-TYPE SMOKE DETECTOR TO BE INSTALLED IN THE SUPPLY OR RETURN AIR DUCT SYSTEM SERVING THE ENTIRE BUILDING THAT MUST TURN OFF THE FUEL SUPPLY AND ELECTRICAL POWER TO THE HEATING SYSTEM UPON ACTIVATION

LOCATION OF SMOKE ALARMS AS PER O.B.C.DIV B. SEC 9.10.19.3

- (1) WITHIN DWELLING UNITS, SUFFICIENT SMOKE ALARMS SHALL BE INSTALLED SO
- A. THERE IS AT LEAST ONE SMOKE ALARM INSTALLED ON EACH STOREY, INCLUDING BASEMENT AND,
- B. ON ANY STOREY OF A DWELLING CONTAINING SLEEPING ROOMS, A SMOKE ALARM IS INSTALLED
- IN EACH ROOM AND,
- IN A LOCATION BETWEEN THE SLEEPING ROOM AND THE REMINDER OF THE STOREY AND IF THE SLEEPING ROOMS ARE SERVED BY A HALLWAY, THE SMOKE ALARM SHOULD BE LOCATED IN THE HALLWAY.
- (1) PROVIDE SUPPLY AIR REGISTER (OBC DIV. B.9.33.1(1). REGISTER SHALL BE LOCATED WITHIN 4' OF OUTSIDE WALL (7.6 HRAI DIGEST REQUIREMENTS)
- (2) THE RETURN AIR GRILLE SHALL BE INSTALLED NEAR FLOOR LEVEL (7.7 HRAI DIGEST REQUIREMENTS). UNDERCUT BY MIN 1. THE DOOR TO ANY ROOM WITHOUT RETURN AIR GRILLE
- (3) CLOTHES DRYER EXHAUST SHALL COMPLY WITH OBC DIV. B.6.2.4.11 REQUIREMENTS
- (4) SEPARATE ANY INTAKES FROM BUILDING ENVELOPE PENETRATIONS THAT ARE POTENTIAL SOURCES OF CONTAMINANTS (GAS VENTS, OIL FILL PIPES, ETC. BY MIN 900MM (2'11"). OBC DIV B.9.32.3.12. ENSURE ADEQUATE VENTILATION & COMBUSTION AIR FOR THE OPTIMUM OPERATION OF THE FURNACE, PER MANUFACTURER'S REQUIREMENTS.

RELEASED FOR BUILDING PERMIT

COPYRIGHT RESERVED

- BEFORE CONSTRUCTION
 ALL DRAWNOS AND SPECEFICATIONS ARE THE PROPERTY
 OF CONSULTANTS AND MUST SE RETURNED AT THE
 COMPLETION OF WORK
 THIS ORAWNO IS NOT TO BE USED FOR CONSTRUCTION
 UNITES SENDED BY THE ARCHITECT / PEMO

THE COPYRIGHTS THE ALL DESIGNS AND SMANROSS ARE THE PROPERTY OF APCHIEGT ARPRODUCTION OR USE FOR AN

| DATE | REVISION/ISSUED |
|-------------|--------------------------|
| 2011/29 | SCHEMPTE (ARRIVE |
| 2073 01 08 | FERRITAPI(COTO) |
| 20(9)(04.4) | KITEGHANIA |
| 2023 EZ CO | CITY EDWISHTS |
| | |
| | 2072 01 08 2072 01 08 |

OWNER

FARZANA BAGAM

ARCHITECT

C-Architecture Ltd 10368 WINSTON CHURCHILL BLVD, c: 647,741,5917, e: info@c-archi.com



ALTERATIONS (SU)

72 CIRCUS CRES, BRAMPTON

BASEMENT -**MECHANICAL** LAYOUT

SCALE: 3/16" = 1'-0"

DATE: 2023.01.11 22-176

PROJECT:

DRAWING NO:

