Flower City



For Office Use Only

FILE NUMBER:

(to be inserted by the Secretary-Treasurer after application is deemed complete)

MBER: A 2023 - 0355

The Personal Information collected on this form is collected pursuant to section 45 of the Planning Act and will be used in the processing of this application. Applicants are advised that the Committee of Adjustment is a public process and the information contained in the Committee of Adjustment files is considered public information and is available to anyone upon request and will be published on the City's website. Questions about the collection of personal information should be directed to the Secretary-Treasurer, Committee of Adjustment, City of Brampton.

APPLICATION

Minor Variance or Special Permission (Please read Instructions) NOTE: It is required that this application be filed with the Secretary-Treasurer of the Committee of Adjustment and be accompanied by the applicable fee. The undersigned hereby applies to the Committee of Adjustment for the City of Brampton under section 45 of the Planning Act, 1990, for relief as described in this application from By-Law 270-2004. Name of Owner(s) FARZANA BAGAM Address 72 CIRCUS CRES, BRAMPTON, ON L7A 0H1 Fax# Phone # 416.830.8457 Email mortgagewithmustafa@outlook.com ARSHAD SIDDIQUI Name of Agent Address 202 - 3485 REBECCA ST, OAKVILLE, ON L6L 0H4 Fax# Phone # **Email** Nature and extent of relief applied for (variances requested): MINOR VARIANCE REQUEST IN REQUIRED SETBACK FOR PROPOSED BELOW GRADE STAIRS AS PRIMARY MEANS OF ENTRANCE AND EXIT FOR PROPSOED SECOND UNIT REQUIRED SETBACK IS 0.3M PER ZONING BY-LAW. PROPOSED SETBACK OF 0.12 REQUIRES MINOR VARIANCE APPROVAL OF 0.18M. Why is it not possible to comply with the provisions of the by-law? EXISTING SIDEYARD ENTRANCE REQUIRED BELOW GRADE STEPS DUE TO SITE CONDITION

Legal Description of the subject land: Lot Number 5 Plan Number/Concession Number PLAN 43M-2074 Municipal Address 72 CIRCUS CRES, BRAMPTON, ON L7A 0H1 Dimension of subject land (in metric units) Frontage 9.150 M Depth 27.50 M Area

Access to the subject land is by: Provincial Highway
Municipal Road Maintained All Year

Private Right-of-Way

Seasonal Road Other Public Road Water

7	
1	

17.	Is the subject property the subject subdivision or consent?	ect of an application under the	ne Planning Act, for app	proval of a plan of
	Yes No			
	If answer is yes, provide details:	File # NA	Status NA	
18.	Has a pre-consultation application	on been filed?		
	Yes No 🗸			
19.	Has the subject property ever be	en the subject of an applicat	ion for minor variance?	•
	Yes No	Unknown		
	If answer is yes, provide details:			
	File # NA Decision File # NA Decision		Relief NA Relief NA	
	File # NA Decision		Relief NA	
			MS.	
		Signature	of Applicant(s) or Author	rized Agent
DAT	ED AT THE CITY	OF BRAM	, , , ,	
	DAY OF NOVER	UBER , 20 23		
	APPLICATION IS SIGNED BY AN		PERSON OTHER THA	N THE OWNER OF
	JECT LANDS, WRITTEN AUTHOR PLICANT IS A CORPORATION,			
	ATION AND THE CORPORATION'			
	, M. ARSHAD SIDDIQUI	, OF THE	TOWN OF OA	KVILLE
IN THI	REGION OF HALTON	SOLEMNLY DECI	_ARE THAT:	
ALL OF	THE ABOVE STATEMENTS ARE T	RUE AND I MAKE THIS SOL	LEMN DECLARATION C	ONSCIENTIOUSLY
BELIEVIN OATH.	IG IT TO BE TRUE AND KNOWING	G THAT IT IS OF THE SAME I	FORCE AND EFFECT A	a Commissioner, etc.,
DECLAR	ED BEFORE ME AT THE	i i i i i		Province of Ontario
CITY	OF BRAMPTON	! ! ! ! !		for the Corporation of the
IN THE	REGION OF		8.1	City of Brampton Expires September 20, 2026
PEEL	THIS THE COM DAY OF	η	ishey	Coptember 20, 2026
	November 20 23	Signatu	re of Applicant or Authori	zed Agent
	1	J. J	Submit by Email	
	A Commissioner etc.	i 	Submit by Email	
	// Commissioner etc.	i		
		FOR OFFICE USE ONLY		
	Present Official Plan Designation	on:		
	Present Zoning By-law Classific	cation:	R1F-2888	
	This application has been review said review	ved with respect to the variance we are outlined on the attached		ts of the
	John C. Cabral Zoning Officer		2023-10-12 Date	
		R1	2 = 5	
	DATE RECEIVED		423	Revised 2022/02/17
	Date Application Deemed		_	

			-2-
8.	land: (specify	<u>in metric units</u> gı	structures on or proposed for the subject round floor area, gross floor area, number of c., where possible)
		SISTRUCTURES on th IAL BUILDING: 214	e subject land: List all structures (dwelling, shed, gazebo, etc.) .07 SM GFA
	PROPOSED BUILDII	NGS/STRUCTURES on	the subject land:
	NA		
9.		-	uctures on or proposed for the subject lands: and front lot lines in <u>metric units</u>)
	EXISTING		
	Front yard setback	6.63 M 15.53 M	
	Rear yard setback Side yard setback	1.48 M	
	Side yard setback	4.24 M	
	PROPOSED		
	Front yard setback	2.35 M	
	Rear yard setback	7.60 M	
	Side yard setback Side yard setback	0.00 M 1.24 M	
	Side yard Setback	1.2.7 (0)	
10.	Date of Acquisition	of subject land:	2022
11.	Existing uses of sul	oject property:	RESIDENTIAL
12.	Proposed uses of s	ubject property:	RESIDENTIAL
13.	Existing uses of ab	utting properties:	RESIDENTIAL
14.	Date of construction	n of all buildings & stru	uctures on subject land: 2022
15.	Length of time the	existing uses of the sul	oject property have been continued: 2YEARS
16. (a)	What water supply Municipal Well	is existing/proposed?]]	Other (specify) NA
(b)	What sewage dispo Municipal v Septic	sal is/will be provided]]	? Other (specify) NA
(c)	What storm drainag	je system is existing/p	roposed?
	Sewers Ditches		Other (specify) NA
	Swales	7	

APPOINTMENT AND AUTHORIZATION OF AGENT

To: The Secretary-Treasurer
Committee of Adjustment
City of Brampton
2 Wellington Street West
Brampton, Ontario
L6Y 4R2

LOCATION OF THE SUBJECT LAND: 72 CIRCUS CRES, BRAMPTON, ON L7A 0H1
I/We, FARZANA BAGAM
please print/type the full name of the owner(s)
the undersigned, being the registered owner(s) of the subject lands, hereby authorize
M. ARSHAD SIDDIQUI
please print/type the full name of the agent(s)
to make application to the City of Brampton Committee of Adjustment in the matter of an application for minor variance with respect to the subject land.
Dated this 3RD day of AUGUST , 20 23 .
Fos James
(signature of the owner[s], or where the owner is efirm or corporation, the signature of an officer of the owner.)
(where the owner is a firm or corporation, please print or type the full name of the person signing.)
NOTE: If the owner is a firm or corporation, the corporate seal shall be affixed hereto.

NOTE: Unit owners within a Peel Standard Condominium Corporation are to secure authorization from the Directors of the Condominium Corporation in a form satisfactory to the City of Brampton, prior to submission of an application. Signatures from all Members of the Board of Directors are required.

PERMISSION TO ENTER

To: The Secretary-Treasurer
Committee of Adjustment
City of Brampton
2 Wellington Street West
Brampton, Ontario
L6Y 4R2

LOCATIO	ON OF THE	SUBJE	CT LAND: 72 C	IRCUS CRES, BRAMPTON, O	N L7A 0H1	
I/We,	FARZANA BAGA	ιM				
			please	print/type the full nam	ne of the owner(s)	
the City the abov	of Brampto e noted pro	n Commoperty fo	nittee of Adjus	stment and City of of conducting a si	Brampton staff	uthorize the Members of members, to enter upon a respect to the attached
Dated th	i S 3RD	day of	AUGUST	ANALYSIS STOREGON AND ANALYSIS OF THE STOREGO	, 20 23	
				Forger		
(sign	ature of the o	wner[s], o	r where the own	er is a ff m or corporat	ion, the signature of	an officer of the owner.)
	(where the	owner is a	firm or corporati	ion, please print or typ	e the full name of the	e person signing.)

NOTE: If the owner is a firm or corporation, the corporate seal shall be affixed hereto.

NO DISCUSSION SHALL TAKE PLACE BETWEEN THE COMMITTEE MEMBERS AND THE APPLICANT DURING THE SITE INSPECTION

APPOINTMENT AND AUTHORIZATION OF AGENT

To: The Secretary-Treasurer
Committee of Adjustment
City of Brampton
2 Wellington Street West
Brampton, Ontario
L6Y 4R2

LOCATION	OF THE SUBJECT LAND: 72 CIRCUS CRES, BRAMPTON, ON L7A 0H1
I/We, FAI	RZANA BAGAM
	please print/type the full name of the owner(s)
the undersi	gned, being the registered owner(s) of the subject lands, hereby authorize
M. ARSHAD SIDDI	IQUI
	please print/type the full name of the agent(s)
	pplication to the City of Brampton Committee of Adjustment in the matter of an for minor variance with respect to the subject land.
Dated this 3	day of AUGUST , 20 23 .
	Feb 2000
(signatu	re of the owner[s], or where the owner is a firm or corporation, the signature of an officer of the owner.)
(v	where the owner is a firm or corporation, please print or type the full name of the person signing.)
(-	

NOTE: Unit owners within a Peel Standard Condominium Corporation are to secure authorization from the Directors of the Condominium Corporation in a form satisfactory to the City of Brampton, prior to submission

NOTE: If the owner is a firm or corporation, the corporate seal shall be affixed hereto.

of an application. Signatures from all Members of the Board of Directors are required.

PERMISSION TO ENTER

To: The Secretary-Treasurer
Committee of Adjustment
City of Brampton
2 Wellington Street West
Brampton, Ontario
L6Y 4R2

LOCATI	ION OF THE	E SUBJEC	CT LAND: 72 CIF	RCUS CRES, BRAMPTON, G	ON L7A 0H1	
I/We,	FARZANA BAG	6AM		****		
,			please	print/type the full nar	ne of the owner(s)	
the City the abo	of Bramptove noted pr	on Commoperty for	nittee of Adjust	tment and City o of conducting a s	f Brampton staff m	thorize the Members of embers, to enter upon respect to the attached
Dated t	his 3RD	day of	AUGUST		, 20 <u>²³</u> .	
				Follows		
(sig	nature of the	owner[s], o	r where the owne	r is a ffm or corpora	tion, the signature of a	n officer of the owner.)
	(where the	owner is a	firm or corporation	on, please print or ty	oe the full name of the	person signing.)

NOTE: If the owner is a firm or corporation, the corporate seal shall be affixed hereto.

NO DISCUSSION SHALL TAKE PLACE BETWEEN THE COMMITTEE MEMBERS AND THE APPLICANT DURING THE SITE INSPECTION

PROPOSED BASEMENT RENOVATIONS

72 CIRCUS CRES, BRAMPTON

FARZANA BAGAM

ISSUED FOR: BASEMENT APARTMENT PERMIT APPLICATION

ISSUE DATE: JANUARY 11, 2023

NAM	E OF PROJECT PROP	OSED BASE	MENT R	ENOVAT	ION	
LOC	ATION 72 CIF	CUS CRES,	BRAMP	TON		
TEM	ONTARIO BU	ILDING CODE D	ATA MAT	RIX	OBC REFER	ENCE
	PROJECT DESCRIPTION:	□ NEW		☐ PART 11		✓ PART
1		ADDITION	1.1	1.1 TO 11.4		2.1.1
	☐ CHANGE OF USE	✓ ALTERATIO	N			9.10.1.3
2	MAJOR OCCUPANCY(S)	С				9.10.2
3	BUILDING AREA (m)2 EX	ISTING 106.98 NEW (TOTAL	106.98		1.1.3.2
4	GROSS AREA (m) ² EX	ISTING 301.03 NEW	0 TOTAL	301.03		1.1.3.2
4a	AREA OF WORK (m)2	86.96				
5	NUMBER OF STOREYS	ABOVE GRADE: 2 BE	LOW GRADE:	1		2.1.1.3
6	NUMBER OF STREET/ACCESS	ROUTES 1				9.10.19
7	BUILDING CLASSIFICATION					9.10.4
8	SPRINKLER SYSTEM PROPOS	SED ENTIF	RE BUILDING			9.10.8
		☐ BASE	MENT ONLY			
		☐ IN L	IEU OF ROOF RA	ATING		
		™ NOT	REQUIRED			
9	STANDPIPE REQUIRED	☐ YES	M NO			9.10.17.2
10	FIRE ALARM REQUIRED	☐ YES	M NO			
11	WATER SERVICE/SUPPLY IS	ADEQUATE YES	□ NO			N/A
12	HIGH BUILDING	☐ YES	M NO	,		N/A
13	PERMITTED CONSTRUCTION	COMBUSTIBLE NON-C	OMBUSTIBLE	Вотн		9.10.6
	ACTUAL CONSTRUCTION	COMBUSTIBLE NON-C	OMBUSTIBLE	□ вотн		
14	MEZZANINE(S) AREA (M)	N/A	,			9.10.4.1
15	OCCUPANT LOAD BASED ON		100000000000000000000000000000000000000	OF BUILDING		9.9.1.3
	BASEMENT:	OCCUPANCY		PERSON PERSON		
	1 ST. FLOOR 2 ST. FLOOR	OCCUPANCY		PERSON		
	3 ST. FLOOR	OCCUPANCY	LOAD _	PERSON		
16	BARRIER-FREE DESIGN	☐ YES M NO	(EXPLAIN)	N/A		9.5.2
17	HAZARDOUS SUBSTANCES	☐ YES M NO				9.10.1.3
18	DECLUDED FIDE	HORIZONTAL ASSEMBLI		TED DESIGN NO		9.10.8
18	REQUIRED FIRE RESISTANCE RATING	FRR (HOURS)	ORD	TED DESIGN NO. ESCRIPTION (SG-2	2)	9.10.9
	(FRR)	FLOORS N/A HOURS				
		ROOF HOURS				
		MEZZANINE HOURS				
		FRR OF SUPPORTING MEMBERS	LIS OR D	TED DESIGN NO. ESCRIPTION (SG-2	2)	
		FLOORS N/A HOURS				
		ROOF HOURS				
		MEZZANINE HOURS				



HALTON HILLS ON L7G 4S7

Project #:

LIST OF ARCHITECTURAL DRAWINGS

COVER SHEET & OBC MATRIX A-000 A-001 SITE PLAN A-002 **GENERAL NOTES** A-101 BASEMENT - EXISTING LAYOUT A-102 BASEMENT - PROPOSED LAYOUT A-103 MAIN FLOOR - EXISTING LAYOUT SECOND FLOOR - EXISTING LAYOUT A-104 A-201 NORTH ELEVATION A-401 EGRESS WINDOW DETAIL A-402 TYPICAL DETAILS A-403 FIRE BLOCKING DETAILS WALKOUT DETAILS A-404 WALKOUT DETAILS A-405 BASEMENT - ELECTRICAL LAYOUT E-101 BASEMENT - MECHANICAL LAYOUT M-101

PROJECT TEAM:

ARCHITECT

22-176

C-ARCHITECTURE LTD. M. ARSHAD SIDDIQUI, OAA C: 647.741.5917 E: arshad@c-archi.com

NOTES:

1. PROVIDE INTERCONNECTED SMOKE ALARMS IN BOTH DWELLING UNITS. (THROUGHOUT THE ENTIRE BUILDING) 2. HORIZONTAL FIRE SEPARATION BETWEEN TWO DWELLING UNITS SHALL COMPLY WITH O.B.C. REQUIREMENTS REFER SECTION 11.5.1.1.C (C152) WHICH PRESCRIBES IT TO BE 15 MINUTES

FIRE SEPARATION O.B.C 9.10.9.14 9.10.8.1

C152 9.10.9.14.(1) AND (3): 9.10.9.15.(1) (B) IN DETACHED HOUSES, SEMI-DETACHED HOUSES, TOWNHOUSES AND ROW HOUSES CONTAINING NOT MORE THAN TWO DWELLING UNITS, 15 MIN

HORIZONTAL FIRE SEPARATION IS ACCEPTABLE WHERE, (I) SMOKE ALARMS ARE INSTALLED IN EVERY DWELLING UNIT AND IN COMMON AREAS IN

CONFORMANCE WITH SUBSECTION 9.10.19., AND (II) SMOKE ALARMS ARE INTERCONNECTED.

(C) IN DETACHED HOUSES, SEMI-DETACHED HOUSES, TOWNHOUSES AND ROW HOUSES CONTAINING NOT MORE THAN TWO DWELLING UNITS, THE FIRE-RESISTANCE RATING OF THE FIRE SEPARATION IS WAIVED WHERE BUILDING IS SPRINKLERED.

C147 9.10.8.1.; 9.10.8.3.; 9.10.8.8. (B) IN DETACHED HOUSES, SEMI-DETACHED HOUSES, TOWNHOUSES AND ROW HOUSES CONTAINING NOT MORE THAN TWO DWELLING UNITS, 15 MIN HORIZONTAL FIRE SEPARATION IS ACCEPTABLE WHERE,

(I) SMOKE ALARMS ARE INSTALLED IN EVERY DWELLING UNIT AND IN COMMON AREAS IN CONFORMANCE WITH SUBSECTION 9.10.19., AND

(II) SMOKE ALARMS ARE INTERCONNECTED. NUMBER OF EXITS:

(O.B.C 9.9.8)

C136 9.9.9. IN DETACHED HOUSES, SEMI-DETACHED HOUSES. TOWNHOUSES AND ROW HOUSES CONTAINING NOT MORE THAN TWO DWELLING UNITS, EXIT REQUIREMENTS ARE ACCEPTABLE IF AT LEAST ONE OF THE FOLLOWING CONDITIONS EXISTS:

BEDROOM WINDOWS: (A) A DOOR, INCLUDING A SLIDING DOOR, THAT OPENS DIRECTLY TO THE EXTERIOR FROM A DWELLING UNIT, SERVES ONLY THAT DWELLING UNIT AND HAS REASONABLE ACCESS TO GROUND LEVEL, AND THE DWELLING UNITS ARE EQUIPPED WITH SMOKE ALARMS INSTALLED IN

CONFORMANCE WITH SUBSECTION 9.10.19., C137 9.9.10.1, IN DETACHED HOUSES, SEMI-DETACHED HOUSES, TOWNHOUSES AND ROW HOUSES CONTAINING NOT MORE THAN TWO DWELLING UNITS, EXISTING ACCEPTABLE, WHERE THERE IS DIRECT ACCESS TO THE EXTERIOR.

C108 9.7 EXISTING ACCEPTABLE.

WINDOW SIZES: C107 9.7.2.3. (A) WHERE WINDOWS ARE NOT USED AS A MEANS OF EGRESS AND WHERE THEY DO NOT CONFLICT WITH VENTILATION REQUIREMENTS. THE MINIMUM GLASS AREAS AS SHOWN IN TABLE 9.7.2.3. MAY BE REDUCED BY 50%

TO BE OPERABLE FORM INSIDE WITHOUT USE OF ANY TOOLS UNOBSTRUCTED OPEN PORTION HAVING A MINIMUM AREA OF 0.35 SM / 3.8 SFT WITH NO DIMENSION LESS THAN 1'-3" 380MM)

ALL WORK SHOULD COMPLY WITH ONTARIO BUILDING CODE 2012.

DIV. B. O.B.C 9.10.19 9.33.4.2

AN EGRESS WINDOW FROM THE BASEMENT FLOOR AREA WITH A MINIMUM OPEN AREA 3.8 FT2 AND NO DIMENSION LESS THAN 15", HARDWIRED AND INTERCONNECTED SMOKE ALARMS IN EACH BEDROOM, AND A HARDWIRED AND INTERCONNECTED CO DETECTOR.

MINIMUM CEILING HEIGHTS FOR BASEMENT SPACES 5 YEARS OR GREATER IN AGE IS 6'-5" OVER THE BASEMENT AREA INCLUDING UNDER BEAMS AND DUCTS.

DIV. B. O.B.C 9.33.1.1.(1)

SUPPLY AIR OUTLIETS ARE REQUIRED IN EACH FINISHED ROOM OR SPACE, PROVIDE AT LEAST ONE RETURN OUTLET PER FLOOR LEVEL. UNDERCUT DOORS TO ROOMS WHERE RETURN AIR IS NOT PROVIDED. LOW WALL SUPPLY AND RETURN OUTLETS ARE RECOMMENDED.

O.B.C 7.6.5.1.(1)


EACH NEW PLUMBING FIXTURE REQUIRES A MIXING VALVE TO ENSURE THAT THE MAXIMUM TEMPERATURE OF HOT WATER SUPPLIED BY FITTINGS TO THE FIXTURE DOES NOT EXCEED 49°C. ALTERNATIVELY PROVIDE A MIXING VALVE ON THE HOT WATER HEATER TO ENSURE THAT THE WATER SUPPLIED TO ALL FIXTURES DOES NOT EXCEED 49°C.

INSULATION IS REQUIRED IN THE FLOOR JOISTS ABOVE WALLS. SEPARATING FINISHED AND UNFINISHED PORTIONS. ENSURE THE DOOR

TO THE UTILITY ROOM IS MINIMUM 32" WIDE.

PART 2 (SURVEY REPORT) SURVEYOR'S REAL PROPERTY REPORT NOTES REGISTERED EASEMENTS AND/OR RIGHT-OF-WAYS: NONE DENOTES MONUMENT FOUND PART 1 THIS PLAN DOES NOT CERTIFY COMPLIANCE WITH ZONING BY-LAWS DENOTES MONUMENT SET PLAN OF LOTS 2, 3, 4, 5, DENOTES IRON BAR IB DENOTES PLASTIC BAR PB SURVEYOR'S CERTIFICATE 6, 7 AND 8 DENOTES SHORT STANDARD IRON BAR SSIB DENOTES PROPERTY IDENTIFIER NUMBER I CERTIFY THAT: P.I.N. PLAN 43M-2074 (WIT) DENOTES WITNESS 1. THIS SURVEY AND PLAN ARE CORRECT AND IN ACCORDANCE DENOTES PLAN 43M-2074 PL. WITH THE SURVEYS ACT, THE SURVEYORS ACT AND THE LAND CITY OF BRAMPTON DENOTES DWELLING UNDER CONSTRUCTION D.U.C. TITLES ACT AND THE REGULATIONS MADE UNDER THEM. DENOTES PORCH REGIONAL MUNICIPALITY OF PEEL DENOTES TOP OF WALL ELEVATION 2. THE SURVEY WAS COMPLETED ON THE 24th DAY OF SEPTEMBER ,2019. TOW SCALE 1:300 ALL FOUND MONUMENTS BY SCHAEFFER DZALDOV Nov. 8 20metres 5m BENNETT LTD., O.L.S. ALL TIES TO CONCRETE FOUNDATIONS R-PE SURVEYING LTD., O.L.S. METRIC T. SINGH BEARINGS ARE GRID AND ARE REFERRED TO THE DISTANCES SHOWN ON THIS PLAN ARE IN METRES AND CAN ONTARIO LAND SURVEYOR NORTHWEST LIMIT OF CIRCUS CRESCENT AS SHOWN ON BE CONVERTED TO FEET BY DIVIDING BY 0.3048. PLAN 43M-2074 HAVING A BEARING OF N38'22'25"E. CALLANDAR ROAD PILAN 45W (BY PLAN 43M-2022) P.I.N. 14251-4131 LOT 398 | LOT 399 | LOT 400 | LOT 401 | LOT 402 LOT 403 LOT 404 LOT 397 BLOCK 431 P.I.N. 14251-4094 P.I.N. 14251-4095 P.I.N. 14251-4096 P.I.N. 14251-4097 P.I.N. 14251-4098 P.I.N. 14251-4099 P.I.N. 14251-4100 (0.30 RESERVE) P.I.N. 14251-4127 P.I.N. 14251-4093 25" E 22' N38° ====== 9.150 11.600 11.600 .37,35"W 11.600 LOT 8 LOT OT 6 LOT LOT 5 ASSOCIATION OF ONTARIO LOT 3 LOT 2 7.0 P.I.N. 7.6 LAND SURVEYORS P.I.N. P.I.N. P.I.N. 7.5 P.I.N. P.I.N. 14251-4621 迈_{18.5} 14251--4616 7.0 14251--4617 14251-4620 4251-4619 5 PLAN SUBMISSION FORM 14251-4615 14251-4618 ROAD 2074) 8.7 2105689 0.62-0.65 0.65 -0.63 0.65-CALLANDAR (BY PLAN 43M--1.21 0.67-ART 2 43R-39172 PART 8 (C) (D) ART 7 THIS PLAN IS NOT VALID UNLESS IT IS AN EMBOSSED D.U.C. D.U.C. D.U.C. D.U.C. ISSUED BY THE SURVEYOR In accordance with \$5. \$0. NI PLAN Regulation 1026, Section 29(3). 0.61 0.62 -0.65 0.62-SSIR 6.05 5.63 5.75 5.56 4.91 2 PL&SET 9,150 i PL&SET 2.35 9.150 PL&MEAS PL&SET 11.600 PL&SET 9.150 44.738 7,856 25"E SSIB 22' SSIB N38° LSTREET LINE CRESCENT **CIRCUS** -/py nLAN 43M--2074) R-PE SURVEYING LTD.
ONTARIO LAND SURVEYORS **DOCUMENTS RELEASED PURSUANT TO A REQUEST** .N. 14251-4960 645 Christed Road, Suite /, Woodbridge, Ontario, L4L 8A3 Te. (ዶኒቴ)695\$\$5000TTACdkE(1416)635-5001 UNDER THE MUNICIPAL FREEDOM OF INFORMATION AND THIS REPORT WAS PREPARED FOR MATTAMY HOMES (905)7E644-SOBHEY FORM (905)264-2099 PROTECTION OF PRIVACY ACT R.S.O. 1990c. M56 Website: WWWRT OF THE DRAWINGS CAD FILE NO. 2074-2 AND THE UNDERSIGNED ACCEPTS NO CHECKED: G.Y. /T.S. RESPONSIBILITY FOR USE BY OTHER PARTIES COPYRIGHT ACT R.S., 1985, c. C-42 APPLIES TO THE JOB No. 19-157 **USE AND REPRODUCTION OF THESE DOCUMENTS** (C)R-PE SURVEYING LTD., O.L.S., 2019

19-157 *43M-2074 L2-8*

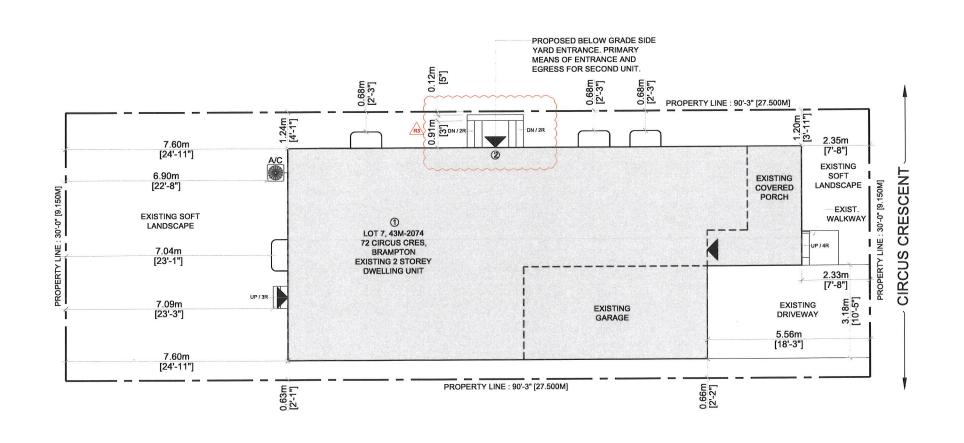



SITE PLAN SCALE : 1/4" = 1'-0"

LEGEND



PROPERTY LINE



ENTRANCE & EGRESS

PARKING SPACES PROVIDED

TWO PARKING SPACES PROVIDED (ONE OUTSIDE & ONE INSIDE THE GARAGE)

AREA STATISTICS

GROSS FLOOR AREA CALCULATIONS A - EXISTING PRINCIPAL RESIDENCE **EXISTING MAIN FLOOR AREA** GARAGE AREA EXISTING SECOND FLOOR AREA TOTAL ABOVE GRADE GFA **B - EXISTING BASEMENT** BASEMENT AREA PART OF PRICIPAL RESIDENCE = 00.00 SFT / 00.00 SM

NEW BASEMENT APARTMENT GFA **FURNACE AREA** TOTAL BASEMENT GFA BASEMENT APARTMENT GFA IS 37.29 % OF PRINCIPAL RESIDENCE GFA

TOTAL LOT AREA: 2708 SFT / 251.67 SM

= 935.77 SFT / 86.96 SM = 214.40 SFT / 19.92 SM

= 1152.22 SFT / 107.08 SM = 2,303.4 SFT / 214.07 SM

= 880 SFT / 81.78 SM = 55.80 SFT / 5.18 SM = 935.77 SFT / 86.96 SM

SCOPE OF WORK

(1) BASEMENT APARTMENT

② PROPOSED BELOW GRADE SIDE YARD ENTRANCE. PRIMARY MEANS OF ENTRANCE AND EGRESS FOR SECOND UNIT

SITE LOCATION

72 CIRCUS CRES, BRAMPTON



RELEASED FOR BUILDING PERMIT

CONFIGURED SHALL BET VERYE ALL DISCOSSIONS AND CONFIGURED SHALL BET VERYE ALL DISCOSSIONS AND SECONDARY ALL DISCOSSIONS AND SECONDARY AND SECO

THE COPYRIGHTS TO ALL DESIGNS AND DRAWINGS ARE THE PROPERTY OF ARCHITECT, REPRODUCTION OR USE FOR ANY PURPOSE OTHER THAN THAT AUTHORIZED BY ARCHITECT IS FORBIDDEN.

NO	DATE	REVISION / ISSUED
00	2022.12.28	SCHEMATIC LAYOUT
00	2023.01.06	PERMIT APPLICATION
01	2023.01.11	CITY COMMENTS
05	2023.02.03	CITY COMMENTS
03	2023.02.08	PERMIT REVISION



FARZANA BAGAM



-Architecture Ltd

10368 WINSTON CHURCHILL BLVD, HALTON HILLS ON L7G 4S7 c: 647.741.5917, e: Info@c-archl.com



ALTERATIONS (SU)

72 CIRCUS CRES, BRAMPTON

SITE PLAN

SCALE: DATE:

1/8" = 1'-0" 2023.01.11

PROJECT: DRAWING NO:

22-176

SPECIFICATION:

- (1) FOUNDATION WALL INSULATION EXISTING FOUNDATION WALL, MOISTURE BARRIER, 2 BY 4 STUDS @ 16" O.C., R12 INSULATION, 6 MIL POLYETHYLENE V.B., 3" GYPSUM DRYWALL JOINTS TAPED AND SEALED AND PAINTED.
- (1A) NOT USED

RECEIVED: 2023/02/15

INTERNAL WALLS (2)

1/2" DRY WALL ON BOTH SIDES OF NEW OR EXISTING FRAMED WALL CONSISTING OF 2 BY 4 WOOD STUDS @ 16" O.C. WITH JOINTS TAPED AND SEALED. SB-3: W1 (WATER RESISTANT GWB ON BATHROOMS' WALLS).


INTERNAL WALLS

1/2" TYPE X DRYWALL ON BOTH SIDES OF NEW OR EXISTING FRAMED WALL CONSISTING OF 2 BY 4 WOOD STUDS @ 16" O.C. WITH ABSORPTIVE MATERIAL (INSULATION), SB-3: W1b, FIRE RESISTANCE: 45 MIN, STC: 34

- 2B NOT USED
- √3>> CEILING

1/2" DRY WALL CEILING ATTACHED TO BOTTOM OF JOISTS OF FLOOR ASSEMBLY ABOVE. SB-3: F3e

- √3A>> NOT USED
- √3B 5/8" TYPE X DRY WALL CEILING ATTACHED TO BOTTOM OF JOISTS OF FLOOR ASSEMBLY ABOVE . SB-3: F3b. FIRE RESISTANCE: 31 MIN, STC: 30.
- √3C > NOT USED
- 20 MIN. RATED DOOR FOR FURNACE ROOM AND BETWEEN BASEMENT APARTMENT AND BASEMENT AREA WHICH IS PART OF PRINCIPAL RESIDENCE
- EXISTING DUCT WORK LOCATED IN THE CEILING SHALL BE RELOCATED SO THAT THE DIRECTION OF THE HEAT FLOW IS TOWARDS THE FLOOR
- MECHANICAL VENTILATION 6 5 L/S EXHAUST FANS IN KITCHEN AND WASHROOM AND 37.5 L.S FOR PRINCIPAL **EXHAUST**
- INTERCONNECTED AND WIRED SMOKE ALARMS AT EACH FLOOR AND EACH UNIT INCLUDING FINISHED BASEMENT AND LEGAL BASEMENT THROUGH ENTIRE HOUSE ALARM - AS PER OBC 9.10.19.
- PERMANENTLY CONNECTED TO ELECTRICAL CIRCUIT CARBON MONOXIDE DETECTOR AS PER OBC 2012 B 9.33.4.3.
- FOR ALL ELECTRICAL WORK AND PERMIT CONTACT ELECTRICAL SAFETY **AUTHORITY**
- SELF CONTAINED EMERGENCY LIGHTING UNIT CONFORMING TO CSA C22.2 NO.141. *EMERGENCY LIGHTING EQUIPMENT* - AS PER OBC 9.9.12

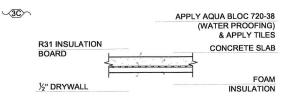

PORCH TO BE FINISHED WITH TILES

SCHEDULES

ROOM FINISH SCHEDULE

		FLO	OR	ВА	SE	WA	LLS	CEIL	ING	UEIQUE	DEMARKS
RM. NO	ROOM NAME	MATERIAL	FINISH	MATERIAL	FINISH	MATERIAL	FINISH	MATERIAL	FINISH	HEIGHT	REMARKS
BASEMI	ENT FLOOR										
1	LIVING / DINING	WOOD	STAIN	VINYL		DRYWALL	PAINT	DRYWALL	PAINT	7'-8"	
2	KITCHEN	WOOD	STAIN	VINYL		DRYWALL	PAINT	DRYWALL	PAINT	7'-8"	
3	BEDROOM	WOOD	STAIN	VINYL		DRYWALL	PAINT	DRYWALL	PAINT	7'-8"	
4	STORAGE	WOOD	STAIN	VINYL		DRYWALL	PAINT	DRYWALL	PAINT	7'-8"	
5	CLOSET	WOOD	STAIN	VINYL		DRYWALL	PAINT	DRYWALL	PAINT	7'-8"	
6	BATH	CERAMIC		VINYL		DRYWALL	PAINT	DRYWALL	PAINT	7'-3"	

DOOR SCHEDULE

1. ALL INTERIOR DOORS ARE SLAB DOOR 1-3/8 TH. HOLLOW CORE OR SLIDING DOORS. THE SIZES ARE MENTIONED ON THE FLOOR PLAN. THE HEIGHT OF ALL DOORS ARE 80".

2. ALL FIRE RATED DOORS SHALL HAVE SELF-CLOSING DEVICES

GENERAL NOTES

- ALL WORK ACCORDING TO ONTARIO BUILDING CODE 2012 AND AHJ BY-LAWS AND **STANDARDS**
- ALL DIMENSIONS AND LOCATIONS TO BE VERIFIED ON SITE PRIOR TO CONSTRUCTION.
- ALL WOOD USED IN THE CONSTRUCTION SHALL BE SPF NO.1 OR NO.2
- MINIMUM BEARING OF STEEL LINTELS 150 MM.
- MINIMUM BEARING OF WOOD BEAM / LINTELS 90 MM
- MINIMUM BEARING OF WOOD JOISTS 40MM
- VERIFY EXISTING SUPPORT SYSTEM. INCLUDING FOUNDATIONS, FOR LOADS IMPOSED BY THE PROPOSED CONSTRUCTION
- PROVIDE ALL BRACING, SHORING AND NEEDLING NECESSARY FOR THE SAFE EXECUTION OF THIS WORK
- INFORM CITY OF ALL INSPECTION AHEAD OF AND AT EACH STAGE OF CONSTRUCTION

3 OR 4 WAY SWITCH

EXISTING N NEW

3 DENOTES 3-WAY SWITCH SPECIFICATION GRADE WHITE, WITH WHITE COVER PLATE4 DENOTES 4-WAY SWITCHSHALL BE INSTALLED AT THEENDS OF EACH STAIRWAYS

INSTALL AT 3'-3" AFF

WP

15A. 120V DUPLEX RECEPTACLE SPECIFICATION GRADE, WHITE C/W WHITE COVER PLATE GFI- GROUND FAULT TYPE WP- WEATHERPROOF COVER C - ABOVE COUNTER

RECEPTACLE 50A, 208V. STOVE OR DRYER OUTLET.

- 6 **EXHAUST FAN**
- \otimes FD: FLOOR DRAIN
- **SPRINKLER**
- **EMERGENCY LIGHT** (10)
- SD: SMOKE ALARM W/ STROBE LIGHT

ALARM LIGHT

POT LIGHT

CO: CARBON MONOXID Building Reviewed

ALL WORK SHALL CONFORM TO THE ONTAR PLEASE SEE ATTACHED

NOTES AS THEY FORM PART OF THE

INSTALL DUCT TYPE SMOKE DETECTOR IN FURNACE.

NEW CEILING TO BE 45 MIN. FIRE RATED WITH ABSORPTIVE MATERIAL IN CAVITY, RESILIENT METAL CHANNELS @ 610MM O.C. WITH 2 LAYERS OF 12.7 MM TYPE X GYP. BD. ON CEILING SIDE AS PER "TABLE 2, FLOORS & CEILINGS F9h OF SB-3"

2/ 2x10 SPR WOOD LINTEL.

ESCAPE WINDOW: TO BE OPERABLE FROM INSIDE WITHOUT USE OF ANY TOOLS UNOBSTRUCTED OPEN PORTION HAVING A MINIMUM AREA OF City of Brampton 0.35M2/3.76 Sq.Ft WITH NO DIMENSION Building Division | LESS THAN 1'-3" 380MM)

> BULKHEAD / STAIR CEILING 45 MIN. FIRE SEPARATION, 2 LAYERS 1/2" TYPE X GYPSUM (NOTE: NO OPENINGS PERMITTED THIS MEMBRANE ONLY FIRE SEPARATION.

CONTRACTOR SHALL SITE VERFY ALL DIMENSIONS AND NGS AND SPECIFICATIONS ARE THE PROPERTY COMPLETION OF WORK.
THIS DRAWING IS NOT TO BE USED FOR CONSTRUCTIO

COPYRIGHT RESERVED

00 2022.12.28 SCHEMATIC LAYOUT 01 2023 01 11 CITY COMMENTS

OWNER

FARZANA BAGAM

ARCHITECT



·Architecture Ltd

10368 WINSTON CHURCHILL BLVD, HALTON HILLS ON L7G 4S7 c: 647.741.5917, e: info@c-archi.com



ALTERATIONS (SU)

72 CIRCUS CRES. BRAMPTON

GENERAL NOTES

SCALE: DATE:

N.T.S 2023.01.11


22-176


PROJECT:

DRAWING NO:

RECEIVED: 2023/02/15

PLEASE SEE ATTACHED NOTES AS THEY FORM PART OF THE REVIEWED DRAWINGS

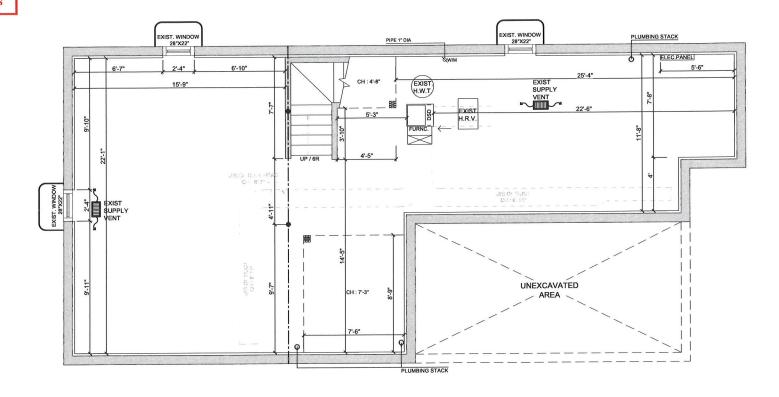

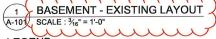

LEGEND : 6

EXHAUST FAN EXISTING WALLS

NEW WALLS

FIRE RATED WALLS. REFER TO A-403 FOR DETAILS

EXISTING TO BE REMOVED

◆ 图 EXISTING STEEL & WOODEN POSTS HARD WIRED SMOKE DETECTOR (INTERCONNECTED)



CARBON MONOXIDE ALARM

BASEMENT - EXISTING LAYOUT

BASEMENT AREA = 935.77 SFT / 86.96 SM

U/S OF DUCT CEILING HEIGHT = 6'-11"

U/S OF BULK HEAD CEILING HEIGHT = 6'-7"

CEILING HEIGHT = 7'-8"

RELEASED FOR BUILDING PERMIT

CONTRACTOR SHALL SITE VITERY ALL DIMENSIONS AND REPORT DISCREPANCIS (F ANY) TO THE CONSISTANTS EFFORCE CONSTITUTION CONTRACTOR AND THE CONSISTANTS EFFORCE CONSTITUTION CONCINCTION AND THE PROPRIETY OF CONSISTANTS AND MAST SE RETURNED AT THE CONSISTANTS AND MAST SE RETURNED AT THE CONSTITUTION OF CONSTITUTION OF THE MACHINETY FAMILY SHALL SH

COPYRIGHT RESERVED

NO	DATE	REVISION / ISSUED
00	2022.12.28	SCHEMATIC LAYOUT
00	2023 01 06	PERMIT APPLICATION
01	2023.01.11	CITY COMMENTS
02	2023 02 03	CITY COMMENTS



FARZANA BAGAM



-Architecture Ltd

10368 WINSTON CHURCHILL BLVD, HALTON HILLS ON L7G 4S7 c: 647.741.5917, e: info@c-archi.com



ALTERATIONS (SU)

72 CIRCUS CRES, BRAMPTON


BASEMENT -**EXISTING** LAYOUT

3/16"=1'-0" SCALE:

DATE: 2023.01.11 22-176 PROJECT:

DRAWING NO:

A-101

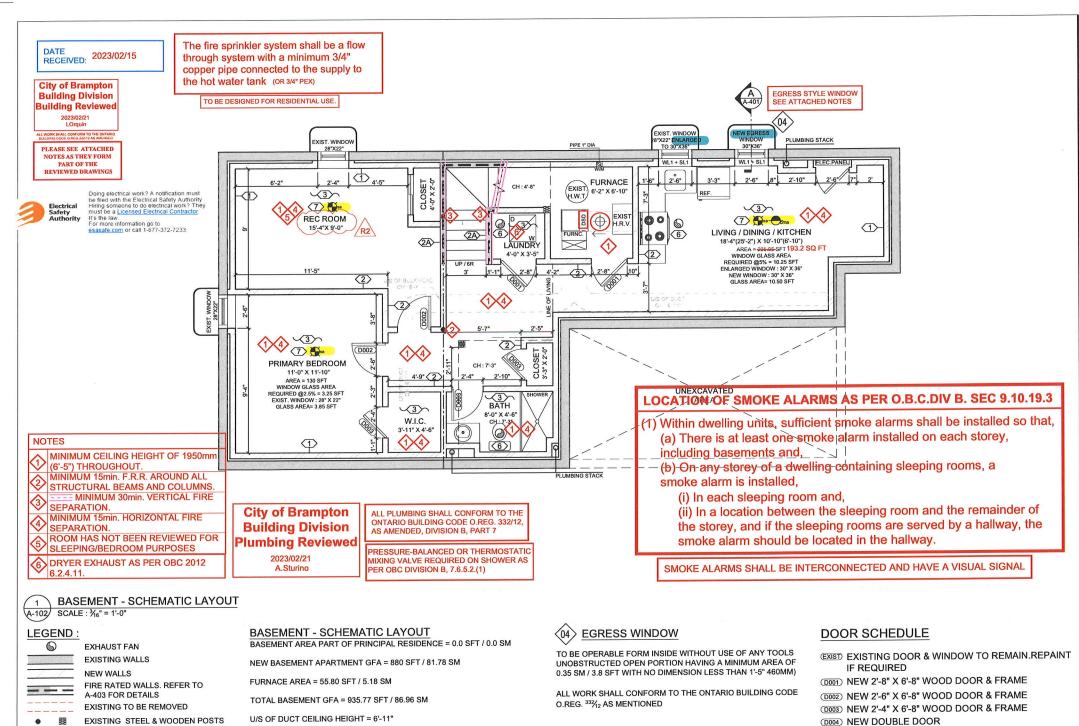

SL1: STEEL LINTEL 31/2" X 31/2" X 3/8"

WL1: WOOD LINTEL 2-2 X 8 SPF NO.1 OR 2

HARD WIRED SMOKE DETECTOR

CARBON MONOXIDE ALARM

(INTERCONNECTED)

U/S OF BULK HEAD CEILING HEIGHT = 6'-7"

CEILING HEIGHT = 7'-8"

RELEASED FOR BUILDING PERMIT

CONTRACTOR SHALL SITE VERIFY ALL DIMENS

CONTRACTOR SHALL STE VIERTY ALL DIMENSIONS AND REPORT DECREPANCE OF MAY) TO THE CONSULTANTS BEFORE CONSTRUCTION ALL DIMANNES AND SPECIATIONS ARE THE PROPERTY OF CONSULTANTS, AND MUST BE RETURNED AT THE THIS DIMANNES IS NOT TO BE USED FOR CONSTRUCTION UNESS SOURCE OF THE AMORTIC! PLINS

COPYRIGHT RESERVED

THE COPYRIGHTS TO ALL DESIGNS AND DRAWINGS ARE FROPERTY OF ARCHITECT, REPRODUCTION OR USE FOR A PUBLICAL OTHER THAN THAT AUTHORIZED BY ARCHITECT COMMODIES.

NO	DATE	REVISION / ISSUED
00	2022 12 28	SCHEMATIC LAYOUT
00	2023.01.05	PERMIT APPLICATION
01	2023.01.11	CITY COMMENTS
02	2023 02 03	CITY COMMENTS



OWNE

FARZANA BAGAM

ARCHITECT



C-Architecture Lt

10368 WINSTON CHURCHILL BLVD, HALTON HILLS ON L7G 4S7 c: 647.741.5917, e: info@c-archi.com



ALTERATIONS (SU)

72 CIRCUS CRES, BRAMPTON

BASEMENT -SCHEMATIC LAYOUT

SCALE: 3/16"=1'-0" DATE: 2023.01.11

DRAWING NO:


PROJECT:

(D005) NEW 2'-8" X 6'-8", 20 MIN. FIRE RATED DOOR

AVVING NO.

A-102

22-176

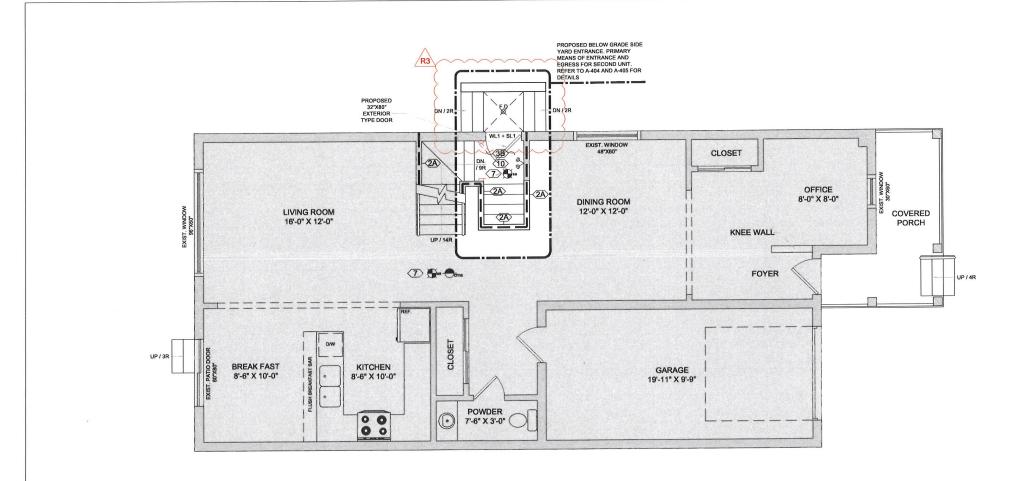



LEGEND:

6 EXHAUST FAN

EXISTING WALLS NEW WALLS

FIRE RATED WALLS. REFER TO A-403 FOR DETAILS

EXISTING TO BE REMOVED **EXISTING STEEL & WOODEN POSTS**

HARD WIRED SMOKE DETECTOR (INTERCONNECTED)

CARBON MONOXIDE ALARM

MAIN FLOOR - EXISTING LAYOUT

MAIN FLOOR AREA = 935.77 SFT / 86.96 SM

GARAGE AREA = 214.40 SFT / 19.92 SM

TOTAL MAIN FLOOR AREA = 1151.18 SFT / 106.98 SM

CEILING HEIGHT = 8'-0"

RELEASED FOR BUILDING PERMIT

ELEASED FOR BUILDING PERMIT

CONTRACTOR BYALL BIT VERRY ALL DIMENSIONS AND
REPORT DISCREPANCES (F ANY) TO THE CONSILTANTS
BEFORE CONSTITUENT CONTRACTIONS ARE THE PROPERTY
ALL DIMENSIONS AND SPECIAL RETURNED AND THE
CONFESTION OF MACHINE RETURNED AND THE
COMPETITION OF THE AMORPHICE THE PROPERTY
THES DIMENSION SHOTT OR IL USED FOR CONSTITUTION
HERE SHOWNED SHOTT OR IL USED FOR CONSTITUTION
HERE SHOWNED SHOTT AND THE THE THE THE THE THE
IT THE SHEET IS NOT IT IF IT! IT IS A REDUCED I
PLANAGIO PRINT MEAD DIMENSION ACCORDINGLY

COPYRIGHT RESERVED

NO	DATE	REVISION / ISSUED
00	2022.12.28	SCHEMATIC LAYOUT
00	2023.01.06	PERMIT APPLICATION
01	2023.01.11	CITY COMMENTS
02	2023 02 03	CITY COMMENTS
03	2023 02 06	PERMIT REVISION



FARZANA BAGAM



-Architecture Ltd

10368 WINSTON CHURCHILL BLVD, HALTON HILLS ON L7G 4S7 c: 647.741.5917, e: info@c-archi.com



ALTERATIONS (SU)

72 CIRCUS CRES, BRAMPTON

MAIN FLOOR -EXISTING LAYOUT

3/16"=1'-0" SCALE:

2023.01.11 DATE: 22-176 PROJECT:

DRAWING NO:

A-103


DATE RECEIVED: 2023/02/15

City of Brampton Building Division Building Reviewed

2023/02/21

ALL WORK SHALL CONFORM TO THE ONTARIO

PLEASE SEE ATTACHED NOTES AS THEY FORM PART OF THE REVIEWED DRAWINGS

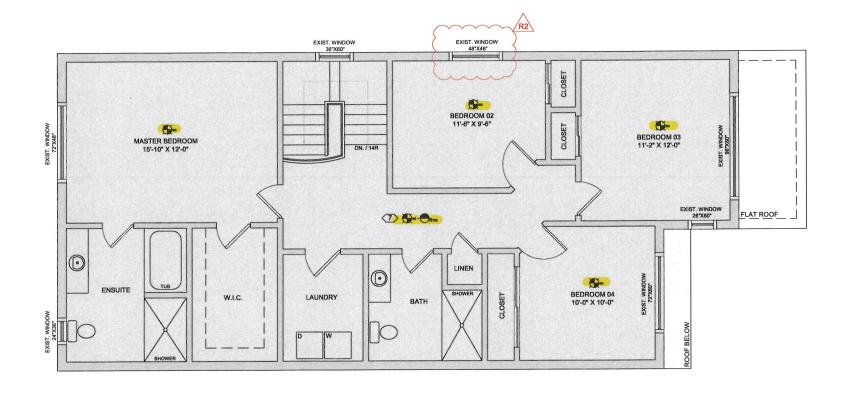



SECOND FLOOR - EXISTING LAYOUT

SECOND FLOOR AREA = 1152.22 SFT / 107.08 SM

CEILING HEIGHT = 8'-0"

LEGEND:

6

EXHAUST FAN EXISTING WALLS

NEW WALLS

FIRE RATED WALLS. REFER TO A-403 FOR DETAILS

EXISTING TO BE REMOVED

EXISTING STEEL & WOODEN POSTS HARD WIRED SMOKE DETECTOR (INTERCONNECTED)

- Crma

CARBON MONOXIDE ALARM

LOCATION OF SMOKE ALARMS AS PER O.B.C.DIV B. SEC 9.10.19.3

- (1) Within dwelling units, sufficient smoke alarms shall be installed so that, (a) There is at least one smoke alarm installed on each storey,
 - (a) There is at least one smoke alarm installed on each storey, including basements and,
 - (b) On any storey of a dwelling containing sleeping rooms, a smoke alarm is installed,
 - (i) In each sleeping room and,
 - (ii) In a location between the sleeping room and the remainder of the storey, and if the sleeping rooms are served by a hallway, the smoke alarm should be located in the hallway.

SMOKE ALARMS SHALL BE INTERCONNECTED AND HAVE A VISUAL SIGNAL

RELEASED FOR BUILDING PERMIT

CONTRACTOR SHALL BITE VEREY ALL DIMENSIONS A REDUCE CONTRACTOR OF THE CONSULTAN ALL DIMANNESS AND SECRETARIONS ARE THE FROMER OF COMBULTANIS AND MUST BE RETURNED AT I COMBULTANIS AND MUST BE RETURNED AT I COMBULTANIS AND MUST BE RETURNED AT I COMBULTANIS AND MUST BE RESERVED. TO COMBULTANIS AND MUST BE RESERVED. TO COMBULTANIS AND MUST BE RESERVED. TO THE SERVED BY THE ARCHITECT P.E.ING. IT HIS SERVED IN OUT IT 7. IT 8. A REDUCED.

PYRIGHT RESERVED

THE COPYRIGHTS TO ALL DESIGNS AND DRAWINGS ARE THE PROPERTY OF ARCHITECT, REPRODUCTION OR USE FOR AN

NO	DATE	REVISION / ISSUED
00	2022 12 28	SCHEMATIC LAYOUT
00	2023.01.06	PERMIT APPLICATION
01	2023.01.11	CITY COMMENTS
02	2023 02:03	CITY COMMENTS



OWN

FARZANA BAGAM



C-Architecture Ltd

10368 WINSTON CHURCHILL BLVD, HALTON HILLS ON L7G 4S7 c: 647.741.5917, e: info@c-archi.com



ALTERATIONS (SU)

72 CIRCUS CRES, BRAMPTON

SECOND FLOOR - EXISTING LAYOUT


SCALE: 3/16"=1'-0" DATE: 2023.01.11 PROJECT: 22-176

DRAWING NO:

A-104

GLAZED OPENINGS:

WALL AREA: = 1016.84 SFT / 94.50 LIMITING DISTANCE: 1.31 M WINDOW AREA PROVIDED: 62.6 SFT / 5.81 M² (6.15%) WINDOW AREA ALLOWED: 7%

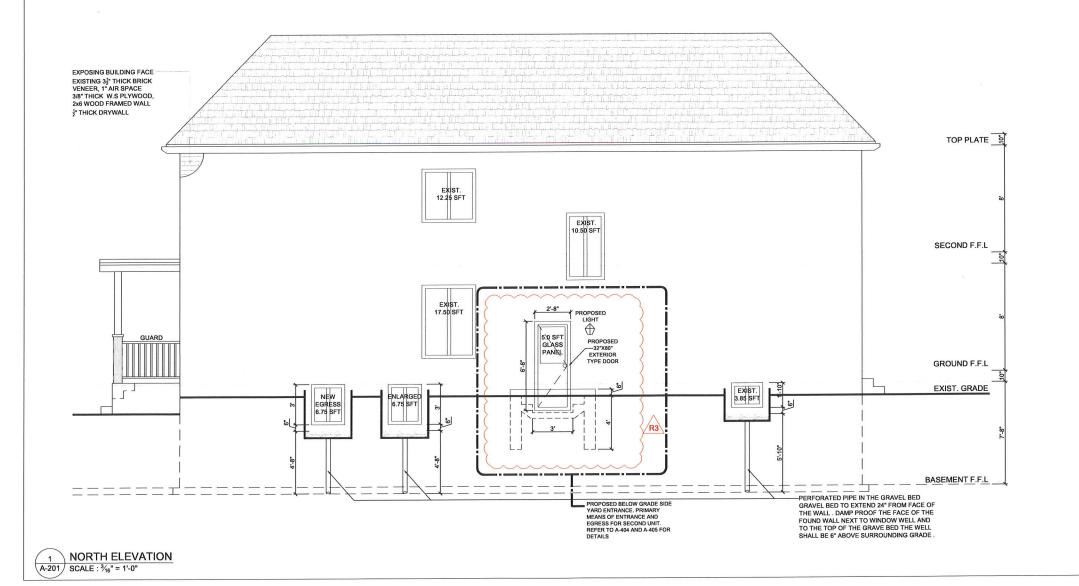

RELEASED FOR BUILDING PERMIT

CONTINUED BUILDING FERMINE
CONTINUED BUILDING FERMINE
CONTINUED BUILDING FERMINE
ELFORE CONSTRUCTION
ELFORE CONSTRUCTION
ELFORE CONSTRUCTION
ELFORE
ELFORE
COMPLETION OF WORK

THE DIMENS IS NOT TO SELED FOR CONSTRUCTION
IF THIS SHEET IS NOT IN *, IT T, IT IS A REDUCED I
ELFANGED FROM FEAD BUILDING SCHOOLSON

F. THIS SHEET IS NOT IN *, IT T, IT IS A REDUCED I
ELFANGED FROM FEAD BUILDING SCHOOLSON

F. THIS SHEET IS NOT IN *, IT T, IT IS A REDUCED I
ELFANGED FROM FEAD BUILDING SCHOOLSON

F. THIS SHEET SCHOOLSON

F.

COPYRIGHT RESERVED

THE COPYRIGHTS TO ALL DESIGNS AND DRAWINGS ARE THE PROPERTY OF ARCHITECT REPRODUCTION OR USE FOR ANY PURPOSE OTHER THAN THAT AUTHORIZED BY ARCHITECT IS FORBIDDEN

NO DATE REVISION / ISSUED

00			
۳ ا	2022 12 28	SCHEMATIC LAYOUT	
00	2023.01.05	PERMIT APPLICATION	
01	2023.01.11	CITY COMMENTS	
02	2023 02 03	CITY COMMENTS	
03	2023 02.06	PERMIT REVISION	

OWNER

FARZANA BAGAM



C-Architecture Ltd

10368 WINSTON CHURCHILL BLVD, HALTON HILLS ON L7G 4S7 c: 647.741.5917, e: info@c-archi.com



ALTERATIONS (SU)

72 CIRCUS CRES, BRAMPTON

NORTH ELEVATION

SCALE:

³/₁₆"=1'-0"

DATE:

2023.01.11 22-176

PROJECT: DRAWING NO:

. . . .

GENERAL NOTES

- ALL WORK ACCORDING TO ONTARIO BUILDING CODE 2012 AND CITY OF BRMPTON BY-LAWS
- ALL WORKING ACCORDING TO GOOD CONSTRUCTION PRACTICES
- ALL FOOTINGS SHALL REST ON NATURAL UNDISTURBED SOIL OR COMPACTED GRANULAR FILL WITH A MINIMUM BEARING CAPACITY OF 75 KPA
- WHERE THE FOUNDATIONS OF A BUILDING ARE TO BE CONSTRUCTED BELOW THE LEVEL OF THE FOOTINGS OF AN ADJACENT BUILDING AND WITHIN THE ANGLE OF REPOSE OF THE SOIL, OR THE UNDERPINNING EXCEEDS 1200MM OF LATERALLY UNSUPPORTED HEIGHT OR THE SOIL IS CLAY OR SILT. THE UNDERPINNING & RELATED CONSECUTION SHALL BE DESIGNED BY A PROFESSIONAL ENGINEER.
- EXCAVATION SHALL BE UNDERTAKEN IN A MANNER SO AS TO PREVENT MOVEMENT WHICH WOULD CAUSE DAMAGE TO ADJACENT PROPERTIES, STRUCTURES, UTILITIES, ROADS & SIDEWALKS. CONTACT YOUR LOCAL UTILITIES PRIOR TO COMMENCING EXCAVATION.
- SHORE & BRACE WHERE NECESSARY TO ENSURE THE SAFETY & STABILITY OF THE EXISTING STRUCTURE DURING UNDERPINNING.

CONCRETE

- 1. MINIMUM COMPRESSIVE STRENGTH OF CONCRETE 32MPA @ 28 DAYS W/5% TO 8% AIR ENTRAINMENT.
- 2. MINIMUM YIELD STRENGTH OF STEEL 60 KSI.

1. EXTERIOR DOOR


EXTERIOR TYPE DOOR (42MM INSULATED STEEL DOOR) SIZE 2'-8"x6'-8", W/ DEADBOLT AS PER OBC 9.6.5 & 9.6.8 TO RESIST FORCED ENTRY. PROVIDE LINTEL AS FOLLOWS: SL1: STEEL LINTEL 32" X 32" X 38" WL1: WOOD LINTEL 2 - 2 X 8 SPF NO.1 OR 2

City of Brampton Building Division Building Reviewed

2023/02/21 LOrquin

L WORK SHALL CONFORM TO THE ONTARIO

PLEASE SEE ATTACHED NOTES AS THEY FORM PART OF THE REVIEWED DRAWINGS

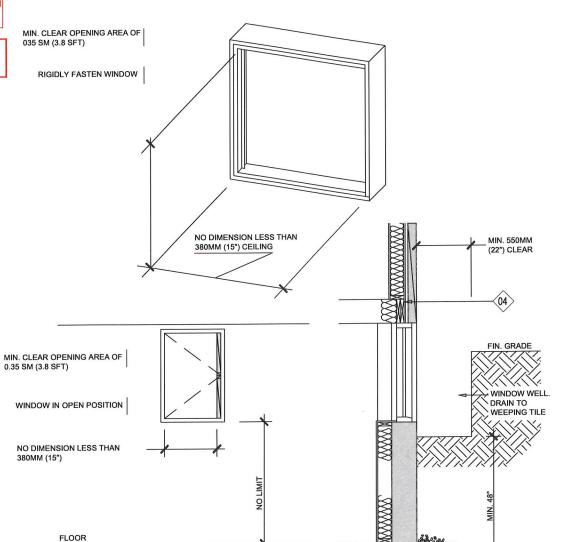

EGRESS WINDOW DETAIL SCALE: 3/8" = 1'-0"

RELEASED FOR BUILDING PERMIT

CONTRACTOR SMALL SET VERY ALL DIMENSIONS AND CONTRACTOR SMALL SET VERY ALL DIMENSIONS AND SET VERY ALL DIMENSIONS AND SET VERY AND TO THE COMBAT MATS REPORT OF CONSILTANTS AND MAST SET RETURNED AT THE DIMANNS IS NOT TO SE USED FOR CONSTRUCTION MALES SIGNED BY THE AMCHITECT P DND.

STORY OF THE STRUCTURE OF THE

COPYRIGHT RESERVED

RECEIVED: 2023/02/15

THE COPYRIGHTS TO ALL DESIGNS AND DRAWINGS ARE THE PROPERTY OF ARCHITECT. REPRODUCTION OR USE FOR ANY PURPOSE OTHER THAN THAT AUTHORIZED BY ARCHITECT IS FORBIDDEN.

NO DATE REVISION / ISSUED 00 2022.12.28 SCHEMATIC LAYOUT 00 2023.01.06 PERMIT APPLICATION 01 2023.01.11 CITY COMMENTS 02 2023.02.03 CITY COMMENTS

OWNER

FARZANA BAGAM



Architecture Ltd

10368 WINSTON CHURCHILL BLVD, HALTON HILLS ON L7G 4S7 c: 647.741.5917, e: info@c-archi.com



ALTERATIONS (SU)


72 CIRCUS CRES, **BRAMPTON**

EGRESS WINDOW DETAIL

3/8" = 1'-0" SCALE: 2023.01.11 DATE: PROJECT: 22-176

DRAWING NO:


RECEIVED: 2023/02/15

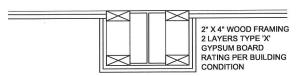




STEEL BEAM SEPERATION

FIRE SEPARATION CEILING ABOVE 2" X 4" WOOD STUDS 1/2" GYPSUM BOARD

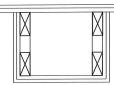

BULKHEAD BELOW FIRE SEPERATION A-402

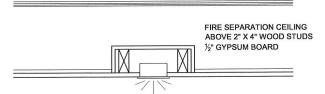

POT LIGHT FIRE SEPERATION A-402

City of Brampton **Building Division Building Reviewed** 2023/02/21 LOrquin

PLEASE SEE ATTACHED NOTES AS THEY FORM PART OF THE REVIEWED DRAWINGS



2" X 4" WOOD FRAMING 2 LAYERS TYPE 'X' GYPSUM BOARD RATING PER BUILDING CONDITION

STEEL COLUMN SEPERATION A-402

> 2" X 4" WOOD STUDS TO SUPPORT CEILING SOUND INSULATION (OPTIONAL) 2 LAYERS TYPE 'X' GYPSUM BOARD RATING PER BUILDING CONDITION

A-402

UNDERSIDE OF STAIR FIRE SEPERATION

ELEASED FOR BUILDING PERMIT
CONTRIGHTOR BULL STEV KERFEY ALL DIMENSIONS AND
REPORT DECREPANCES (IF ANY) TO THE CONSISTANT
ALL DRIVENESS AND SPECIATIONS ARE THE PROFESSE
ALL DRIVENESS AND SPECIATIONS ARE THE PROFESSE
ALL DRIVENESS AND SPECIATIONS ARE THE PROFESSE
THIS SPECIAL SP

RELEASED FOR BUILDING PERMIT

COPYRIGHT RESERVED

THE COPPRIGHTS TO ALL DESIGNS AND DRAWINGS ARE THE PROPRIETY OF ARCHITECT. REPRODUCTION ON USE FOR ANY PURPOSE OTHER THAN THAT AUTHORIZED BY ARCHITECT IS FORRIDDEN.

NO DATE REVISION / ISSUED

00 2022.12.28 SCHEMATIC LAYOUT 00 2023.01.06 PERMIT APPLICATION
01 2023.01.11 CITY COMMENTS
02 2023.02.03 CITY COMMENTS

OWNER

FARZANA BAGAM

ARCHITECT



-Architecture Ltd

10368 WINSTON CHURCHILL BLVD, HALTON HILLS ON L7G 4S7 c: 647.741.5917, e: info@c-archi.com



ALTERATIONS (SU)

72 CIRCUS CRES, BRAMPTON

TYPICAL DETAILS

SCALE:


3/8"= 1'-0" 2023.01.11

DATE: PROJECT:

22-176

DRAWING NO:

A-402

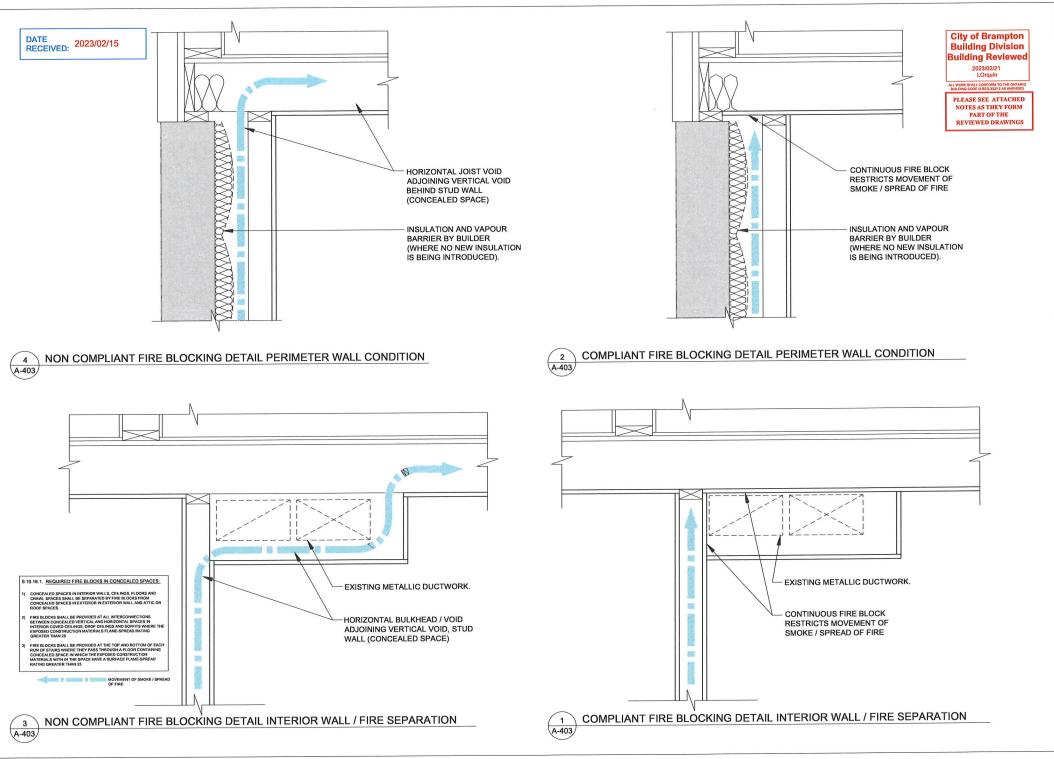

ELEASED FOR BUILDING PERMIT

CONTRACTOR BINL BIT VIREY ALL DIMENSIONS AND
REPORT DISCREPANCES (F ANY) TO THE CONSILTANTS
BEFORE CONSTITUENT STORY CONTRACTOR
ALL DRAWNESS AND SPECIALIZED ARE RETURNED AT THE
CONSISTENCY WAS AND SPECIAL STORY OF THE CONSISTENCY OF THE CONTRACTOR AND THE CONSISTENCY OF THE ADDRESS OF THE ADDRESS AND THE

COPYRIGHT RESERVED

OWNER

FARZANA BAGAM



Architecture Ltd

10368 WINSTON CHURCHILL BLVD, HALTON HILLS ON L7G 4S7 c: 647.741.5917, e: info@c-archi.com



ALTERATIONS (SU)

72 CIRCUS CRES, BRAMPTON

FIRE BLOCKING **DETAILS**

SCALE: DATE:


3/8" = 1'-0" 2023.01.11

PROJECT:


22-176

DRAWING NO:

GRADE

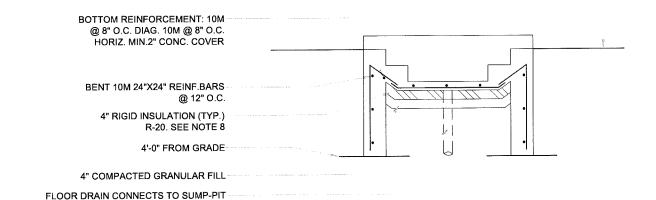

1 SECTION - A A-404 SCALE: 3/6" = 1'-0" SECTION - A

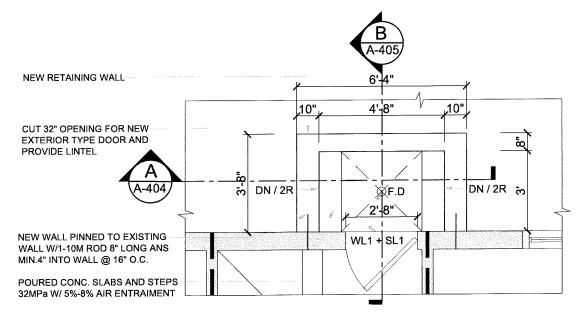

FLOOR DRAIN CONNECTS TO SUMP-PIT



RELEASED FOR BUILDING PERMIT

THE COPPRIGHTS TO ALL DESIGNS AND DRAWINGS ARE THE PROPERTY OF ARCHITECT REPRODUCTION OR USE FOR MY PURPOSE OTHER THAN THAT AUTHORIZED BY ARCHITECT IS FORBODEN

NO	DATE	REVISION / ISSUED
60	2022.12.28	SCHEMATIC LAYOUT
00	2023.01.06	PERMIT APPLICATION
01	2023 01.11	OTTY COMMENTS
02	2023.02.03	CITY COMMENTS
00	2023.02.06	PERMIT REVISION

OWNER

FARZANA BAGAM

ARCHITECT



10368 WINSTON CHURCHILL BLVD, HALTON HILLS ON L7G 4S7 c: 647.741.5917, e: info@c-archi.com

ARSHAD SIDDIQUE

ALTERATIONS (SU)

72 CIRCUS CRES, BRAMPTON

WALKOUT **DETAILS**

SCALE: 3/8" = 1'-0"

DATE: 2023.01.11

PROJECT: 22-176

DRAWING NO:

A-404

GENERAL NOTES

1. FOOTING

FOOTINGS SHALL REST ON NATURAL UNDISTURBED SOIL OR COMPACTED GRANULAR FILL WITH A MINIMUM SOIL BEARING CAPACITY OF 75 KPa

2. HANDRAILS

HANDRAILS SHOUD BE BETWEEN 34 TO 38 ABOVE THE TREAD AT THE LEADING EDGE LINE 2 IN CLEARANCE FROM THE WALL IS REQUIRED

START AND END POINT OF HANDRAILS MUST NOT OBSTRUCT PEDESTRIAN TRAFFIC OR CREATE A HAZARD BOTH SIDE HANDRAILS REQUIRED IF STAIRS ARE 43 IN OR WINDER

3. EXTERIOR

7 %" RISER MAXIMUM 4 %" MINIMUM 10" RUN MINIMUM 14" MAXIMUM 10" TREAD MINIMUM 14" MAXIMUM

4. RETAINING WALL

10" POURED CONCRETE WALL DOES NOT REQUIRED REBAR IF BACKFILL HEIGHT DOES NOT EXCEED 4'-7". PROVIDE 10M REBAR @12" O.C. EACH WAY FIR BACKFILL HEIGHTS EXCEEDING 4'-7"

5. GUARDS (PRE-ENGINEERED)

42 INCH HIGH WHERE DISTANCE FROM GRADE TO BOTTOM OF WALKOUT EXCEEDS 5'-11" 36" FOR LESSER HEIGHTS, MAMIUM 4" BETWEEN VERTICAL PICKETS

6. LIGHT

ELECTRIC FEED FOR THE LIGHT TO BE SEPARATE FROM ANY OTHER SWITCHED CIRCUIT

EXTERNAL DOOR

EXTERIOR DOOR GENERAL PERFORMANCE CRITERIA AND THERMAL RESISTANCE TO COMPLY WITH OBC 9.7.3 INSTALLATION OF MANUFACTURED AND PRE - ASSEMEBED DOOR SHALL CONFORM TO THE MANUFACTURERS INSTRUCTIONS

ALL UN FINISHED PORTIONS OF THE GRAME AND OTHER COMPONENTS OF DOORS IN CONTACT WITH THE EDGES OF MANSORY OR CONCRETE SHALL BE PROTECTED WITH CAULKING


8. INSULATION DETAILS

RIGID INSULATION TO HAVE FOLLOWING SPECFICATION

- STYROFOAM BRAND SM EXTRUDED POLYSTYRENE FOAM INSULATION
- RSI VALUE 0.87/25MM [R-5 PER 1 INCH]
- BOARD SIZE : AS INDICATED ON DRAWINGS]
- COMPRESSIVE STRENGTH : 210 KPa
- DRAINING CAPAICTY > 0.72 M3/ HR/ M

9. INSULATION FINISHING

INSTALL RIGID INSULATION ON EXISTING FOUNDATION WALL MIN 4FT ABOVE FOOTING INSULATION TO BE INSTALLED ON EXPOSED FOUNDATION WALL ONLY STARTING FROM GRANULAR FILL UNDER STEPS COVER INSULATION WITH ½" CEMENT BOARD INSTAL 21 ½" GALVANIZED J TRACK ON SECURE AND PROTECT ALL EXPOSED EDGES ALL JOINTS TO THE EXISTING WALL NEW STEPS MUST BE CAULKED APPLY SEAL GUARD TO ALL JOINTS ON CEMET BOARD PARGE CEMENT BOARD OR APPLY ACRYLIC FINISH

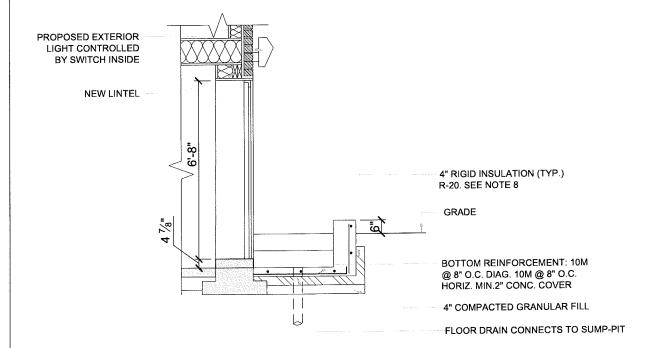



1 SECTION - B SCALE: 3/6" = 1'-0"

RELEASED FOR BUILDING PERMIT

CONTRACTOR SHALL SITE VERY VAL. DIMENSIONE AND REPORT IDSCRIPANCIE SE ANY, TO THE CONSIGNATION SEFOND AND SEFO

COPYRIGHT RESERVED

THE COPPUIGHTS TO ALL DESIGNS AND DRAWINGS ARE THE PROPERTY OF ARCHITECT, REPRODUCTION OR USE FOR ANY PURPOSE OTHER THAN THAT AUTHORIZED BY ARCHITECT IS

NO	DATE	REVISION / ISSUED	
90	2022:12:28	SCHEMATIC LAYOUT	
60	2023.01.06	PERMIT APPLICATION	
01	2023 01.11	CITY COMMENTS	
05	2023 02:03	CITY CONDENTS	
03	2023.02.05	PERMIT REVISION	
_			

OWNER

FARZANA BAGAM

ARCHITECT



10368 WINSTON CHURCHILL BLVD,

HALTON HILLS ON L7G 4S7 c: 647.741.5917, e: info@c-archi.com



ALTERATIONS (SU)

72 CIRCUS CRES, BRAMPTON

WALKOUT DETAILS

SCALE: 3/6" = 1'-0"

DATE: 2023.01.11 PROJECT: 22-176

PROJECT: DRAWING NO:

A-405

DATE RECEIVED: 2023/02/15

City of Brampton Building Division Building Reviewed


LOrquin

PLEASE SEE ATTACHED NOTES AS THEY FORM PART OF THE REVIEWED DRAWINGS



Doing electrical work? A notification must be filed with the Electrical Safety Authority. Hiring someone to do electrical work? They must be a <u>Licensed Electrical Contractor</u>. It's the law.

For more information go to

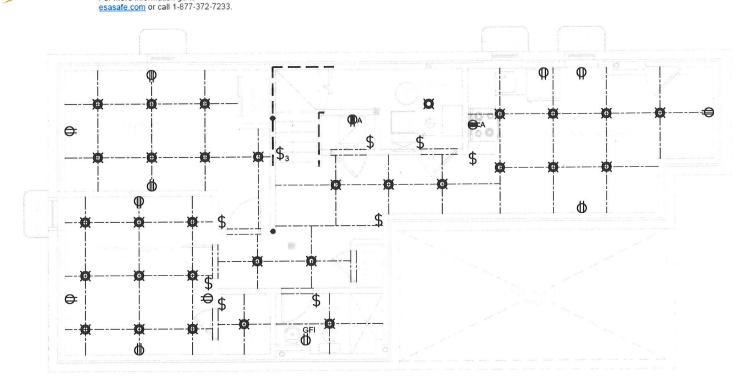

BASEMENT - ELECTRICAL LAYOUT

E-101) SCALE : 3/6" = 1'-0"

ELECTRICAL SYMBOL:

\$ 3 OR 4 WAY SWITCH E EXISTING N NEW

GFI WP 15A, 120V DUPLEX RECEPTACLE SPECIFICATION GRADE, WHITE CW WHITE COVER PLATE GFI- GROUND FAULT TYPE WP- WEATHERPROOF COVER C - ABOVE COUNTER

ELECTRICAL SYMBOL:

RECEPTACLE 50A, 208V, STOVE OR DRYER OUTLET.

EXHAUST FAN

FD: FLOOR DRAIN

SPRINKLER

10 EMERGENCY LIGHT

SD: SMOKE ALARM W/ STROBE LIGHT
CO: CARBON MONOXIDE ALARM

POT LIGHT

ELECTRICAL NOTES

LOCATIONS OF ELECTRICAL ITEMS ARE APPROXIMATE, ACTUAL LOCATION MAY VARY AS PER SITE CONDITIONS

WHERE PENETRATING FIRE SEPARATION FOR POT LIGHT FIXTURES, USE FIRE RATED POT LIGHTS OR PROVIDE FIRE RATED ENCLOSURE BEHIND LIGHT FIXTURE TO ENSURE CONTINUITY OF FIRE SEPARATION

RELEASED FOR BUILDING PERMIT

CONTRACTOR SMALL SITE VERBY ALL DIMERSIONS AND REPORT INSPECTATION OF THE CONSIGNATION OF THE CONSIGNATION OF THE CONSIGNATION OF THE PROPERTY OF CONSIGNATION AND THE REPORT OF CONSIGNATION AND THE REPORT OF THE CONTRACT

COPYRIGHT RESERVED

THE COPYRIGHTS TO ALL DESONS AND DRAWINGS ARE THE PROPERTY OF ARCHITECT, REPRODUCTION OR USE FOR AN PURPOSE OTHER THAN THAT AUTHORIZED BY ARCHITECT IS COMMONDED.

NO	DATE	REVISION / ISSUED
00	2022.12.28	SCHEMATIC LAYOUT
00	2023.01.06	PERMIT APPLICATION
01	2023 01.11	CITY COMMENTS
02	2023.02.03	CITY COMMENTS

OWNER

FARZANA BAGAM

ARCHITEC



C-Architecture Ltd

10368 WINSTON CHURCHILL BLVD, HALTON HILLS ON L7G 4S7 c: 647.741.5917, e: info@c-archi.com



ALTERATIONS (SU)

72 CIRCUS CRES, BRAMPTON

BASEMENT -ELECTRICAL LAYOUT

SCALE: $\frac{3}{16}$ " = 1'-0" DATE: 2023.01.11

PROJECT: 22-176

DRAWING NO:

E-101


RECEIVED: 2023/02/15

City of Brampton **Building Division**

Building Reviewed

ALL WORK SHALL CONFORM TO THE ONTARI BUILDING CODE O.REG.332/12 AS AMENDED

PLEASE SEE ATTACHED NOTES AS THEY FORM PART OF THE REVIEWED DRAWINGS

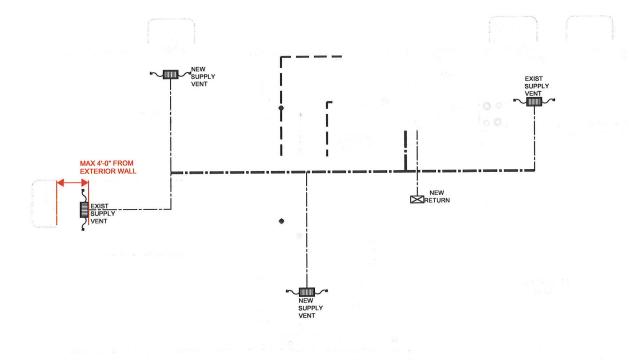

BASEMENT - MECHANICAL LAYOUT

M-101 SCALE : 3/16" = 1'-0"

MECHANIAL NOTES

LOCATIONS OF MECHANICAL ITEMS ARE APPROXIMATE, ACTUAL LOCATION MAY VARY AS PER SITE CONDITIONS

DUCT-TYPE SMOKE DETECTOR TO BE INSTALLED IN THE SUPPLY OR RETURN AIR DUCT SYSTEM SERVING THE ENTIRE BUILDING THAT MUST TURN OFF THE FUEL SUPPLY AND ELECTRICAL POWER TO THE HEATING SYSTEM UPON ACTIVATION

LOCATION OF SMOKE ALARMS AS PER O.B.C.DIV B. SEC 9.10.19.3

- (1) WITHIN DWELLING UNITS, SUFFICIENT SMOKE ALARMS SHALL BE INSTALLED SO
- A. THERE IS AT LEAST ONE SMOKE ALARM INSTALLED ON EACH STOREY, INCLUDING
- B. ON ANY STOREY OF A DWELLING CONTAINING SLEEPING ROOMS, A SMOKE ALARM IS INSTALLED
- IN EACH ROOM AND,
- IN A LOCATION BETWEEN THE SLEEPING ROOM AND THE REMINDER OF THE STOREY AND IF THE SLEEPING ROOMS ARE SERVED BY A HALLWAY, THE SMOKE ALARM SHOULD BE LOCATED IN THE HALLWAY.
- (1) PROVIDE SUPPLY AIR REGISTER (OBC DIV. B.9.33.1(1). REGISTER SHALL BE LOCATED WITHIN 4' OF OUTSIDE WALL (7.6 HRAI DIGEST REQUIREMENTS)
- (2) THE RETURN AIR GRILLE SHALL BE INSTALLED NEAR FLOOR LEVEL (7.7 HRAI DIGEST REQUIREMENTS). UNDERCUT BY MIN 1. THE DOOR TO ANY ROOM WITHOUT RETURN AIR GRILLE
- (3) CLOTHES DRYER EXHAUST SHALL COMPLY WITH OBC DIV. B.6.2.4.11 REQUIREMENTS
- (4) SEPARATE ANY INTAKES FROM BUILDING ENVELOPE PENETRATIONS THAT ARE POTENTIAL SOURCES OF CONTAMINANTS (GAS VENTS, OIL FILL PIPES, ETC. BY MIN 900MM (2'11"). OBC DIV B.9.32.3.12. ENSURE ADEQUATE VENTILATION & COMBUSTION AIR FOR THE OPTIMUM OPERATION OF THE FURNACE, PER MANUFACTURER'S REQUIREMENTS.

BEFORE CONSTRUCTION
ALL DRAWNIGS AND SPECIFICATIONS ARE THE PROPERTY
OF CONSULTANTS AND MUST BE RETURNED AT THE
COMPLETION OF WORK
THIS DRAWNING IS NOT TO BE USED FOR CONSTRUCTION

THE COPYRIGHTS TO ALL DESIGNS AND DRAWINGS ARE THE

NO	DATE	REVISION / ISSUED
00	2022 12 28	SCHEMATIC LAYOUT
00	2023.01.06	PERMIT APPLICATION
01	2023.01.11	CITY COMMENTS
02	2023 02 03	CITY COMMENTS

OWNER

FARZANA BAGAM

ARCHITECT



-Architecture Ltd

10368 WINSTON CHURCHILL BLVD. HALTON HILLS ON L7G 4S7 c: 647.741.5917, e: info@c-archi.com



ALTERATIONS (SU)

72 CIRCUS CRES, **BRAMPTON**

BASEMENT -**MECHANICAL** LAYOUT

SCALE: 3/16" = 1'-0"

DATE:

2023.01.11

PROJECT:

22-176

DRAWING NO:

Zoning Non-compliance Checklist

File	No. 2023-	0355

Applicant: FARZANA BAGAMV

Address: 72 CIRCUS CRES, BRAMPTON, ON L7A 0H1

Zoning: R1F-2888

By-law 270-2004, as amended

Category	Proposal	By-law Requirement	Section #
USE			
LOT DIMENSIONS AREA / DEPTH / WIDTH			
BELOW GRADE ENTRANCE	To permit a proposed exterior stairway leading to a below grade entrance in a required side yard	Whereas the by-law does not permit exterior stairways constructed below established grade in the required interior side yard.	10.23.1
SETBACKS	To permit an interior side yard setback of 0.12m to a proposed exterior stairway leading to a below grade entrance	Whereas the by-law requires a minimum setback of 0.3m to an exterior stairway leading to a below grade entrance in the interior side yard provided that a continuous side yard width of no less than 1.2m (3.94 ft.) is provided on the opposite side of the dwelling.	10.23.2
BUILDING HEIGHT			
OUTSIDE STORAGE			
LOT COVERAGE			
DRIVEWAY			
FENCE HEIGHT			
ACCESSORY STRUCTURE HEIGHT			
ACCESSORY STRUCTURE SETBACK			
DRIVEWAY WIDTH			
LANDSCAPE OPEN SPACE			
GARAGE DOOR HEIGHT			

John C. Cabral	
Reviewed by Zoning	
2023-10-12	

Date