Flower City



For Office Use Only (to be inserted by the Secretary-Treasurer after application is deemed complete)

FILE NUMBER: A 12024-009

The Personal Information collected on this form is collected pursuant to section 45 of the Planning Act and will be used in the processing of this application. Applicants are advised that the Committee of Adjustment is a public process and the information contained in the Committee of Adjustment files is considered public information and is available to anyone upon request and will be published on the City's website. Questions about the collection of personal information should be directed to the Secretary-Treasurer, Committee of Adjustment, City of Brampton.

APPLICATION Minor Variance or Special Permission

(Please read Instructions)

NOTE: It is required that this application be filed with the Secretary-Treasurer of the Committee of Adjustment and be accompanied by the applicable fee.

The undersigned hereby applies to the Committee of Adjustment for the City of Brampton under section 45 of the Planning Act, 1990, for relief as described in this application from By-Law 270-2004.

1.	Name of	Owner(s) RAVI KONDAPALLI 50 COMMODORE DR, BRAMPT	TON ONLEY 057	
	Address	50 COMMODORE DR, BRAIMP	TON; ON L6A 037	
	Phone #	437.995.9924	Fax#	
	Email	crmravi24@gmail.com	rax #	
		,		
2.	Name of	Agent ARSHAD SIDDIQUI		
		202 - 3485 REBECCA ST, OAK	VILLE, ON L6L 0H4	
	Phone #	647.741.5917	Fax #	_
	Email	arshad@c-archi.com		
		1		
3.		d extent of relief applied for (va		
			REQUIRED SETBACK FOR PROPOSED BELOW	
	SECON		ANS OF ENTRANCE AND EXIT FOR PROPSOED	
	SECON	DOMI		
			R ZONING BY-LAW. PROPOSED SETBACK OF 0.1	8
	REQUIF	RES MINOR VARIANCE APP	PROVAL OF 0.12M.	
4.	M/hyr in it	net neceible to comply with the	manufaciona of the by law?	
4.		not possible to comply with the	REQUIRED BELOW GRADE STEPS DUE TO SITE	
	CONDIT		THE GOINED BELOW ON USE OF EN O BOE TO OTHE	-
5.	_	scription of the subject land:		
	Lot Numi	per ^{234L} hber/Concession Number	PLAN M1751	
		Address 50 COMMODORE DR, BRAMPT		
6.	Dimensio	on of subject land (<u>in metric unit</u>	ts)	
	Frontage		<u></u> ,	
	Depth	27.00 M 226.80 SM		
	Area	ZZV.OV CIVI		
_				
7.		o the subject land is by: al Highway	Seasonal Road	
	Municipa	l Road Maintained All Year	Other Public Road	
	Private R	light-of-Way	Water	

8.	land: (specify	<u>in metric units</u> g	d structures on or proposed for the subject round floor area, gross floor area, number of c., where possible)
	EVICTING DISH DING	SS/STRUCTURES on 4	ho aubiant lands - 1 to a ll atroctor (despite a la l
		SS/STRUCTURES on the	
	MAIN RESIDENT	IAL BUILDING : 183	3.21 SM GFA
	PROPOSED BUILDII	NGS/STRUCTURES on	the subject land:
	NA		
		, ,	
9.	Location of all	buildings and str	ructures on or proposed for the subject lands:
		_	and front lot lines in <u>metric units</u>)
	(opoon) mount		<u></u>
	EXISTING		
	Front yard setback	3.50 M	
	Rear yard setback	7.40 M	
	Side yard setback	1.27 M	
	Side yard setback	0.00 M	
	•		
	<u>PROPOSED</u>		
	Front yard setback	3.50 M	
	Rear yard setback	7.40 M	
	Side yard setback	0.18 M	
	Side yard setback	0.00 M	
10.	Date of Acquisition	of subject land:	2007
	q	,	
11.	Existing uses of sul	bject property:	RESIDENTIAL
42	Drawagad uppo of o	uhiaat muanautuu	DECIRENTIAL
12.	Proposed uses of s	ubject property:	RESIDENTIAL
13.	Existing uses of abo	utting properties:	RESIDENTIAL
	J	• •	
14.	Date of construction	n of all buildings & str	uctures on subject land: 2007
			1. (() () () () () () ()
15.	Length of time the	existing uses of the su	bject property have been continued: 17 YEARS
16. (a)	What water sunnly i	is existing/proposed?	
10. (4)	Municipal		Other (specify) NA
	Well		
(b)		sal is/will be provided	
	Municipal 👱	4	Other (specify) NA
	Septic	_	
	140 d d d d		
(c)	تنسير المساور	je system is existing/p 刁	roposed?
	Sewers	╡	Other (specify) NA
	Ditches L Swales	╡	Other (specify)
	JW4103	-	

	subdivision or consent?	or an application under	the Flamming Act, for a	ipprovai oi a pian oi
	Yes No			
	If answer is yes, provide details:	File # NA	Status 1	NA .
18.	Has a pre-consultation application	been filed?		
	Yes No			
19.	Has the subject property ever beer	ո the subject of an applic	ation for minor variance	e?
	Yes No	Unknown	l .	
	If answer is yes, provide details:			
	File # NA Decision NA	4	Relief NA	
	File # NA Decision NA		Relief NA	
	File # NA Decision NA		Relief NA	
			. /	
			M. Palice	·
		Signatu	re of Applicant(s) or Auth	orized Agent
DATE	ED AT THE CTY	OF BRAN	MPTON	
THIS	22ND DAY OF MAR	CH, 20 24.		
F THIS AI	PPLICATION IS SIGNED BY AN AG	ENT. SOLICITOR OR AN	Y PERSON OTHER TH	AN THE OWNER OF
	JECT LANDS, WRITTEN AUTHORIZ			
	LICANT IS A CORPORATION, TH			OFFICER OF THE
CORPORA	ATION AND THE CORPORATION'S	SEAL SHALL BE AFFIXED	D .	
	M ADOLIAD CIDDIOLII	OF THE	TOWN OF	OAKAULE
l,	M. ARSHAD SIDDIQUI	, OF THE		OAKVILLE
IN THE	REGION OF HALTON	SOLEMNLY DEC	CLARE THAT:	
	HE ABOVE STATEMENTS ARE TRI G IT TO BE TRUE AND KNOWING T			
DECLARE	D BEFORE ME AT THE			
CITY	OF BRAMPTON			
IN THE	REGION OF		K	
PEEL	THIS 24TH DAY OF	u j	Tehel	
EDDUADY	20.23	Cianal	use of Applicant or Author	wined Agent
FEBRUARY	, 20 ²³ Clara Vani		ture of Applicant or Autho	orized Agent
Λ_{I}	A Commissioner		Submit by Email	
$-\omega$	A Commissioner etc. the Corporation			-
	City of Brampton	. (.) (.) (.) (.) (.) (.) (.) (.) (.) (.)		
	Evniros Santamba	FOR OFFICE USE ONLY		
	Present Official Plan Designation:			
	Present Zoning By-law Classificat	ion:	R2A-1301	
	This application has been reviewed said review	d with respect to the variand are outlined on the attache		ults of the
	Shiza Athar		2024/03/01	
	Zoning Officer		Date	
			2 - 16	
	DATE RECEIVED_	MARCH	22,2024	Revised 2022/02/17
	Date Application Deemed Complete by the Municipality	l	12	116VISGU 2022/02/17

APPOINTMENT AND AUTHORIZATION OF AGENT

To: The Secretary-Treasurer
Committee of Adjustment
City of Brampton
2 Wellington Street West
Brampton, Ontario
L6Y 4R2

LOCATION OF THE SUBJECT LAND: 50 COMMODORE DR, BRAMPTON, ON L6X 0S7
I/We, RAVI KONDAPALLI
please print/type the full name of the owner(s)
the undersigned, being the registered owner(s) of the subject lands, hereby authorize
ARSHAD SIDDIQUI
please print/type the full name of the agent(s)
to make application to the City of Brampton Committee of Adjustment in the matter of an application for minor variance with respect to the subject land.
Dated this 24TH day of FEBRUARY , 20 24 .
12. how Charles
(signature of the owner[s], or where the owner is a firm or corporation, the signature of an officer of the owner.)
(where the owner is a firm or corporation, please print or type the full name of the person signing.)

NOTE: Unit owners within a Peel Standard Condominium Corporation are to secure authorization from the Directors of the Condominium Corporation in a form satisfactory to the City of Brampton, prior to submission of an application. Signatures from all Members of the Board of Directors are required.

NOTE: If the owner is a firm or corporation, the corporate seal shall be affixed hereto.


PERMISSION TO ENTER

To: The Secretary-Treasurer
Committee of Adjustment
City of Brampton
2 Wellington Street West
Brampton, Ontario
L6Y 4R2

LOCATI	ON OF THE SUBJE	ECT LAND: 50 COMMOD	OORE DR, BRAMPTON, ON L	L6X 0S7	
I/We,	RAVI KONDAPALLI	í			
		please print/	type the full name of	the owner(s)	
the City the abov	of Brampton Com ve noted property f	mittee of Adjustmer	nt and City of Bra anducting a site in	and, hereby authorize the Member ampton staff members, to enter unappection with respect to the attac	ıpon
Dated th	ni <u>s 24TH</u> day of	FEBRUARY		, 20 24	
		12. Row 1	leyla		
(sigr	nature of the owner[s],	or where the owner is a	firm or corporation, t	the signature of an officer of the owner.)	
•	(where the owner is	a firm or corporation, pl	ease print or type the	e full name of the person signing.)	

NOTE: If the owner is a firm or corporation, the corporate seal shall be affixed hereto.

NO DISCUSSION SHALL TAKE PLACE BETWEEN THE COMMITTEE MEMBERS AND THE APPLICANT DURING THE SITE INSPECTION

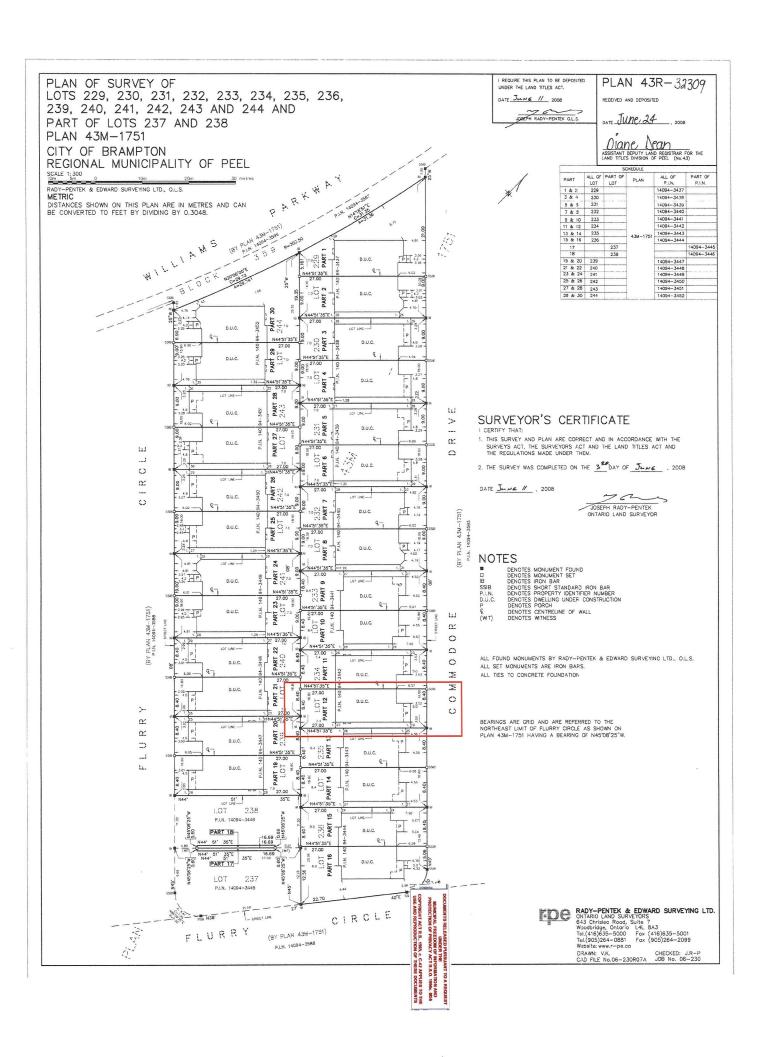

ALTERATIONS, SECOND UNIT

50 COMMODORE DR, BRAMPTON

RAVIKONDAPALLI

ISSUED FOR: BUILDING PERMIT APPLICATION

ISSUE DATE: FEBRUARY 14, 2024

NAM	E OF PROJECT ALTE	RATION	s, s	ECON	ID	UNIT		
LOC	ation 50 CC	MMODO	RE	DR, B	RA	AMPTON		
TEM	ONTARIO BU	ILDING CO	DDE	DATA N	ſΑN	RIX	OBC REFE	RENCE
	PROJECT DESCRIPTION:	□ N	EW		T	☐ PART 11		✓ PART
1		□ A	DDITION	ı	1.	1.1 TO 11.4		2.1.1
	CHANGE OF USE	√ Al	LTERATI	ION				9.10.1.3
2	MAJOR OCCUPANCY(S)	С				1.07,00		9.10.2
3		(ISTING 139.20	NEW	0 T	OTAL	139.20		1.1.3.2
4	GROSS AREA (m) ² EX	(ISTING 183.21	NEW	82.71 T	DTAL	265.92		1.1.3.2
4a	AREA OF WORK (m)2	82.71						
5	NUMBER OF STOREYS	ABOVE GRADE:	2	BELOW GRA	DE:	1		2.1.1.3
6	NUMBER OF STREET/ACCESS	ROUTES	1	.,,,,,,,,,,,,,,,,,,,,,,,,,,,,,,,,,,,,,,				9.10.19
7	BUILDING CLASSIFICATION						AMA MANAGANA	9.10.4
8	SPRINKLER SYSTEM PROPO	SED	□ EN7	TIRE BUILDIN	IG			9.10.8
•			□ вая	SEMENT ON	Υ.			
			☐ IN	LIEU OF RO	OF R	ATING		
			▼ NO	T REQUIRED				
9	STANDPIPE REQUIRED		☐ YE	s 🗹	10	Lancasana		9.10.17.2
10	FIRE ALARM REQUIRED	***************************************	☐ YE	s 🗹	10			
11	WATER SERVICE/SUPPLY IS	SADEQUATE	YE	:s 🗆 !	10			N/A
12	HIGH BUILDING	······································	☐ YE	s 🗹	10			N/A
	PERMITTED CONSTRUCTION	COMBUSTIBLE	□NON-	-COMBUSTIE	LE	У вотн		9.10.6
	ACTUAL CONSTRUCTION N	COMBUSTIBLE	□NON-	-COMBUSTIE	LE	Вотн		
14	MEZZANINE(S) AREA (M ?		N/A					9.10.4.1
15	OCCUPANT LOAD BASED OF	N □ m ² /	PERSON			OF BUILDING		9.9.1.3
	BASEMENT:	OCCUPA				PERSON		
	1 ST. FLOOR	OCCUPA OCCUPA				PERSON PERSON		
	2 ST. FLOOR 3 ST. FLOOR	OCCUPA				PERSON		
16	BARRIER-FREE DESIGN							9.5.2
17	HAZARDOUS SUBSTANCES	☐ YES		IO (EXPLAIN		N/A		9.10.1.3
-17	HAZAKDOOS SOBSTANCES	☐ YES	Y N				1	9.10.8
18	REQUIRED FIRE RESISTANCE RATING	HORIZONTAL / FRR (HC	ASSEMB DURS)	ILIES	LIS OR D	TED DESIGN NO. ESCRIPTION (SG-	2)	
	(FRR)	FLOORS N/A		es.	_			9.10.9
		ROOF	HOUR					
		MEZZANINE_						
		FRR OF SUF	=	4G	LIS	TED DESIGN NO.		
		MEMB			OR D	ESCRIPTION (SG-	2)	
		FLOORS N/A	_ HOUR	RS				
		ROOF	HOUR	:S				
		MEZZANINE	HOUR	RS				



LIST OF ARCHITECTURAL DRAWINGS

TYPICAL DETAILS

WALKOUT DETAILS

WALKOUT DETAILS

FIRE BLOCKING DETAILS

BASEMENT - ELECTRICAL LAYOUT

BASEMENT - MECHANICAL LAYOUT

A-000 COVER SHEET & OBC MATRIX A-001 SITE PLAN Project # A-002 GENERAL NOTES	24-514
A-101 BASEMENT - EXISTING LAYOUT A-102 BASEMENT - PROPOSED LAYOUT	
A-103 MAIN FLOOR - EXISTING LAYOUT A-104 SECOND FLOOR - EXISTING LAYOUT A-105 PROJECT	TEAM:
A-201 SOUTH ELEVATION	
A-202 WEST ELEVATION	ARCHITECT
A-301 EGRESS WINDOW DETAIL	

C-ARCHITECTURE LTD. M. ARSHAD SIDDIQUI, OAA C: 647.741.5917 E: arshad@c-archi.com

NOTES:

A-302

A-303

A-304

A-305

1. PROVIDE INTERCONNECTED SMOKE ALARMS IN BOTH DWELLING UNITS. (THROUGHOUT THE ENTIRE BUILDING)
2. HORIZONTAL FIRE SEPARATION BETWEEN TWO DWELLING UNITS SHALL COMPLY WITH O.B.C. REQUIREMENTS
REFER SECTION 11.5.1.1.C (C152) WHICH PRESCRIBES IT TO BE 15 MINUTES

	, ,
FIRE SEPARATION O.B.C 9.10.9.14	C152 9.10.9.14.(1) AND (3); 9.10.9.15.(1) (8) IN DETACHED HOUSES, SEMI-DETACHED HOUSES, TOWNHOUSES AND ROW HOUSES CONTAINING NOT MORE THAN TWO DWELLING UNITS, 15 MII
9.10.8.1	HORIZONTAL FIRE SEPARATION IS ACCEPTABLE WHERE,
9.10.8.3	(i) SMOKE ALARMS ARE INSTALLED IN EVERY DWELLING UNIT AND IN COMMON AREAS IN
9.10.9.15	CONFORMANCE WITH SUBSECTION 9 10 19 AND

CONFORMANCE WITH SUBSECTION 9.10.19., AND (II) SMOKE ALARMS ARE INTERCONNECTED.

(C) IN DETACHED HOUSES, SEMI-DETACHED HOUSES, TOWNHOUSES AND ROW HOUSES CONTAINING NOT MORE THAN TWO DWELLING UNITS, THE FIRE-RESISTANCE RATING OF THE FIRE SEPARATION IS WAIVED WHERE BUILDING IS SPRINKLERED.

C147 9.10.8.1.: 9.10.8.3.: 9.10.8.8. (B) IN DETACHED HOUSES, SEMI-DETACHED HOUSES, TOWNHOUSES AND ROW HOUSES CONTAINING NOT MORE THAN TWO DWELLING UNITS, 15 MIN HORIZONTAL FIRE SEPARATION IS ACCEPTABLE WHERE,

(I) SMOKE ALARMS ARE INSTALLED IN EVERY DWELLING UNIT AND IN COMMON AREAS IN CONFORMANCE WITH SUBSECTION 9.10.19., AND

(II) SMOKE ALARMS ARE INTERCONNECTED.

C136 9.9.9. IN DETACHED HOUSES, SEMI-DETACHED HOUSES, TOWNHOUSES AND ROW HOUSES NUMBER OF EXITS: CONTAINING NOT MORE THAN TWO DWELLING UNITS, EXIT REQUIREMENTS ARE ACCEPTABLE IF AT LEAST ONE OF THE FOLLOWING CONDITIONS EXISTS:

BEDROOM WINDOWS: (A) A DOOR, INCLUDING A SLIDING DOOR, THAT OPENS DIRECTLY TO THE EXTERIOR FROM A DWELLING UNIT. SERVES ONLY THAT DWELLING UNIT AND HAS REASONABLE ACCESS TO GROUND LEVEL. AND THE DWELLING UNITS ARE EQUIPPED WITH SMOKE ALARMS INSTALLED IN CONFORMANCE WITH SUBSECTION 9.10.19.,

> C137 9.9.10.1, IN DETACHED HOUSES, SEMI-DETACHED HOUSES, TOWNHOUSES AND ROW HOUSES CONTAINING NOT MORE THAN TWO DWELLING UNITS, EXISTING ACCEPTABLE, WHERE THERE IS DIRECT ACCESS TO THE EXTERIOR.

C108 9.7 EXISTING ACCEPTABLE.

WINDOW SIZES: C107 9.7.2.3. (A) WHERE WINDOWS ARE NOT USED AS A MEANS OF EGRESS AND WHERE THEY DO NOT CONFLICT WITH VENTILATION REQUIREMENTS, THE MINIMUM GLASS AREAS AS SHOWN IN TABLE 9.7.2.3. MAY BE REDUCED BY 50%

DIV. B. O.B.C 9.10.19

TO BE OPERABLE FORM INSIDE WITHOUT USE OF ANY TOOLS

UNOBSTRUCTED OPEN PORTION HAVING A MINIMUM AREA OF 0.35 SM / 3.8 SFT WITH NO DIMENSION LESS THAN 1'-3" 380MM)

ALL WORK SHOULD COMPLY WITH ONTARIO BUILDING CODE 2012. AN EGRESS WINDOW FROM THE BASEMENT FLOOR AREA WITH A MINIMUM OPEN AREA 3.8 FT2 AND NO DIMENSION LESS THAN 15",

HARDWIRED AND INTERCONNECTED SMOKE ALARMS IN EACH BEDROOM, AND A HARDWIRED AND INTERCONNECTED CO DETECTOR. MINIMUM CEILING HEIGHTS FOR BASEMENT SPACES 5 YEARS OR

DIV. B. O.S.C 11.5.1.1 GREATER IN AGE IS 6'-5" OVER THE BASEMENT AREA INCLUDING UNDER BEAMS AND DUCTS.


SUPPLY AIR OUTLETS ARE REQUIRED IN EACH FINISHED ROOM OR SPACE. PROVIDE AT LEAST ONE RETURN OUTLET PER FLOOR LEVEL. UNDERCUT DOORS TO ROOMS WHERE RETURN AIR IS NOT PROVIDED. LOW WALL SUPPLY AND RETURN OUTLETS ARE RECOMMENDED.

DIV. B. O.B.C 7.6.5.1.(1)

EACH NEW PLUMBING FIXTURE REQUIRES A MIXING VALVE TO ENSURE THAT THE MAXIMUM TEMPERATURE OF HOT WATER SUPPLIED BY FITTINGS TO THE FIXTURE DOES NOT EXCEED 49°C. ALTERNATIVELY PROVIDE A MIXING VALVE ON THE HOT WATER HEATER TO ENSURE THAT THE WATER SUPPLIED TO ALL FIXTURES DOES NOT EXCEED 49°C.

DIV. B. O.B.C 9.10.16.1

INSULATION IS REQUIRED IN THE FLOOR JOISTS ABOVE WALLS SEPARATING FINISHED AND UNFINISHED PORTIONS. ENSURE THE DOOR TO THE UTILITY ROOM IS MINIMUM 32" WIDE.

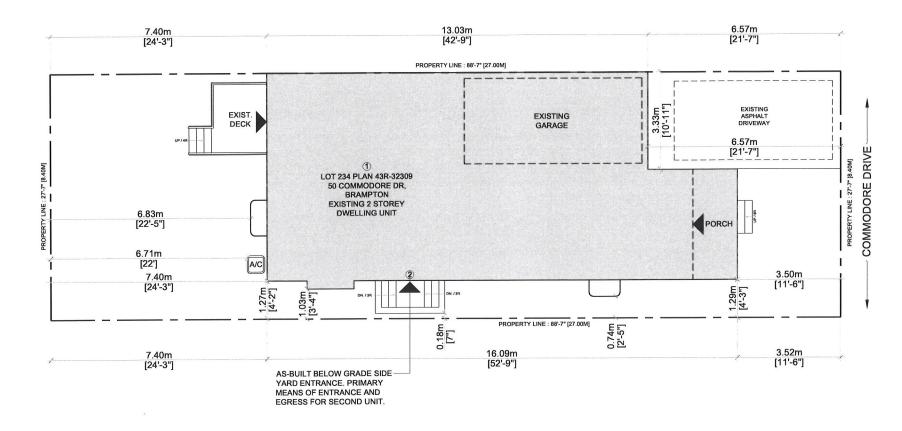



SITE PLAN SCALE : 1/8" = 1'-0"

LEGEND

PROPERTY LINE

ENTRANCE & EGRESS

PARKING SPACES PROVIDED

TWO PARKING SPACES PROVIDED (ONE OUTSIDE & ONE INSIDE THE GARAGE)

AREA STATISTICS

MAIN FLOOR AREA SECOND FLOOR AREA TOTAL ABOVE GRADE GFA PORCH **GARAGE**

- BASEMENT - NEW BASEMENT APARTMENT GFA
- FURNACE AREA
- PRINCIPAL RESIDENCE AREA TOTAL BASEMENT GFA **BASEMENT APARTMENTS GFA IS**

28.11 % OF TOTAL PRINCIPAL RESIDENCE GFA TOTAL LOT AREA: 2441.49 SFT / 226.90 SM

= 890.01 SFT / 82.71 SM

- = 1081.38 SFT / 100.5 SM = 1971.33 SFT / 183.21 SM
- = 61.86 SFT / 5.74 SM = 2223.79 SFT / 56.49 SM
- = 761.27 SFT / 70.75 SM = 128.73 SFT / 11.96 SM
- = 00.00 SFT / 00.0 SM = 890.01 SFT / 82.71 SM

SCOPE OF WORK

- 1 BASEMENT APARTMENT
- ② AS-BUILT BELOW GRADE SIDE YARD ENTRANCE, PRIMARY MEANS OF ENTRANCE AND EGRESS FOR SECOND UNIT.

SITE LOCATION

50 COMMODORE DR. BRAMPTON



NO DATE REVISION / ISSUED 00 2024.01.29 SCHEMATIC DESIGN 00 2024 02 01 PERMIT APPLICATION



RAVI KONDAPALLI

ARCHITECT



C-Architecture Ltd

202 - 3485 REBECCA ST, OAKVILLE ON L6L 0H4 905.847.7177, e: info@c-archi.com



ALTERATIONS (SU)

50 COMMODORE DRIVE, BRAMPTON

SITE PLAN

SCALE:

2024.02.01 DATE: PROJECT: 24-514

DRAWING NO:

A-001

1/8" = 1'-0"

SPECIFICATION:

FOUNDATION WALL INSULATION EXISTING FOUNDATION WALL, MOISTURE BARRIER, 2 BY 4 STUDS @ 16" O.C., R12 INSULATION, 6 MIL POLYETHYLENE V.B., 1/2" GYPSUM DRYWALL JOINTS TAPED AND SEALED AND PAINTED.

FOUNDATION WALL INSULATION

- (1A) EXISTING FOUNDATION WALL, MOISTURE BARRIER, 2 BY6 STUDS WOODEN OR STEEL @ 16" O.C OR 24" O.C R22 INSULATION, 6 MIL POLYETHYLENE FOR WOOD STUDS VAPOUR BARRIER., 1/2" OR 5 GYPSUM DRYWALL JOINTS TAPED AND SEALED AND PAINTED
- (2) INTERNAL WALLS ½" DRY WALL ON BOTH SIDES OF NEW OR EXISTING FRAMED WALL CONSISTING OF 2 BY 4 WOOD STUDS @ 16" O.C. WITH JOINTS TAPED AND SEALED. SB-3: W1 (WATER RESISTANT GWB ON BATHROOMS' WALLS).
- ②A) INTERNAL WALLS 1/2" TYPE X DRYWALL ON BOTH SIDES OF NEW OR EXISTING FRAMED WALL CONSISTING OF 2 BY 4 WOOD STUDS @ 16" O.C. WITH ABSORPTIVE MATERIAL (INSULATION). SB-3: W1b. FIRE RESISTANCE : 45 MIN, STC: 34
- ⟨2B⟩ INTERNAL WALLS TWO \S " TYPE X DRYWALL ON ONE SIDE AND ONE \S " TYPE X DRYWALL ON RESILIENT CHANNEL ON THE OTHER SIDE OF NEW OR EXISTING FRAMED WALL CONSISTING OF 2 BY 4 WOOD STUDS @ 16" O.C. WITH ABSORPTIVE MATERIAL (INSULATION). SB-3: W4a. FIRE RESISTANCE : 1 HOUR, STC: 51

✓3>CEILING 1/2" DRY WALL CEILING ATTACHED TO BOTTOM OF JOISTS OF FLOOR ASSEMBLY ABOVE. SB-3: F3e

√3A∕CEILING

5/8" TYPE X DRY WALL CEILING(WITH SONOPAN) ATTACHED TO RESILIENT CHANNELS WITH OR WITHOUT ABSORPTIVE MATERIAL IN CAVITY. TO BOTTOM OF JOISTS OF FLOOR ASSEMBLY ABOVE . FIRE RESISTANCE : 30 MIN WITHOUT INSULATION SB-3: F10c & 45 Min WITH INSULATION SB-3: F10c STC: 51

5%" TYPE X DRY WALL CEILING ATTACHED TO BOTTOM OF JOISTS OF FLOOR ASSEMBLY ABOVE ABSORPTIVE MATERIAL IN CAVITY. SB-3: F3b. FIRE RESISTANCE: 31 MIN. STC: 30.

- ✓3C CEILING (FOR COLD ROOMS TO BE FINISHED) DRY WALL CEILING ATTACHED TO BOTTOM OF JOISTS OF FLOOR ASSEMBLY ABOVE. 1/2" REGULAR GYPSUM BOARD WITH ABSORPTIVE MATERIAL IN CAVITY AND R31 INSULATION.
- 20 MIN. RATED DOOR FOR FURNACE ROOM AND BETWEEN BASEMENT APARTMENT AND BASEMENT AREA WHICH IS PART OF PRINCIPAL RESIDENCE
- EXISTING DUCT WORK LOCATED IN THE CEILING SHALL BE RELOCATED SO THAT THE DIRECTION OF THE HEAT FLOW IS TOWARDS THE FLOOR
- (6) MECHANICAL VENTILATION 5 L/S EXHAUST FANS IN KITCHEN AND WASHROOM AND 37.5 L.S FOR PRINCIPAL **EXHAUST**
- INTERCONNECTED AND WIRED SMOKE ALARMS AT EACH FLOOR AND EACH UNIT INCLUDING FINISHED BASEMENT AND LEGAL BASEMENT THROUGH ENTIRE HOUSE ALARM - AS PER OBC 9.10.19.
- PERMANENTLY CONNECTED TO ELECTRICAL CIRCUIT CARBON MONOXIDE DETECTOR AS PER OBC 2012 B 9.33.4.3.
- FOR ALL ELECTRICAL WORK AND PERMIT CONTACT ELECTRICAL SAFETY **AUTHORITY**
- SELF CONTAINED EMERGENCY LIGHTING UNIT CONFORMING TO CSA C22.2 NO.141, *EMERGENCY LIGHTING EQUIPMENT* - AS PER OBC 9.9.12

√3C >>		APPLY AQUA BLOC 720-38 (WATER PROOFING)
	R31 INSULATION BOARD	& APPLY TILES CONCRETE SLAB
	½" DRYWALL	FOAM INSULATION

PORCH TO BE FINISHED WITH TILES

SCHEDULES

RM.		FLO	OR	BAS	SE	WAI	LS	CEIL	ING	HEIGHT	REMARKS
NO	ROOM NAME	MATERIAL	FINISH	MATERIAL	FINISH	MATERIAL	FINISH	MATERIAL	FINISH	HEIGHT	KLWAKK
SEME	ENT FLOOR										
1	LIVING / DINING	WOOD	STAIN	VINYL		DRYWALL	PAINT	DRYWALL	PAINT	7'-6"	
2	KITCHEN	WOOD	STAIN	VINYL		DRYWALL	PAINT	DRYWALL	PAINT	7'-6"	
3	BEDROOM	WOOD	STAIN	VINYL		DRYWALL	PAINT	DRYWALL	PAINT	7'-0"(6'-7")	
4	CLOSET	doow	STAIN	VINYL		DRYWALL	PAINT	DRYWALL	PAINT	7'-6"	
5	BATH	CERAMIC		VINYL		DRYWALL	PAINT	DRYWALL	PAINT	7'-6"	

DOOR SCHEDULE

1. ALL INTERIOR DOORS ARE SLAB DOOR 1-3/8 TH. HOLLOW CORE OR SLIDING DOORS. THE SIZES ARE MENTIONED ON THE FLOOR PLAN, THE HEIGHT OF ALL DOORS ARE 80".

2 ALL FIRE RATED DOORS SHALL HAVE SELF-CLOSING DEVICES

GENERAL NOTES

- ALL WORK ACCORDING TO ONTARIO BUILDING CODE 2012 AND AHJ BY-LAWS AND **STANDARDS**
- ALL DIMENSIONS AND LOCATIONS TO BE VERIFIED ON SITE PRIOR TO CONSTRUCTION.
- ALL WOOD USED IN THE CONSTRUCTION SHALL BE SPF NO.1 OR NO.2
- MINIMUM BEARING OF STEEL LINTELS 150 MM.
- . MINIMUM BEARING OF WOOD BEAM / LINTELS 90 MM
- MINIMUM BEARING OF WOOD JOISTS 40MM
- · VERIFY EXISTING SUPPORT SYSTEM. INCLUDING FOUNDATIONS, FOR LOADS IMPOSED BY THE PROPOSED CONSTRUCTION
- PROVIDE ALL BRACING, SHORING AND NEEDLING NECESSARY FOR THE SAFE EXECUTION OF THIS WORK
- . INFORM CITY OF ALL INSPECTION AHEAD OF AND AT EACH STAGE OF CONSTRUCTION

3 OR 4 WAY SWITCH

EXISTING Е NEW

3 DENOTES 3-WAY SWITCH SPECIFICATION GRADE WHITE, WITH WHITE COVER PLATE4 DENOTES 4-WAY SWITCHSHALL BE INSTALLED AT THEENDS OF EACH STAIRWAYS

INSTALL AT 3'-3" AFF

15A, 120V DUPLEX RECEPTACLE SPECIFICATION GRADE, WHITE C/W WHITE COVER PLATE GFI- GROUND FAULT TYPE WP- WEATHERPROOF COVER C - ABOVE COUNTER

RECEPTACLE 50A, 208V. STOVE OR DRYER OUTLET.

 \oplus EXHAUST FAN

 \otimes FD: FLOOR DRAIN

 \oplus SPRINKLER

EMERGENCY LIGHT

SD: SMOKE ALARM W/ STROBE LIGHT

CO: CARBON MONOXIDE ALARM

Ø LIGHT

Ø POT LIGHT INSTALL DUCT TYPE SMOKE DETECTOR IN FURNACE.

NEW CEILING TO BE 45 MIN. FIRE RATED WITH ABSORPTIVE MATERIAL IN CAVITY, RESILIENT METAL CHANNELS @ 610MM O.C. WITH 2 LAYERS OF 12.7 MM TYPE X GYP, BD. ON CEILING SIDE AS PER "TABLE 2, FLOORS & CEILINGS F9h OF SB-3"

2/2x10 SPR WOOD LINTEL.

EGRESS WINDOW: TO BE OPERABLE FROM INSIDE WITHOUT USE OF ANY TOOLS UNOBSTRUCTED OPEN PORTION HAVING A MINIMUM AREA OF 0.35M2/3.76 Sq.Ft WITH NO DIMENSION LESS THAN 1'-3" 380MM)

BULKHEAD / STAIR CEILING 45 MIN. FIRE SEPARATION, 2 LAYERS 1/2" TYPE X GYPSUM (NOTE: NO OPENINGS PERMITTED THIS MEMBRANE ONLY FIRE SEPARATION.

CONTRACTOR SHALL SITE VERIFY ALL DIMENSIONS AND REPORT DISCREPANCES (F ANY) TO THE CONSULTANTS TRUCTION
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ALTERATIONS (SU)


50 COMMODORE DRIVE, BRAMPTON

GENERAL NOTES

N.T.S SCALE: DATE: 2024.02.01

PROJECT: DRAWING NO:

24-514

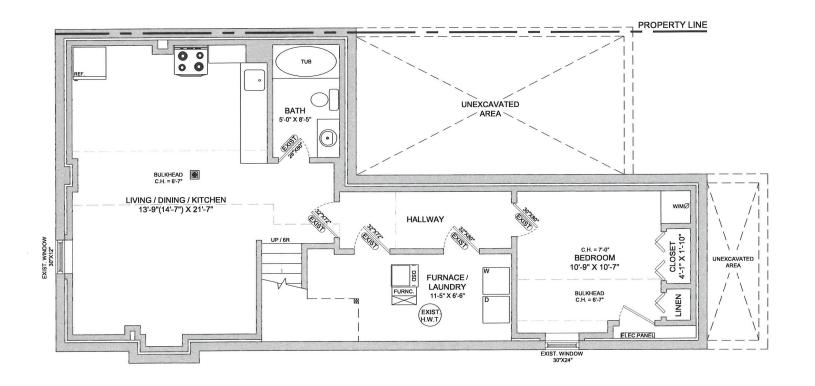



LEGEND:

EXHAUST FAN

EXISTING WALLS **NEW WALLS**

FIRE RATED WALLS. REFER TO A-303 FOR DETAILS

EXISTING TO BE REMOVED EXISTING STEEL & WOODEN POSTS

HARD WIRED SMOKE DETECTOR

(INTERCONNECTED) CARBON MONOXIDE ALARM

BASEMENT - EXISTING LAYOUT

BASEMENT AREA = 890.01 SFT / 82.71 SM

CEILING HEIGHT = 7'-6"

RELEASED FOR BUILDING PERMIT COPYRIGHT RESERVED

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ALTERATIONS (SU)

50 COMMODORE DRIVE, BRAMPTON

BASEMENT -**EXISTING** LAYOUT

SCALE:

3/₁₆"=1'-0"

DATE:


2024.02.01

PROJECT:

24-514

DRAWING NO:

A-101

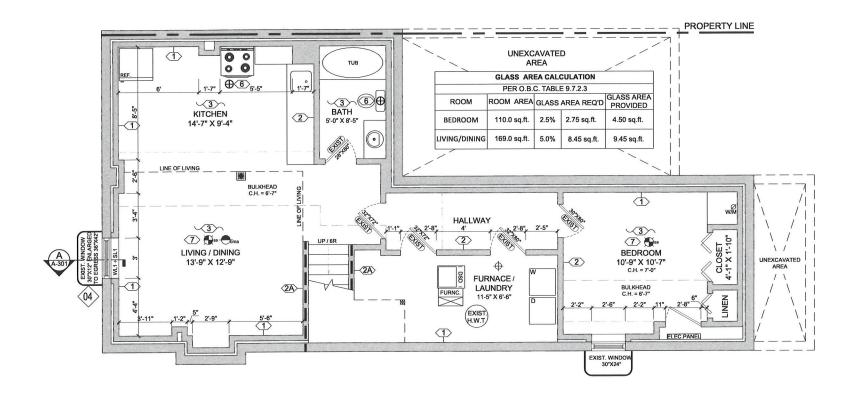



LEGEND:

 \oplus

EXHAUST FAN

EXISTING WALLS NEW WALLS

FIRE RATED WALLS. REFER TO A-303 FOR DETAILS

EXISTING TO BE REMOVED

EXISTING STEEL & WOODEN POSTS HARD WIRED SMOKE DETECTOR (INTERCONNECTED)

CARBON MONOXIDE ALARM

BASEMENT - PROPOSED LAYOUT

BASEMENT AREA PART OF PRINCIPAL RESIDENCE = 00.00 SFT / 00.00 SM

NEW BASEMENT APARTMENT GFA = 761.27 SFT / 70.75 SM

FURNACE AREA = 128.73 SFT / 11.96 SM

TOTAL BASEMENT GFA = 890.01 SFT / 82.71 SM

CEILING HEIGHT = 7'-6"

(04) EGRESS WINDOW

TO BE OPERABLE FORM INSIDE WITHOUT USE OF ANY TOOLS UNOBSTRUCTED OPEN PORTION HAVING A MINIMUM AREA OF 0.35 SM / 3.8 SFT WITH NO DIMENSION LESS THAN 1'-3" 380MM)

ALL WORK SHALL CONFORM TO THE ONTARIO BUILDING CODE O.REG. ³³²/₁₂ AS MENTIONED

SL1: STEEL LINTEL 31/2" X 31/2" X 3/8" WL1: WOOD LINTEL 2-2X8 SPF NO.1 OR 2

DOOR SCHEDULE

EXIST) EXISTING DOOR & WINDOW TO REMAIN.REPAINT IF REQUIRED

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ALTERATIONS (SU)

50 COMMODORE DRIVE, BRAMPTON

BASEMENT -PROPOSED LAYOUT

SCALE:


3/16"=1'-0" 2024.02.01


24-514

PROJECT:

DRAWING NO:

A-102

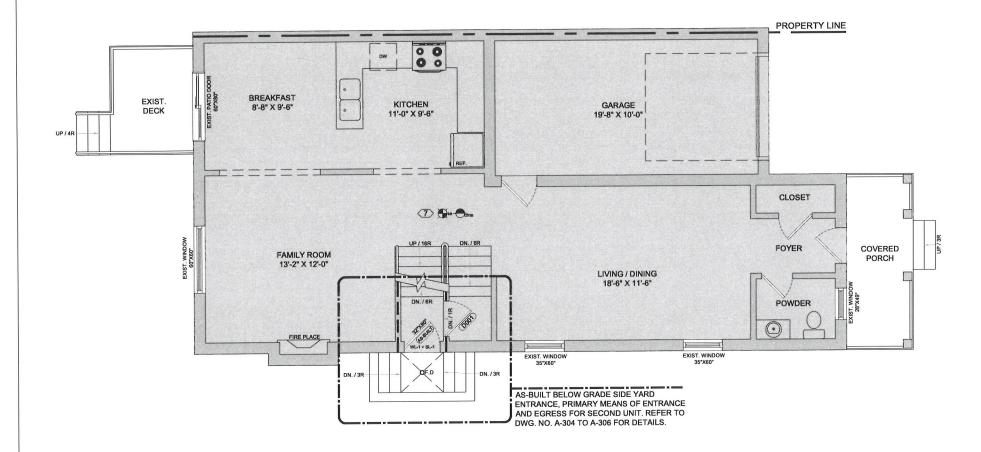

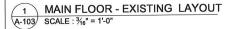

LEGEND:

 \oplus EXHAUST FAN

EXISTING WALLS NEW WALLS

FIRE RATED WALLS. REFER TO A-303 FOR DETAILS EXISTING TO BE REMOVED

EXISTING STEEL & WOODEN POSTS HARD WIRED SMOKE DETECTOR

(INTERCONNECTED) CARBON MONOXIDE ALARM

MAIN FLOOR - EXISTING LAYOUT

MAIN FLOOR AREA = 890.01 SFT / 82.71 SM

GARAGE AREA = 2223.79 SFT / 56.49 SM

TOTAL MAIN FLOOR AREA = 1497.81 SFT / 139.20 SM

CEILING HEIGHT = 9'-0"

DOOR SCHEDULE

0001) 2'-8" X 6'-8" 20 MIN. FIRE RATED DOOR

RELEASED FOR BUILDING PERMIT ELECANCEO PO MAN SERVICE PROTECTION AND REPORT DESCRIPTIONS AND REPORT DESCRIPTION OF WORK

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ALTERATIONS (SU)

50 COMMODORE DRIVE, BRAMPTON

MAIN FLOOR -**EXISTING LAYOUT**

SCALE:

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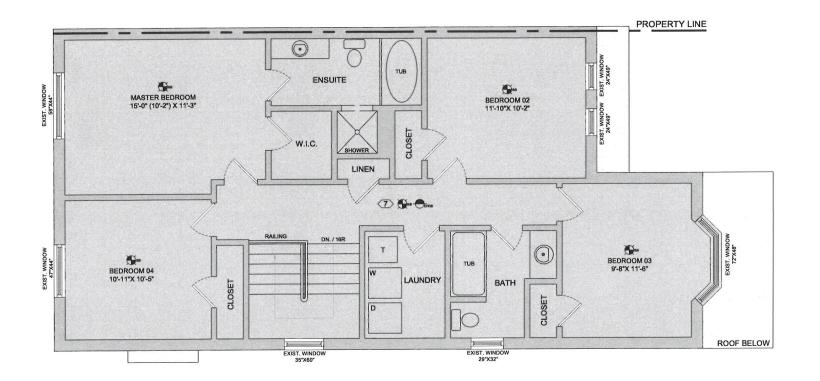
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2024.02.01 24-514

PROJECT:

DRAWING NO:

A-103





EXHAUST FAN EXISTING WALLS NEW WALLS

FIRE RATED WALLS. REFER TO A-303 FOR DETAILS

EXISTING TO BE REMOVED EXISTING STEEL & WOODEN POSTS HARD WIRED SMOKE DETECTOR

(INTERCONNECTED) CARBON MONOXIDE ALARM SECOND FLOOR - EXISTING LAYOUT

SECOND FLOOR AREA = 1081.38 SFT / 100.5 SM

CEILING HEIGHT = 8'-0"

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SECOND FLOOR -**EXISTING LAYOUT**

SCALE:

3/16"=1'-0"


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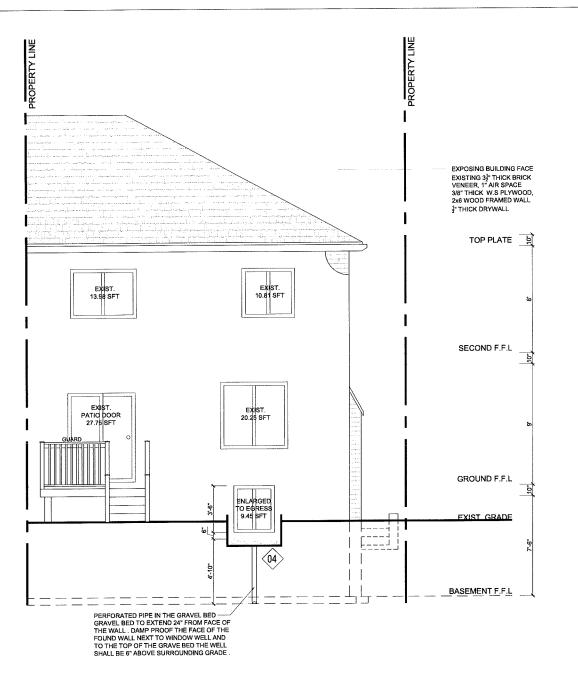
SOUTH ELEVATION

SCALE: 3/16"=1'-0" DATE: 2024.02.01

PROJECT: 24-514

DRAWING NO:

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EAST ELEVATION

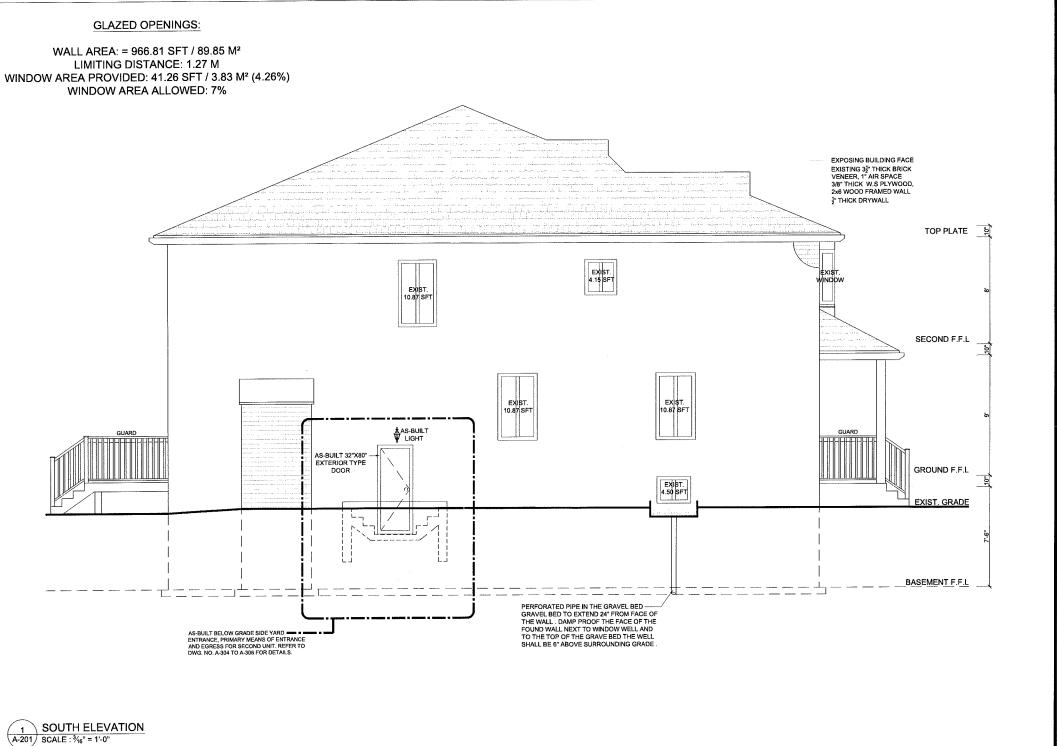SCALE:

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DATE:

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PROJECT:

DRAWING NO:

A-202

GENERAL NOTES


- ALL WORK ACCORDING TO ONTARIO BUILDING CODE 2012 AND CITY OF BRAMPTON BY-LAWS
- ALL WORKING ACCORDING TO GOOD CONSTRUCTION PRACTICES
- ALL FOOTINGS SHALL REST ON NATURAL UNDISTURBED SOIL OR COMPACTED GRANULAR FILL WITH A MINIMUM BEARING CAPACITY OF 75 KPA
- WHERE THE FOUNDATIONS OF A BUILDING ARE TO BE
 CONSTRUCTED BELOW THE LEVEL OF THE FOOTINGS OF AN
 ADJACENT BUILDING AND WITHIN THE ANGLE OF REPOSE OF THE
 SOIL, OR THE UNDERPINNING EXCEEDS 1200MM OF LATERALLY
 UNSUPPORTED HEIGHT OR THE SOIL IS CLAY OR SILT, THE
 UNDERPINNING & RELATED CONSECUTION SHALL BE DESIGNED BY
 A PROFESSIONAL ENGINEER.
- EXCAVATION SHALL BE UNDERTAKEN IN A MANNER SO AS TO PREVENT MOVEMENT WHICH WOULD CAUSE DAMAGE TO ADJACENT PROPERTIES, STRUCTURES, UTILITIES, ROADS & SIDEWALKS. CONTACT YOUR LOCAL UTILITIES PRIOR TO COMMENCING EXCAVATION.
- SHORE & BRACE WHERE NECESSARY TO ENSURE THE SAFETY & STABILITY OF THE EXISTING STRUCTURE DURING UNDERPINNING.


CONCRETE

- MINIMUM COMPRESSIVE STRENGTH OF CONCRETE 32MPA @ 28 DAYS W/5% TO 8% AIR ENTRAINMENT.
- 2. MINIMUM YIELD STRENGTH OF STEEL 60 KSI.

1. EXTERIOR DOOR

EXTERIOR TYPE DOOR (42MM INSULATED STEEL DOOR) SIZE 2'-8"x6'-8", W/ DEADBOLT AS PER OBC 9.6.5 & 9.6.8 TO RESIST FORCED ENTRY. PROVIDE LINTEL AS FOLLOWS: S.1: STEEL LINTEL $3_1^4 \times 3_2^4 \times 3_3^4 \times 3$

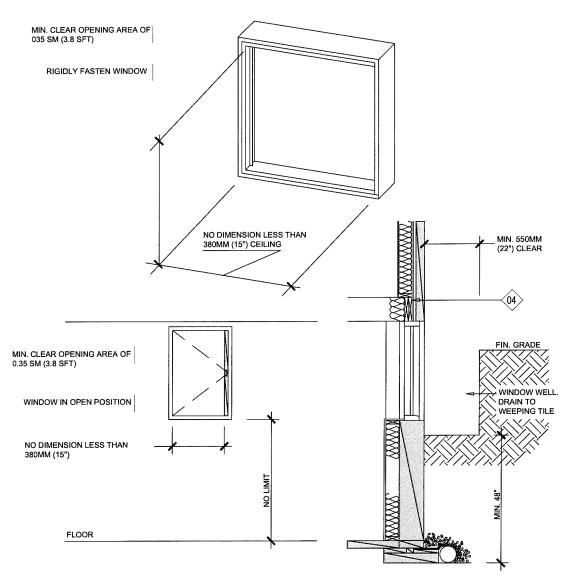

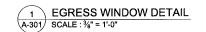

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ALTERATIONS (SU)

50 COMMODORE DRIVE, BRAMPTON

EGRESS WINDOW DETAIL

SCALE:


3/8" = 1'-0" 2024.02.01

DATE:

PROJECT: 24-514

DRAWING NO:

A-301

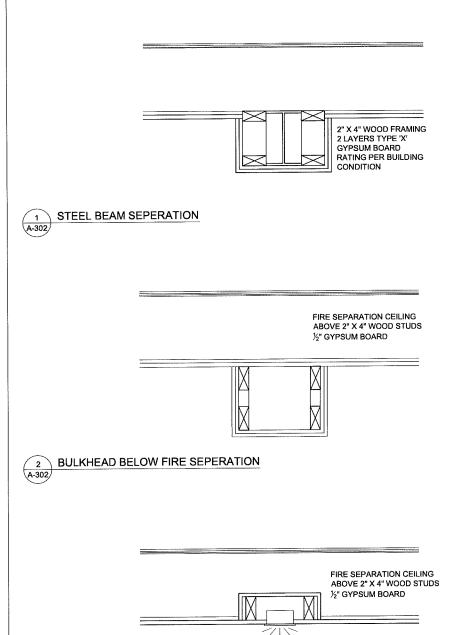

POT LIGHT FIRE SEPERATION

A-302

2" X 4" WOOD FRAMING 2 LAYERS TYPE 'X' GYPSUM BOARD RATING PER BUILDING CONDITION

STEEL COLUMN SEPERATION 4 A-302

> 2" X 4" WOOD STUDS TO SUPPORT CEILING SOUND INSULATION (OPTIONAL) 2 LAYERS TYPE 'X' GYPSUM BOARD RATING PER **BUILDING CONDITION**

5 A-302

UNDERSIDE OF STAIR FIRE SEPERATION

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ALTERATIONS (SU)

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TYPICAL DETAILS


SCALE:

3/8"= 1'-0"

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FIRE BLOCKING **DETAILS**


3/8" = 1'-0" SCALE: DATE: 2024.02.01

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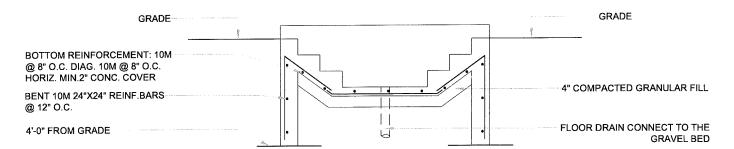
A-303

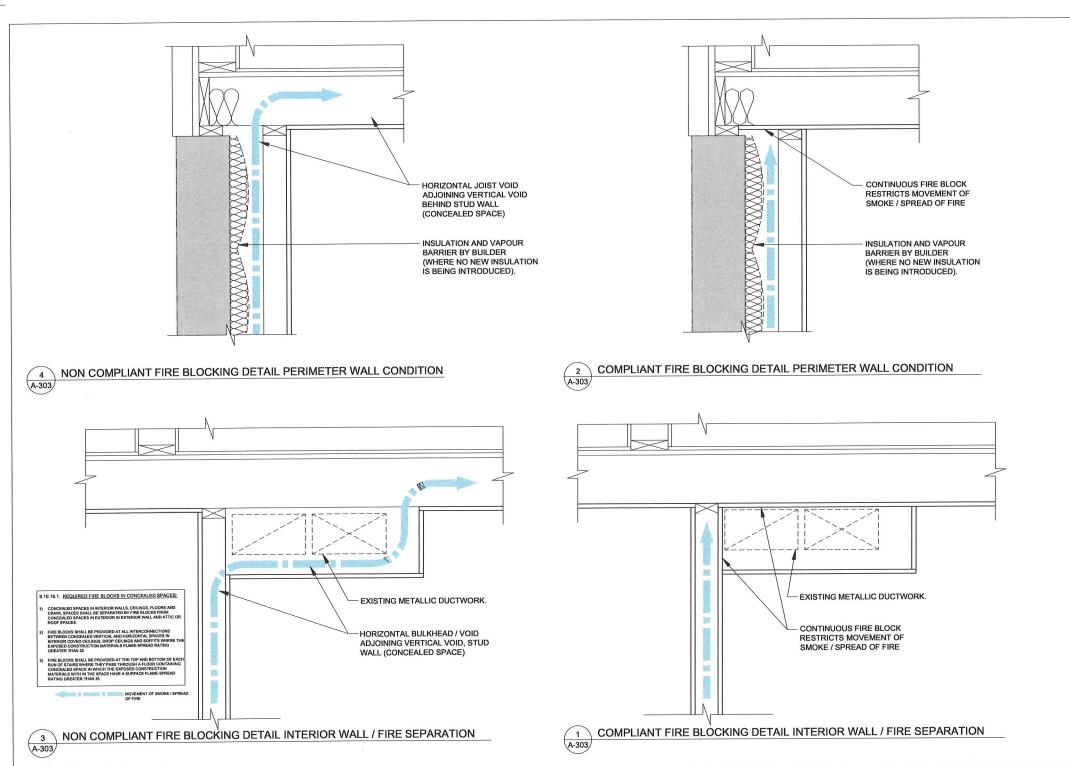24-514



WALK-OUT PLAN A-304 SCALE : 3/8" = 1'-0"

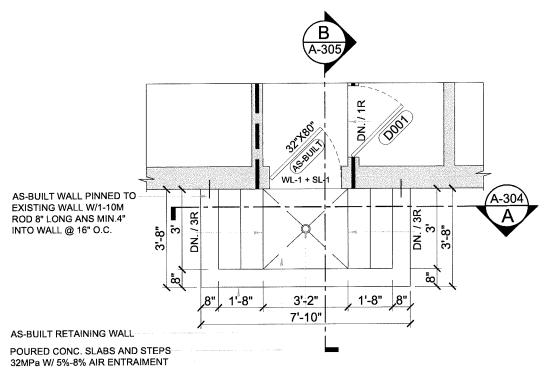FLOOR DRAIN CONNECT TO THE GRAVEL BED



1 A-304 WALK-OUT SECTION - A SCALE: 3%" = 1'-0"

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ALTERATIONS (SU)

50 COMMODORE DRIVE, BRAMPTON

WALKOUT **DETAILS**

SCALE:

3/8" = 1'-0" 2024.02.01

DATE: PROJECT:

24-514

DRAWING NO:

A-304

GENERAL NOTES

1. FOOTING

FOOTINGS SHALL REST ON NATURAL UNDISTURBED SOIL OR COMPACTED GRANULAR FILL WITH A MINIMUM SOIL BEARING CAPACITY OF 75 KPa

2. HANDRAILS

HANDRAILS SHOUD BE BETWEEN 34 TO 38 ABOVE THE TREAD AT THE LEADING EDGE LINE 2 IN CLEARANCE FROM THE WALL IS REQUIRED START AND END POINT OF HANDRAILS MUST NOT OBSTRUCT PEDESTRIAN TRAFFIC OR

START AND END POINT OF HANDRAILS MUST NOT OBSTRUCT PEDESTRIAN TRAFFIC OR CREATE A HAZARD BOTH SIDE HANDRAILS REQUIRED IF STAIRS ARE 43 IN OR WINDER

3. EXTERIOR

7 %" RISER MAXIMUM 4 %" MINIMUM 10" RUN MINIMUM 14" MAXIMUM 10" TREAD MINIMUM 14" MAXIMUM 14" MAXIMUM

4. RETAINING WALL

10" POURED CONCRETE WALL DOES NOT REQUIRED REBAR IF BACKFILL HEIGHT DOES NOT EXCEED 4'-7". PROVIDE 10M REBAR @12" O.C. EACH WAY FIR BACKFILL HEIGHTS EXCEEDING 4'-7"

GUARDS (PRE-ENGINEERED)

42 INCH HIGH WHERE DISTANCE FROM GRADE TO BOTTOM OF WALKOUT EXCEEDS 5'-11" 36" FOR LESSER HEIGHTS, MAMIUM 4" BETWEEN VERTICAL PICKETS

LIGHT

ELECTRIC FEED FOR THE LIGHT TO BE SEPARATE FROM ANY OTHER SWITCHED CIRCUIT

EXTERNAL DOOR

EXTERIOR DOOR GENERAL PERFORMANCE CRITERIA AND THERMAL RESISTANCE TO COMPLY WITH OBC 9.7.3 INSTALLATION OF MANUFACTURED AND PRE - ASSEMEBED DOOR SHALL CONFORM TO THE MANUFACTURERS INSTRUCTIONS

ALL UN FINISHED PORTIONS OF THE GRAME AND OTHER COMPONENTS OF DOORS IN CONTACT WITH THE EDGES OF MANSORY OR CONCRETE SHALL BE PROTECTED WITH CAULKING


8. INSULATION DETAILS

RIGID INSULATION TO HAVE FOLLOWING SPECFICATION

- STYROFOAM BRAND SM EXTRUDED POLYSTYRENE FOAM INSULATION
 RSI VALUE 0.87/25MM [R-5 PER 1 INCH]
- BOARD SIZE : AS INDICATED ON DRAWINGS]
- COMPRESSIVE STRENGTH: 210 KPa
- DRAINING CAPAICTY > 0.72 M3/ HR/ M

9. INSULATION FINISHING

INSTALL RIGID INSULATION ON EXISTING FOUNDATION WALL MIN 4FT ABOVE FOOTING INSULATION TO BE INSTALLED ON EXPOSED FOUNDATION WALL ONLY STARTING FROM GRANULAR FILL UNDER STEPS COVER INSULATION WITH ½" CEMENT BOARD INSTAL 21½" GALVANIZED J TRACK ON SECURE AND PROTECT ALL EXPOSED EDGES ALL JOINTS TO THE EXISTING WALL NEW STEPS MUST BE CAULKED APPLY SEAL GUARD TO ALL JOINTS ON CEMET BOARD PARGE CEMENT BOARD OR APPLY ACRYLIC FINISH

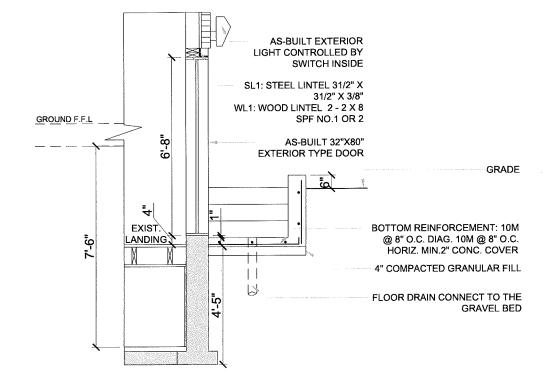



RELEASED FOR BUILDING PERMIT
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REPORT DISCREPANCES (IF ANY) TO THE CONSULT.

SEFORE CONSTRUCTION.

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ALTERATIONS (SU)

50 COMMODORE DRIVE, BRAMPTON

WALKOUT DETAILS

SCALE:


3/8" = 1'-0"

DATE: PROJECT: 2024.02.01 24-514

DRAWING NO:

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A-305

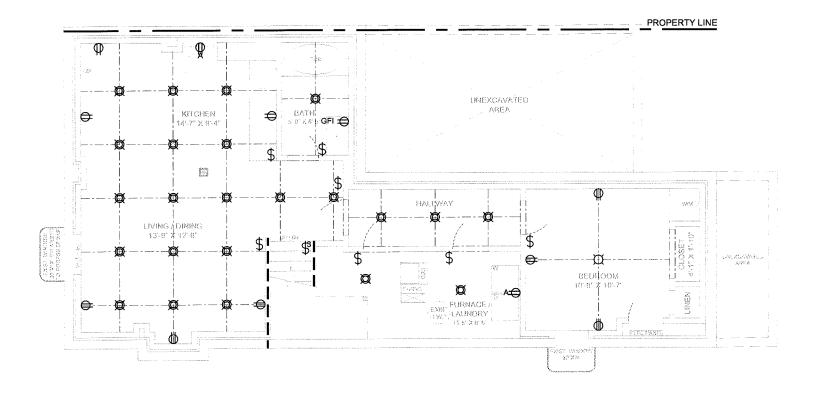

BASEMENT - ELECTRICAL LAYOUT E-101) SCALE : 3/6" = 1'-0"

ELECTRICAL SYMBOL :

3 OR 4 WAY SWITCH E EXISTING

⊖_{GF}

15A, 120V DUPLEX RECEPTACLE SPECIFICATION GRADE, WHITE C/W WHITE COVER PLATE GFI- GROUND FAULT TYPE WP- WEATHERPROOF COVER C - ABOVE COUNTER

ELECTRICAL SYMBOL:

RECEPTACLE 50A, 208V, STOVE OR DRYER OUTLET.

EXHAUST FAN

FD: FLOOR DRAIN

SPRINKLER

EMERGENCY LIGHT

SD: SMOKE ALARM W/ STROBE LIGHT
CO: CARBON MONOXIDE ALARM

LIGHT POT LIGHT

ELECTRICAL NOTES

LOCATIONS OF ELECTRICAL ITEMS ARE APPROXIMATE, ACTUAL LOCATION MAY VARY AS PER SITE CONDITIONS

WHERE PENETRATING FIRE SEPARATION FOR POT LIGHT FIXTURES, USE FIRE RATED POT LIGHTS OR PROVIDE FIRE RATED ENCLOSURE BEHIND LIGHT FIXTURE TO ENSURE CONTINUITY OF FIRE SEPARATION RELEASED FOR BUILDING PERMIT

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ALTERATIONS (SU)

50 COMMODORE DRIVE, BRAMPTON

BASEMENT -ELECTRICAL LAYOUT

SCALE:

3/16" = 1'-0"

DATE:


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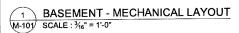
PROJECT:

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DRAWING NO:

E-101



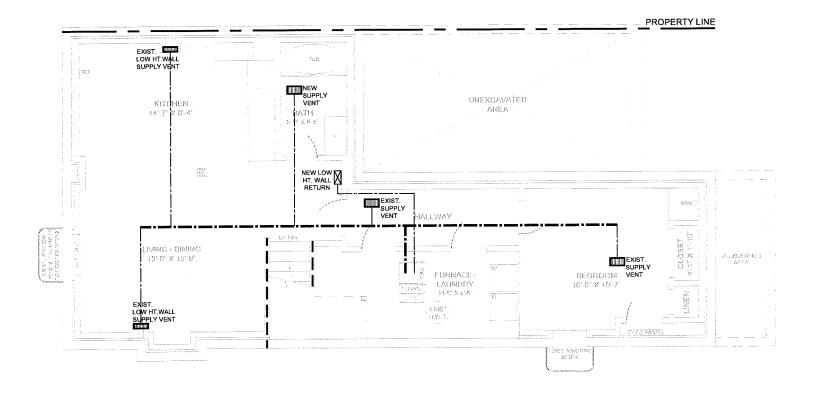

MECHANIAL NOTES

LOCATIONS OF MECHANICAL ITEMS ARE APPROXIMATE, ACTUAL LOCATION MAY VARY AS PER SITE CONDITIONS

DUCT-TYPE SMOKE DETECTOR TO BE INSTALLED IN THE SUPPLY OR RETURN AIR DUCT SYSTEM SERVING THE ENTIRE BUILDING THAT MUST TURN OFF THE FUEL SUPPLY AND ELECTRICAL POWER TO THE HEATING SYSTEM UPON ACTIVATION

LOCATION OF SMOKE ALARMS AS PER O.B.C.DIV B. SEC 9.10.19.3

- (1) WITHIN DWELLING UNITS, SUFFICIENT SMOKE ALARMS SHALL BE INSTALLED SO THAT,
- A. THERE IS AT LEAST ONE SMOKE ALARM INSTALLED ON EACH STOREY, INCLUDING BASEMENT AND,
- B. ON ANY STOREY OF A DWELLING CONTAINING SLEEPING ROOMS, A SMOKE ALARM IS INSTALLED
- IN EACH ROOM AND,
- ii. IN A LOCATION BETWEEN THE SLEEPING ROOM AND THE REMINDER OF THE STOREY AND IF THE SLEEPING ROOMS ARE SERVED BY A HALLWAY, THE SMOKE ALARM SHOULD BE LOCATED IN THE HALLWAY.
- (1) PROVIDE SUPPLY AIR REGISTER (OBC DIV. B.9.33.1(1). REGISTER SHALL BE LOCATED WITHIN 4' OF OUTSIDE WALL (7.6 HRAI DIGEST REQUIREMENTS)
- (2) THE RETURN AIR GRILLE SHALL BE INSTALLED NEAR FLOOR LEVEL (7.7 HRAI DIGEST REQUIREMENTS). UNDERCUT BY MIN 1. THE DOOR TO ANY ROOM WITHOUT RETURN AIR GRILLE
- (3) CLOTHES DRYER EXHAUST SHALL COMPLY WITH OBC DIV. B.6.2.4.11 REQUIREMENTS
- (4) SEPARATE ANY INTAKES FROM BUILDING ENVELOPE PENETRATIONS THAT ARE POTENTIAL SOURCES OF CONTAMINANTS (GAS VENTS, OIL FILL PIPES, ETC. BY MIN 900MM (2'11") . OBC DIV B.9.32.3.12. ENSURE ADEQUATE VENTILATION & COMBUSTION AIR FOR THE OPTIMUM OPERATION OF THE FURNACE, PER MANUFACTURER'S REQUIREMENTS.

RELEASED FOR BUILDING PERMIT

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NO DATE REVISION / ISSUED 00 2024 01:29 SCHEMATIC DESIGN 00 2024 02 01 PERMIT APPLICATION

OWNER

RAVI KONDAPALLI



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ALTERATIONS (SU)

50 COMMODORE DRIVE, BRAMPTON

BASEMENT -**MECHANICAL** LAYOUT

SCALE:

3/16" = 1'-0"

DATE:

2024.02.01 24-514

PROJECT:

DRAWING NO:

M-101

Zoning Non-compliance Checklist

File No.		
A-2024-00	9	7

Applicant: Arshad Siddiqui Address: 50 Commodore Dr

Zoning: R2A-1301

By-law 270-2004, as amended

Category	Proposal	By-law Requirement	Section #
USE			
LOT DIMENSIONS AREA / DEPTH / WIDTH			
BUILDING SETBACKS FRONT / SIDE / REAR			
BUILDING SIZE			
BUILDING HEIGHT			
COVERAGE			
BELOW GRADE ENTRANCE	To permit an existing exterior stairway leading to a below grade entrance in a required side yard,	whereas the by-law does not permit exterior stairways constructed below established grade in the required interior side yard.	10.23.1
BELOW GRADE ENTRANCE	To permit an interior side yard setback of 0.18m to an existing exterior stairway leading to a below grade entrance,	whereas the by-law requires a minimum interior side yard setback of 1.2m.	10.23.2
ACCESSORY STRUCTURE SIZE / HEIGHT			
MULTIPLE ACCESSORY STRUCTURES			
GARAGE WIDTH			
LANDSCAPED OPEN SPACE			
ENCROACHMENTS			
TWO-UNIT DWELLING			
SCHEDULE "C"			
OTHER - DECK			

Shiza Athar	
Reviewed by Zoning	
2024/03/01	
Date	